

GENERAL NOTES

1. These notes are General and are not to be construed as a contract. The Engineer shall be responsible for the design and construction of the work shown on the drawings. The Contractor shall be responsible for the construction of the work shown on the drawings. The Contractor shall be responsible for the construction of the work shown on the drawings.

ITEM	DESCRIPTION	UNIT	QUANTITY
1.00	Excavation	SF	100.00
2.00	Concrete	CY	10.00
3.00	Reinforcing Steel	LB	1000.00
4.00	Formwork	SF	100.00
5.00	Gravel	CY	10.00
6.00	Backfill	CY	10.00
7.00	Drainage	LF	100.00
8.00	Foundation	SF	100.00
9.00	Wall	SF	100.00
10.00	Roof	SF	100.00

2. The Contractor shall be responsible for the construction of the work shown on the drawings. The Contractor shall be responsible for the construction of the work shown on the drawings. The Contractor shall be responsible for the construction of the work shown on the drawings.

3. The Contractor shall be responsible for the construction of the work shown on the drawings. The Contractor shall be responsible for the construction of the work shown on the drawings. The Contractor shall be responsible for the construction of the work shown on the drawings.

4. The Contractor shall be responsible for the construction of the work shown on the drawings. The Contractor shall be responsible for the construction of the work shown on the drawings. The Contractor shall be responsible for the construction of the work shown on the drawings.

5. The Contractor shall be responsible for the construction of the work shown on the drawings. The Contractor shall be responsible for the construction of the work shown on the drawings. The Contractor shall be responsible for the construction of the work shown on the drawings.

6. The Contractor shall be responsible for the construction of the work shown on the drawings. The Contractor shall be responsible for the construction of the work shown on the drawings. The Contractor shall be responsible for the construction of the work shown on the drawings.

7. The Contractor shall be responsible for the construction of the work shown on the drawings. The Contractor shall be responsible for the construction of the work shown on the drawings. The Contractor shall be responsible for the construction of the work shown on the drawings.

8. The Contractor shall be responsible for the construction of the work shown on the drawings. The Contractor shall be responsible for the construction of the work shown on the drawings. The Contractor shall be responsible for the construction of the work shown on the drawings.

9. The Contractor shall be responsible for the construction of the work shown on the drawings. The Contractor shall be responsible for the construction of the work shown on the drawings. The Contractor shall be responsible for the construction of the work shown on the drawings.

10. The Contractor shall be responsible for the construction of the work shown on the drawings. The Contractor shall be responsible for the construction of the work shown on the drawings. The Contractor shall be responsible for the construction of the work shown on the drawings.


11. The Contractor shall be responsible for the construction of the work shown on the drawings. The Contractor shall be responsible for the construction of the work shown on the drawings. The Contractor shall be responsible for the construction of the work shown on the drawings.

12. The Contractor shall be responsible for the construction of the work shown on the drawings. The Contractor shall be responsible for the construction of the work shown on the drawings. The Contractor shall be responsible for the construction of the work shown on the drawings.

13. The Contractor shall be responsible for the construction of the work shown on the drawings. The Contractor shall be responsible for the construction of the work shown on the drawings. The Contractor shall be responsible for the construction of the work shown on the drawings.

14. The Contractor shall be responsible for the construction of the work shown on the drawings. The Contractor shall be responsible for the construction of the work shown on the drawings. The Contractor shall be responsible for the construction of the work shown on the drawings.

Depth of Footings may be determined by inspection of soil. Where necessary, consult with Mechanical Contractors to determine exact depth and location of pipes.

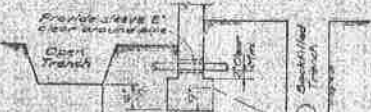

Plates shall be placed below the line. No pipes shall pass under footings.


RELATION OF STEEL & TRENCHES TO FOOTINGS

(Applies also to walls, column footings, etc.)



DOUBLE MAT

TYPICAL REINFORCING AT WALL AND FOOTING CORNERS

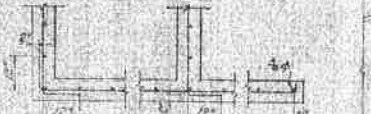

SINGLE MAT

TYPICAL REINFORCING AT WALL AND FOOTING CORNERS



CONCRETE

TYPICAL FLASHING AT DOOR AGAINST WALL



CONCRETE

TYPICAL FLASHING AT DOOR AGAINST WALL



CONCRETE

Where edge of concrete limits bar lengths, extend as far as possible and hook.



Typical wall built


MINIMUM STEEL AROUND OPENINGS IN WALLS



MINIMUM STEEL AROUND OPENINGS IN WALLS



MINIMUM STEEL AROUND OPENINGS IN WALLS

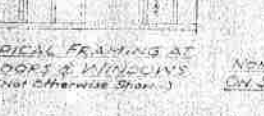

MINIMUM STEEL AROUND OPENINGS IN WALLS



MINIMUM STEEL AROUND OPENINGS IN WALLS




MINIMUM STEEL AROUND OPENINGS IN WALLS



MINIMUM STEEL AROUND OPENINGS IN WALLS

MINIMUM STEEL AROUND OPENINGS IN WALLS

Top of footing 30 diameters

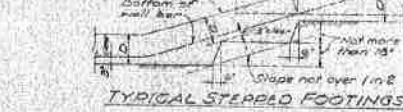

TYPICAL STEPPED FOOTINGS



TYPICAL STEPPED FOOTINGS



TYPICAL STEPPED FOOTINGS




TYPICAL STEPPED FOOTINGS



TYPICAL STEPPED FOOTINGS



TYPICAL STEPPED FOOTINGS

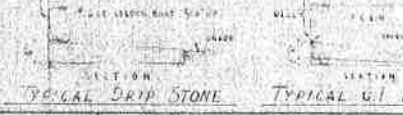

TYPICAL STEPPED FOOTINGS

TYPICAL STEPPED FOOTINGS

APPROVED BY THE


APPROVED BY THE


APPROVED BY THE

APPROVED BY THE


APPROVED BY THE

APPROVED BY THE

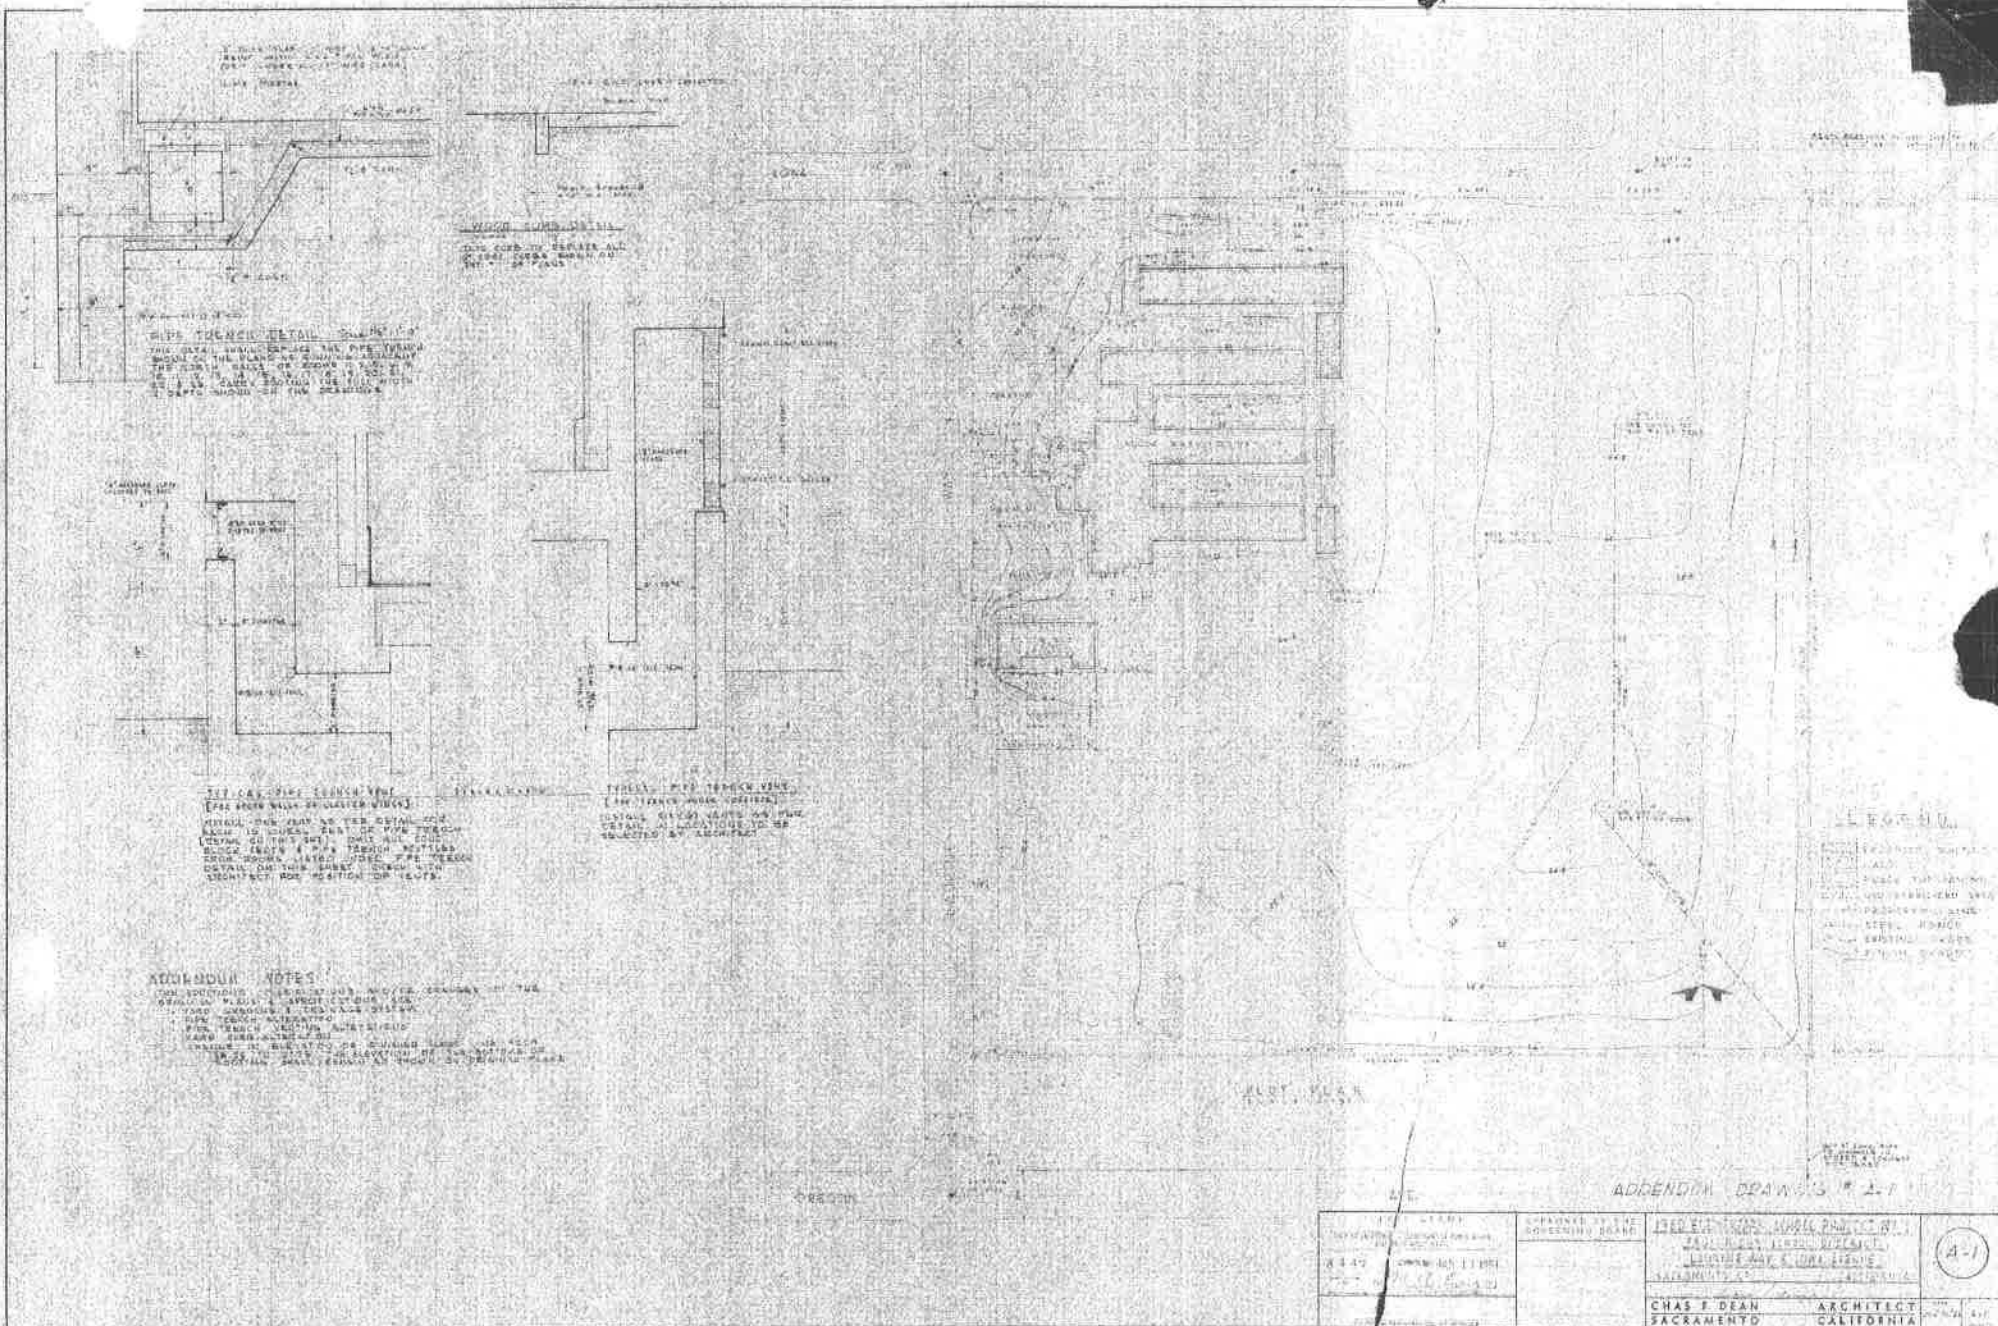


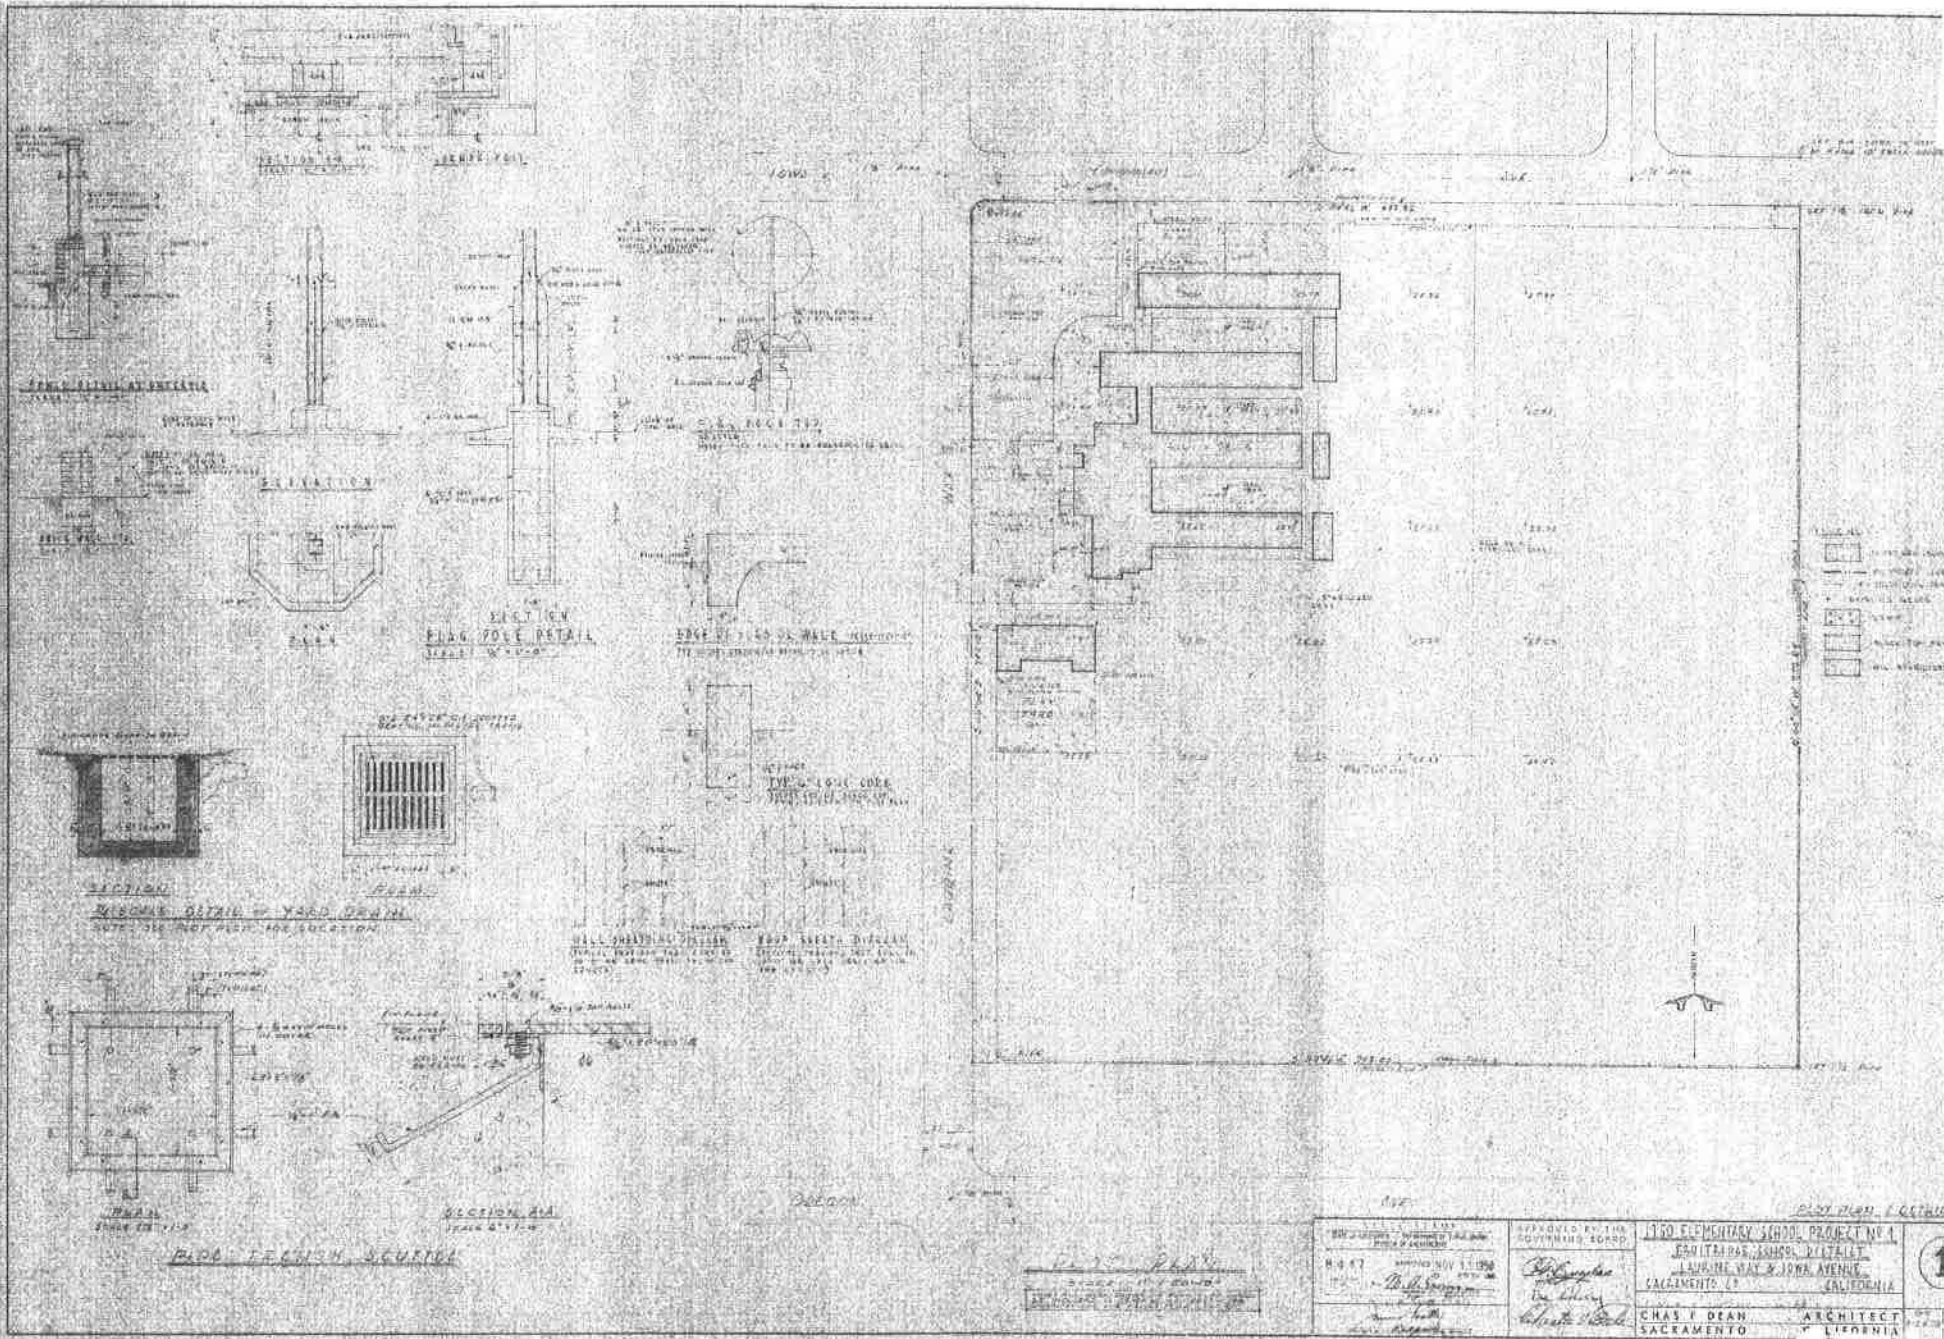


①

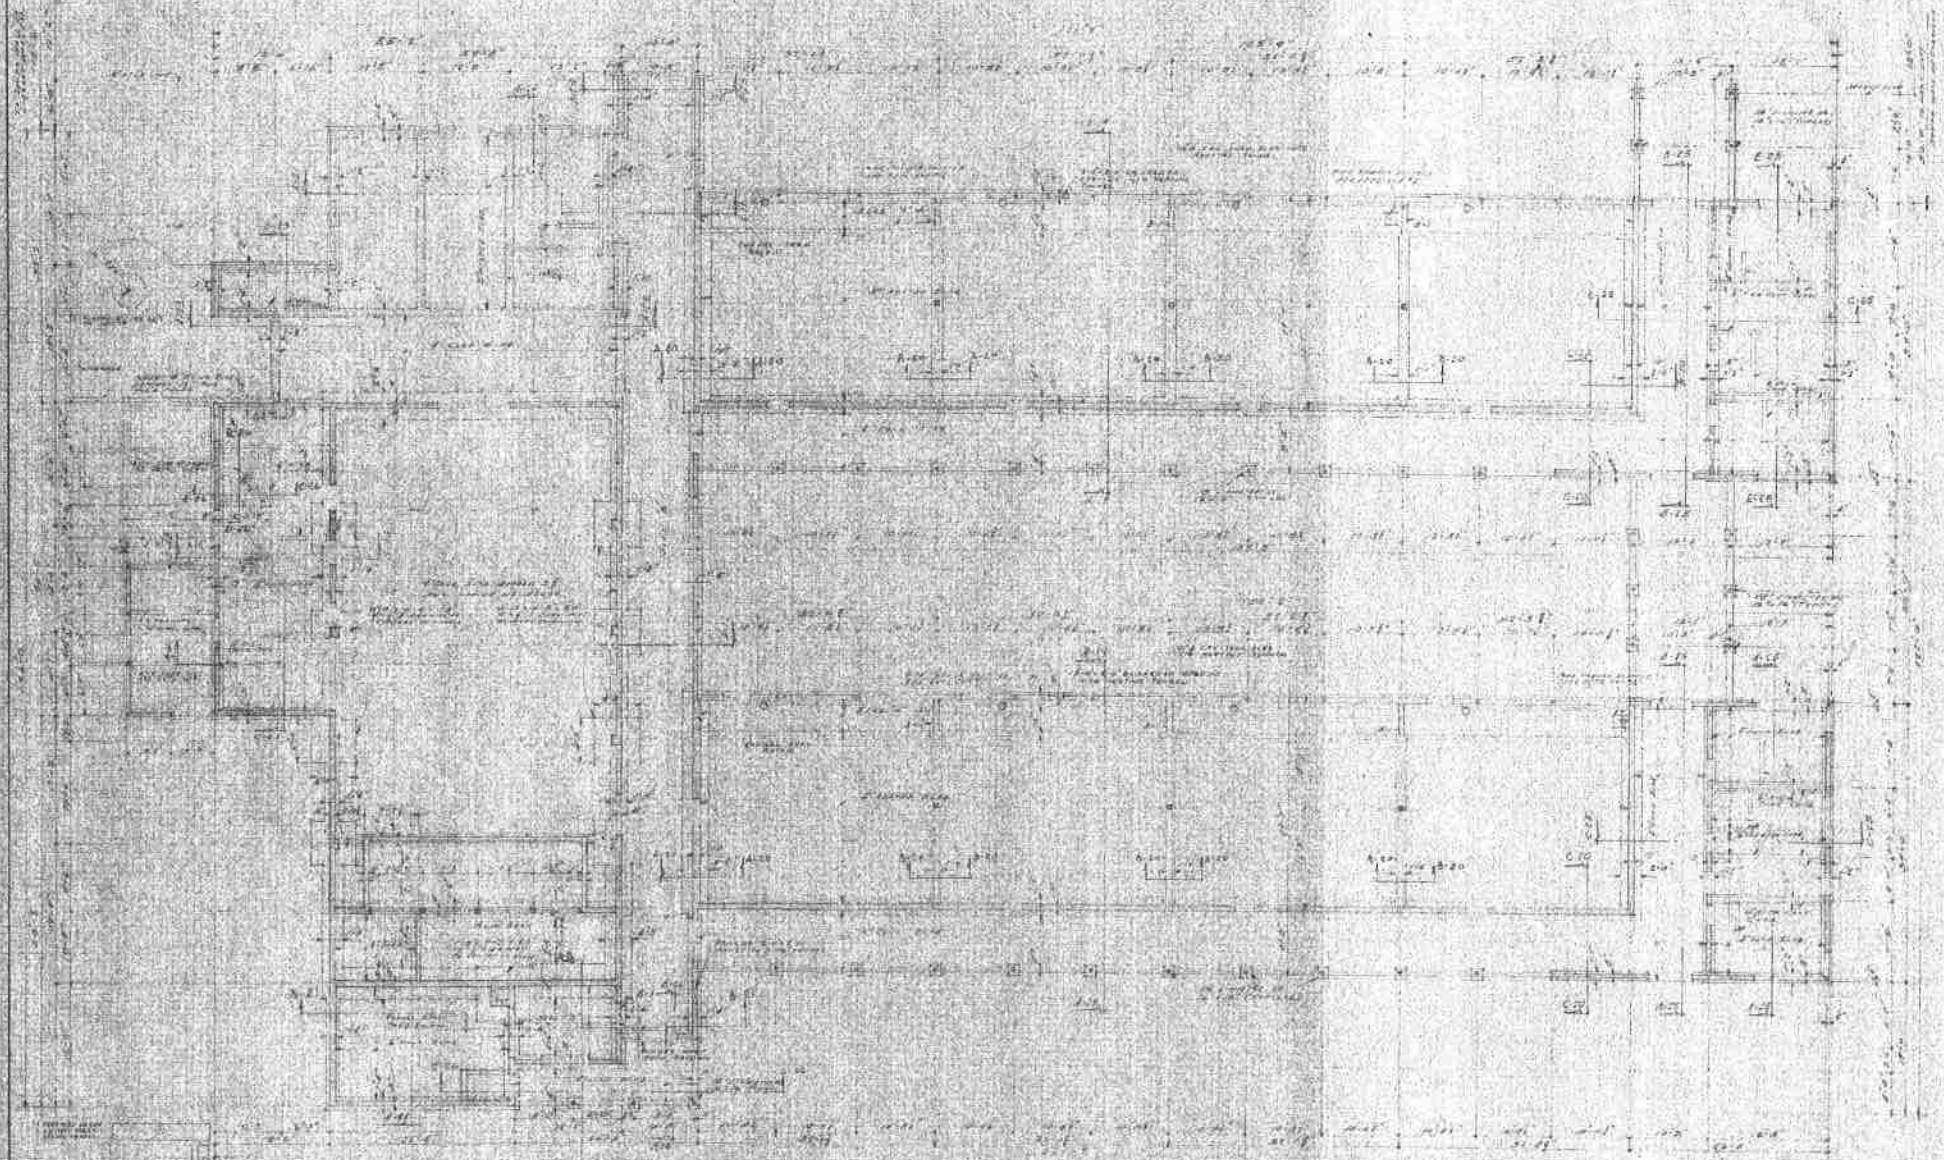

FOUNDATION & FLOOR PLAN OF THE SACRAMENTO COUNTY JAIL

DRAWING NO. 8447 DATE MAY 1950 CHAS. I. DEAN ARCHITECT SACRAMENTO, CALIF.	APPROVED BY THE ARCHITECT CHAS. I. DEAN SACRAMENTO, CALIF.	SUPPLEMENTARY SCHOOL PROJECT #114 TRUFFLEBERRY SCHOOL DISTRICT TRUFFLEBERRY, CALIF.	12 10
--	---	---	----------

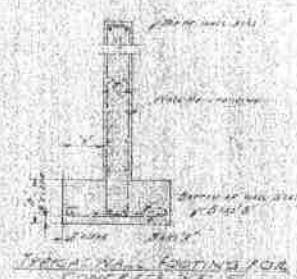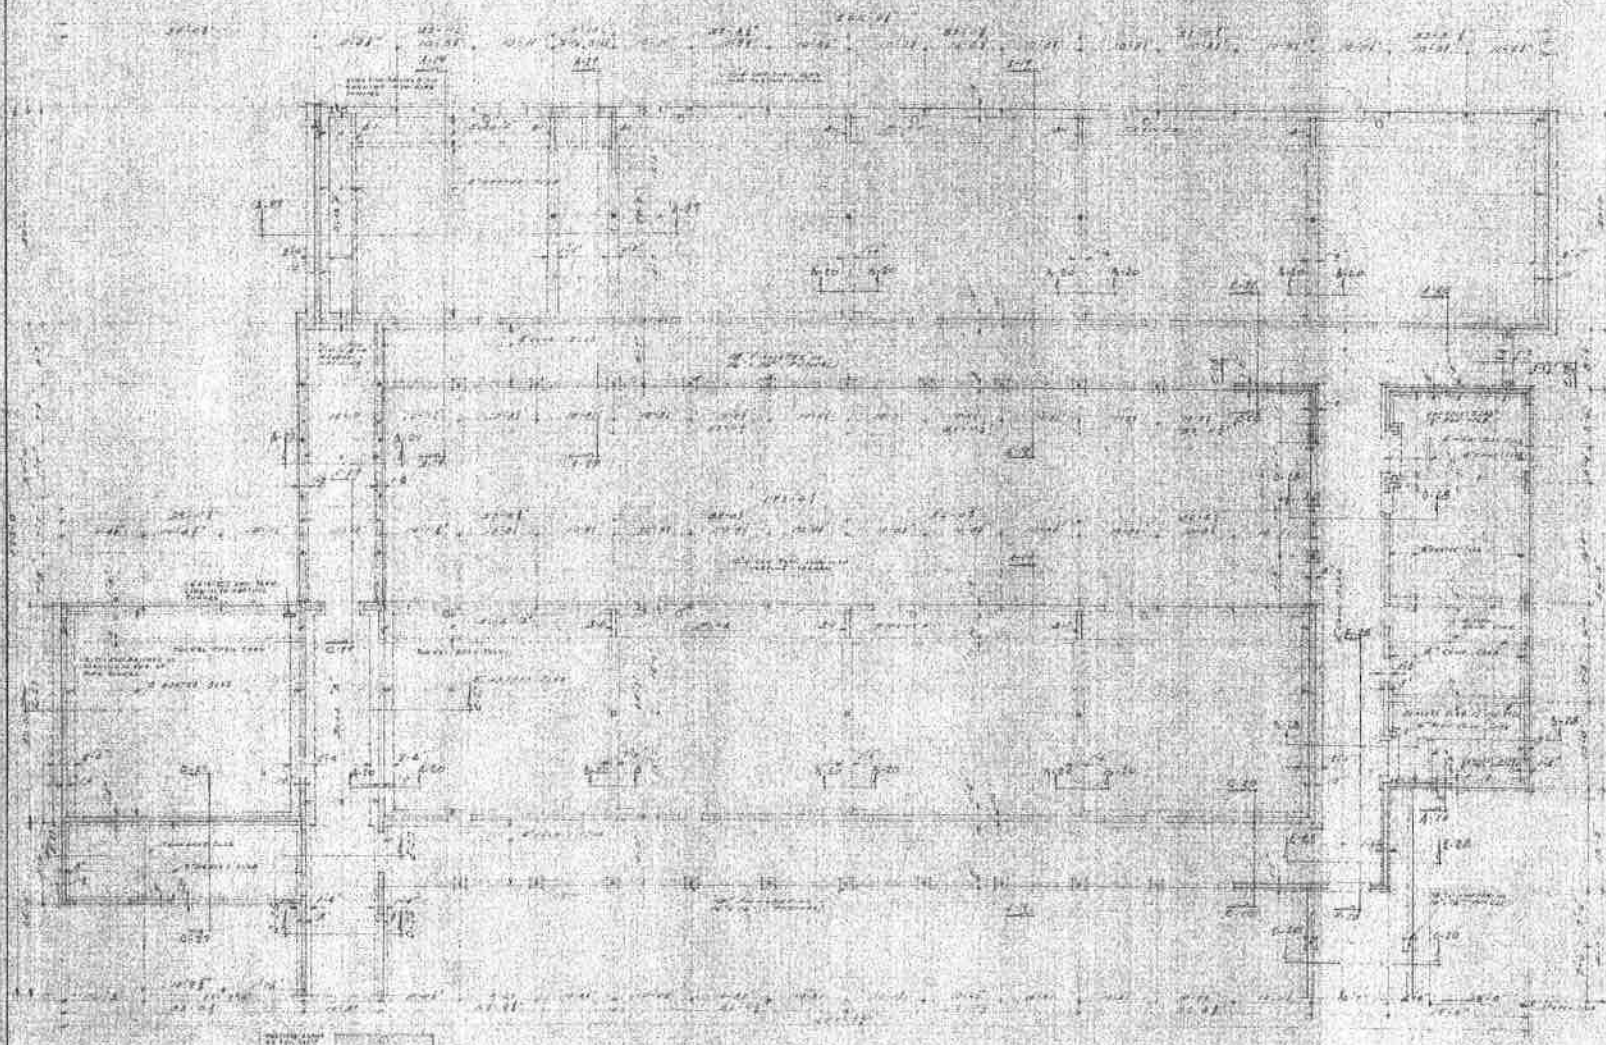



WALL REINFORCING SCHEDULE	
REINFORCING	QUANTITY
8# REINFORCING	2.15
10# REINFORCING	1.15
12# REINFORCING	1.15

WALL FOOTING SCHEDULE	
FOOTING	QUANTITY
FOOTING 1	1.15
FOOTING 2	1.15
FOOTING 3	1.15
FOOTING 4	1.15
FOOTING 5	1.15

FOUNDATION & FIRST FLOOR FRAMING PLAN

THIS DRAWING IS PART OF THE PROJECT NO. 1417, AND IS TO BE USED ONLY FOR THE PROJECT NO. 1417.		APPROVED BY THE SUPERVISOR OF THE DISTRICT	FOUNDATION & FIRST FLOOR FRAMING PLAN 1950 ELEMENTARY SCHOOL PROJECTS-1 CHATELAIN SCHOOL DISTRICT LAKELAND WAY & 10TH AVENUE SACRAMENTO, CA	<div style="border: 1px solid black; border-radius: 50%; width: 30px; height: 30px; display: flex; align-items: center; justify-content: center;">3</div>
CHAS F DEAN SACRAMENTO		ARCHITECT CALIFORNIA		

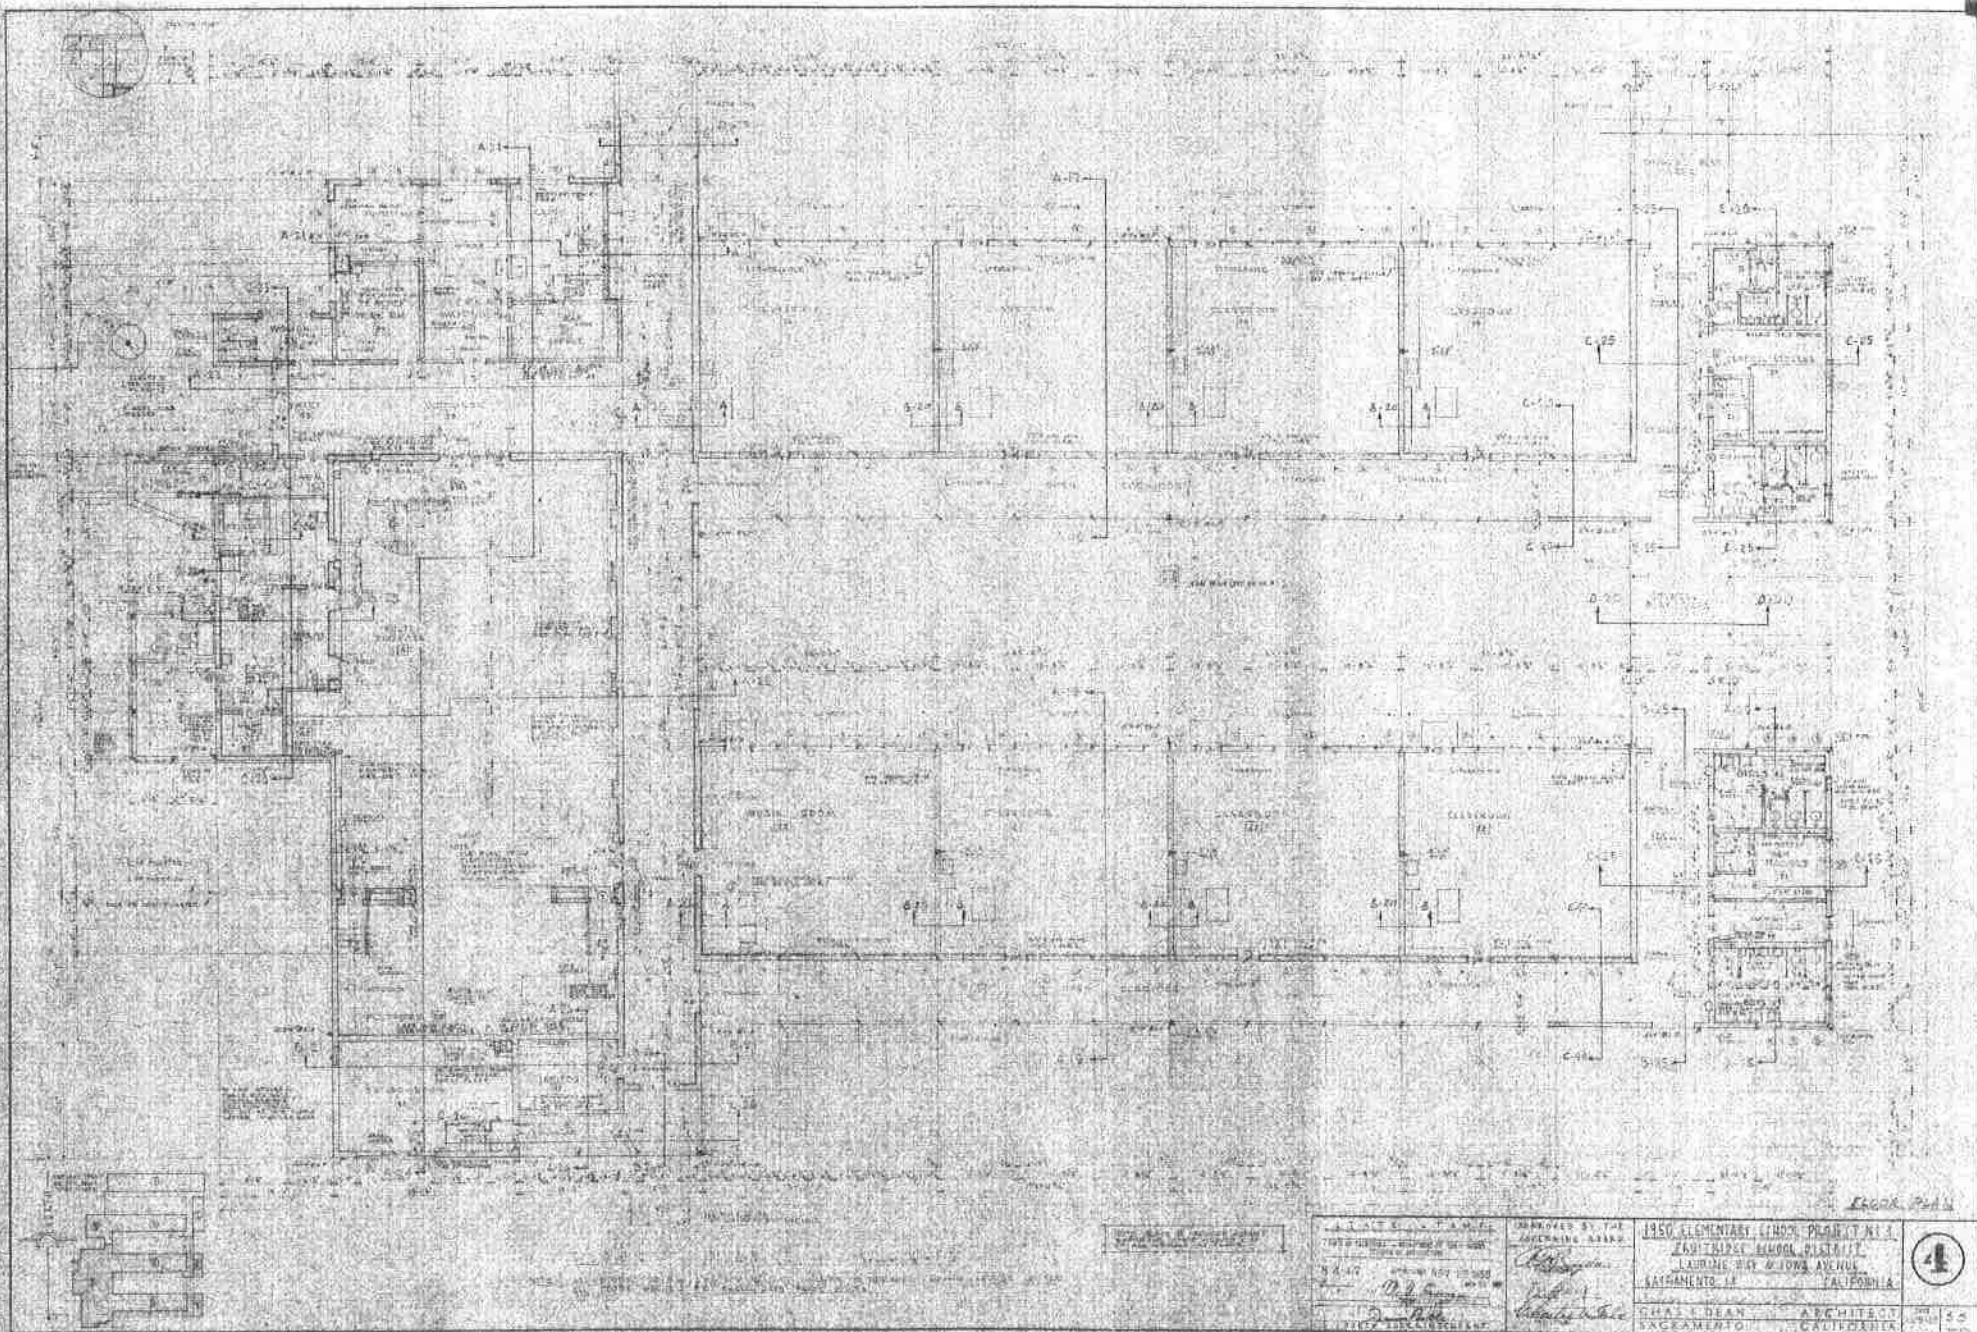

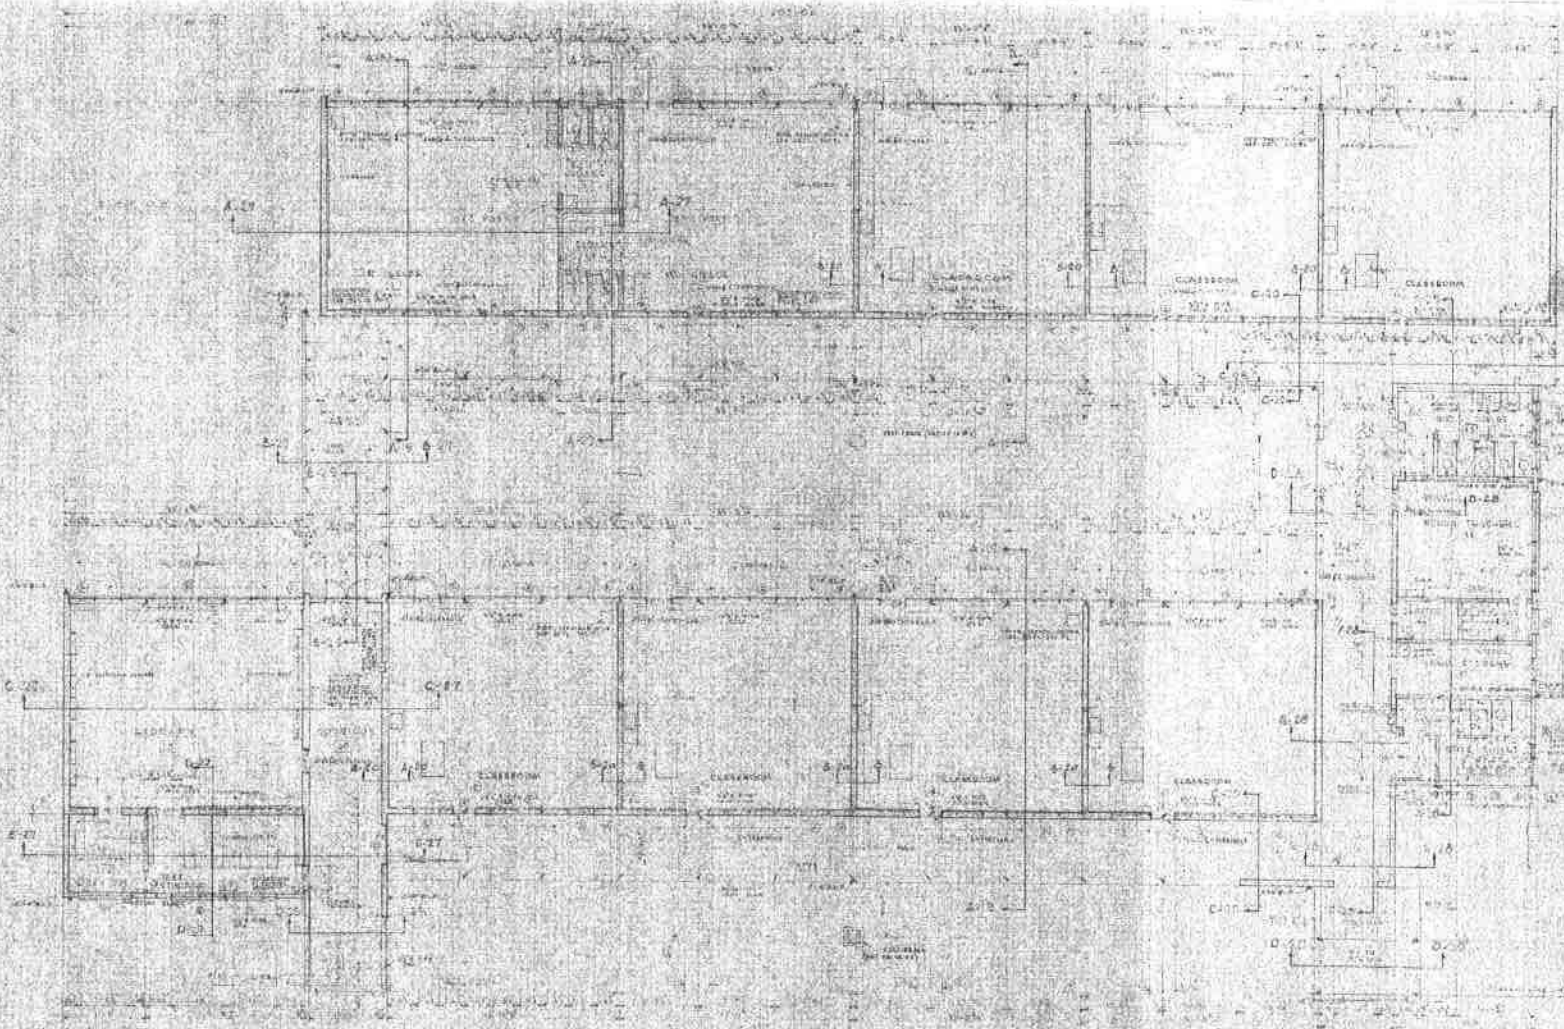

SEE 4. SCALE 1/8" = 1'-0" FOR DIMENSIONS

NO. 100-000-50


REVISIONS	
1	Initial design
2	Revised design
3	Final design
4	Construction documents
5	As built
6	Final
7	Final
8	Final
9	Final
10	Final

DESIGNED BY
 DRAWN BY
 CHECKED BY
 APPROVED BY
 DATE

APPROVED BY THE
 ARCHITECTURAL BOARD
 DATE

1970 ELEMENTARY SCHOOL PROJECT NO. 4
 FOURTH GRADE CLASSROOMS
 LAKELAND HIGH SCHOOL
 LAKELAND, FLORIDA

5

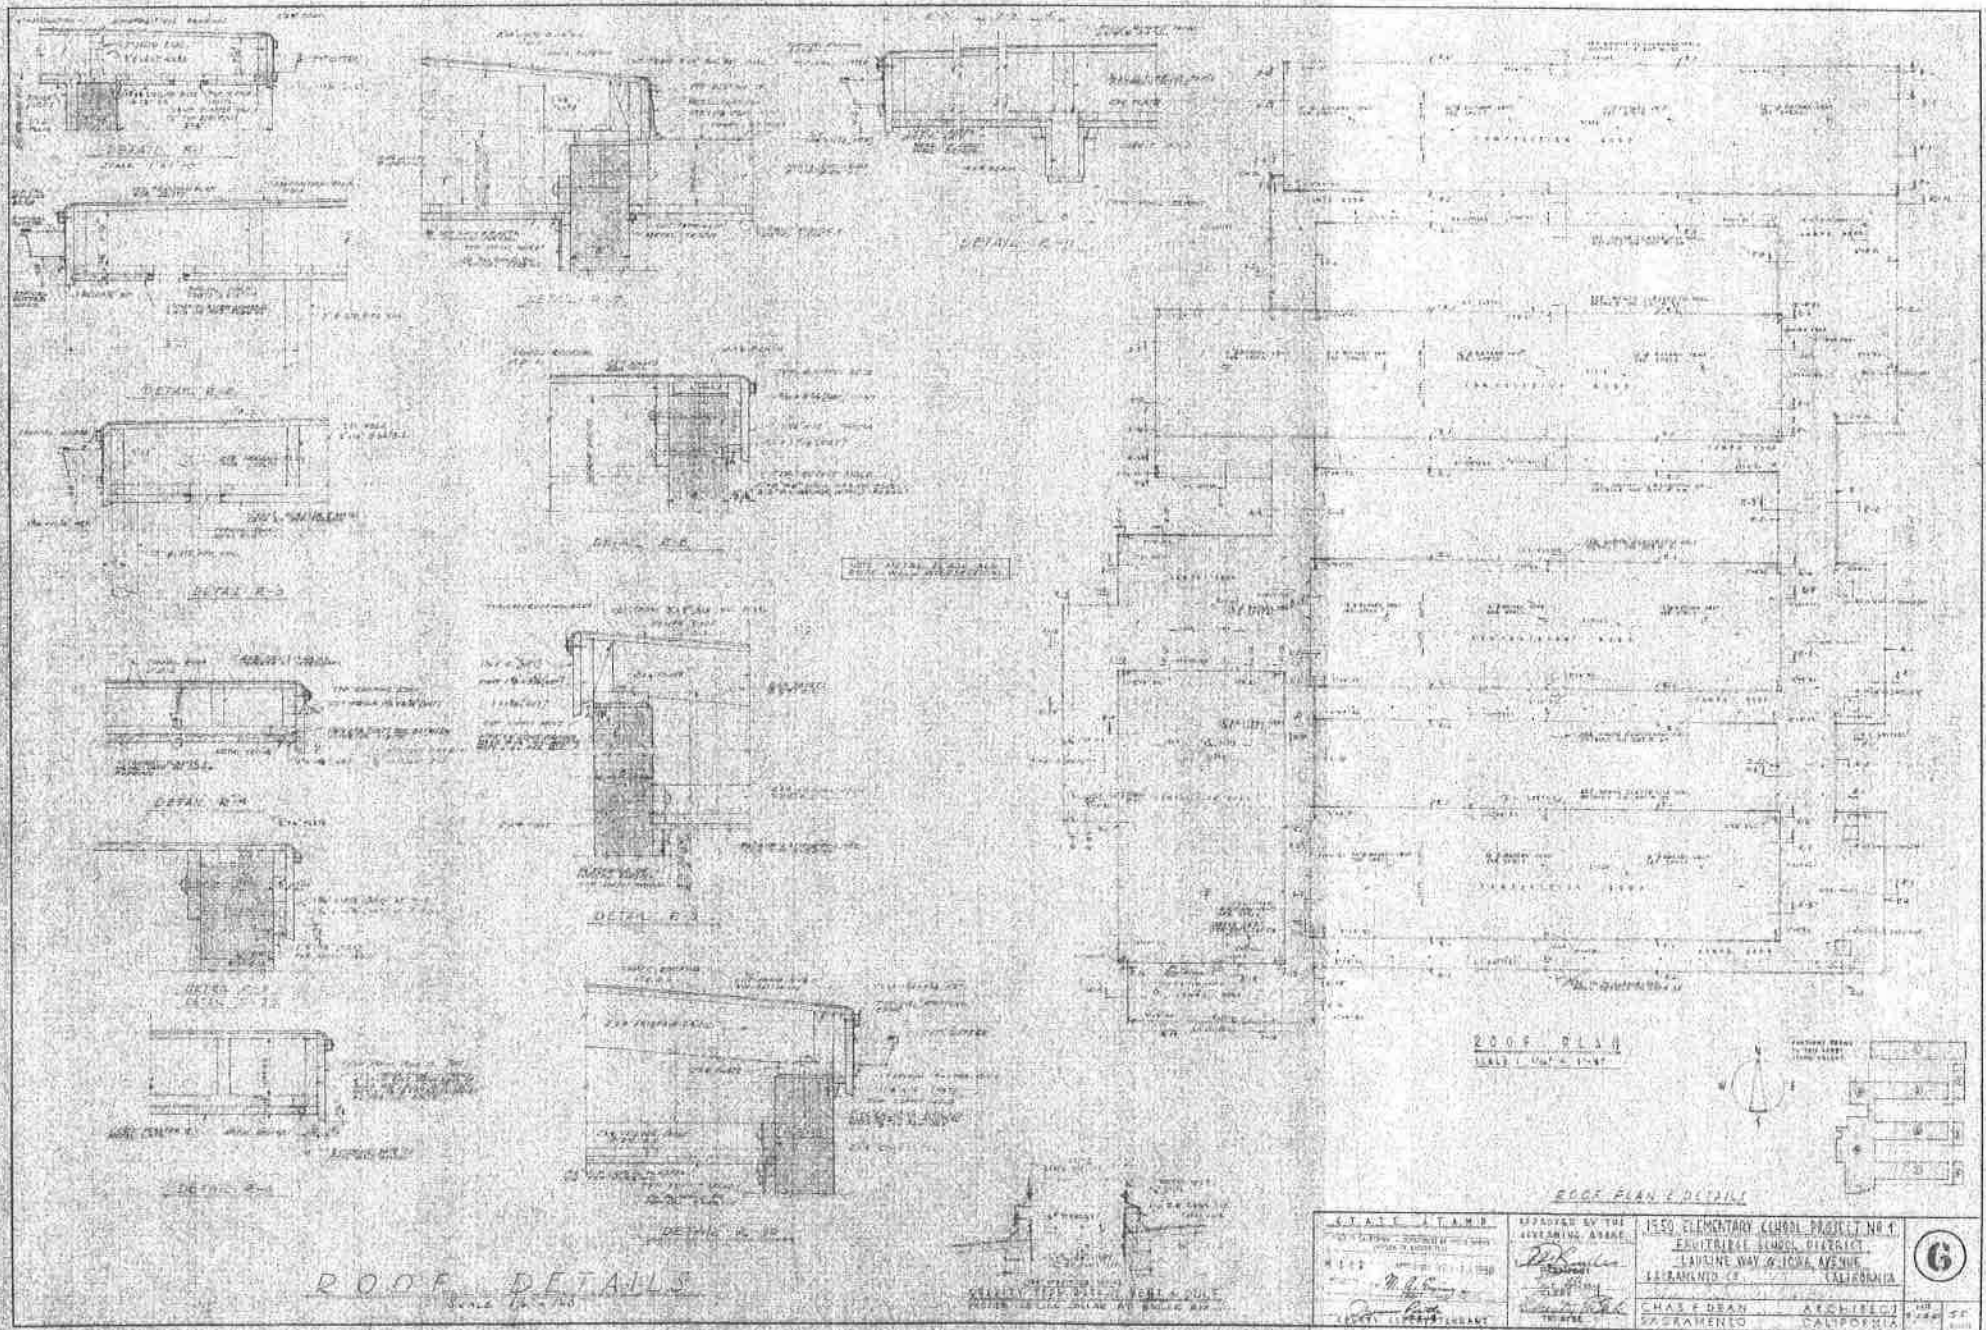

ROOF DETAILS


SCALE 1/8" = 1'-0"

STAINLESS STEEL VENTILATOR

ROOF PLAN
SCALE 1/8" = 1'-0"

ROOF PLAN & DETAILS


STATE STAMP APPROVED BY THE SACRAMENTO ARCHITECTURAL BOARD DATE 11-1-50 BY [Signature] [Signature]	APPROVED BY THE SACRAMENTO ARCHITECTURAL BOARD DATE 11-1-50 BY [Signature] [Signature]	1950 ELEMENTARY SCHOOL PROJECT NO. 1 EDWINA L. LUND, PRINCIPAL LAURENCE WAY & IOWA AVENUE SACRAMENTO, CALIFORNIA CHAS. DEAN ARCHITECT SACRAMENTO, CALIFORNIA	6
---	--	---	---

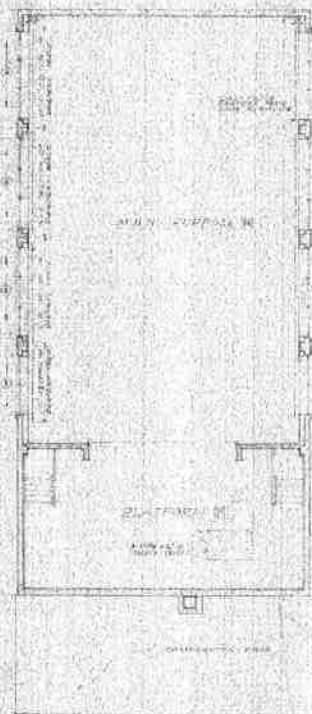


MAIN FLOOR
PLAN
SCALE 1/4" = 1'-0"




DETAIL 1
DETAIL 2

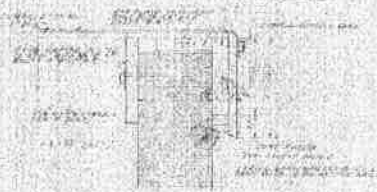


DETAIL 3

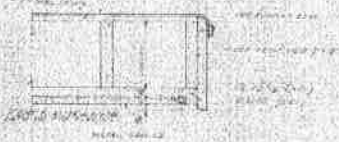

DETAIL 4

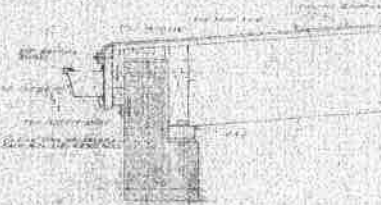


DETAIL 5

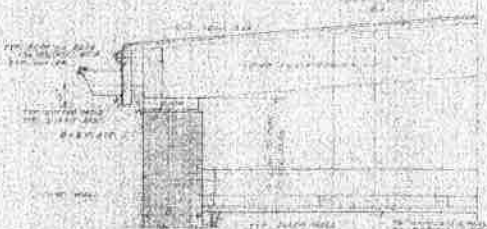


DETAIL 6


DETAILS

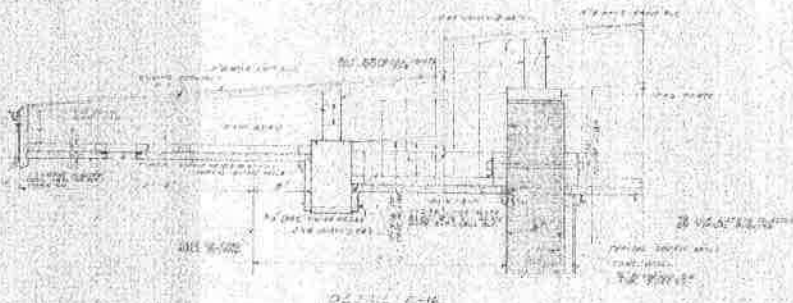


DETAIL 7

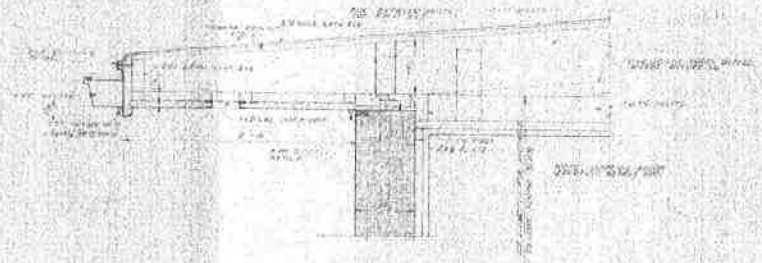

DETAIL 8

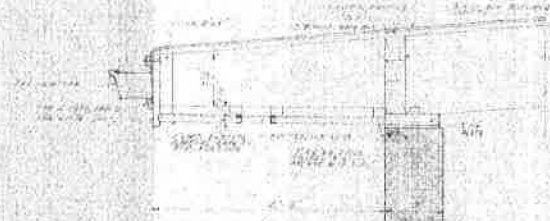


DETAIL 9

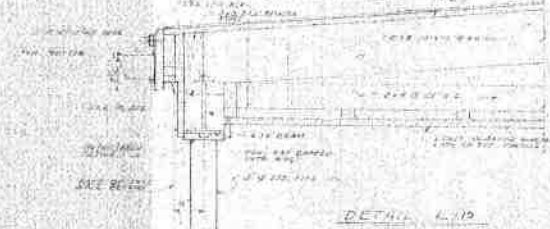

DETAIL 10


DETAILS

STATE OF CALIFORNIA COUNTY OF SACRAMENTO CITY OF SACRAMENTO	APPROVED BY THE GOVERNING BOARD OF THE BOARD OF SUPERVISORS	1930 ELEMENTARY SCHOOL PROJECT NO. 2 EDWINBURGH SCHOOL DISTRICT LAUREL WAY & IOWA AVENUE SACRAMENTO, CALIFORNIA	
CHAS. F. DEAN ARCHITECT	CHAS. F. DEAN ARCHITECT	CHAS. F. DEAN ARCHITECT	CHAS. F. DEAN ARCHITECT

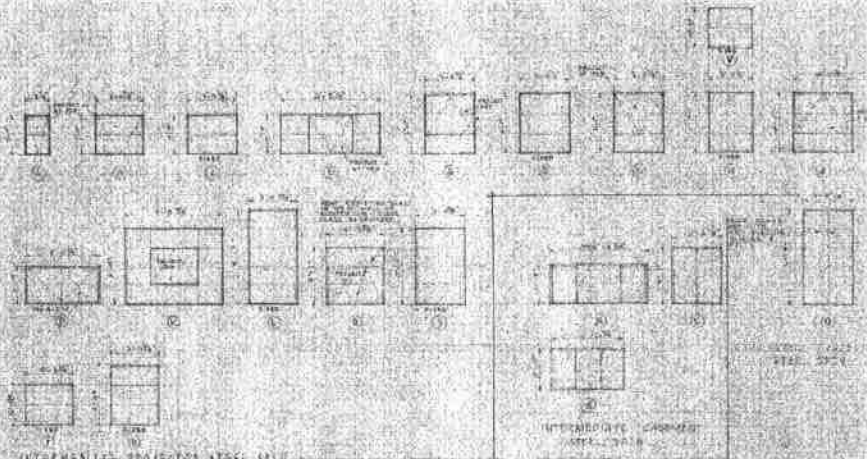

WINDOW SCHEDULE

NOTE: ALL WINDOWS SHOWN ARE TO BE INSTALLED WITH THE FOLLOWING FINISHES: INTERIOR - WHITE PAPER, EXTERIOR - WHITE PAPER. ALL WINDOWS TO BE INSTALLED WITH THE FOLLOWING FINISHES: INTERIOR - WHITE PAPER, EXTERIOR - WHITE PAPER.

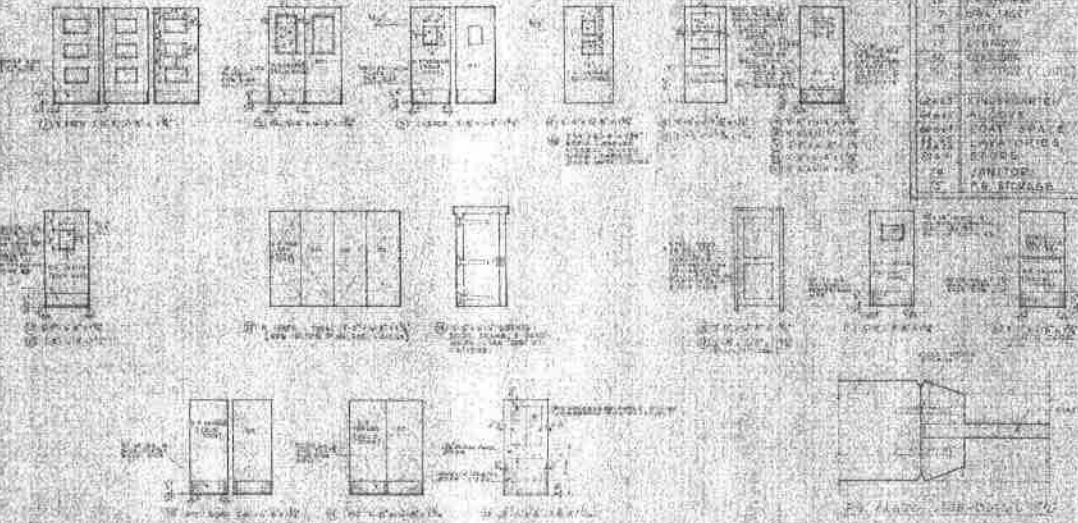

DOOR SCHEDULE

NOTE: ALL DOORS SHOWN ARE TO BE INSTALLED WITH THE FOLLOWING FINISHES: INTERIOR - WHITE PAPER, EXTERIOR - WHITE PAPER.

FINISH SCHEDULE											
NO.	DESCRIPTION	FLOOR	WALL	CEILING	DOOR	WINDOW	WALL	CEILING	DOOR	WINDOW	WALL
1	10' x 10' x 10'										
2	10' x 10' x 10'										
3	10' x 10' x 10'										
100	10' x 10' x 10'										

FINISH SCHEDULE	
1	10' x 10' x 10'
2	10' x 10' x 10'
3	10' x 10' x 10'
100	10' x 10' x 10'

APPROVED BY THE ARCHITECT

DATE: 10/10/10

BY: [Signature]

APPROVED BY THE ENGINEER

DATE: 10/10/10

BY: [Signature]

INSTRUMENTAL ENGINEER PROJECT NO. 1

PROJECT: 100' x 100' x 100'

LOCATION: 100' x 100' x 100'


CITY: 100' x 100' x 100'

STATE: 100' x 100' x 100'

COUNTRY: 100' x 100' x 100'

CHART & BEAN ARCHITECTS


SACRAMENTO CALIFORNIA

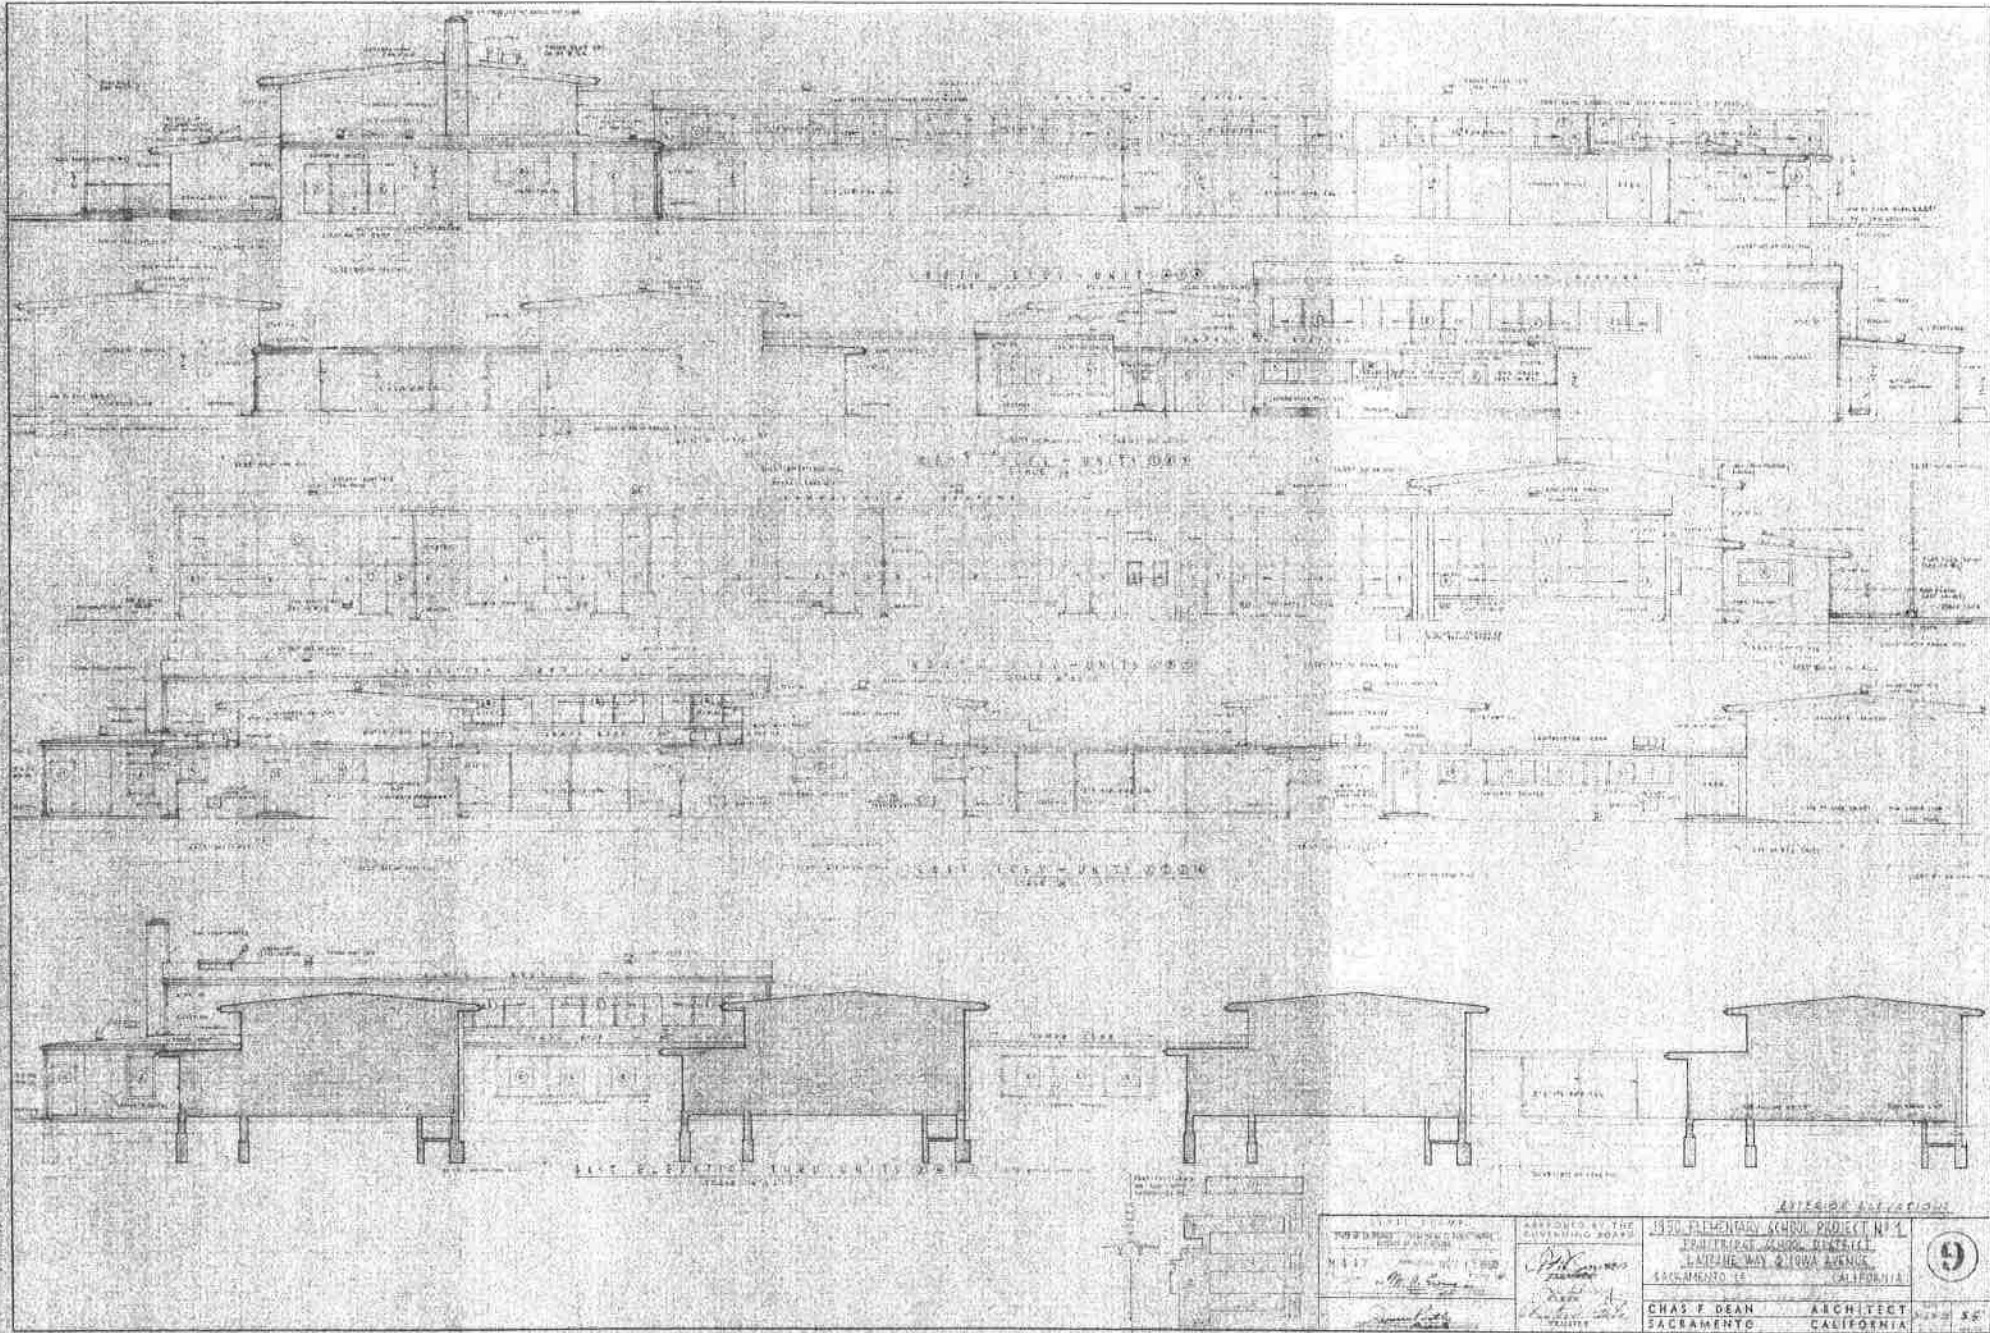

<p>1950 ELEMENTARY SCHOOL PROJECT NO. 1 1950 ELEMENTARY SCHOOL DISTRICT LATHAM WAY & 10TH AVENUE SACRAMENTO 16 CALIFORNIA</p>		<p>9</p>
<p>CHAS. F. DEAN ARCHITECT SACRAMENTO</p>	<p>ARCHITECT CALIFORNIA</p>	



NORTH HALL 1ST FLOOR UNIT 100

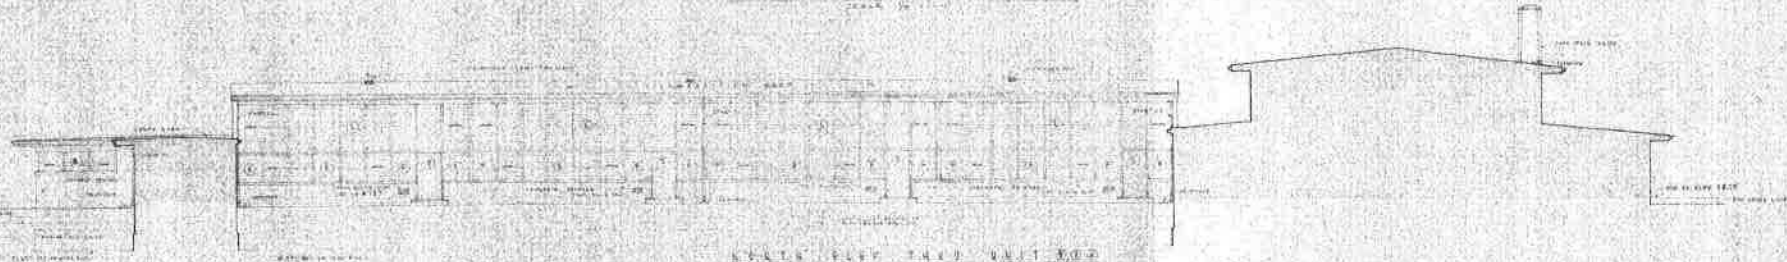

NORTH HALL 2ND FLOOR UNIT 100



NORTH HALL 3RD FLOOR UNIT 100



NORTH HALL 4TH FLOOR UNIT 100



<p>1150 ELEMENTARY SCHOOL PROJECT #21 EMBUDGE SCHOOL DISTRICT LAURENCE WAY & IOWA AVENUE SACRAMENTO 12 CALIFORNIA</p>		<p>10</p>
<p>CHAS F DEAN SACRAMENTO</p>	<p>ARCHITECT CALIFORNIA</p>	



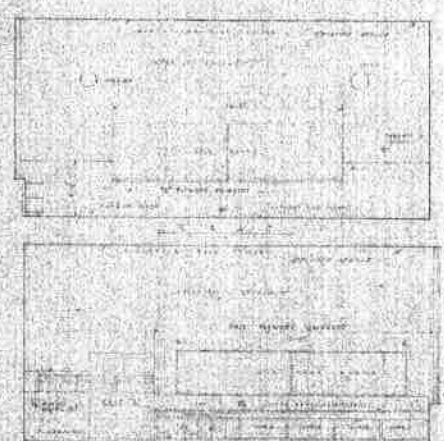


FIG. 1 PLASTIC COUNTER TOP DETAILS



TABLE 1			
Parameter	Value	Unit	Reference
ρ	1.0	g/cm ³	[1]
μ	0.01	cm ² /g	[2]
σ	0.01	cm ² /g	[3]
τ	0.01	cm ² /g	[4]
η	0.01	cm ² /g	[5]
θ	0.01	cm ² /g	[6]
ϕ	0.01	cm ² /g	[7]
χ	0.01	cm ² /g	[8]
ψ	0.01	cm ² /g	[9]
ω	0.01	cm ² /g	[10]
ν	0.01	cm ² /g	[11]
ξ	0.01	cm ² /g	[12]
ζ	0.01	cm ² /g	[13]
η	0.01	cm ² /g	[14]
θ	0.01	cm ² /g	[15]
ϕ	0.01	cm ² /g	[16]
χ	0.01	cm ² /g	[17]
ψ	0.01	cm ² /g	[18]
ω	0.01	cm ² /g	[19]
ν	0.01	cm ² /g	[20]
ξ	0.01	cm ² /g	[21]
ζ	0.01	cm ² /g	[22]
η	0.01	cm ² /g	[23]
θ	0.01	cm ² /g	[24]
ϕ	0.01	cm ² /g	[25]
χ	0.01	cm ² /g	[26]
ψ	0.01	cm ² /g	[27]
ω	0.01	cm ² /g	[28]
ν	0.01	cm ² /g	[29]
ξ	0.01	cm ² /g	[30]
ζ	0.01	cm ² /g	[31]
η	0.01	cm ² /g	[32]
θ	0.01	cm ² /g	[33]
ϕ	0.01	cm ² /g	[34]
χ	0.01	cm ² /g	[35]
ψ	0.01	cm ² /g	[36]
ω	0.01	cm ² /g	[37]
ν	0.01	cm ² /g	[38]
ξ	0.01	cm ² /g	[39]
ζ	0.01	cm ² /g	[40]
η	0.01	cm ² /g	[41]
θ	0.01	cm ² /g	[42]
ϕ	0.01	cm ² /g	[43]
χ	0.01	cm ² /g	[44]
ψ	0.01	cm ² /g	[45]
ω	0.01	cm ² /g	[46]
ν	0.01	cm ² /g	[47]
ξ	0.01	cm ² /g	[48]
ζ	0.01	cm ² /g	[49]
η	0.01	cm ² /g	[50]
θ	0.01	cm ² /g	[51]
ϕ	0.01	cm ² /g	[52]
χ	0.01	cm ² /g	[53]
ψ	0.01	cm ² /g	[54]
ω	0.01	cm ² /g	[55]
ν	0.01	cm ² /g	[56]
ξ	0.01	cm ² /g	[57]
ζ	0.01	cm ² /g	[58]
η	0.01	cm ² /g	[59]
θ	0.01	cm ² /g	[60]
ϕ	0.01	cm ² /g	[61]
χ	0.01	cm ² /g	[62]
ψ	0.01	cm ² /g	[63]
ω	0.01	cm ² /g	[64]
ν	0.01	cm ² /g	[65]
ξ	0.01	cm ² /g	[66]
ζ	0.01	cm ² /g	[67]
η	0.01	cm ² /g	[68]
θ	0.01	cm ² /g	[69]
ϕ	0.01	cm ² /g	[70]
χ	0.01	cm ² /g	[71]
ψ	0.01	cm ² /g	[72]
ω	0.01	cm ² /g	[73]
ν	0.01	cm ² /g	[74]
ξ	0.01	cm ² /g	[75]
ζ	0.01	cm ² /g	[76]
η	0.01	cm ² /g	[77]
θ	0.01	cm ² /g	[78]
ϕ	0.01	cm ² /g	[79]

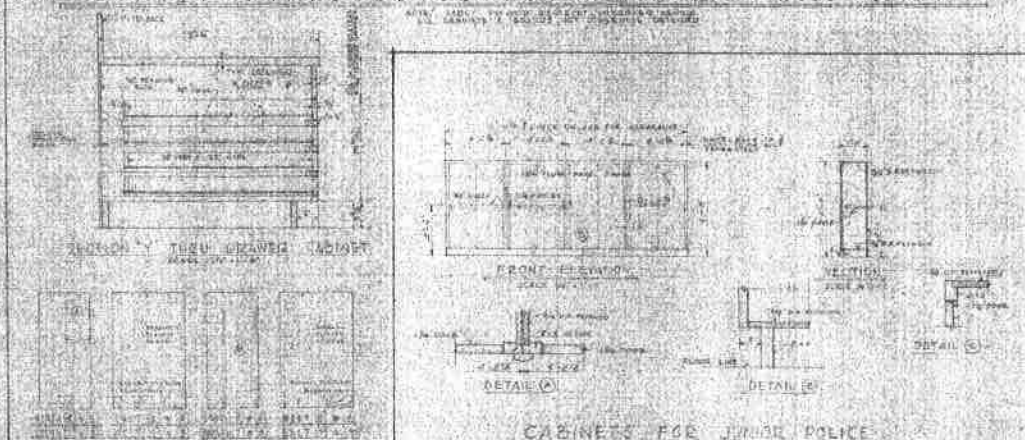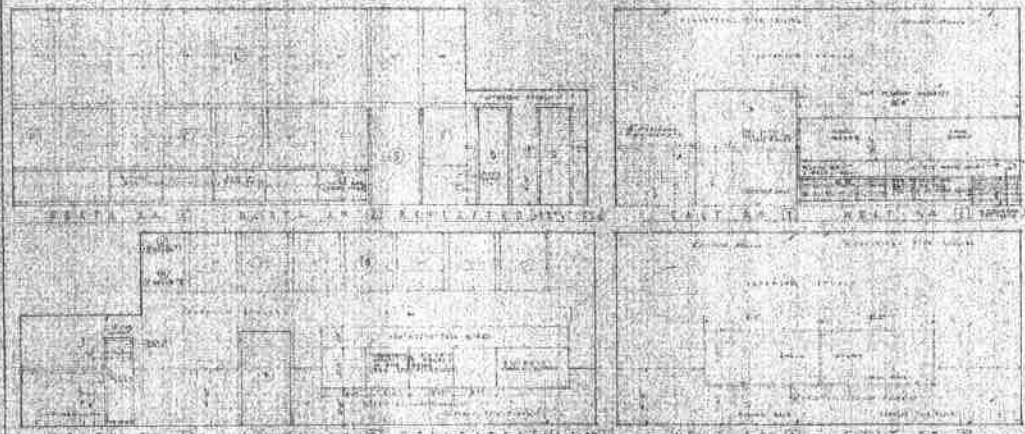



SOUTH WEST
STORAGE ROOM 52

1950 ELEMENTARY SCHOOL PROJECT NO. 1
FRUIT VEG SCHOOL DIST. CT.
LAUREL WAY & LOWE AVENUE
SALAMANCA CT CALIFORNIA

CHAS F DEAN	ARCHITECT
SACRAMENTO	CALIFORNIA

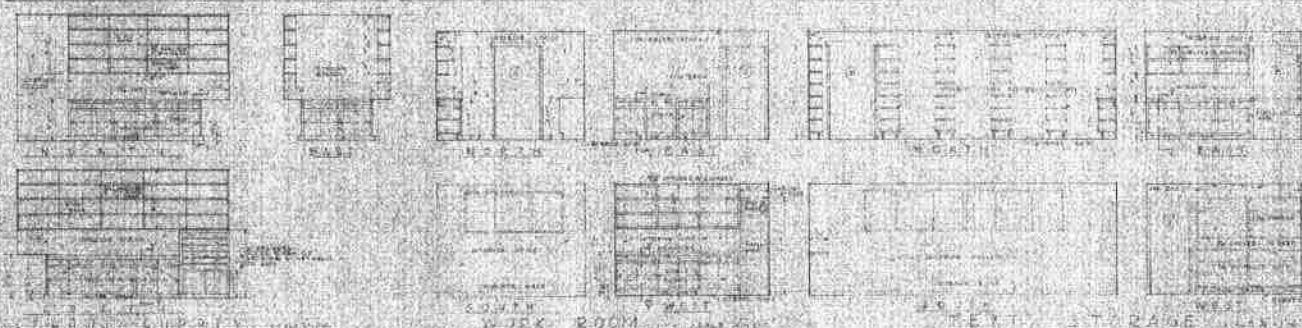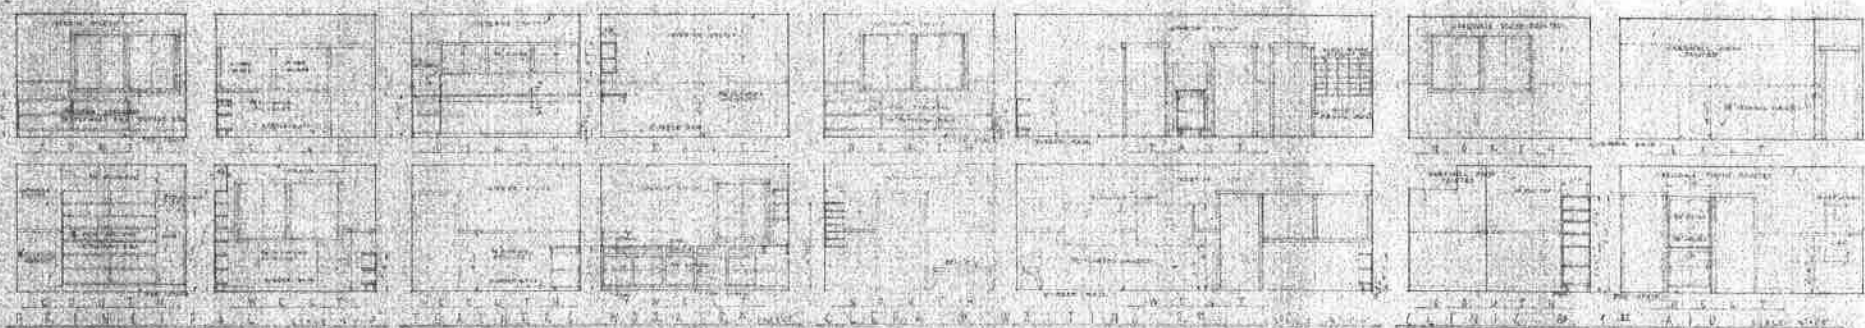


BENCH DETAIL & WAITING BR.

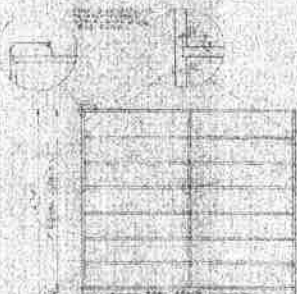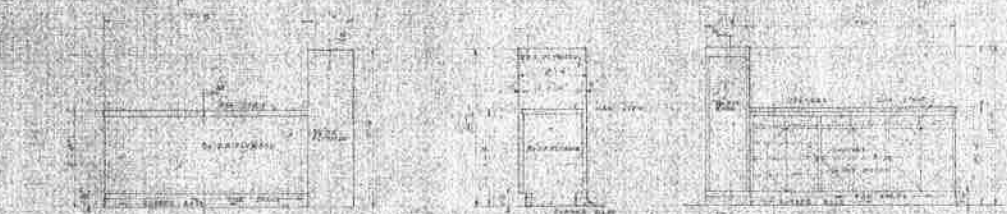

DOUBLE STACKS IN TEST STORAGE




CABINET DETAIL

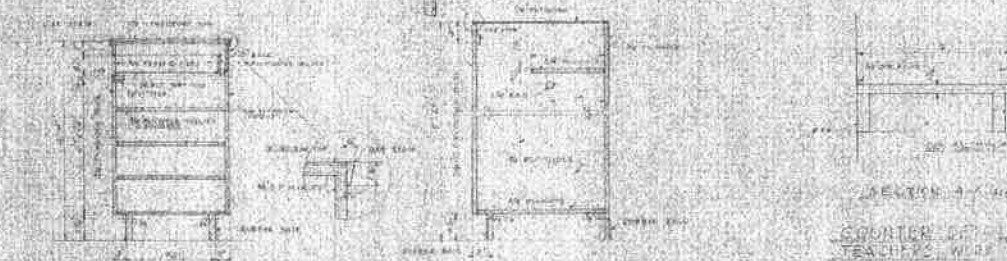

COUNTER IN TEACHERS WAIT BR.

COUNTER & COAT CABINET DETAILS IN POLYX WAITING BR. NO. 30

6344 1950	APPROVED BY THE SUPERINTENDING BOARD 	1950 ELEMENTARY SCHOOL PROJECT NO. 1 LAMARDALE SCHOOL DISTRICT LAMARDALE, WY 82040 AVENUE SACRAMENTO, CALIFORNIA	14
CHAS. E. DEAN SACRAMENTO	ARCHITECT CALIFORNIA	CHAS. E. DEAN SACRAMENTO	ARCHITECT CALIFORNIA

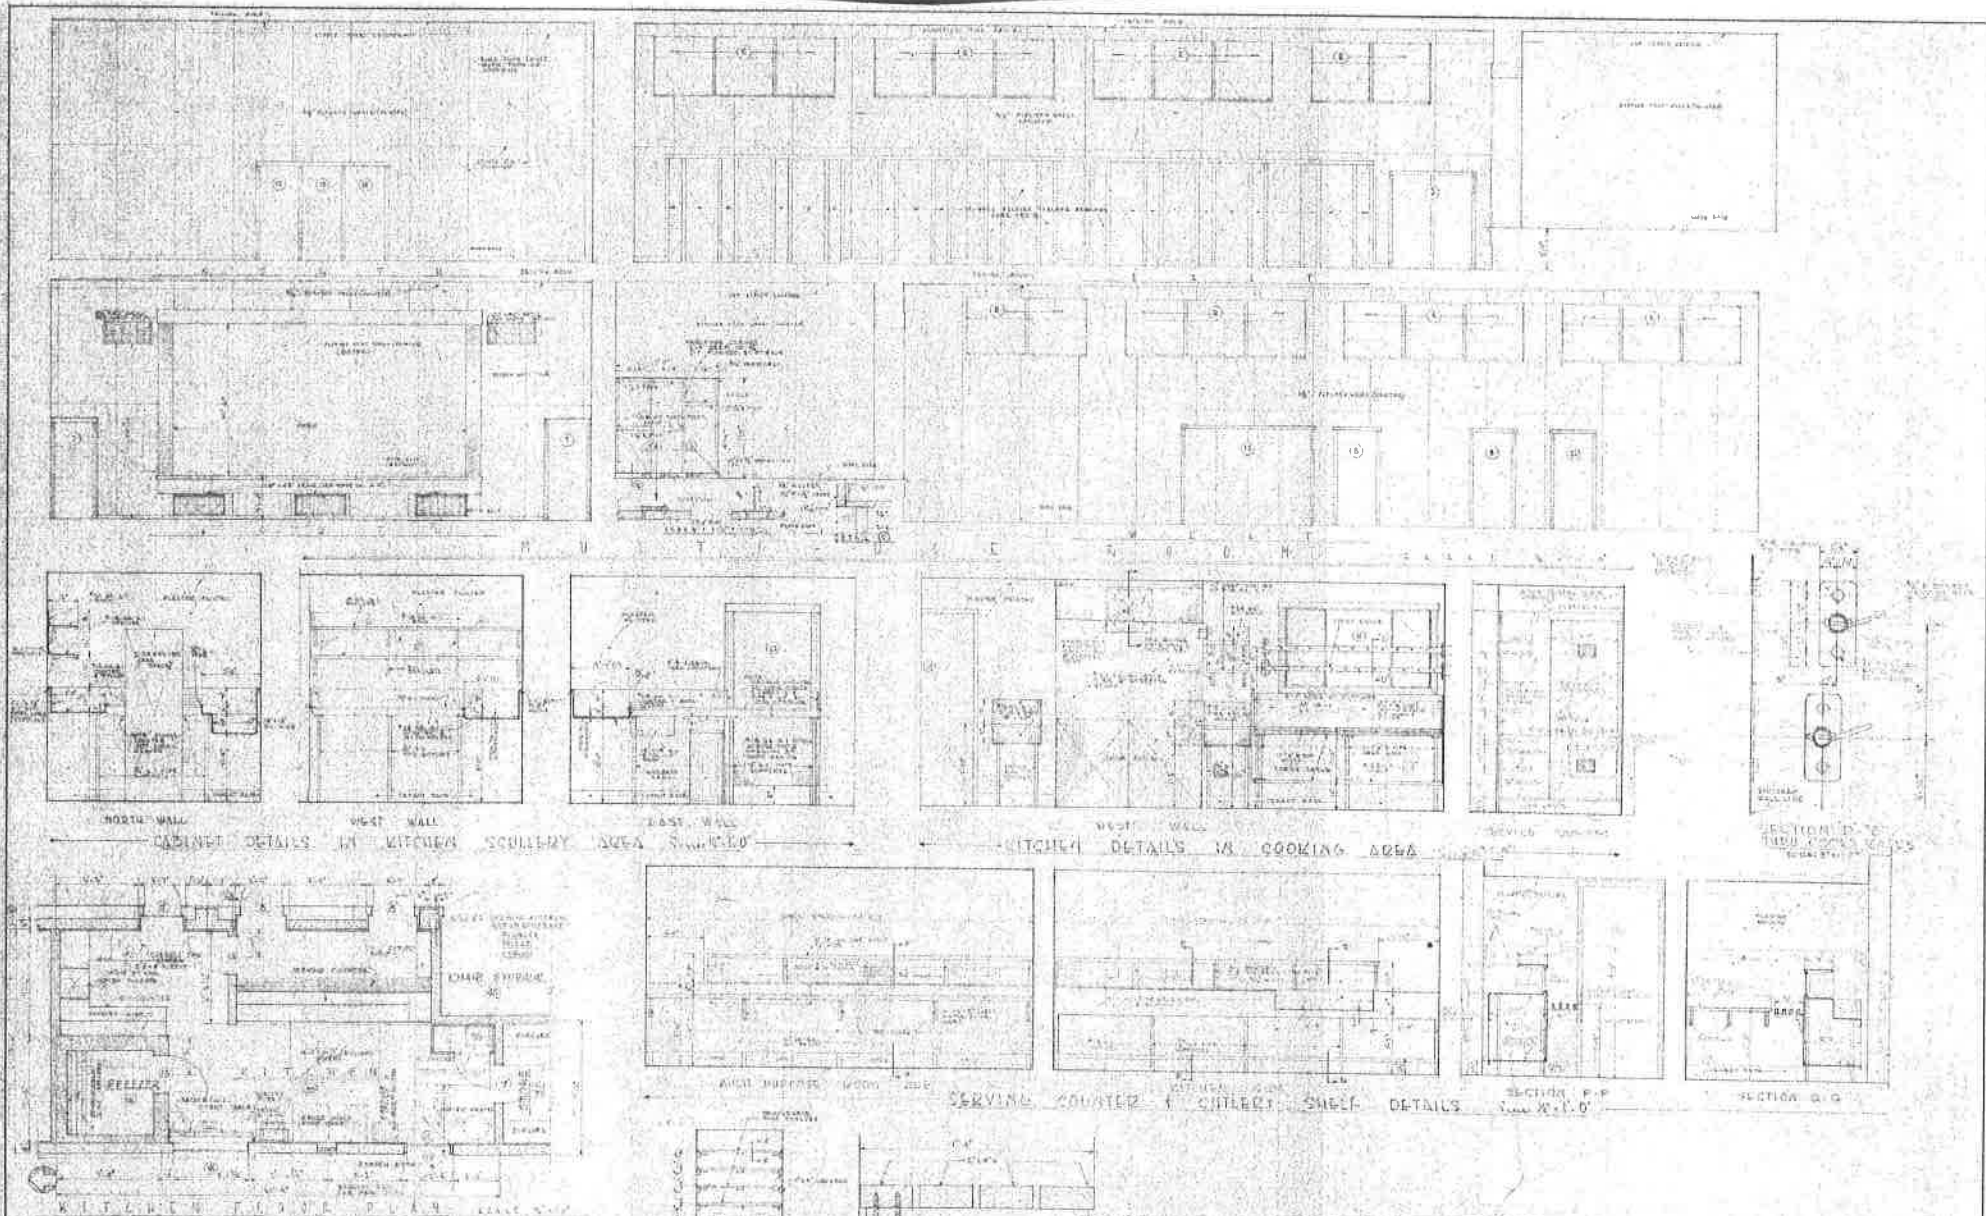

ELEVATION OF DELICIOUS IN FREEZER
SCALE: 1/4" = 1'-0"

FREEZER SHELF DETAIL X-X
SCALE: 1/4" = 1'-0"

SERVING COUNTER & CUPBOARD SHELF DETAILS
SCALE: 1/4" = 1'-0"

SECTION P-P
SCALE: 1/4" = 1'-0"

SECTION Q-Q
SCALE: 1/4" = 1'-0"

APPROVED BY THE GOVERNING BOARD
DATE: NOV 11 1950
BY: *[Signature]*

APPROVED BY THE ARCHITECT
DATE: NOV 11 1950
BY: *[Signature]*

1950 ELMHURST SCHOOL PROJECT NO. 1
ERNEST R. SIMON, ARCHT.
SACRAMENTO 16, CALIFORNIA


16

CHAS F DEAN
SACRAMENTO


ARCHITECT
SACRAMENTO

CHAS F DEAN
SACRAMENTO


16

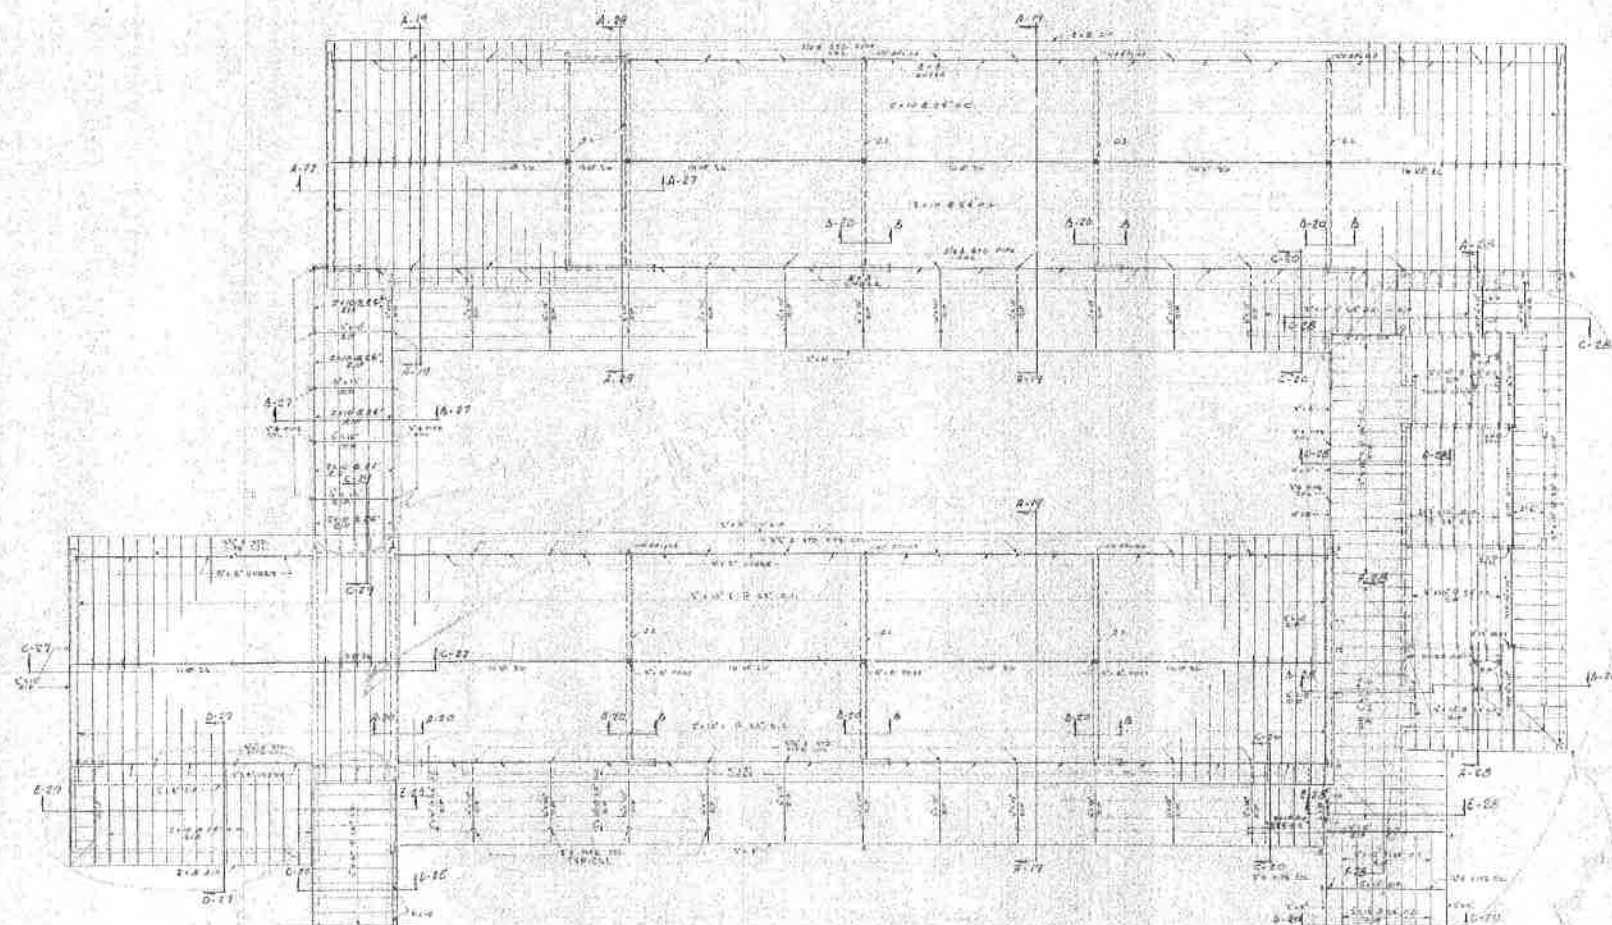


ROOF FRAMING PLAN Scale: 1/8" = 1'-0"

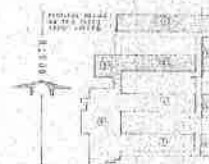


STATE STAMP		APPROVED BY THE GOVERNING BOARD		1950 ELEMENTARY SCHOOL PROJECT AT EBBETTSVILLE SCHOOL DISTRICT		18
RECEIVED	APR 17 1950	CHAS. F. DEAN	ARCHITECT	SACRAMENTO	CALIFORNIA	

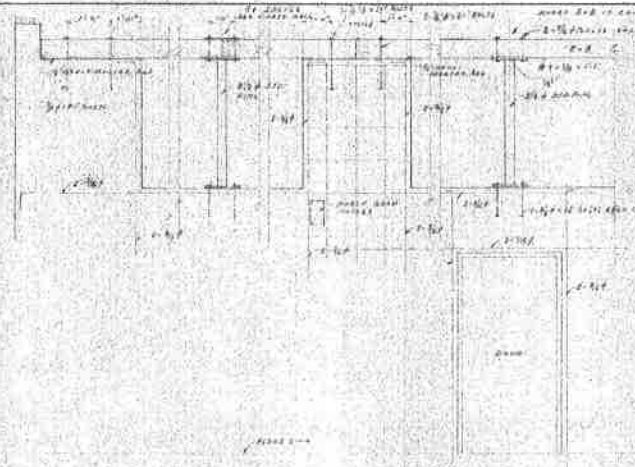


TYPICAL SOUTH WALL FRAMING

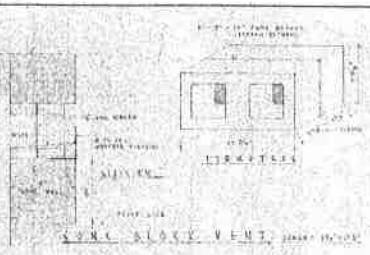

SYNC SLAB VENT




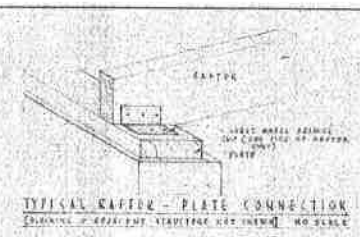


TYPICAL GUTTER - PLATE CONNECTION
DRAWING OF GUTTER - PLATE CONNECTION


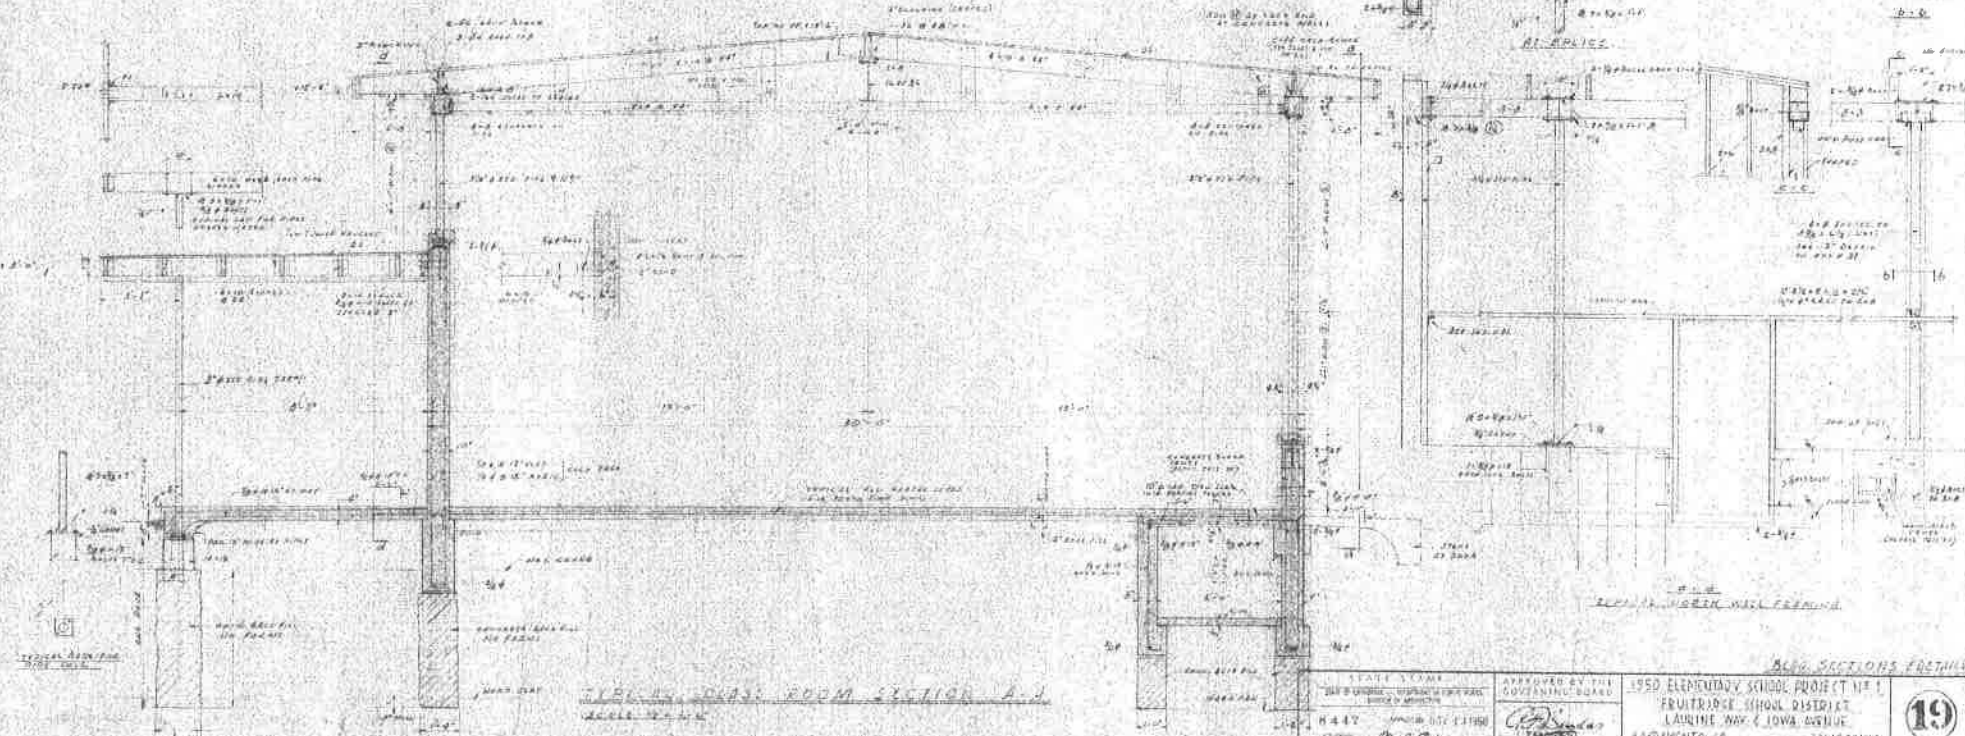


TYPICAL CLASS ROOM SECTION A-A

SCALE 1/8" = 1'-0" DATE 10-10-1950 DRAWN BY H. H. H. CHECKED BY J. J. J. APPROVED BY THE GOV. BOARD	1950 ELEMENTARY SCHOOL PROJECT NO. 1 FRUITRIDGE SCHOOL DISTRICT LAUREL WAY & JOWA AVENUE SACRAMENTO, CA CHAS. F. DEAN ARCHITECT SACRAMENTO, CALIFORNIA	19
---	--	----

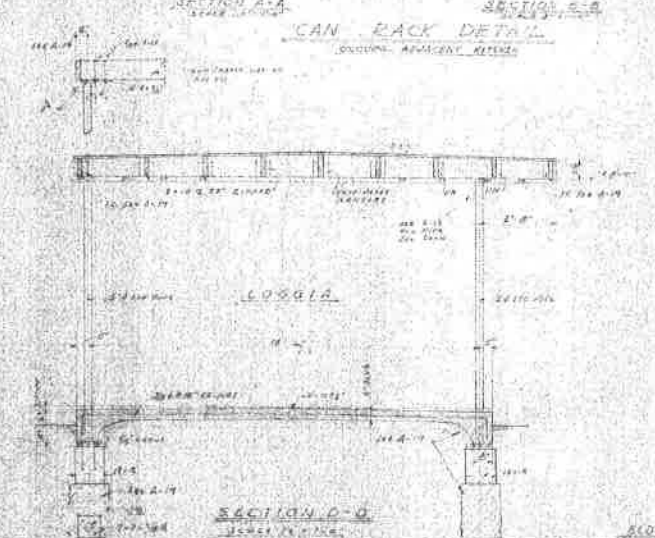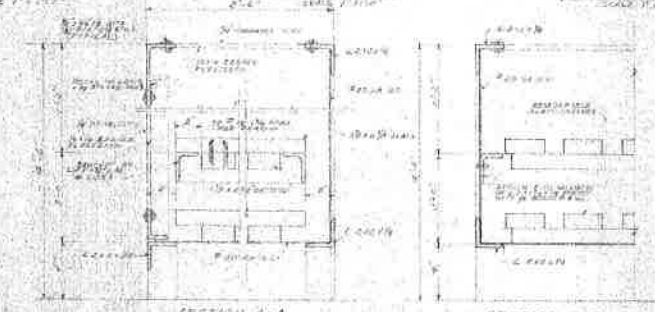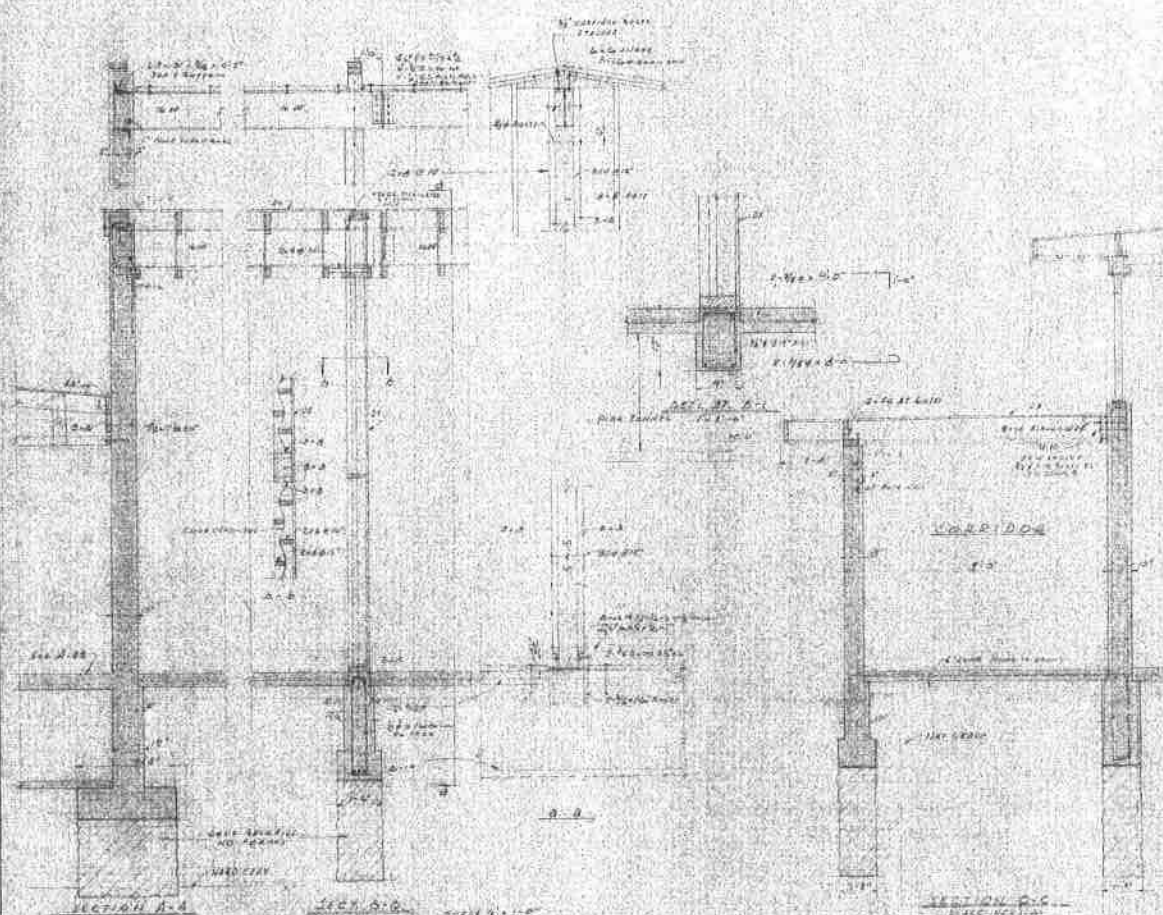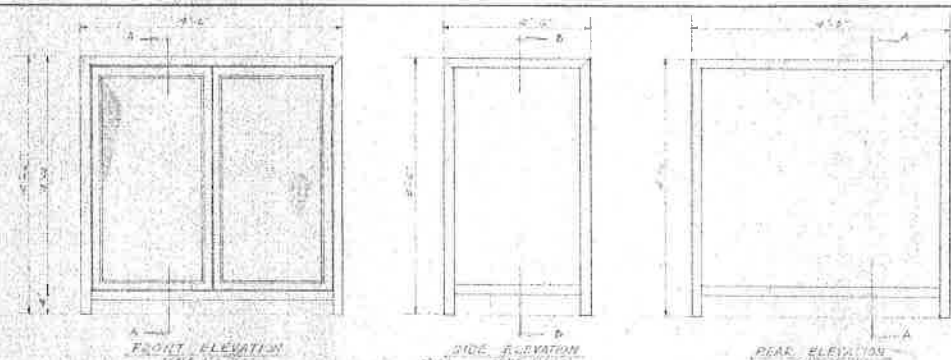

<p>APPROVED BY THE GOVERNING BOARD</p> <p>6-1-57 APPROVED NOV 19 1958</p> <p>CHAS. F. DEAN</p>	<p>APPROVED BY THE GOVERNING BOARD</p> <p>CHAS. F. DEAN</p>	<p>1950 ELEMENTARY SCHOOL PROJECT NO. 1 SACRAMENTO SCHOOL DISTRICT LAUREL WAY & JONES AVENUE SACRAMENTO, CALIFORNIA</p> <p>CHAS. F. DEAN ARCHITECT SACRAMENTO CALIFORNIA</p>
--	---	--

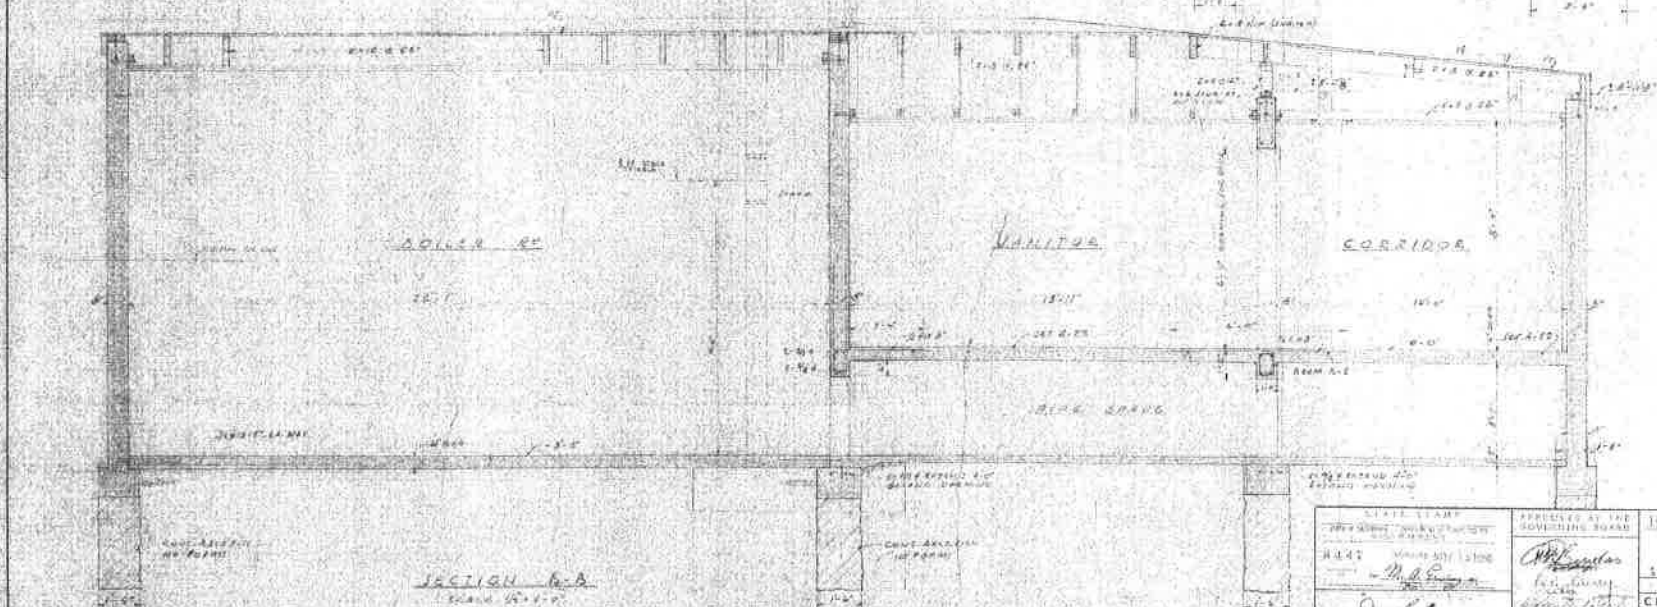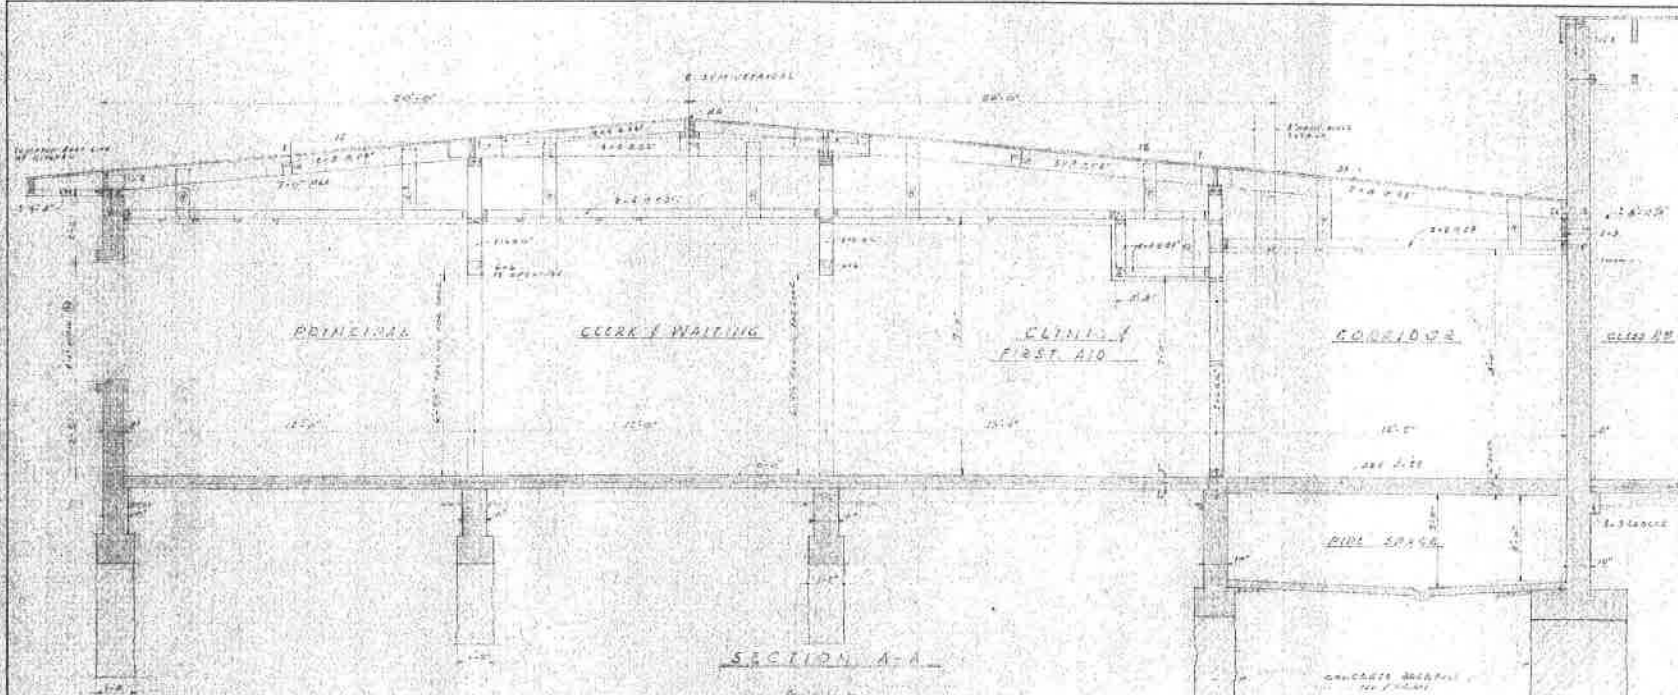


STATE STAMP
APPROVED FOR THE
GOV. BY 12100
MAY 1910
J. D. G. G. G.



APPROVED AT THE
GOV. BY 12100
MAY 1910
J. D. G. G. G.

1150 ELEMENTARY SCHOOL PROJECT NO. 1
SACRAMENTO SCHOOL DISTRICT
LAWRENCE HAY & SONS ARCHT.
SACRAMENTO, CALIFORNIA
CHAS. F. DEAN
SACRAMENTO
ARCHITECT
CALIFORNIA


21

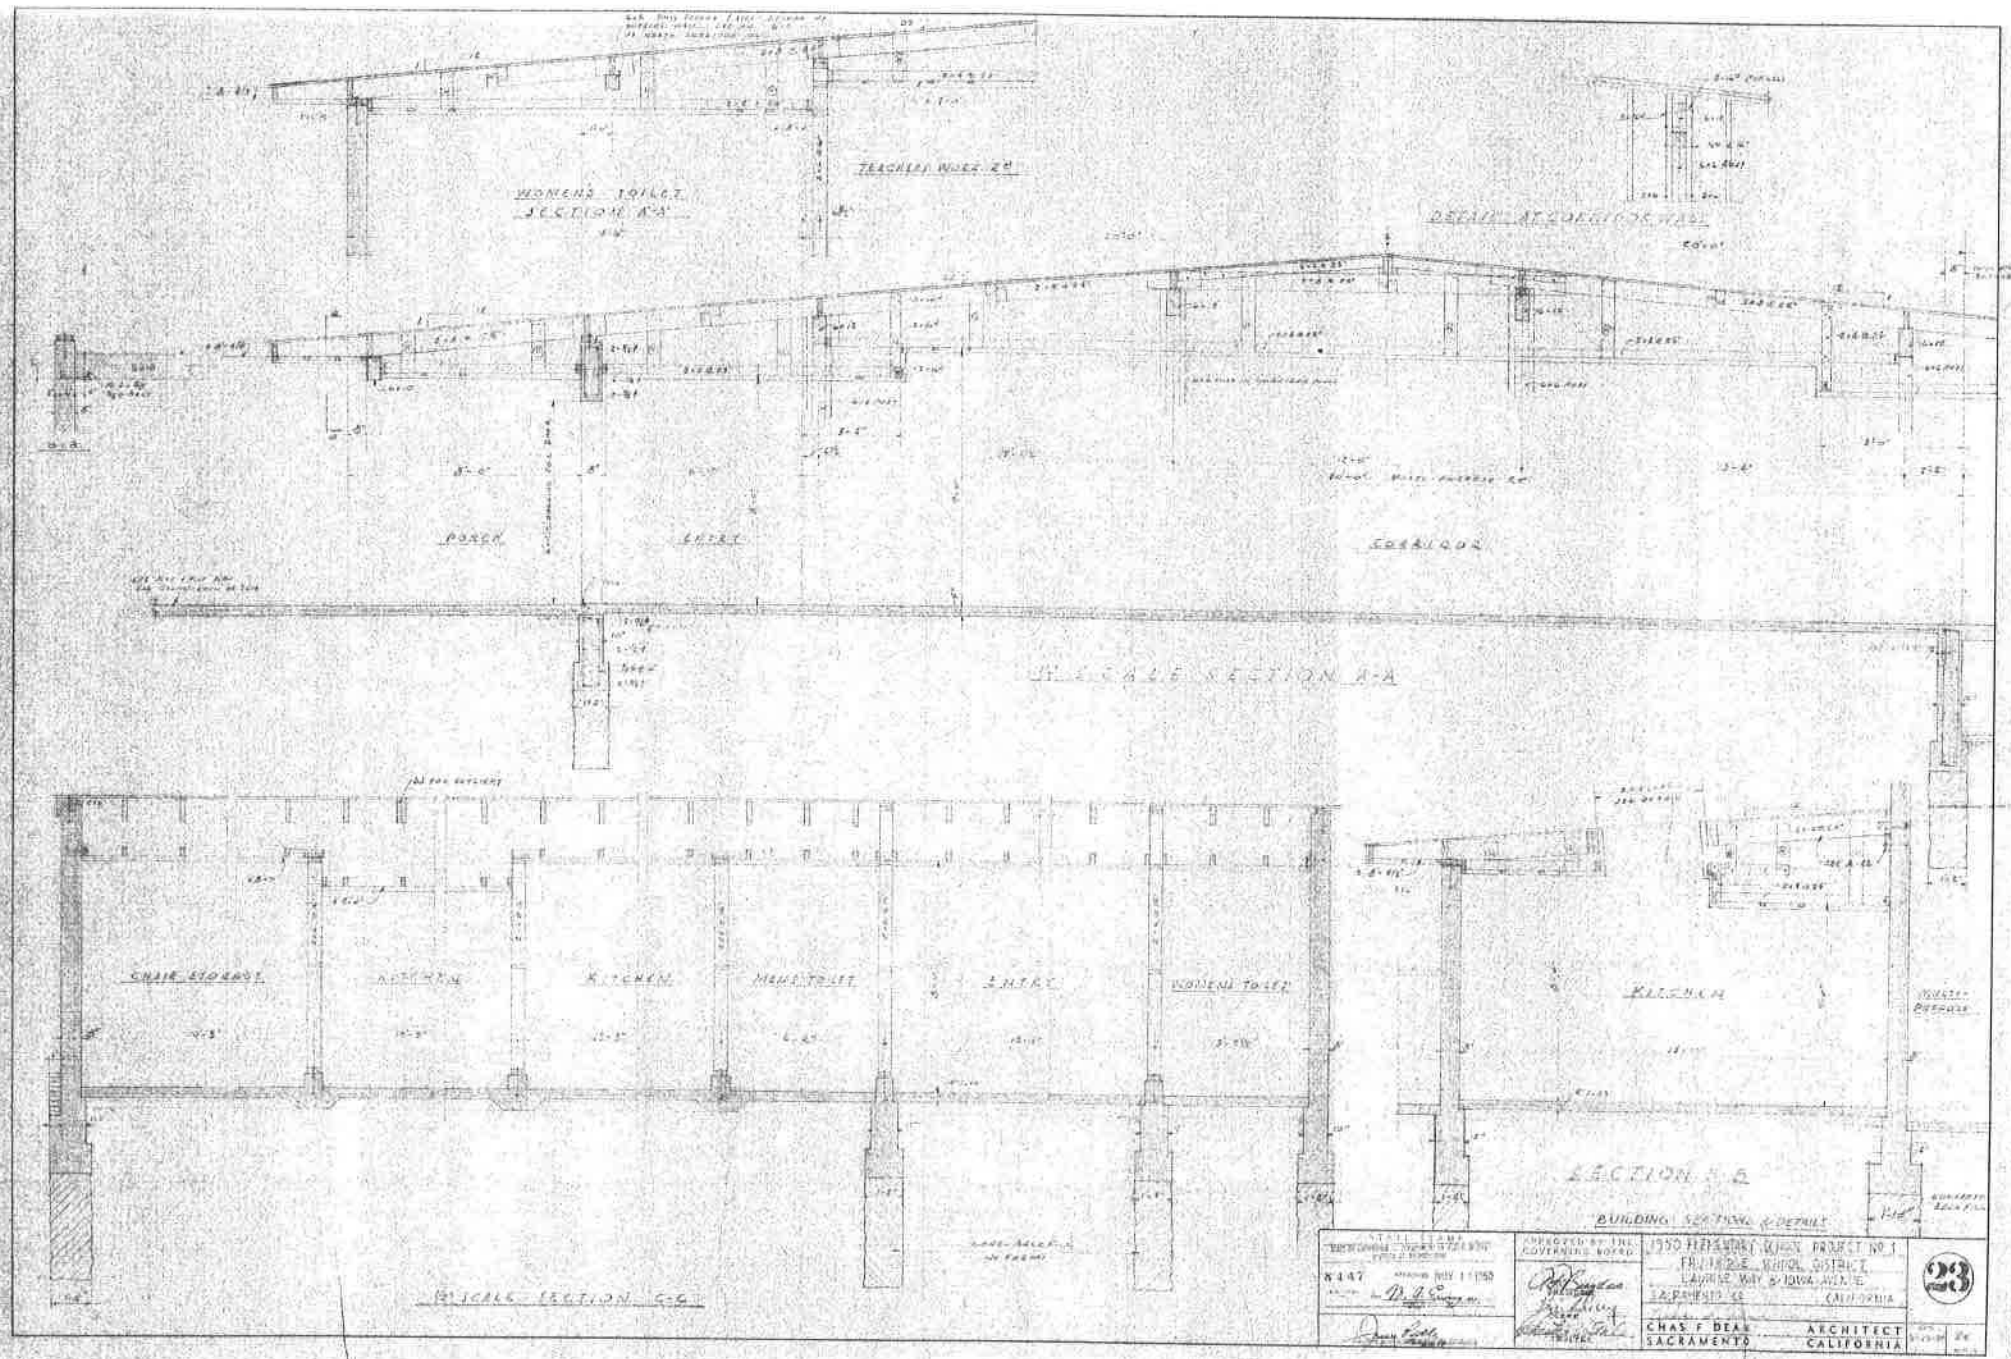


STEEL CASE THERMOMETER COVER TYPICAL FIELD SECTION 8447 APPROVED JULY 1 1950 BY <i>M. J. C. [Signature]</i> CHAS. F. DEAL SACRAMENTO		APPROVED BY THE COVERING BOARD <i>[Signature]</i> 1950 PLAYWRIGHT UNION PROJECT NO. 1 FAIRFIELD UNION DISTRICT LAURENCE WAY & IOWA AVE. E. SACRAMENTO 32 CALIFORNIA CHAS. F. DEAL SACRAMENTO ARCHITECT CALIFORNIA		23
---	--	---	--	----

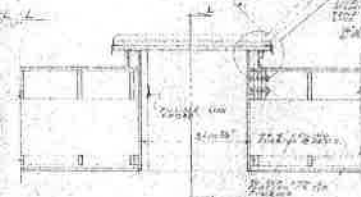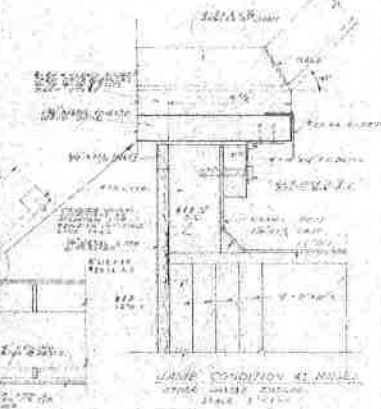


SMOKE VENT DETAIL OVER PLATFORM

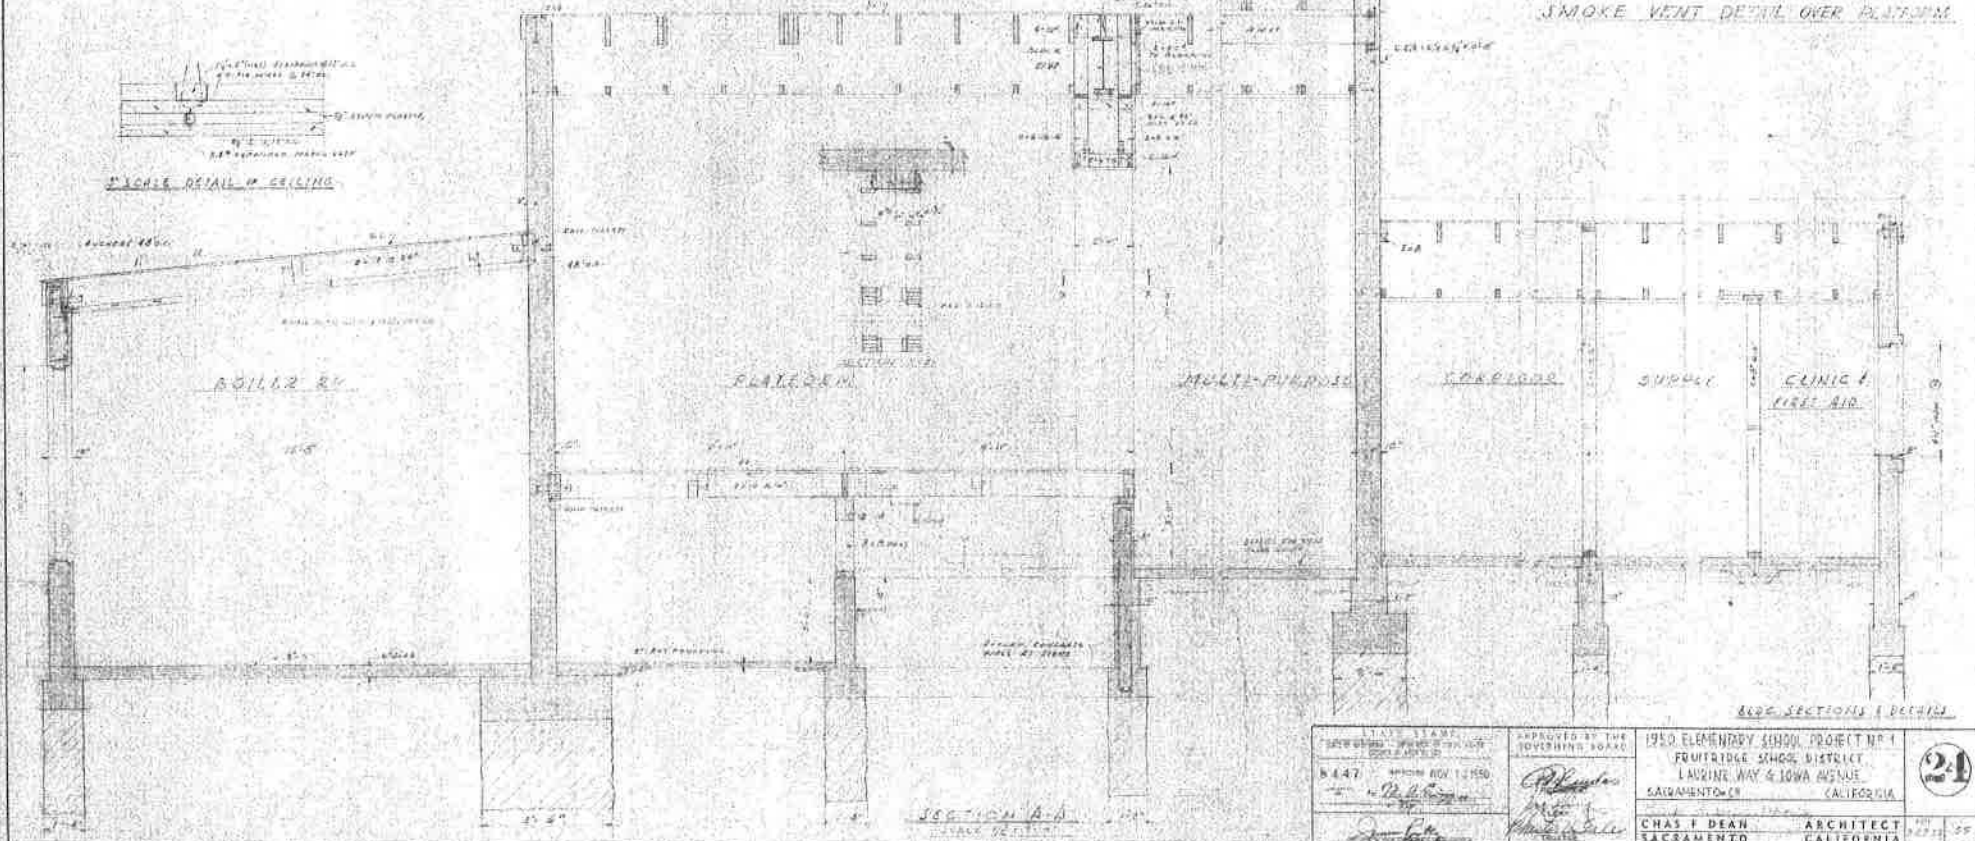

<p>STAMP RECORDED INDEXED MAY 1 1910 SACRAMENTO</p>	<p>APPROVED BY THE TOWNSHIP BOARD CHAS. F. DEAN ARCHITECT</p>	<p>1910 ELEMENTARY SCHOOL, PROJECT NO. 1 FOURTH GRADE SCHOOL DISTRICT LAURENCE WAY & IOWA AVENUE SACRAMENTO, CALIFORNIA</p>
---	---	---

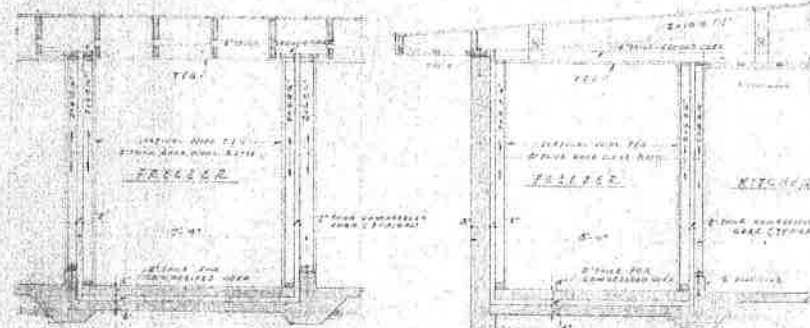

SECTION E-E

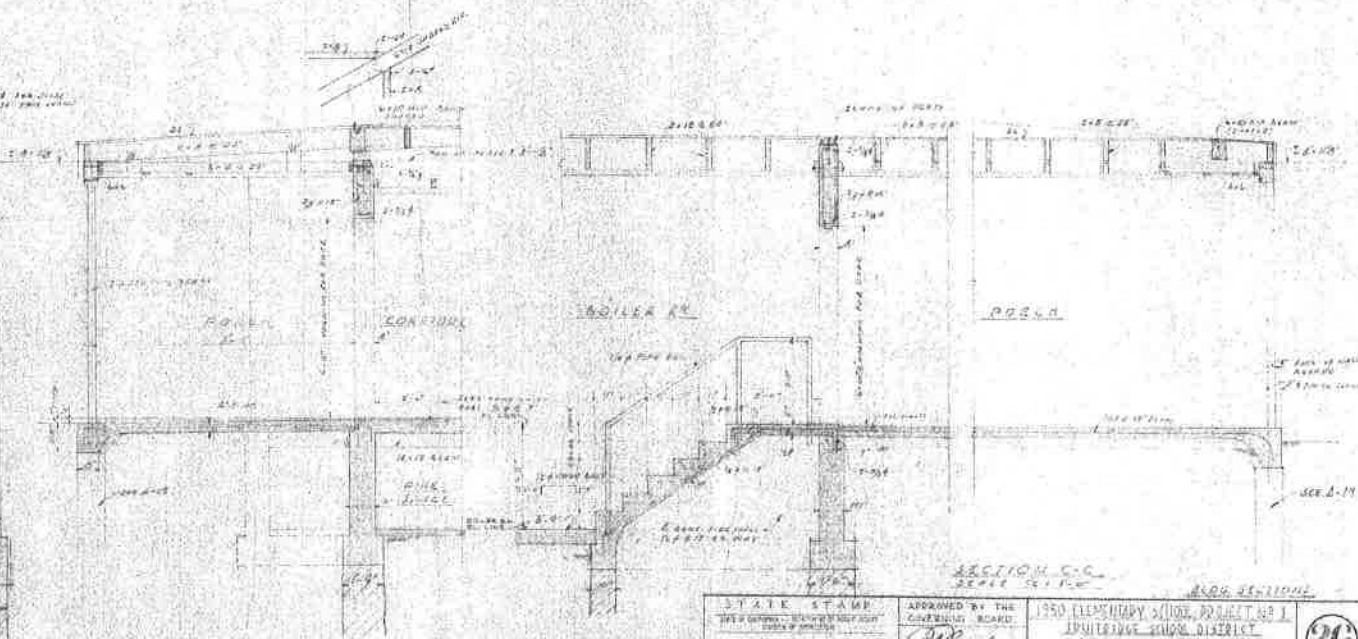


SECTION B-6

UNITED STATES
APPROVED NOV 1 1952
M447
W. H. P. S.


APPROVED BY THE
GOV. BOARD
Chas. B. Ryan
Chas. B. Ryan
Chas. B. Ryan

1950 ELEMENTARY SCHOOL PROJECT #1	
FURNITURE SHOP DISTRICT	
LARKINE WAY & IOWA AVENUE	
SACRAMENTO, CA	CALIFORNIA
CHAS F DEAN	ARCHITECT
SACRAMENTO	CALIFORNIA


26

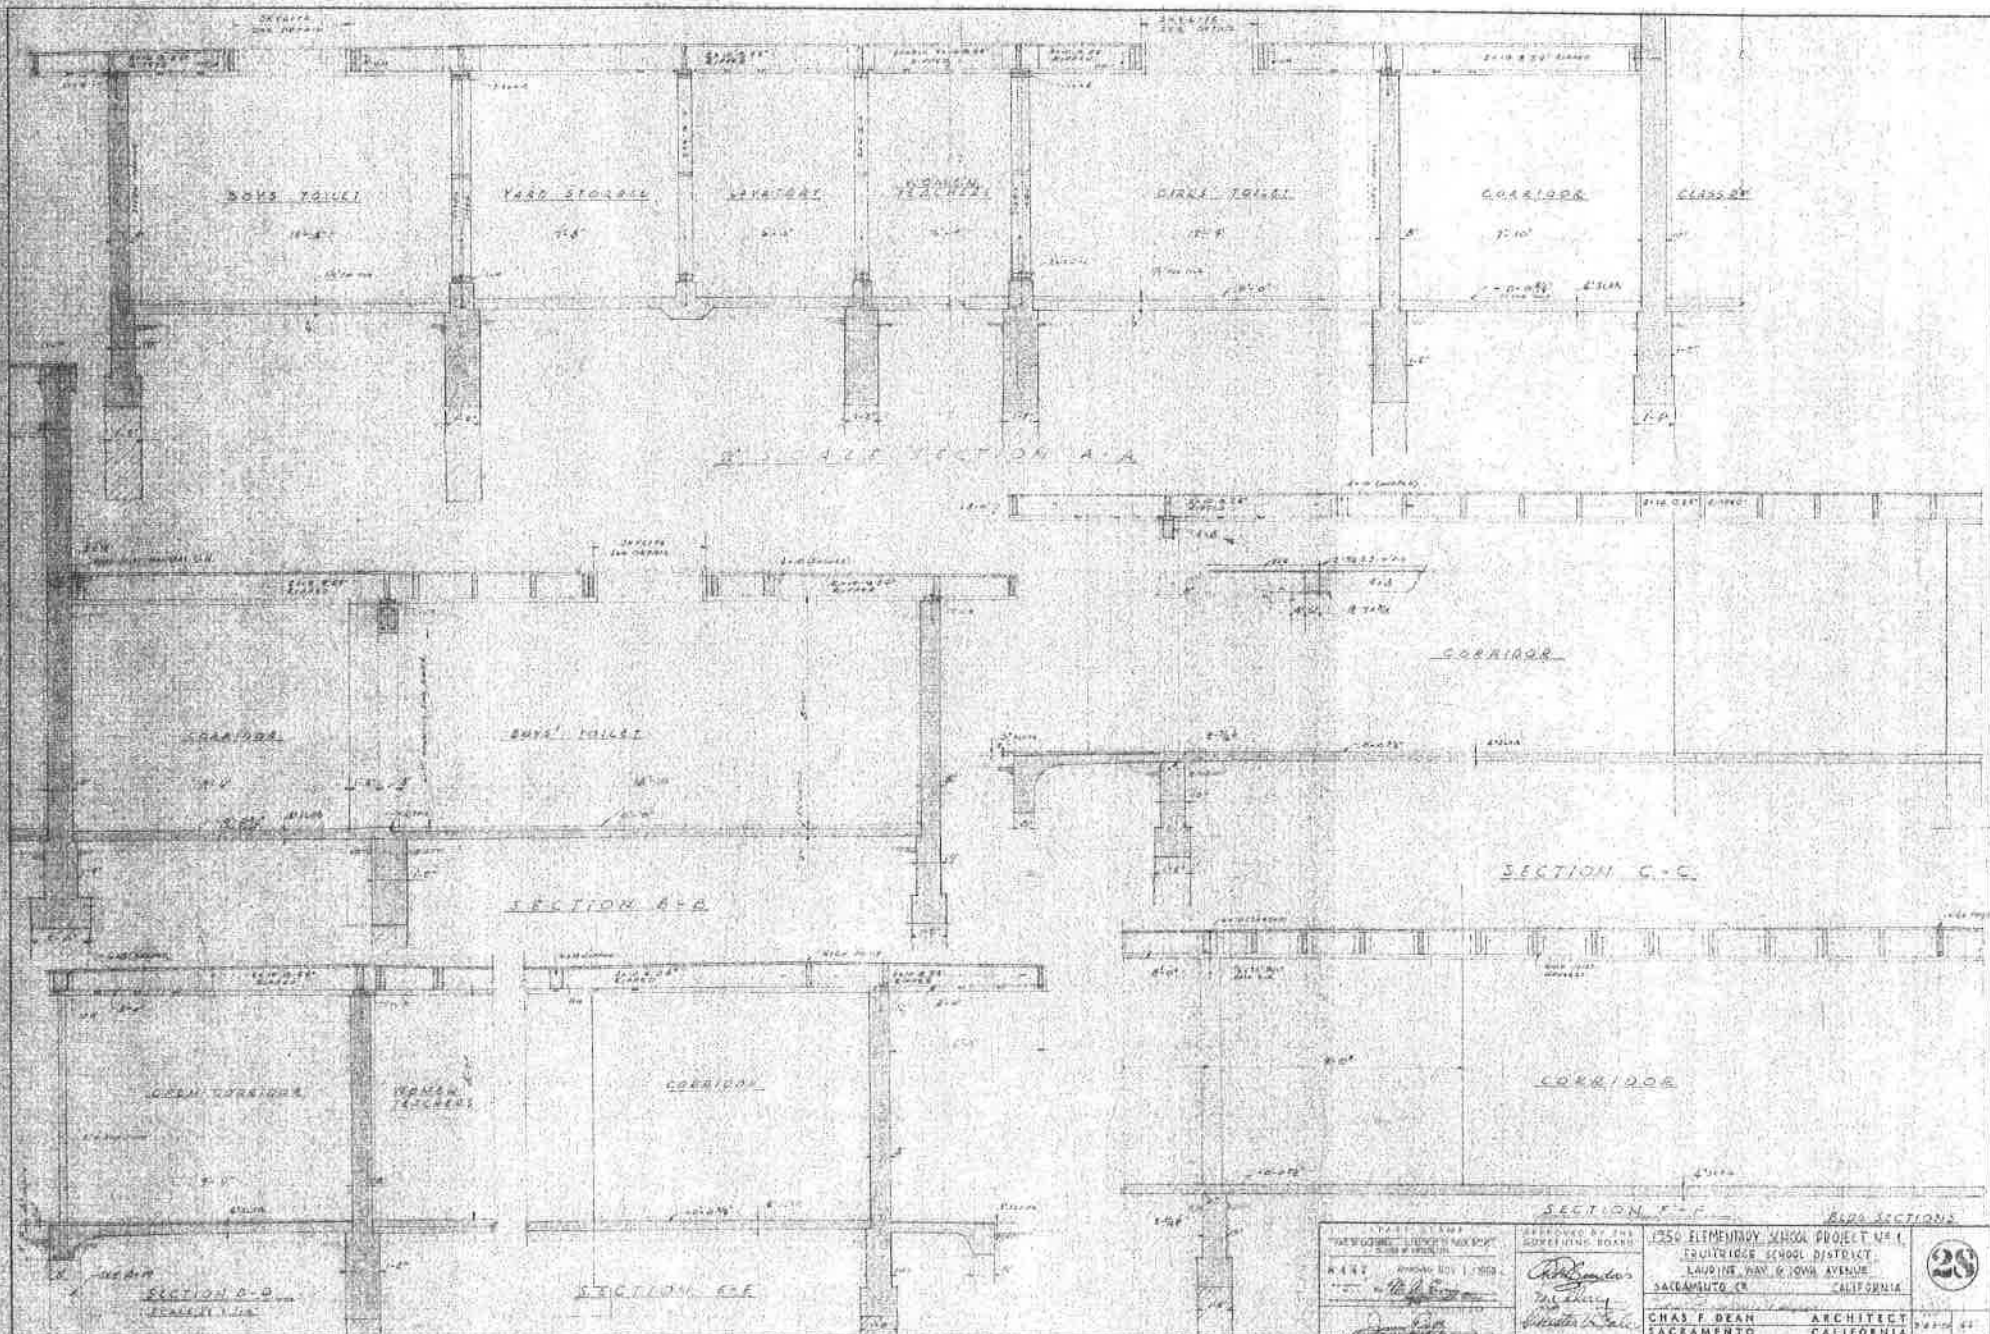

BUILDING SECTIONS		BUILDING SECTIONS	
DATE: 1911	DESIGNED BY: CHAS. F. DEAN	1250 ELEMENTARY SCHOOL PROJECT NO. 1	28
APPROVED BY THE BOARD OF SUPERVISORS	CHAS. F. DEAN	TRULOCK SCHOOL DISTRICT	
		LAUDING WAY & JONAH AVENUE	
		SACRAMENTO, CA	CALIFORNIA
		CHAS. F. DEAN	ARCHITECT
		SACRAMENTO	CALIFORNIA

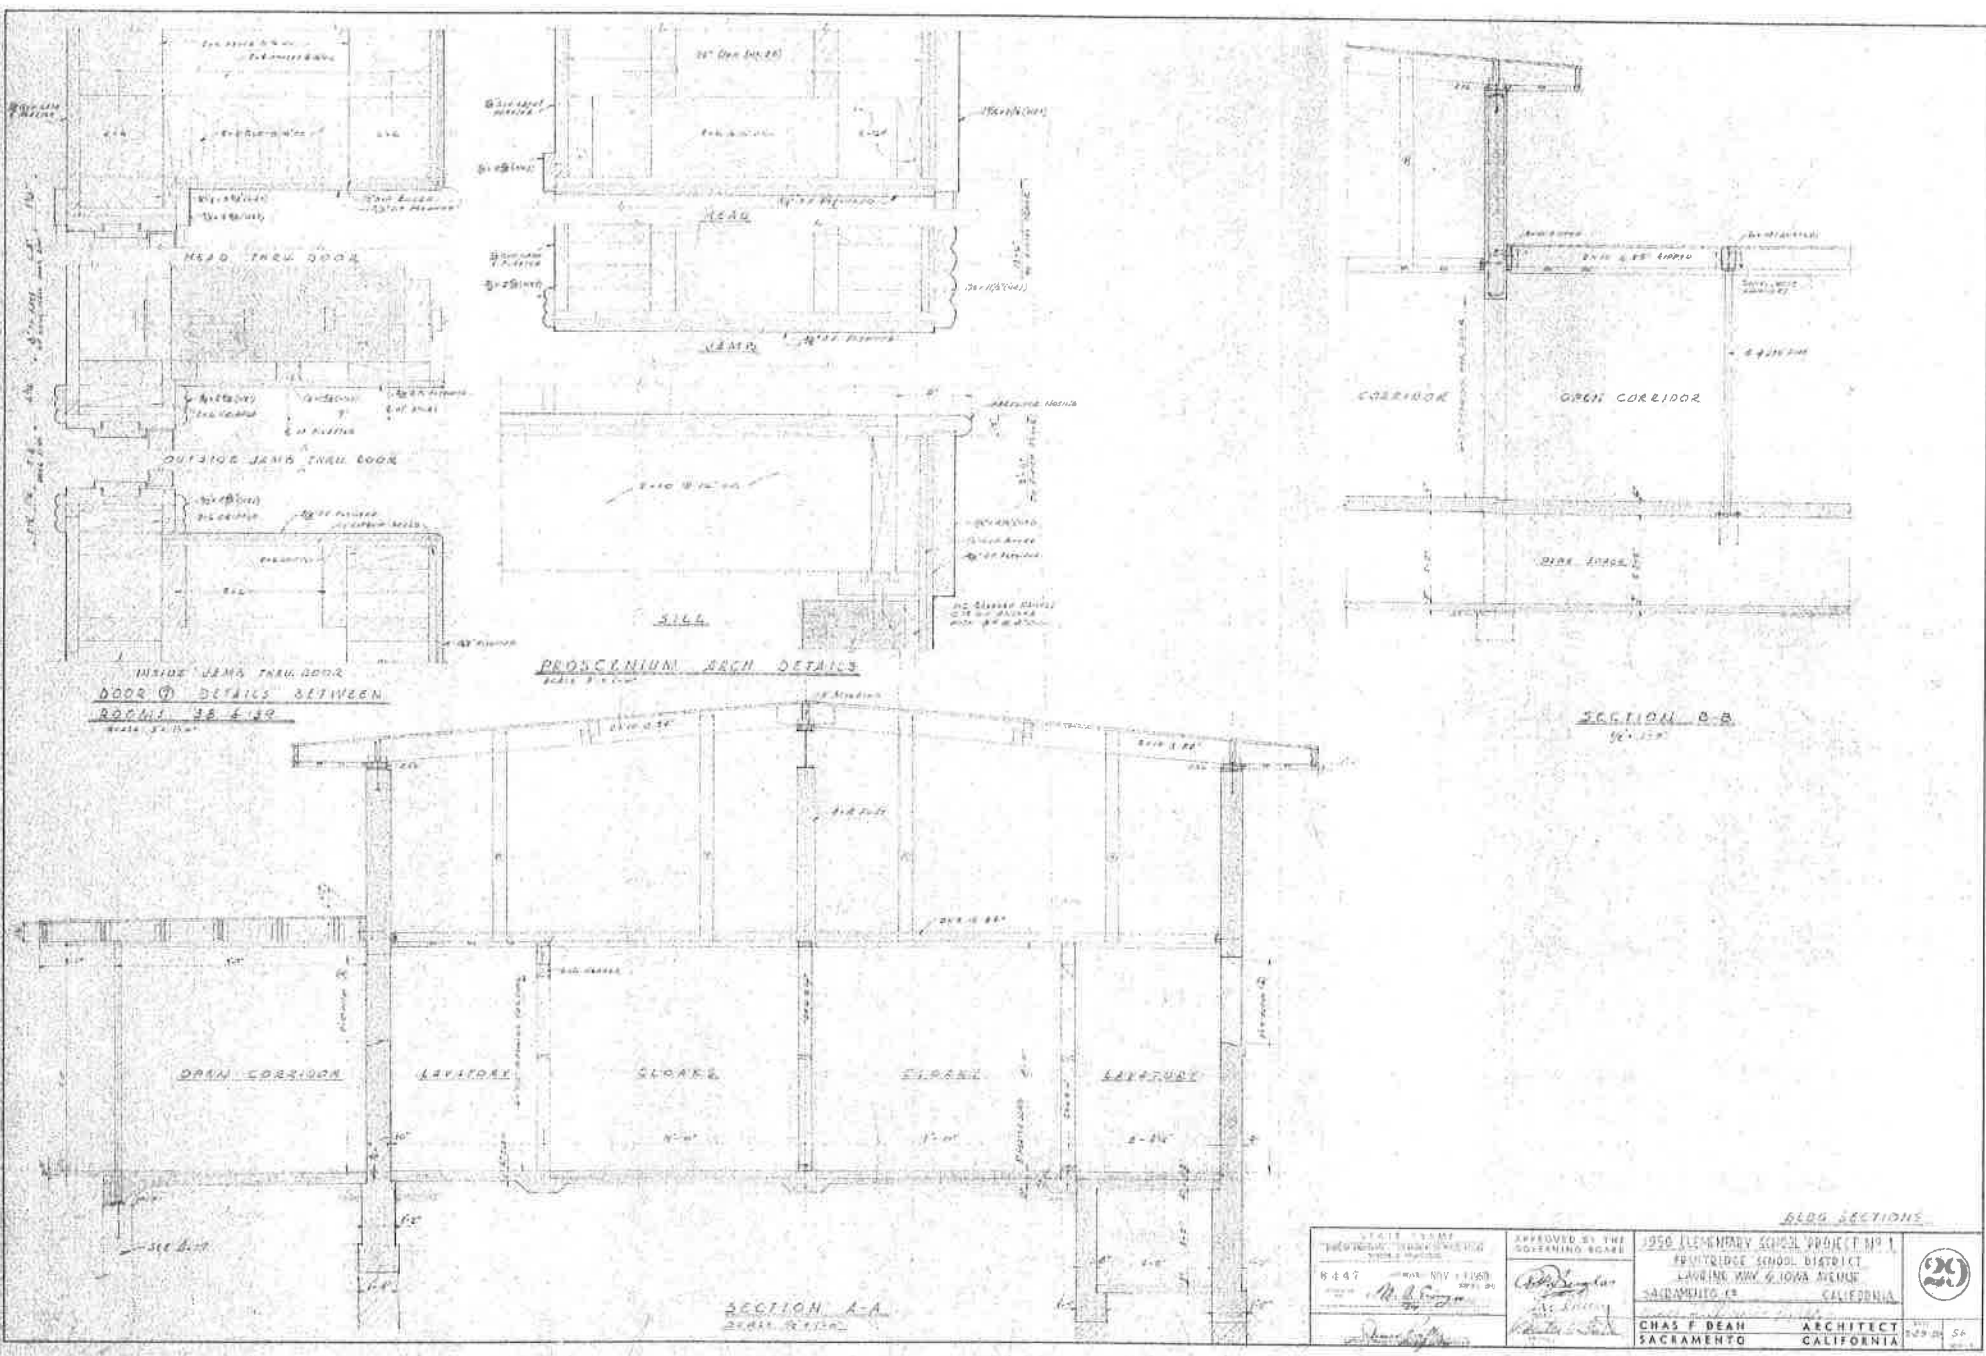



STATE OF CALIFORNIA DEPARTMENT OF EDUCATION DIVISION OF ARCHITECTURE NO. 447 MAY 11 1960 1960		APPROVED BY THE GOVERNING BOARD CHAS. F. DEAN SACRAMENTO		1950 ELEMENTARY SCHOOL PROJECT NO. 1 BRIDGECREST SCHOOL DISTRICT LAWRENCE, W.W. 6100A AVENUE SACRAMENTO, CA CALIFORNIA		
CHAS. F. DEAN SACRAMENTO		ARCHITECT CALIFORNIA		SHEET NO. 54 OF 54		

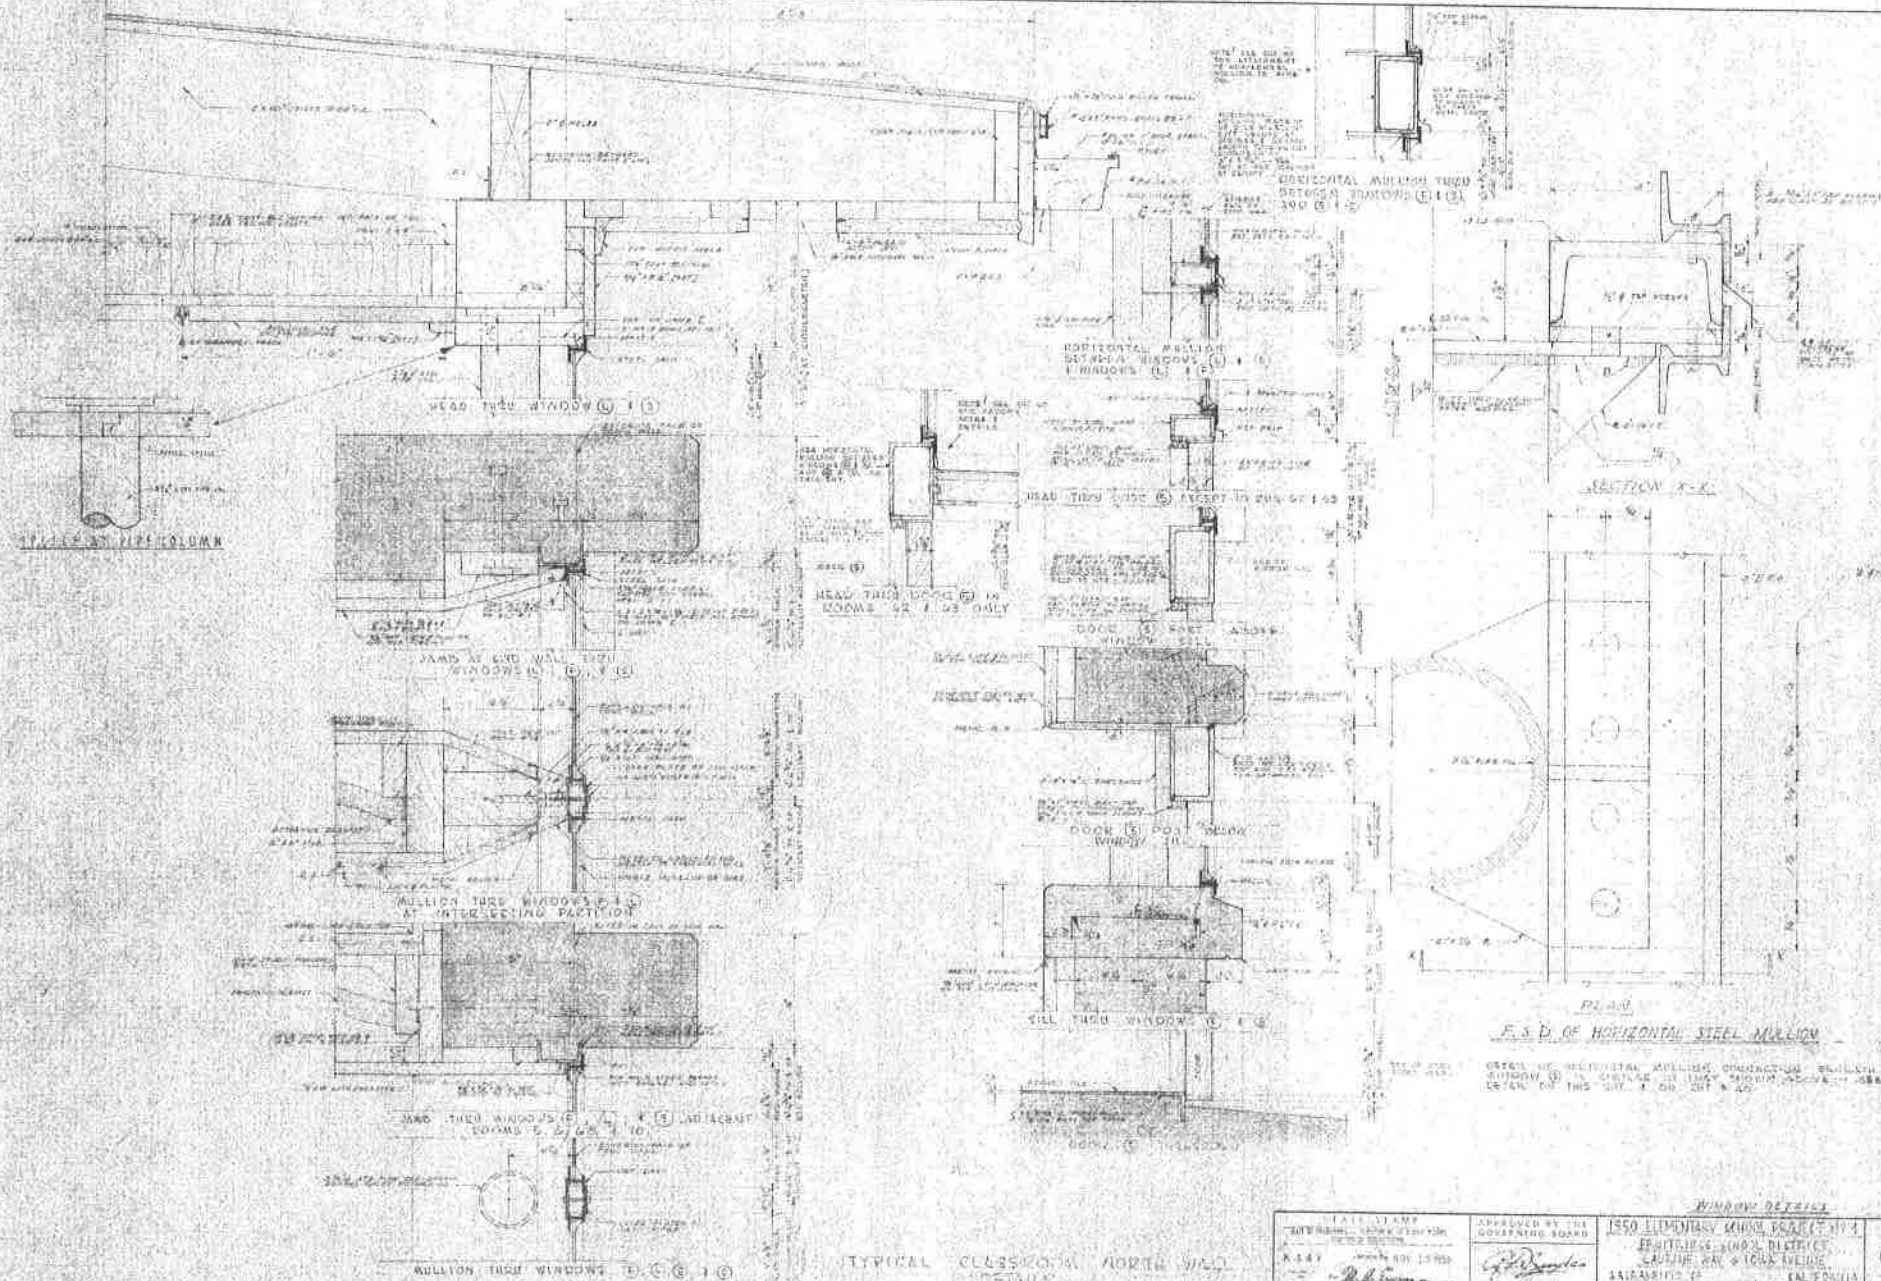


TYPICAL CLASSICAL NORTH WALL

NOTE: WALLS TO BE CONSTRUCTED OF 12" THICK CONCRETE WITH 4" REINFORCING BARS AT 12" ON CENTER.


<p>DATE: 1930 DRAWN BY: J. H. Dean CHECKED BY: J. H. Dean</p>	<p>APPROVED BY THE GOVERNING BOARD</p>	<p>1930 LEGISLATIVE HOUSE BUILDING CAPITOL DISTRICT SACRAMENTO, CALIFORNIA CHAS. F. DEAN ARCHITECT SACRAMENTO, CALIFORNIA</p>
---	---	--

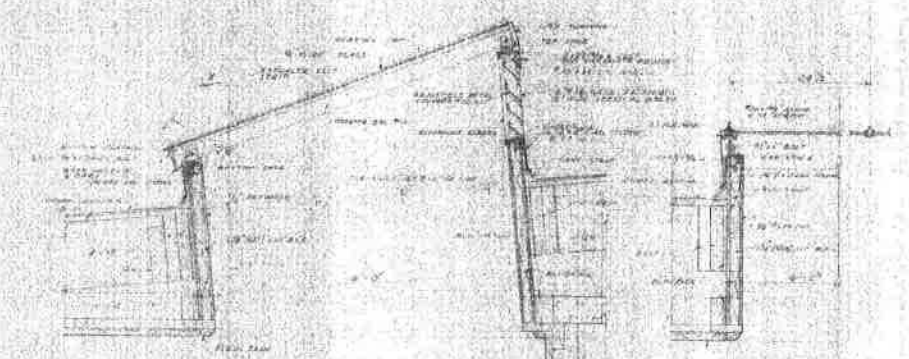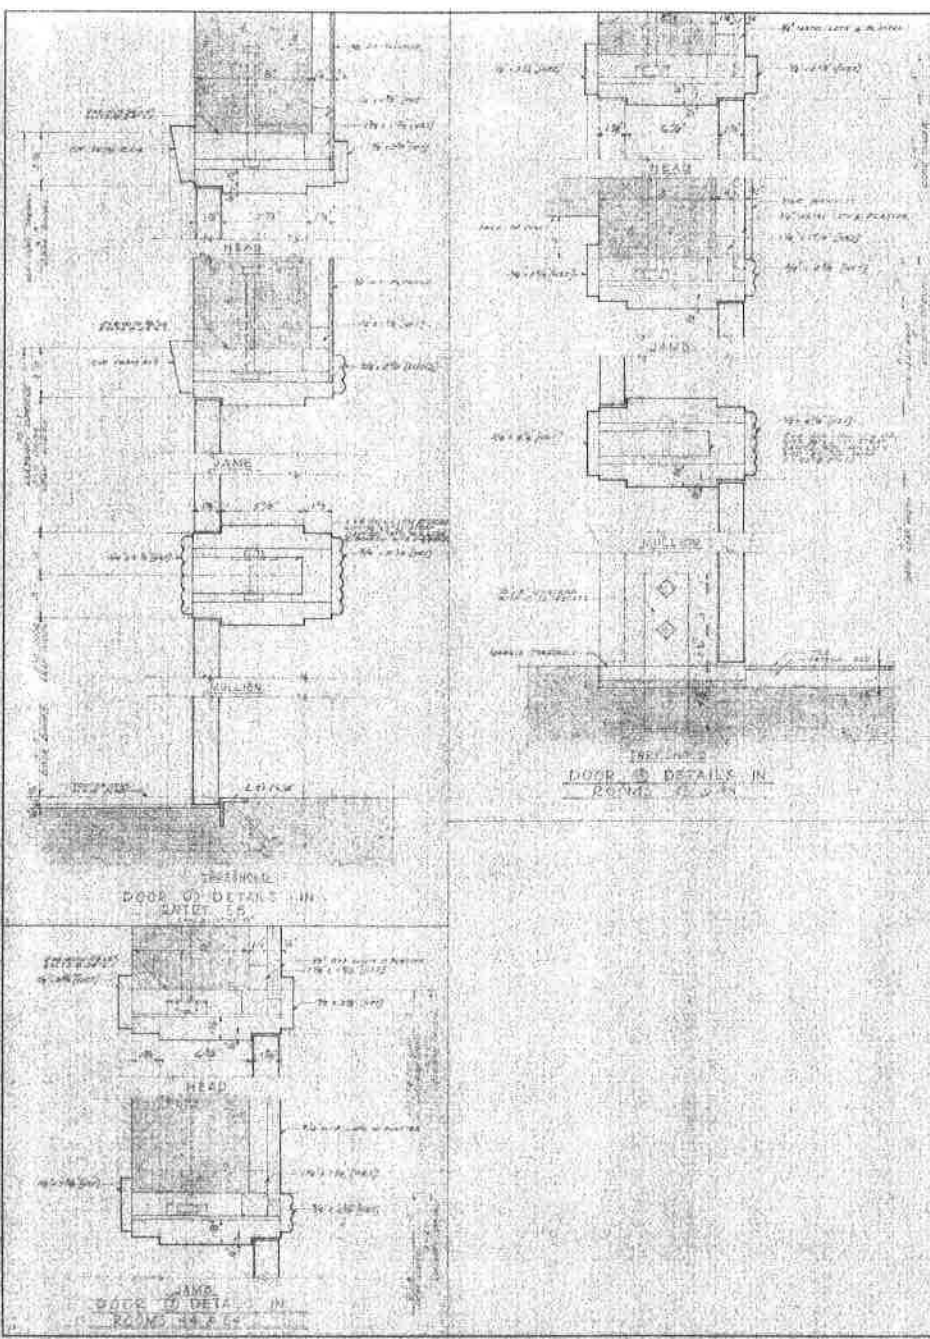

KITCHEN SKYLIGHT DETAILS

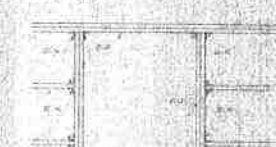


VERTICAL SKYLIGHT FRAMING

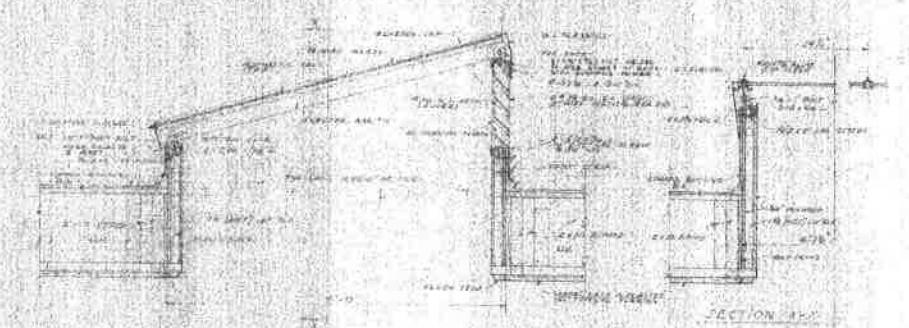


DOOR & SKYLIGHT DETAILS

DOOR & SKYLIGHT DETAILS


STATE OF CALIFORNIA COUNTY OF SACRAMENTO I, <i>Chas. F. Dean</i> , Architect do hereby certify that the above is a true and correct copy of the original as filed in my office.	CHAS. F. DEAN ARCHITECT SACRAMENTO, CALIFORNIA	USED ELEMENTARY SCHOOL PROJECT NO. 1 FRUITVILLE, SACRAMENTO DISTRICT LAUREL WAY & 10TH AVENUE SACRAMENTO, CALIFORNIA CHAS. F. DEAN ARCHITECT SACRAMENTO, CALIFORNIA	34
--	--	--	----

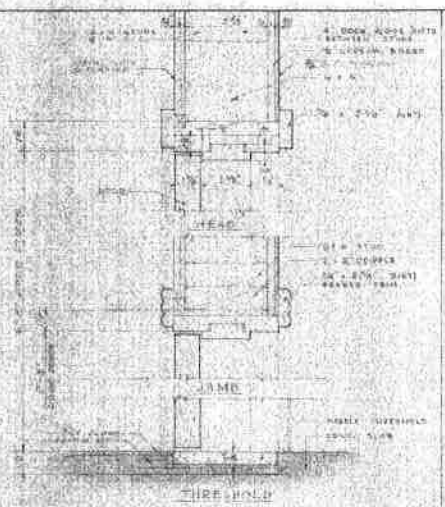


DOOR 1 DETAIL BETWEEN
DOOR 2 & 3

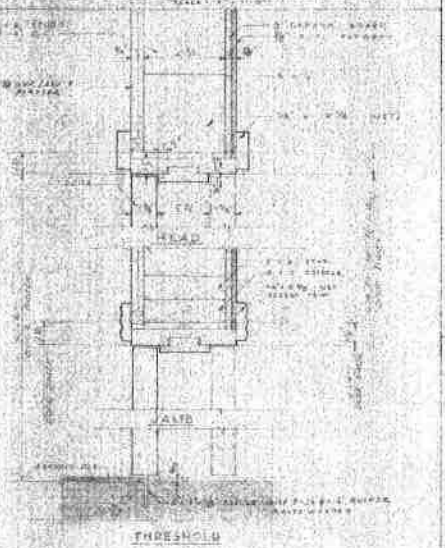


DOOR 2 DETAIL
IN ROOM 25 & 26 ADJACENT
CORRIDOR 25

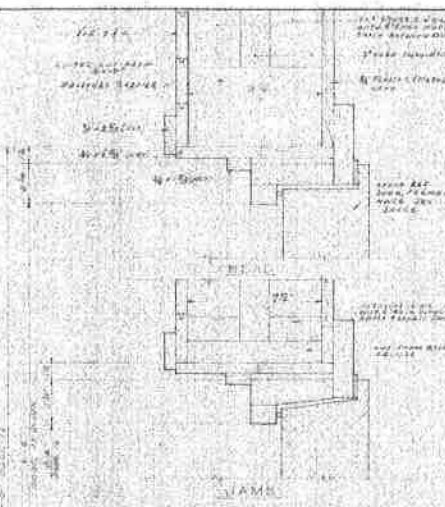


DOOR 3 DETAIL BETWEEN
DOOR 2 & 4

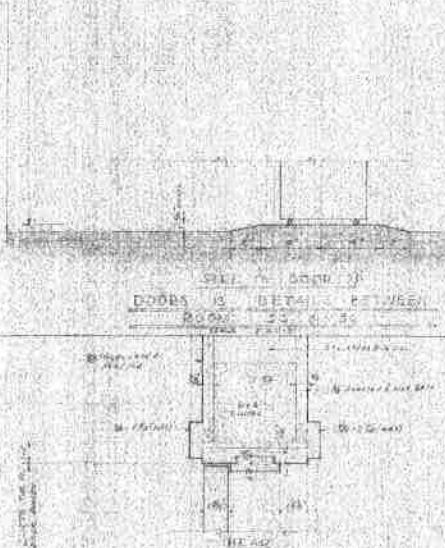


DOOR 4 DETAIL
IN ROOM 25 & 26 ADJACENT
CORRIDOR 25

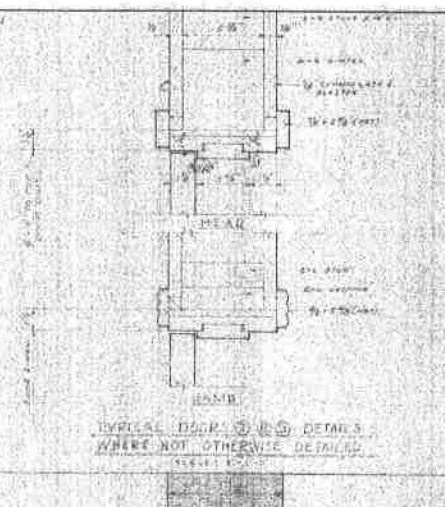


DOOR 5 DETAIL
IN ROOM 25 & 26 ADJACENT
CORRIDOR 25

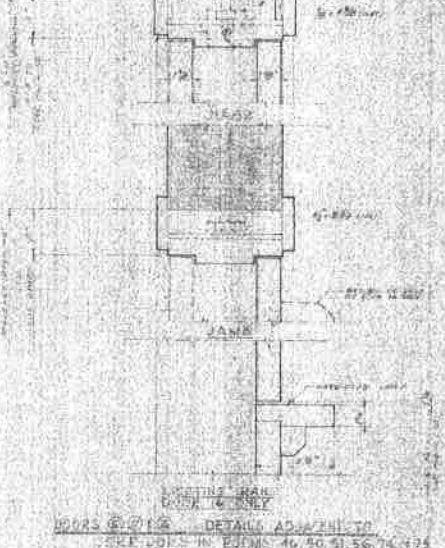

DOOR 6 DETAIL
IN ROOM 25 & 26 ADJACENT
CORRIDOR 25



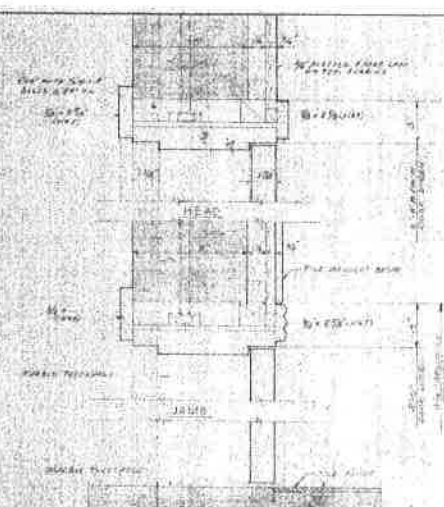


DOOR 7 DETAIL
IN ROOM 25 & 26 ADJACENT
CORRIDOR 25

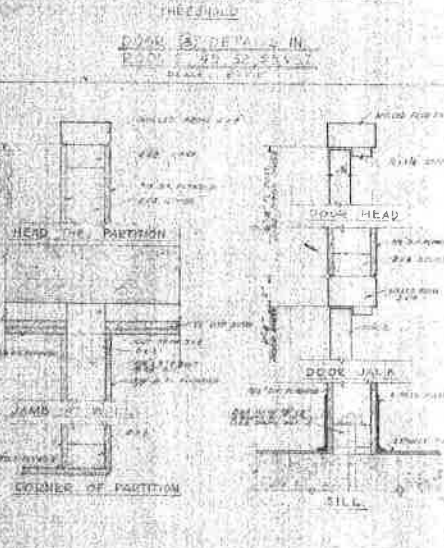


DOOR 8 DETAIL
IN ROOM 25 & 26 ADJACENT
CORRIDOR 25



<p>DOOR DETAILS</p> <p>35</p>	
<p>APPROVED FOR CONSTRUCTION</p> <p>DATE: 10/1/1928</p> <p>BY: [Signature]</p>	<p>1725 LUMINA DRIVE, PROJECT N-1</p> <p>FRUITHORN, SACRAMENTO DISTRICT</p> <p>LAURENCE WAY & 10TH AVENUE</p> <p>SACRAMENTO, CA CALIFORNIA</p> <p>CHAS. F. DEAN ARCHITECT SACRAMENTO CALIFORNIA</p>

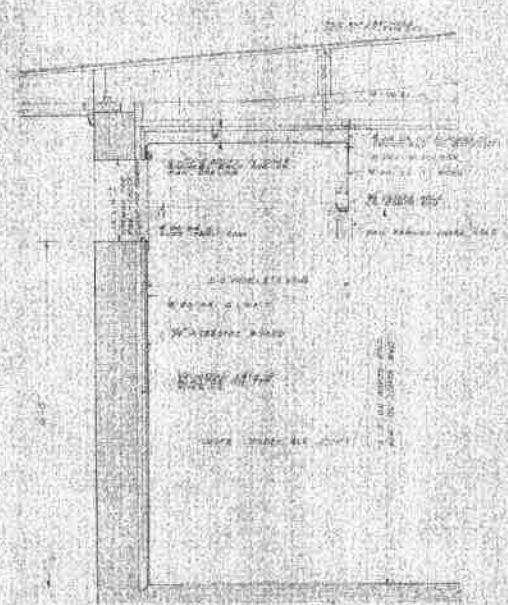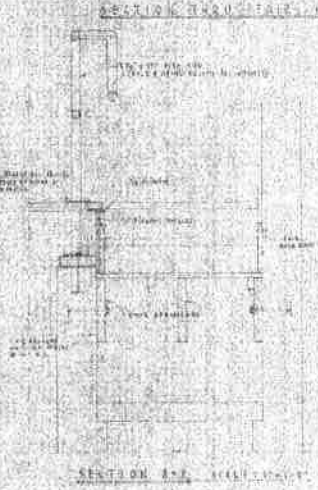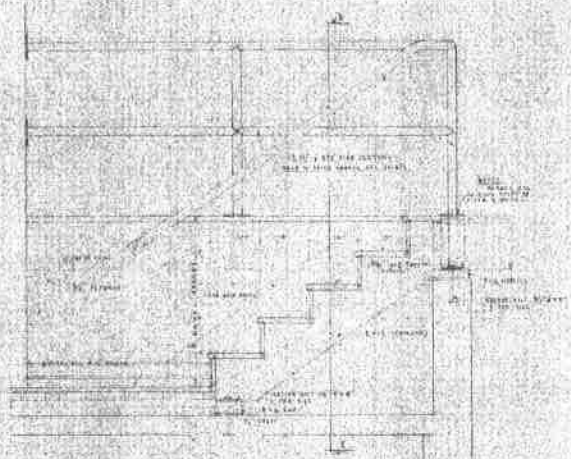

DANIEL HODD DETAIL




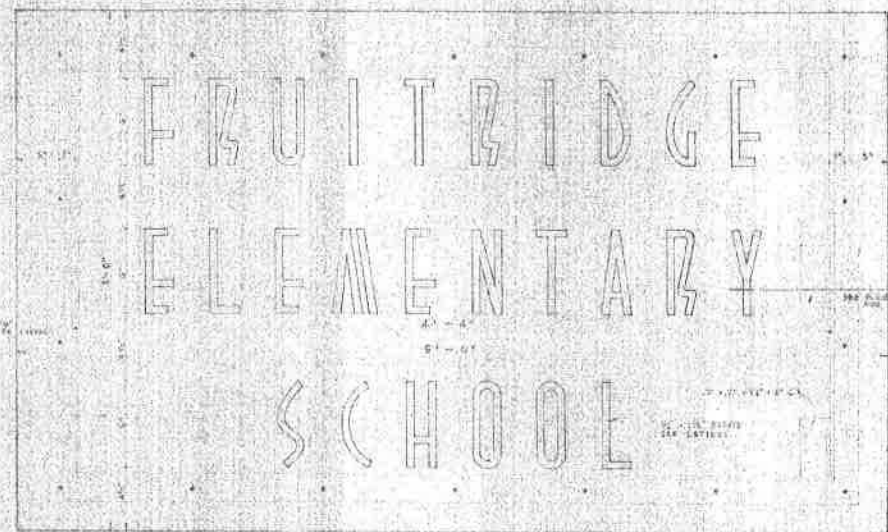


SCHOOL SIGN DETAIL

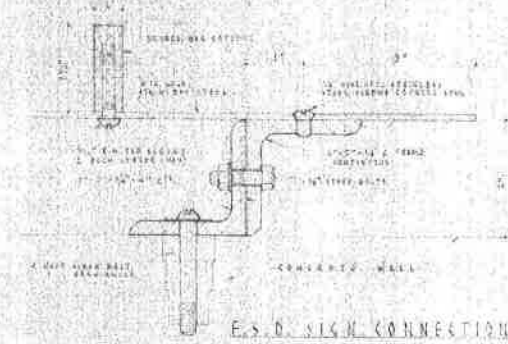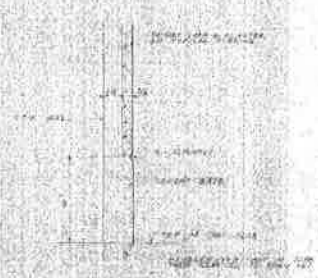

MISCELLANEOUS DETAILS


DRAWN BY H442 M. D. HODD	APPROVED BY CHAS. I. DEAN ARCHITECT	1950 ELEMENTARY SCHOOL PROJECT NO. 4 FRUITRIDGE (CHAS. DIST. 47) LANE, WY. & CHAS. DEAN SACRAMENTO, CALIFORNIA	
CHAS. I. DEAN SACRAMENTO	ARCHITECT CALIFORNIA	1950	

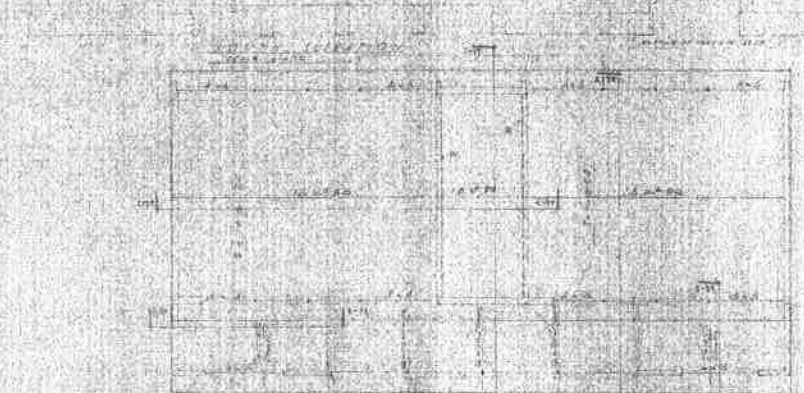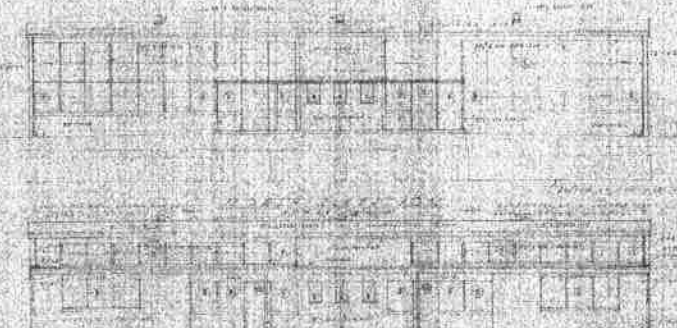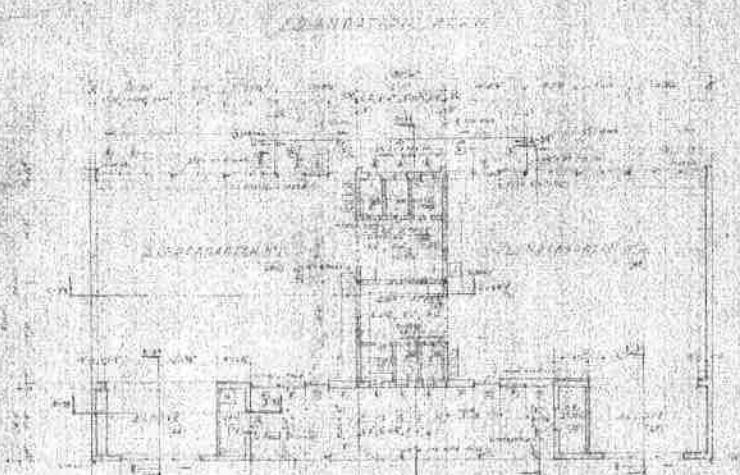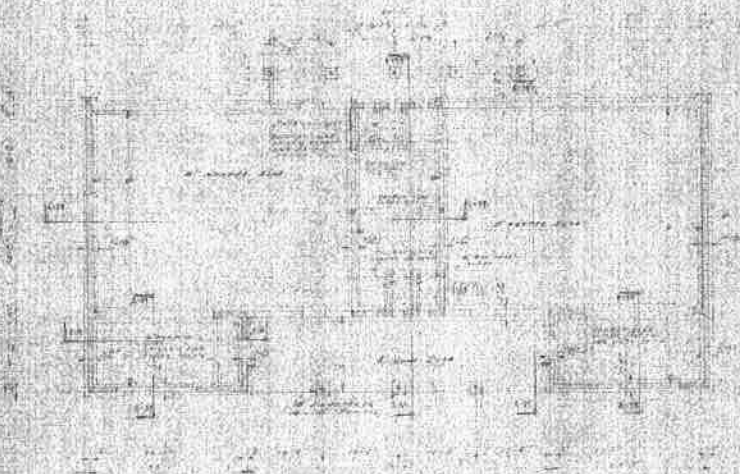


KINDERGARTEN

FOUNDATION PLAN - FLOOR PLAN
 8000' PLAN - ELEVATION ELEVATIONS


THE UNIVERSITY OF CALIFORNIA 8447 <i>Th. J. Dean</i>	CHAS F DEAN SACRAMENTO	1930 ELEMENTARY SCHOOL PROJECT NO. 1 1000 HAY ST. DISTRICT SACRAMENTO, CALIFORNIA	39
--	---------------------------	---	----

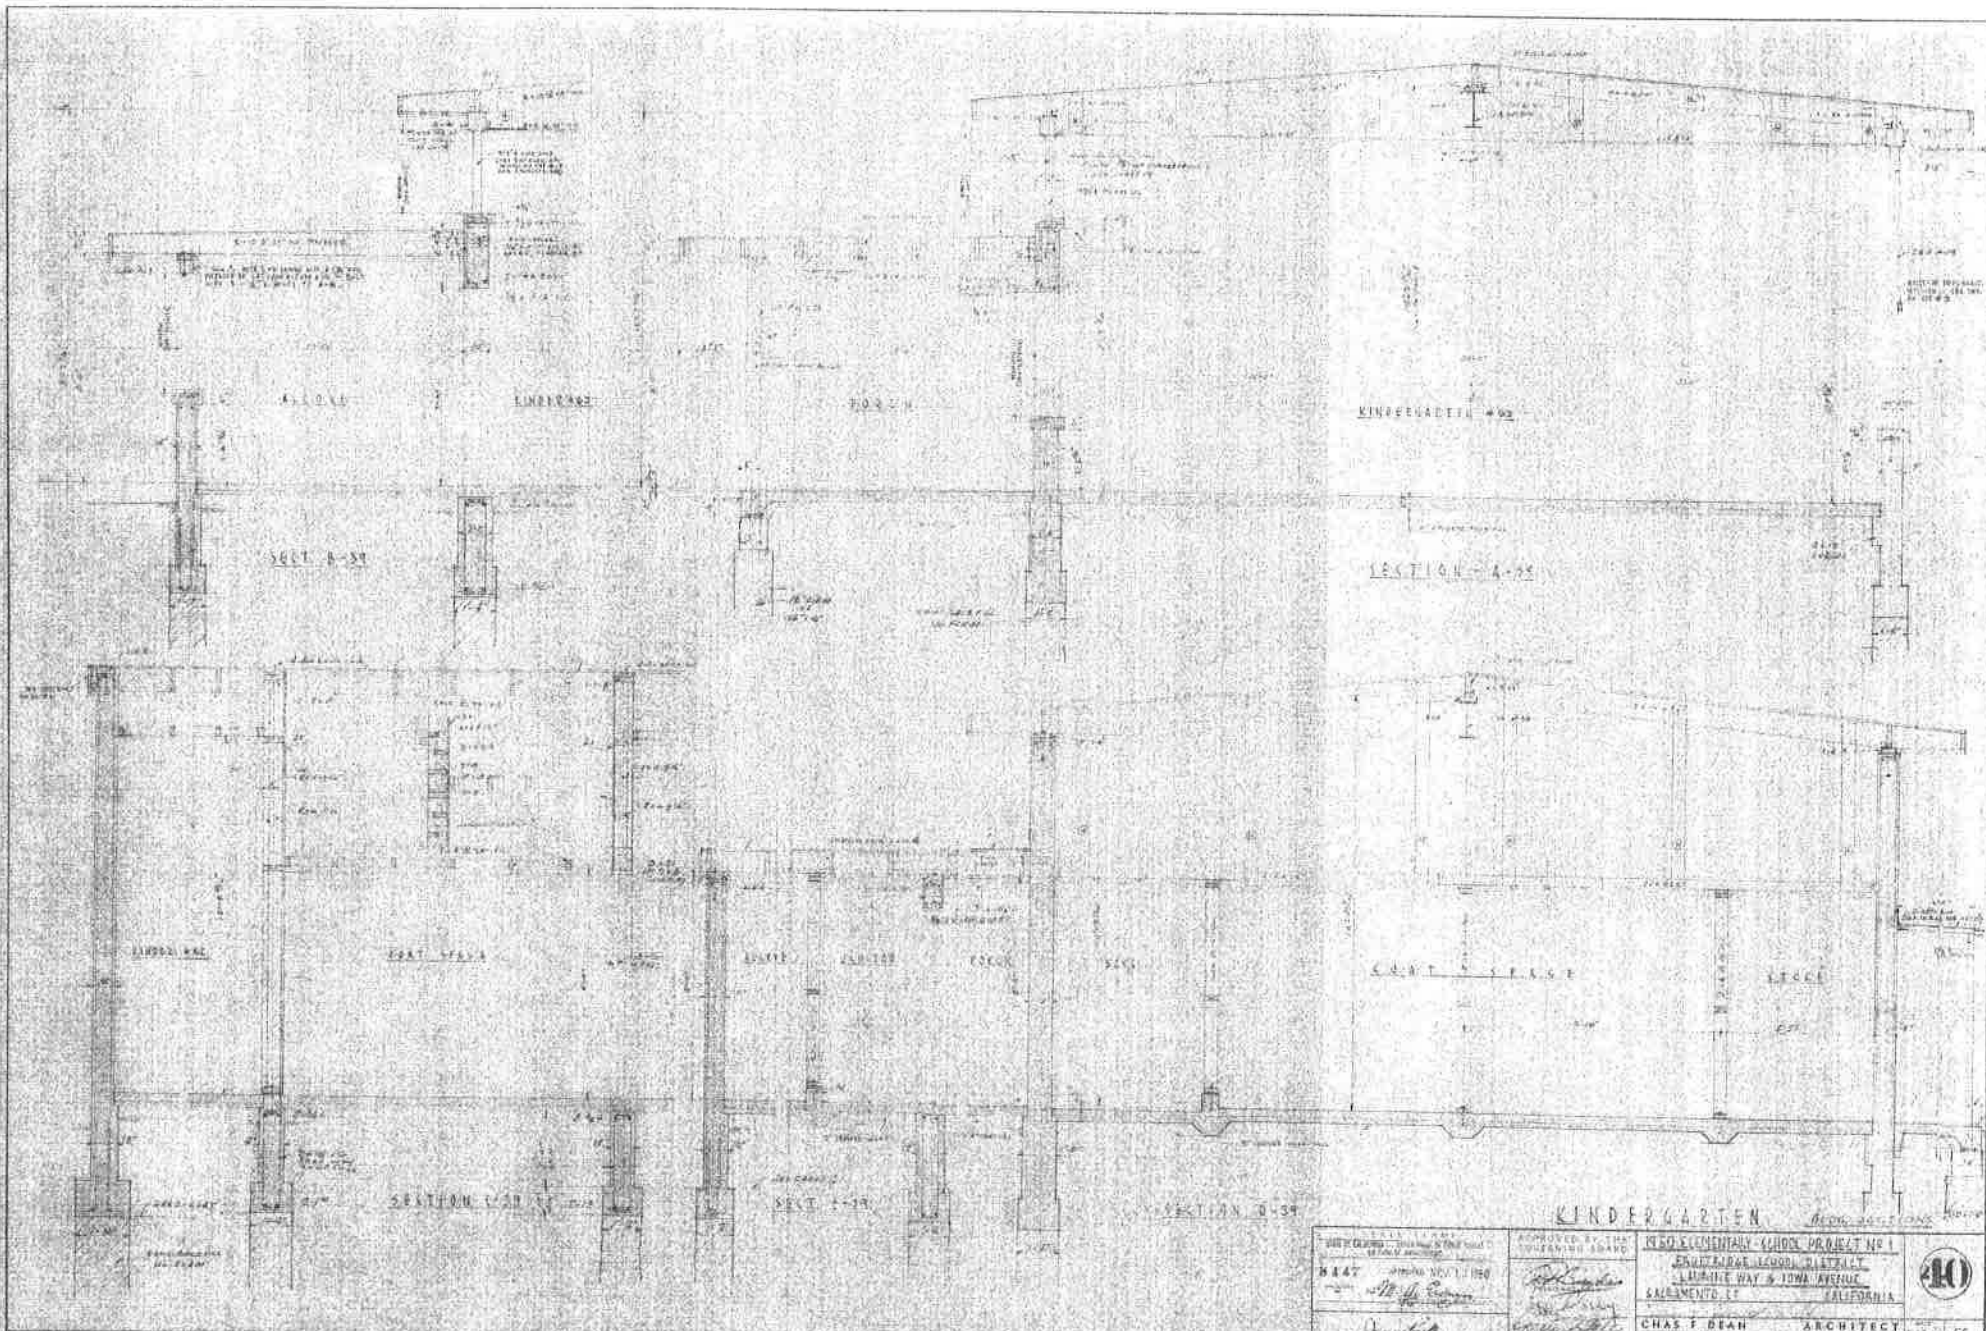

KINDERGARTEN 1950 ELEMENTARY SCHOOL PROJECT NO. 1 BRIDGE LANE DISTRICT LUMBERT HAY & IOWA AVENUE SACRAMENTO, CALIFORNIA		
CHAS. F. DEAN ARCHITECT SACRAMENTO, CALIFORNIA		

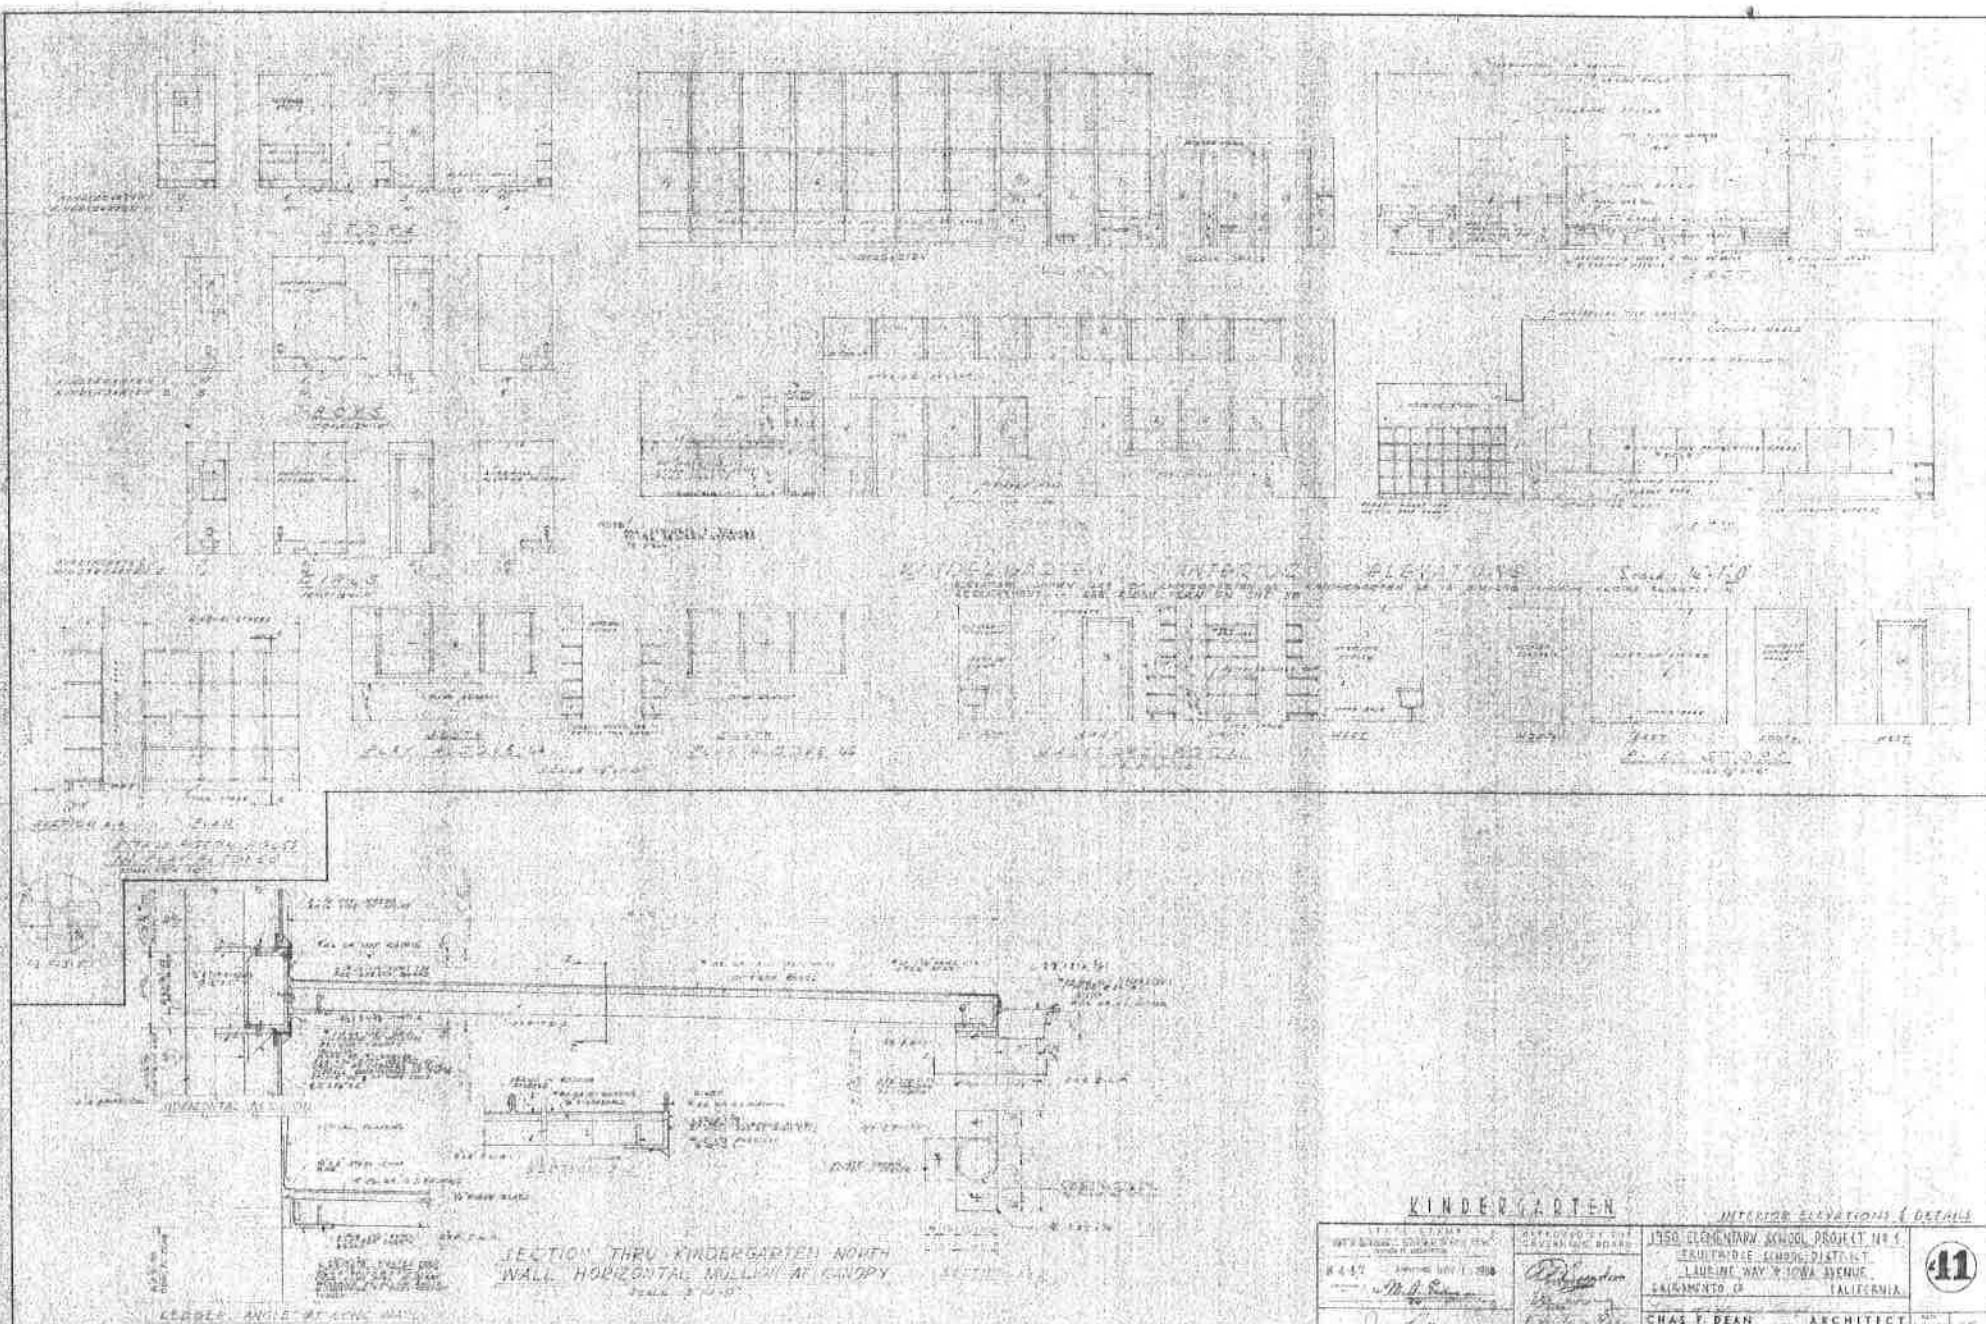

KINDERGARTEN		INTERIOR ELEVATIONS & DETAILS	
DRAWN BY R. A. L.	CHECKED BY M. A. Dean	1950 ELEMENTARY SCHOOL PROJECT NO. 1 LAUREL WAY & JOWA AVENUE SACRAMENTO, CALIFORNIA	<div>41</div>
DATE 1949	SCALE 1/8" = 1'-0"	CHAS. F. DEAN ARCHITECT SACRAMENTO, CALIFORNIA	1949

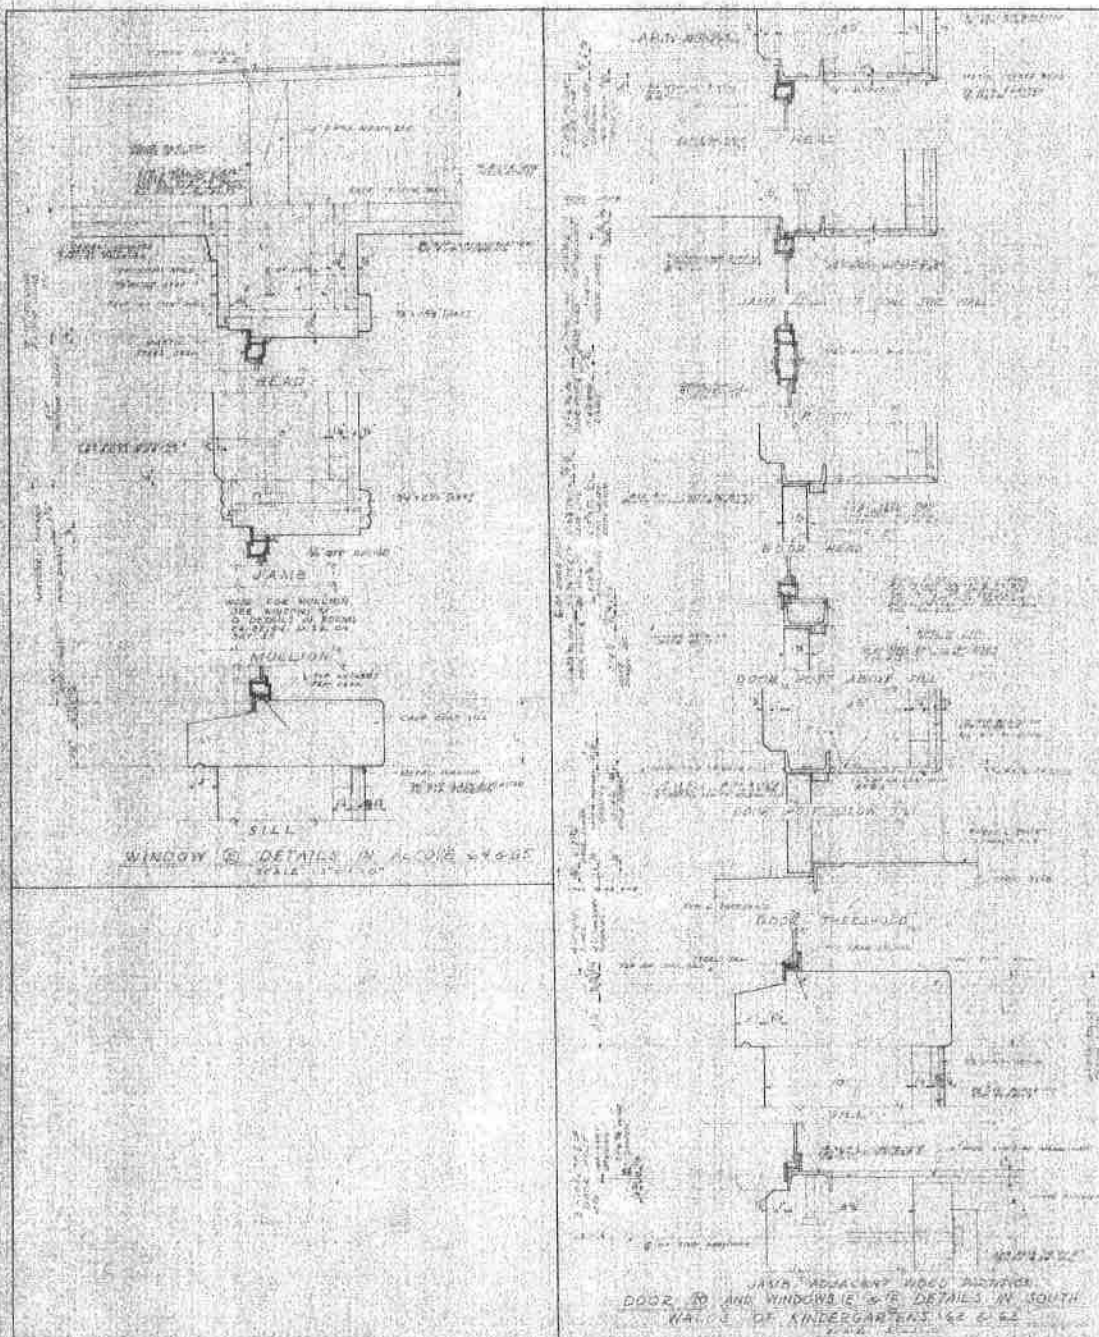

KINDERGARTEN DOOR & WINDOW DETAILS			
DATE: 1947	APPROVED BY: CHAS. F. DEAN	PROJECT NO. 1	
PROJECT NO. 1	DESIGNED BY: CHAS. F. DEAN	MAINTENANCE SCHOOL DISTRICT	
		CALIFORNIA HWY. & COMM. AGENCY	
		SACRAMENTO, CALIF.	
		CHAS. F. DEAN	ARCHITECT
		SACRAMENTO	CALIFORNIA