


CONSTRUCTION DRAWINGS FOR HIRAM JOHNSON HIGH SCHOOL GOLF PRACTICE FACILITY, VARSITY BASEBALL AND SOFTBALL FIELDS

6879 14TH AVENUE, SACRAMENTO, CA 95820
SACRAMENTO CITY UNIFIED SCHOOL DISTRICT
VERDE DESIGN, INC. PROJECT NO. 2203200
DSA APPLICATION NO. 02-120164

PREPARED BY

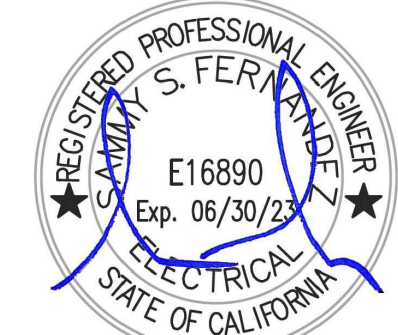

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SCOPE OF WORK

SCOPE OF WORK TO INCLUDE, BUT NOT LIMITED TO, THE FOLLOWING:
REMOVAL OF EXISTING BLEACHERS AND SELECTIVE FENCING; SITE RELOCATION OF EXISTING BASEBALL AND SOFTBALL FIELDS. PROPOSED IMPROVEMENTS AT THE BASEBALL FIELD TO INCLUDE CONSTRUCTION OF NEW 30' TALL CHAIN LINK BACKSTOP WITH NETTED HOOD, NETTING FENCING ALONG THIRD-BASE LINE, SOFTBALL FIELD TO INCLUDE 30' TALL CHAIN LINK BACKSTOP AND NETTING FENCING ALONG FIRST-BASE LINE, BOTH BASEBALL AND SOFTBALL TO INCLUDE HOME AND VISITOR CMU DUGOUTS WITH STORAGE CLOSETS, SINGLE STATION BATTING CAGES, SINGLE STATION BULLEN FOR VISITORS AND DOUBLE STATION BULLEN FOR HOME SIDE, NEW DOUBLE SIDED SPORT SPECIFIC SCOREBOARDS AND FLAG POLE LOCATED ADJACENT TO SCOREBOARD. CONSTRUCTION TO INCLUDE PERIMETER FENCING WITH MOW BANDS FOR EACH FIELD, NEW SYNTHETIC TURF GOLF PRACTICE FACILITY WITH ASSOCIATED FENCING, INSTALLATION OF ASSOCIATED HARDSCAPE, FENCING, LANDSCAPE, DRINKING FOUNTAIN, SITE UTILITIES, ELECTRICAL INFRASTRUCTURE, PATHWAY AND PATH OF TRAVEL FOR ACCESSIBILITY REQUIREMENTS.

BID ADDITIVE ALTERNATES
ADDITIVE ALTERNATE #01: INSTALL SYNTHETIC TURF AT GOLF PUTTING GREEN PERIMETER IN LIEU OF LANDSCAPE AND IRRIGATION
IF BID ALTERNATE IS ACCEPTED, WORK TO INCLUDE BUT NOT LIMITED TO CONSTRUCTION ON SYNTHETIC TURF PUTTING GREEN PERIMETER AND RELATED IMPROVEMENTS INCLUDING BUT NOT LIMITED TO HARDSCAPE, UTILITIES AND IRRIGATION.


GENERAL NOTES

- PRIOR TO BIDDING, THE GENERAL CONTRACTOR SHALL VISIT & INSPECT THE SITE & FAMILIARIZE THEMSELVES WITH EXISTING CONDITIONS AFFECTING THE NEW WORK. THE GENERAL CONTRACTOR SHALL NOT DISPUTE, COMPLAIN OR ASSERT THAT THERE IS ANY MISUNDERSTANDING IN REGARDS TO LOCATION, EXTENT, NATURE OR AMOUNT OF WORK TO BE PERFORMED UNDER THIS CONTRACT DUE TO THE CONTRACTOR'S FAILURE TO INSPECT THE SITE. CONTRACTOR SHALL NOTIFY DISTRICT'S REPRESENTATIVE OF ANY CONDITIONS, REQUIRING WORK, WHICH ARE NOT COVERED IN THE CONTRACT DOCUMENTS.
- NO CONSTRUCTION SHALL COMMENCE WITHOUT THE OFFICIAL NOTICE TO PROCEED FROM THE DISTRICT.
- THE GENERAL CONTRACTOR & SUBCONTRACTORS ARE RESPONSIBLE FOR LOCATING & VERIFYING ALL EXISTING UNDERGROUND UTILITIES IN ALL AREAS OF NEW WORK PRIOR TO COMMENCEMENT OF EXCAVATION. EXISTING UTILITIES SHOWN ON THE DRAWINGS ARE APPROXIMATE ROUTING LOCATIONS AS BEST DETERMINED FROM EXISTING DRAWINGS AND THE SCHOOL DISTRICT, BUT SHOULD NOT BE CONSTRUED TO REPRESENT ALL OF THE EXISTING UNDERGROUND UTILITIES. THE CONTRACTOR SHALL POTHOLE ALL EXISTING UTILITIES THAT MAY BE AFFECTED BY NEW FACILITIES IN THIS CONTRACT. VERIFY ACTUAL LOCATION AND DEPTH OF UTILITIES, AND REPORT POTENTIAL CONFLICTS TO THE DISTRICT'S REPRESENTATIVE PRIOR TO EXCAVATING FOR NEW FACILITIES.
- CONTRACTOR SHALL TAKE ALL NECESSARY STEPS TO PROTECT ALL EXISTING UTILITIES, WHETHER SHOWN OR NOT, IN THE CONTRACT DOCUMENTS. CONTRACTOR SHALL BE RESPONSIBLE FOR ALL DAMAGES TO EXISTING UTILITIES CAUSED BY ITS OPERATIONS.
- THE CONTRACTOR SHALL PROTECT ALL EXISTING ITEMS WITHIN SITE IMPROVEMENTS. IT IS THE RESPONSIBILITY OF THE CONTRACTOR TO REPAIR ALL DAMAGED AREAS TO THEIR ORIGINAL CONDITION OR BETTER AT CONTRACTOR'S EXPENSE TO THE SATISFACTION OF THE DISTRICT'S REPRESENTATIVE.
- DIMENSIONS AND LOCATIONS OF EXISTING FACILITIES ARE APPROXIMATE AND SHALL BE FIELD VERIFIED BY CONTRACTOR. ANY DISCREPANCIES SHALL BE IMMEDIATELY BROUGHT TO THE ATTENTION OF THE DISTRICT'S REPRESENTATIVE.
- ALL WORK SHALL CONFORM TO THE LATEST EDITION OF THE CALIFORNIA BUILDING CODE, CALIFORNIA PLUMBING CODE, CALIFORNIA FIRE CODE AND ALL APPLICABLE STATE AND LOCAL CODES AND ORDINANCES, AS WELL AS ADAPTED STANDARDS.
- ALL NOTES ARE FOR GENERAL REFERENCE IN CONJUNCTION WITH, AND AS A SUPPLEMENT TO, THE WRITTEN SPECIFICATIONS AND DETAILS ASSOCIATED WITH THE CONTRACT DOCUMENTS.
- THIS DRAWING SET SHALL BE USED IN CONJUNCTION WITH THE CSI FORMAT SPECIFICATIONS PUBLISHED IN BOOK FORM. COMBINED, THEY ARE REFERRED TO AS THE "CONTRACT DOCUMENTS".
- DIMENSIONS ON WORKING DRAWINGS TAKE PRECEDENCE OVER MEASURED ELEMENTS. CONTRACTOR SHALL NOT SCALE DRAWINGS.
- ALL TYPICAL DETAILS SHALL APPLY UNLESS NOTED OTHERWISE.
- CONTRACTOR SHALL PROVIDE ADEQUATE DUST CONTROL AND KEEP MUD AND DEBRIS OFF THE PUBLIC RIGHT-OF-WAY AT ALL TIMES.
- ALL TRENCHES AND EXCAVATIONS SHALL BE CONSTRUCTED IN STRICT COMPLIANCE WITH THE APPLICABLE SECTIONS OF CALIFORNIA AND FEDERAL O.S.H.A. REQUIREMENTS AND OTHER APPLICABLE SAFETY ORDINANCES. CONTRACTOR SHALL BEAR FULL RESPONSIBILITY FOR TRENCH SHORING DESIGN AND INSTALLATION.
- ANY ALTERATIONS OF EXISTING FACILITIES TO ACCOMMODATE THE INSTALLATION OF NEW WORK SHALL BE REVIEWED BY THE DISTRICT'S REPRESENTATIVE PRIOR TO COMMENCING WORK.
- CONTRACTOR SHALL COORDINATE ALL WORK TO AVOID DISTURBING STUDENTS OR TEACHERS DURING SCHOOL HOURS. ANY DISRUPTION OF THE UTILITIES MUST BE COORDINATED AND APPROVED BY THE DISTRICT'S REPRESENTATIVE AND INSPECTOR OF RECORD PRIOR TO COMMENCING WORK.
- ALL TEMPORARY WORK SHALL BE CONSIDERED A PART OF THIS CONTRACT AND NO EXTRA CHARGES WILL BE ALLOWED. THIS SHALL INCLUDE MINOR ITEMS OF MATERIAL OR EQUIPMENT NECESSARY TO MEET THE REQUIREMENTS AND INTENT OF THE PROJECT.
- THE PLANS AND SPECIFICATIONS DO NOT UNDERTAKE TO SHOW OR LIST EVERY ITEM TO BE PROVIDED, BUT RATHER TO DEFINE THE REQUIREMENTS FOR A FULL AND WORKING SYSTEM FROM THE STANDPOINT OF THE END USER. FOR THIS REASON, WHEN AN ITEM NOT SHOWN OR LISTED IS CLEARLY NECESSARY FOR PROPER CONTROL, OPERATION OF EQUIPMENT WHICH IS SHOWN OR LISTED, THE CONTRACTOR SHALL PROVIDE AN ITEM WHICH WILL ALLOW THE SYSTEM TO FUNCTION PROPERLY AT NO INCREASE IN PRICE.
- ALL CONTRACTORS SHALL REMOVE TRASH AND DEBRIS STEMMING FROM THEIR WORK ON A DAILY BASIS. PROJECT SITE SHALL BE MAINTAINED IN A CLEAN AND ORDERLY CONDITION.
- THE DETAILS REFLECT THE DESIGN INTENT FOR TYPICAL CONDITIONS. THE CONTRACTOR SHALL VERIFY ALL FIELD CONDITIONS AND SHALL INCLUDE, IN HIS SCOPE, THE COST FOR COMPLETE FINISHED INSTALLATIONS, INCLUDING ANOMALIES, OF ALL TRADES.
- NO WORK SHALL COMMENCE WITH UNAPPROVED MATERIALS. ANY WORK DONE WITH UNAPPROVED MATERIALS AND EQUIPMENT IS AT THE CONTRACTOR'S RISK AND IS SUBJECT TO REJECTION AND REPLACEMENT. SEE SPECIFICATIONS FOR SUBMITTAL AND SUBSTITUTION REQUIREMENTS.
- CONSTRUCTION MATERIALS STORED ON THE SITE SHALL BE PROPERLY STACKED AND PROTECTED SO AS TO PREVENT DAMAGE OR DETERIORATION UNTIL USED. FAILURE IN THIS REGARD MAY BE CAUSE FOR REJECTION OF MATERIAL AND/OR WORK.
- ALL EQUIPMENT SHALL BE FABRICATED FROM FIELD VERIFIED DIMENSIONS AND APPROVED SHOP DRAWINGS. COORDINATE MECHANICAL, PLUMBING AND ELECTRICAL EQUIPMENT.
- CONTRACTOR SHALL PERFORM THEIR CONSTRUCTION AND OPERATIONS IN A MANNER WHICH WILL NOT ALLOW HARMFUL POLLUTANTS TO ENTER THE STORM DRAIN SYSTEM. TO ENSURE COMPLIANCE, THE CONTRACTOR SHALL IMPLEMENT THE APPROPRIATE BEST MANAGEMENT PRACTICE (BMP) AS OUTLINED IN THE BROCHURES ENTITLED "BEST MANAGEMENT PRACTICE FOR THE CONSTRUCTION INDUSTRY" ISSUED BY THE CALIFORNIA STORM WATER QUALITY ASSOCIATION, NONPOINT SOURCE POLLUTION CONTROL PROGRAM, TO SUIT THE CONSTRUCTION SITE AND JOB CONDITION. THE CONTRACTOR SHALL PRESENT THEIR PROPOSED BMP AT THE PRE-CONSTRUCTION MEETING FOR DISCUSSION AND APPROVAL.
- CONTRACTOR SHALL PROVIDE TEMPORARY CONSTRUCTION FENCING PER CONTRACT DOCUMENTS TO SERVE LIMIT OF WORK AREAS. FENCING MAY BE ADJUSTED DURING CONSTRUCTION BASED ON CONSTRUCTION SEQUENCE OR DISTRICT REPRESENTATIVE'S DIRECTION.
- OVERNIGHT PARKING OF CONSTRUCTION EQUIPMENT IN THE STREET RIGHT-OF-WAY SHALL NOT BE PERMITTED.


DSA SUPPLEMENTARY CONDITIONS

- FABRICATION AND INSTALLATION OF DEFERRED SUBMITTAL ITEMS SHALL NOT BE STARTED UNTIL CONTRACTOR'S DRAWINGS, SPECIFICATIONS, AND ENGINEERING CALCULATIONS FOR THE ACTUAL SYSTEMS TO BE INSTALLED HAVE BEEN ACCEPTED AND SIGNED BY THE ARCHITECT OR STRUCTURAL ENGINEER AND APPROVED BY THE DSA. LIST DEFERRED SUBMITTAL ITEMS FOR THIS PROJECT.
- CHANGES TO THE APPROVED DRAWINGS AND SPECIFICATIONS SHALL BE MADE BY AN ADDENDUM OR A CONSTRUCTION CHANGED DOCUMENT (CCD) APPROVED BY THE DIVISION OF THE STATE ARCHITECT PRIOR TO FABRICATION AND INSTALLATION, AS REQUIRED BY SECTION 4-318, PART 1, TITLE 24, CCR AND DSA IR-6.
- A "DSA CERTIFIED" PROJECT INSPECTOR EMPLOYED BY THE DISTRICT (OWNER) AND APPROVED BY THE DSA SHALL PROVIDE CONTINUOUS INSPECTION OF THE WORK. THE DUTIES OF THE INSPECTOR ARE DEFINED IN SECTION 4-342, PART 1, TITLE 24, CCR.
- A DSA ACCEPTABLE INSPECTOR EMPLOYED BY THE DISTRICT (OWNER) SHALL CONDUCT ALL THE REQUIRED TESTS AND INSPECTIONS FOR THE PROJECT.
- THE INTENT OF THESE DRAWINGS AND SPECIFICATIONS IS THAT THE WORK OF THE ALTERATION, REHABILITATION OR RECONSTRUCTION IS TO BE IN ACCORDANCE WITH TITLE 24, CCR, SHOULD ANY EXISTING CONDITIONS SUCH AS DETERIORATION OR NON-COMPLYING CONSTRUCTION BE DISCOVERED WHICH IS NOT COVERED BY THE CONTRACT DOCUMENTS WHEREIN THE FINISHED WORK WILL NOT COMPLY WITH TITLE 24, CALIFORNIA CODE OF REGULATIONS, A CHANGE ORDER, OR A SEPARATE SET OF PLANS AND SPECIFICATIONS, DETAILING AND SPECIFYING THE REQUIRED WORK SHALL BE SUBMITTED TO AND APPROVED BY DSA BEFORE PROCEEDING WITH THE WORK. (SECTION 4-317(C), PART 1, TITLE 24, CCR)
- GRADING PLANS, DRAINAGE IMPROVEMENTS, ROAD AND ACCESS REQUIREMENTS AND ENVIRONMENTAL HEALTH CONSIDERATIONS SHALL COMPLY WITH ALL LOCAL ORDINANCES.
- THE PROJECT WILL BE COMPLIANT WITH CFC CH. 33 - FIRE SAFETY DURING CONSTRUCTION AND DEMOLITION


PROJECT MAP

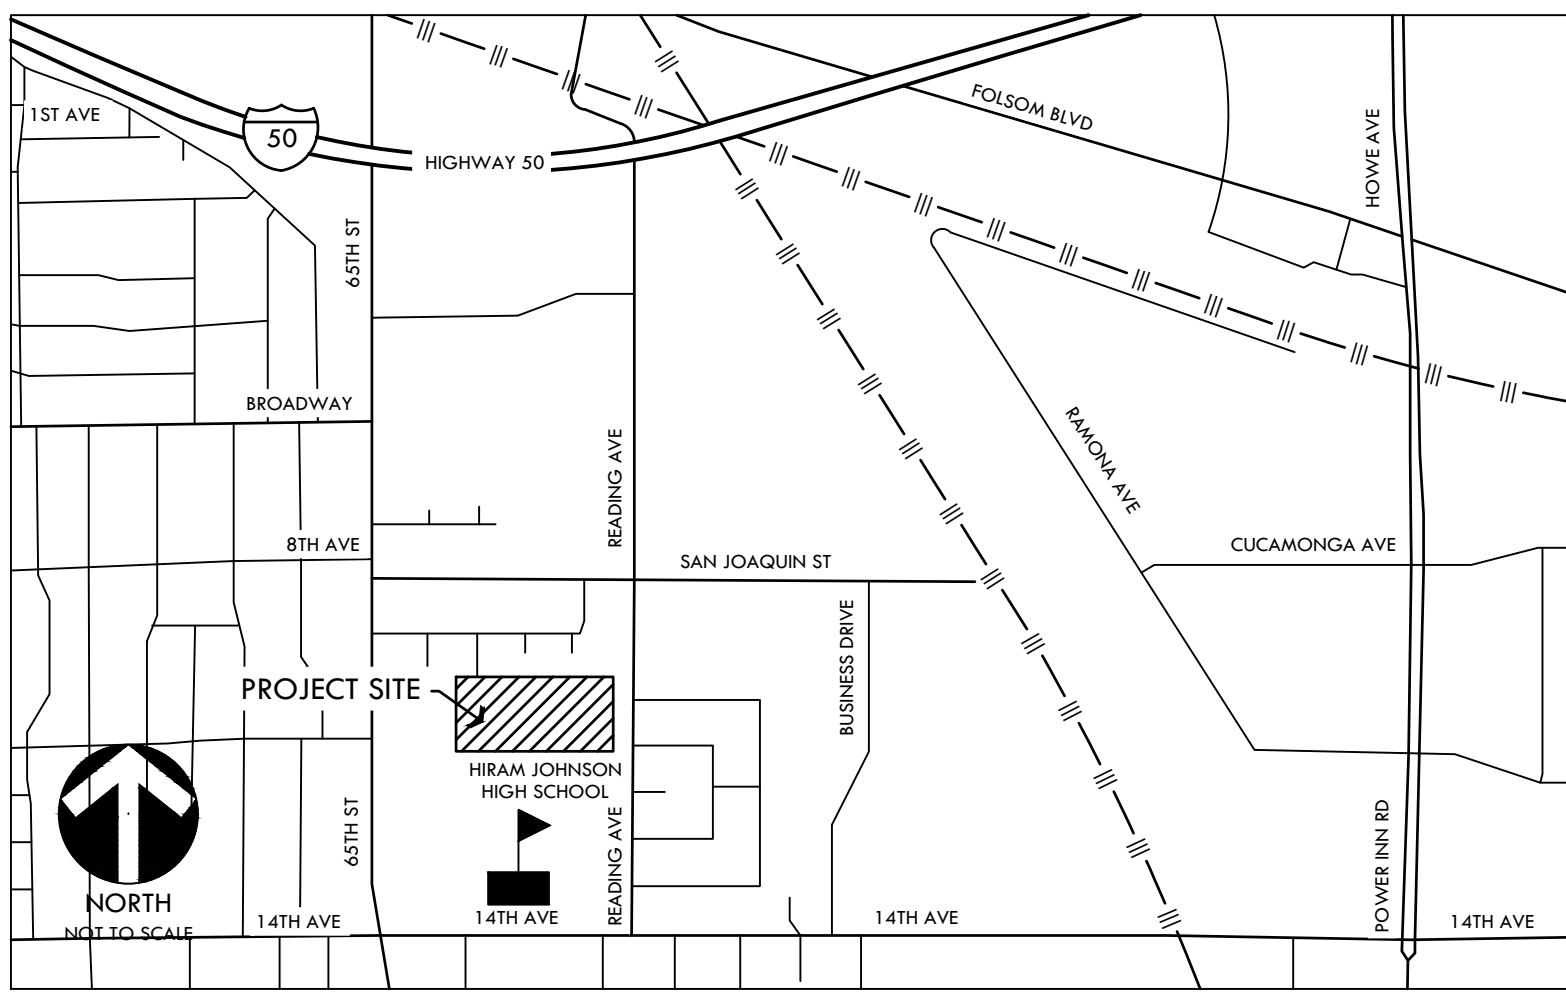

VICINITY MAP

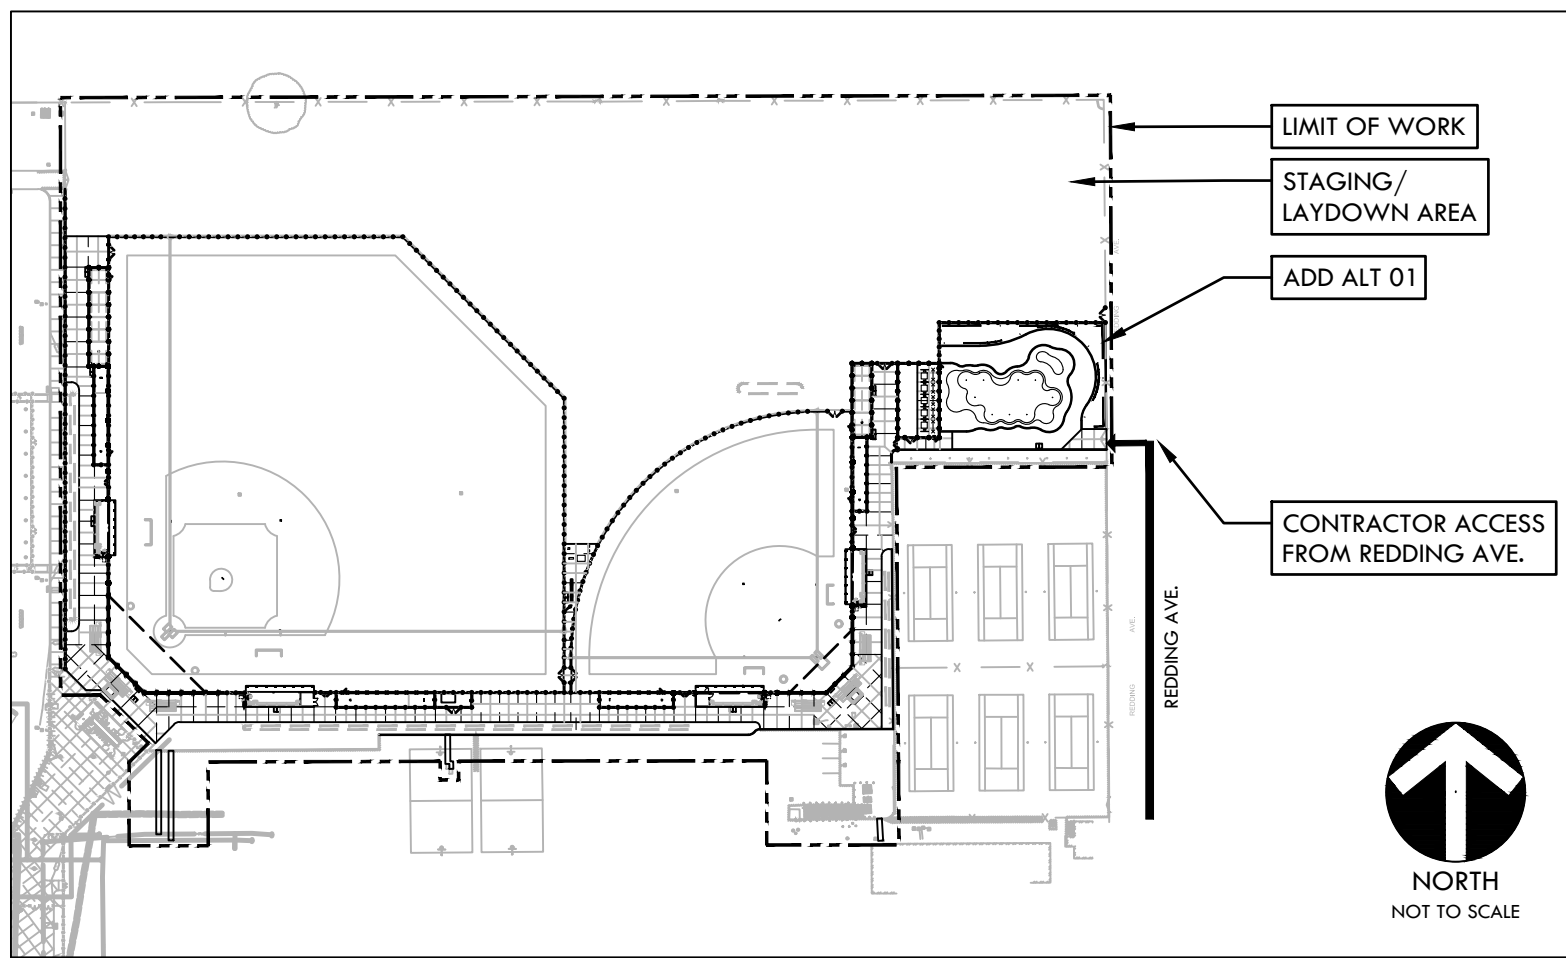

SITE MAP

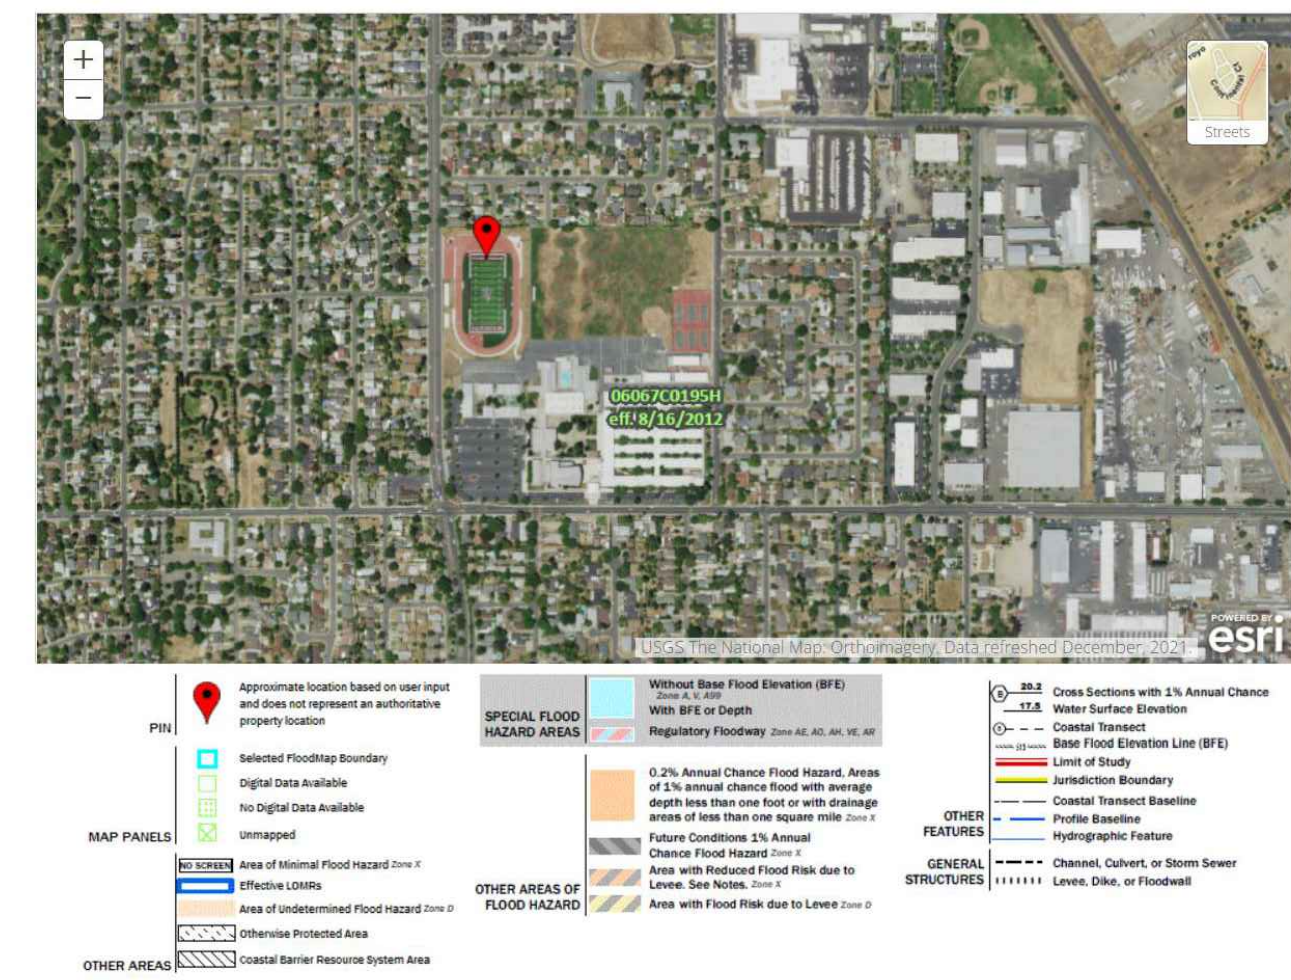

APPLICABLE CODES

- 2019 CBC CHAPTER 33: PROVIDE ALL THE APPLICABLE/ADOPTED STANDARDS. WHERE A PARTICULAR STANDARD IS REFERENCED IN THE CODE BUT DOES NOT APPEAR AS AN ADOPTED STANDARD IT MAY STILL BE USED. APPLY ONLY THE PORTION OF THE STANDARD THAT IS APPLICABLE TO THE CODE SECTION WHERE THE STANDARD IS REFERENCED, NOT THE ENTIRE STANDARD.
 - 2002 CALIFORNIA BUILDING STANDARDS ADMINISTRATIVE CODE, PART 1, TITLE 24 C.C.R.
 - 2019 CALIFORNIA BUILDING CODE (CBC), PART 2, TITLE 24 C.C.R.
 - [2018 INTERNATIONAL BUILDING CODE VOLUMES 1-2]
 - 2019 CALIFORNIA ELECTRICAL CODE (CEC), PART 3, TITLE 24 C.C.R.
 - [2017 NATIONAL ELECTRICAL CODE]
 - 2019 CALIFORNIA MECHANICAL CODE (CMC) PART 4, TITLE 24 C.C.R.
 - [2018 UNIFORM MECHANICAL CODE]
 - 2019 CALIFORNIA PLUMBING CODE (CPC), PART 5, TITLE 24 C.C.R.
 - [2018 UNIFORM PLUMBING CODE]
 - 2019 CALIFORNIA ENERGY CODE, PART 6, TITLE 24 C.C.R.
 - 2019 CALIFORNIA FIRE CODE, PART 9, TITLE 24 C.C.R.
 - [2018 INTERNATIONAL FIRE CODE AND 2016 CALIFORNIA AMENDMENTS]
 - 2019 CALIFORNIA EXISTING BUILDING CODE, PART 10, TITLE 24 C.C.R.
 - [2018 INTERNATIONAL EXISTING BUILDING CODES]
 - 2019 CALIFORNIA "GREEN" BUILDING REQUIREMENTS OR CAL GREEN, PART 11, TITLE 24 C.C.R.
 - 2019 CALIFORNIA REFERENCED STANDARDS, PART 12, TITLE 24 C.C.R.
 - 2019 TITLE 19 C.C.R., PUBLIC SAFETY, STATE FIRE MARSHAL REGULATIONS.
- LIST OF FEDERAL CODES AND STANDARDS (IF APPLICABLE)
 - AMERICANS WITH DISABILITIES ACT (ADA), TITLE II OR TITLE III FOR TITLE II, UNIFORM FEDERAL ACCESSIBILITY STANDARDS (UFAS) 28 CFR 35.151(C)
 - OR ADA STANDARDS FOR ACCESSIBLE DESIGN (APPENDIX A OF 28 CFR PART 35)
 - FOR TITLE III, ADA STANDARDS FOR ACCESSIBLE DESIGN (APPENDIX A OF 28 CFR PART 36) 28 CFR 36.406
 - 2010 AMERICANS WITH DISABILITIES ACT (ADA) STANDARDS FOR ACCESSIBLE DESIGN
- NOTE: TITLE II APPLIES TO PROJECTS FUNDED AND/OR USED BY STATE AND LOCAL GOVERNMENT SERVICES. TITLE III COVERS PUBLIC ACCOMMODATIONS AND COMMERCIAL FACILITIES. DEPENDING ON THE USE AND FUNDING, BOTH TITLE MAY APPLY TO THE PROJECT.
 - NFPA 13 AUTOMATIC SPRINKLER SYSTEMS 2016 EDITION
 - NFPA 14 STANDPIPE SYSTEMS 2016 EDITION
 - NFPA 17 DRY CHEMICAL EXTINGUISHING SYSTEMS 2016 EDITION
 - NFPA 17A WET CHEMICAL EXTINGUISHING SYSTEMS 2016 EDITION
 - NFPA 20 STATIONARY FIRE PUMPS 2016 EDITION
 - NFPA 24 PRIVATE FIRE SERVICE MAINS 2016 EDITION
 - NFPA 72 NATIONAL FIRE ALARM AND SIGNALING CODE (CALIFORNIA AMENDED) 2016 EDITION
(NOTE: SEE UL STANDARD 1971 FOR VISUAL DEVICES)
 - NFPA 253 CRITICAL RADIANT FLUX OF FLOOR COVERING SYSTEMS 2015 EDITION
 - NFPA 2001 CLEAN AGENT FIRE EXTINGUISHING SYSTEMS 2015 EDITION
 - ASME 17.1 ELEVATOR STANDARD 2015 EDITION
- REFERENCE CODE SECTIONS FOR APPLICABLE STANDARDS - 2019 CALIFORNIA BUILDING CODE (FOR SFM) REFERENCED STANDARDS CHAPTER 35
ADA STANDARD FOR ACCESSIBLE DESIGN (APPENDIX A OF 28 CFR PART 36)

- THE INTENT OF THESE DRAWINGS AND SPECIFICATIONS IS THAT WORK OF THE ALTERATION, REHABILITATION OR RECONSTRUCTION IS TO BE IN ACCORDANCE WITH TITLE 24, CALIFORNIA CODE OF REGULATIONS. SHOULD ANY EXISTING CONDITIONS SUCH AS DETERIORATION OR NON-COMPLYING CONSTRUCTION BE DISCOVERED WHICH IS NOT COVERED BY THE CONTRACT DOCUMENTS WHEREIN THE FINISHED WORK WILL NOT COMPLY WITH TITLE 24, CALIFORNIA CODE OF REGULATIONS, A CHANGE ORDER, OR A SEPARATE SET OF PLANS AND SPECIFICATIONS, DETAILING AND SPECIFYING THE REQUIRED WORK SHALL BE SUBMITTED TO AND APPROVED BY THE OWNER REPRESENTATIVE BEFORE PROCEEDING WITH THE WORK.
- ALL EXISTING FIRE EXTINGUISHING SYSTEMS ARE IN COMPLIANCE WITH UL 300, CBC 904.11, CFC 904.11.

CONTACT INFORMATION

ORGANIZATION	NAME	PHONE
OWNER SACRAMENTO UNIFIED SCHOOL DISTRICT DIRECTOR, FACILITIES MANAGEMENT AND OPERATIONS	CHRIS RALSTON CHRIS-RALSTON@SCUSD.EDU	(916) 971-5740
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STRUCTURAL ENGINEER AHERN KNOX AND HYDE	TIM HYDE HYDE@AKHSE.COM	(408) 978-1970
GEOTECHNICAL ENGINEER WALLACE - KÜHL & ASSOCIATES, INC.	MATT MOYNEUR	(209) 372-1434

SHEET INDEX (64 SHEETS)

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L0.2	FIRE LIFE SAFETY PLAN
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L2.1	EROSION AND SEDIMENT CONTROL PLAN
L3.1	DEMOLITION PLAN - BASEBALL FIELD
L3.2	DEMOLITION PLAN - SOFTBALL FIELD AND GOLF
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D4.3	CONSTRUCTION DETAILS - BASEBALL
D4.4	CONSTRUCTION DETAILS - SOFTBALL
D4.5	CONSTRUCTION DETAILS - SOFTBALL
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D4.7	CONSTRUCTION DETAILS - BASEBALL DUGOUTS
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N85.1	ATTACHMENT DETAILS
N85.2	OPTIONAL SCOREBOARD FEATURE ATTACHMENT DETAILS

* THESE DRAWINGS AND/OR SPECIFICATIONS AND/OR CALCULATIONS HAS BEEN PREPARED BY OTHER DESIGN PROFESSIONALS OR CONSULTANTS WHO ARE LICENSED AND/OR AUTHORIZED TO PREPARE SUCH DRAWINGS IN THIS STATE. IT HAS BEEN EXAMINED BY ME FOR:

- DESIGN INTENT AND APPEARS TO MEET THE APPROPRIATE REQUIREMENTS OF TITLE 24, CALIFORNIA CODE OF REGULATIONS AND THE PROJECT SPECIFICATIONS PREPARED BY ME, AND
- COORDINATION WITH MY PLANS AND SPECIFICATIONS AND IS ACCEPTABLE FOR INCORPORATION INTO THE CONSTRUCTION OF THIS PROJECT.

THE STATEMENT OF GENERAL CONFORMANCE SHALL NOT BE CONSTRUED AS RELIEVING ME OF ANY RIGHTS, DUTIES, AND RESPONSIBILITIES UNDER SECTION 17203 AND 81138 OF THE EDUCATION CODE AND SECTIONS 4-336, 4-341 AND 4-344 OF TITLE 24, PART 1, (TITLE 24, PART 1, SECTION 4-317 (B))

Tim Hyde
Structural Engineer
License # S3260
Exp. Date 05/27/2022

C0.0

COVER SHEET C0.0

HIRAM JOHNSON HIGH SCHOOL GOLF PRACTICE FACILITY, VARSITY BASEBALL AND SOFTBALL FIELDS
 PROJECT NO. 2203200
 DATE: 09-15-22
 PLOTTED BY: station27


HIRAM JOHNSON HIGH SCHOOL GOLF PRACTICE FACILITY, VARSITY BASEBALL AND SOFTBALL FIELDS
 DSA ADDENDUM SUBMITAL - 09/21/2022

SYM	DESCRIPTION
9	EXISTING TOW-AWAY SIGN AT PARKING LOT ENTRANCE

PARKING COUNTS							PER C.B.C. 118-208.2
TOTAL (e)	(e) STANDARD	(e) ♠	(e) ♢	REQUIRED ♠	REQUIRED ♢	TOTAL NEW PARKING REQUIRED	
356	343	10	3	8	2	0	

GENERAL SHEET NOTES


- ACCESSIBLE PATH OF TRAVEL AS INDICATED ON PLAN IS A BARRIER-FREE ACCESS ROUTE WITHOUT ANY ABRUPT LEVEL CHANGES EXCEEDING 1/2" BEVELED AT 1:2 MAXIMUM SLOPE, OR VERTICAL LEVEL CHANGES NOT EXCEEDING 1/4" MAXIMUM, AND IS AT LEAST 48" WIDE. SURFACE IS SLIP-RESISTANT, STABLE, FIRM, AND SMOOTH. CROSS SLOPE DOES NOT EXCEED 2%, AND SLOPE IN THE DIRECTION OF TRAVEL IS LESS THAN 5% UNLESS OTHERWISE NOTED. ACCESSIBLE PATH OF TRAVEL SHALL BE MAINTAINED FREE OF OVERHANGING OBSTRUCTIONS TO 80" MINIMUM AND FROM OBJECTS PROJECTING MORE THAN 4" FROM WALL BETWEEN 27" AND 80" AFF. ARCHITECT SHALL VERIFY THAT THERE ARE NO BARRIERS IN THE PATH OF TRAVEL.
 - CONTRACTOR SHALL VERIFY THAT ALL BARRIERS IN THE PATH OF TRAVEL HAVE BEEN REMOVED, OR WILL BE REMOVED, UNDER THIS PROJECT, AND THAT THE PATH OF TRAVEL COMPLIES WITH CBC SECTION 11338 - GENERAL ACCESSIBILITY FOR ENTRANCES, EXITS AND PATHS OF TRAVEL.
 - CONTRACTOR TO ENSURE ACCESS THROUGH CAMPUS BY PROVIDING STRATEGIC CONSTRUCTION FENCING AND TRENCH LIDS AT APPROPRIATE LOCATIONS. VERIFY LOCATIONS WITH OWNER REPRESENTATIVE. SCHEDULE TRENCHING TO BE COMPLETED DURING PERIODS OF LEAST INTERRUPTION FOR CAMPUS USE.
 - THE INTENT OF THE DRAWINGS AND SPECIFICATIONS IS TO MODIFY THE FACILITY FOR ACCESSIBILITY IN ACCORDANCE WITH TITLE 24, CALIFORNIA CODE OF REGULATIONS. SHOULD ANY CONDITIONS DEVELOP THAT ARE NOT COVERED BY THE CONTRACT DOCUMENTS SUCH THAT THE FINISHED WORK WILL NOT COMPLY WITH TITLE 24, A CONSTRUCTION CHANGE DIRECTIVE (CCD) DETAILING AND SPECIFYING THE WORK REQUIRED TO BRING CONDITIONS INTO COMPLIANCE WITH TITLE 24 SHALL BE SUBMITTED TO AND APPROVED BY DSA BEFORE PROCEEDING WITH THE WORK.
- DESIGN PROFESSIONAL IN GENERAL RESPONSIBLE CHARGE STATEMENT:**
THE POT IDENTIFIED IN THESE CONSTRUCTION DOCUMENTS IS COMPLIANT WITH CURRENT APPLICABLE CALIFORNIA BUILDING CODE ACCESSIBILITY PROVISIONS FOR **PATH OF TRAVEL REQUIREMENTS AND STRUCTURAL REPAIRS**. AS PART OF THE DESIGN OF THIS PROJECT, THE POT WAS EXAMINED AND ANY ELEMENTS, COMPONENTS OR PORTION OF THE POT THAT WERE DETERMINED TO BE NONCOMPLIANT 1) HAVE BEEN IDENTIFIED AND 2) THE CORRECTIVE WORK NECESSARY TO BRING THEM INTO COMPLIANCE HAS BEEN INCLUDED WITHIN THE SCOPE OF THIS PROJECT'S WORK THROUGH DETAILS, DRAWINGS AND SPECIFICATIONS INCORPORATED INTO THESE CONSTRUCTION DOCUMENTS. ANY NONCOMPLIANT ELEMENTS, COMPONENTS OR PORTION OF THE POT THAT WILL NOT BE CORRECTED BY THIS PROJECT BASED ON VALUATION THRESHOLD LIMITATIONS OR A FINDING OF UNREASONABLE HARDSHIP ARE SO INDICATED IN THESE CONSTRUCTION DOCUMENTS.
- DURING CONSTRUCTION, IF POT ITEMS WITHIN THE SCOPE OF THE PROJECT REPRESENTED AS CODE COMPLIANT ARE FOUND TO BE NONCONFORMING BEYOND REASONABLE CONSTRUCTION TOLERANCES, THEY SHALL BE BROUGHT INTO COMPLIANCE WITH THE CBC AS PART OF THIS PROJECT BY MEANS OF A "CONSTRUCTION CHANGE DOCUMENT" (FORM DSA 140).
- NOTE: THIS DRAWING IS FOR AGENCY APPROVAL ONLY - NOT FOR CONSTRUCTION.

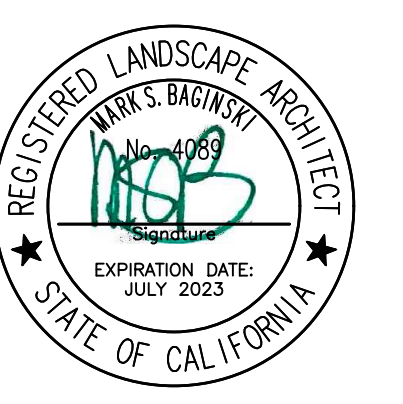

CONSULTANT

ACCESSIBILITY LEGEND

SYM	DESCRIPTION
- - -	PROJECT LIMIT OF WORK
P.O.T.	ACCESSIBLE PATH OF TRAVEL - PATH OF TRAVEL SHALL NOT EXCEED 2% SLOPE IN EITHER DIRECTION. ALTERATIONS MUST BE MADE TO ENSURE SLOPE IS LESS THAN 2% IN EITHER DIRECTION FOR ENTIRE PATH OF TRAVEL.
P.O.T.	EXISTING ACCESSIBLE PATH OF TRAVEL
→	PEDESTRIAN ACCESS
♠	NUMBER OF EXISTING ACCESSIBLE PARKING STALLS;
♢	NUMBER OF EXISTING ACCESSIBLE VAN PARKING STALLS;
♠	NUMBER OF EXISTING PARKING STALLS
DF	PROPOSED DRINKING FOUNTAIN
E	EXISTING FIRE HYDRANT
G1	42" TALL X 4" WIDE CHAINLINK SWING GATE - ACCESSIBLE
G2	6" TALL X 4" WIDE CHAINLINK SWING GATE - ACCESSIBLE
G3	8" TALL X 4" WIDE CHAINLINK SWING GATE WITH TRANSOM - ACCESSIBLE
G4	6" TALL X 8" WIDE CHAINLINK DOUBLE SWING GATE - ACCESSIBLE
G5	8" TALL X 10" WIDE DOUBLE MIXED LEAF CHAINLINK WITH TRANSOM
G6	6" TALL X 12" WIDE CHAINLINK DOUBLE SWING GATE
E1	EXISTING GATE - 8" TALL X 8" WIDE CHAINLINK SWING GATE
E2	EXISTING GATE - 8" TALL X 12" WIDE CHAINLINK SWING GATE

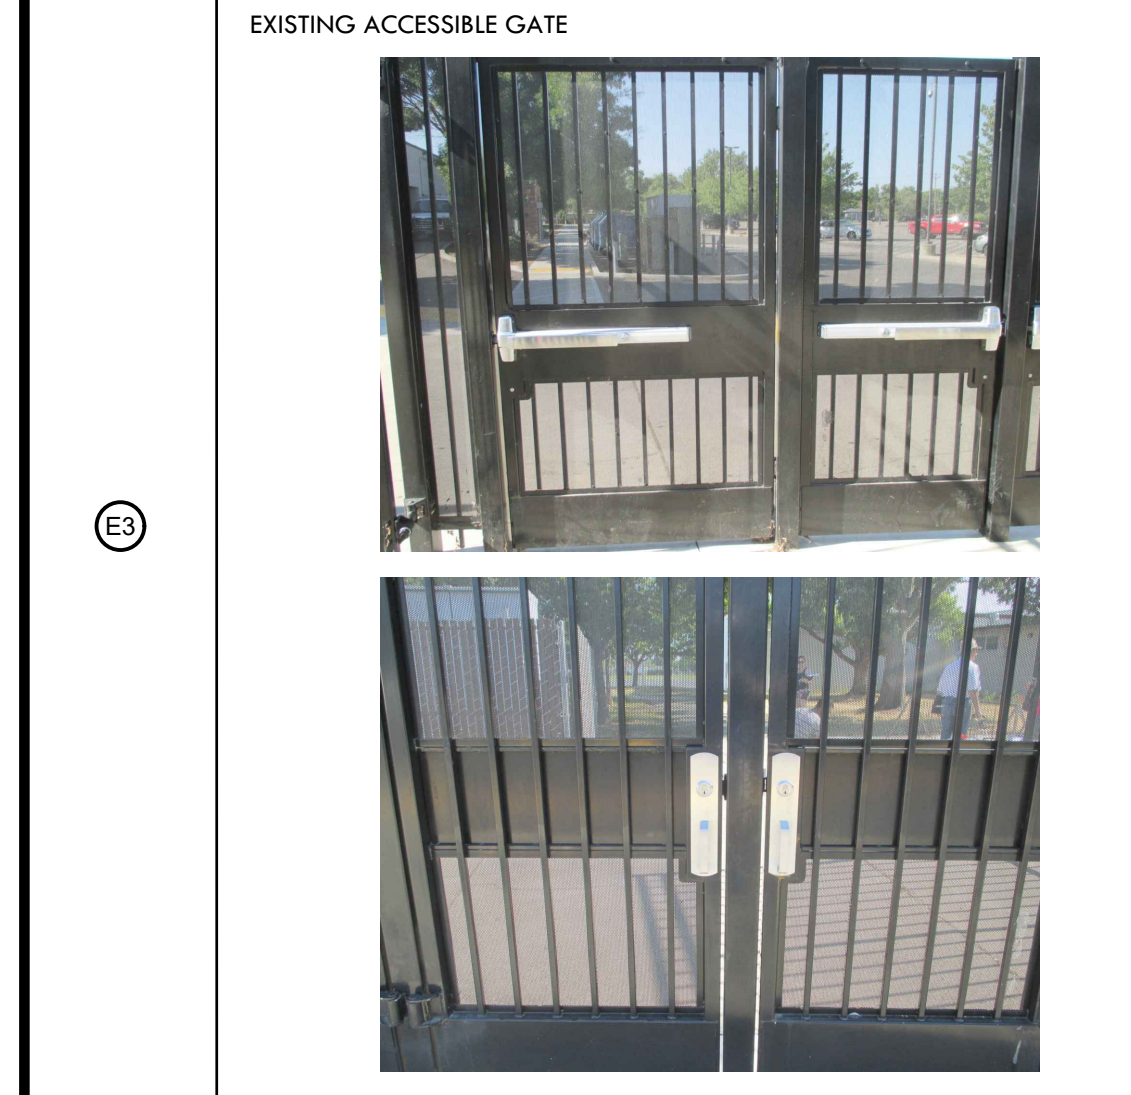

NO.	REVISIONS	DATE
1	PROPOSED BASEBALL FIELD	
2	PROPOSED SOFTBALL FIELD	
3	PROPOSED GOLF PRACTICE AREA	
4	PROPOSED DUGOUTS	
5	PROPOSED BULLPENS	
6	PROPOSED BATTING CAGE	
7	PROPOSED 4-ROW BLEACHERS	
8	EXISTING ACCESSIBLE RESTROOM/CONCESSION BUILDING DSA#02-119926	

ACCESSIBILITY PLAN



PROJECT NAME
HIRAM JOHNSON HIGH SCHOOL GOLF PRACTICE FACILITY, VARSITY BASEBALL AND SOFTBALL FIELDS

PROJECT ADDRESS
6879 14TH AVENUE SACRAMENTO, CA 95820


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DD 50% SUBMITTAL	04/15/22
100% DSA SUBMITTAL	05/27/22
DSA BACK CHECK	08/11/22
DSA ADDENDUM SUBMITTAL	09/16/22

NO.	REVISIONS	DATE
1	ADDENDUM	09/16/22

DRAWN BY KL	CHECKED BY MB/CS
DATE ISSUED 09/16/2022	SCALE 1" = 50'-0"
PROJ. NO. 2203200	SHEET NO. L0.1

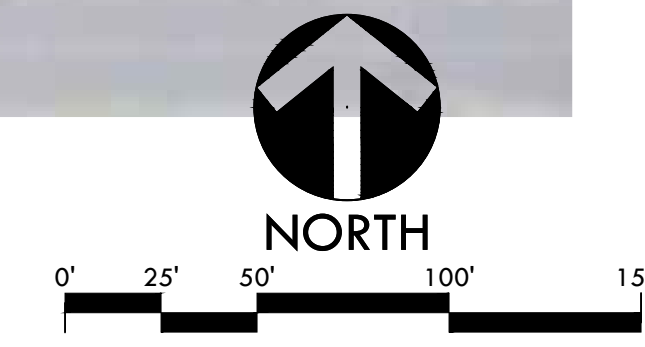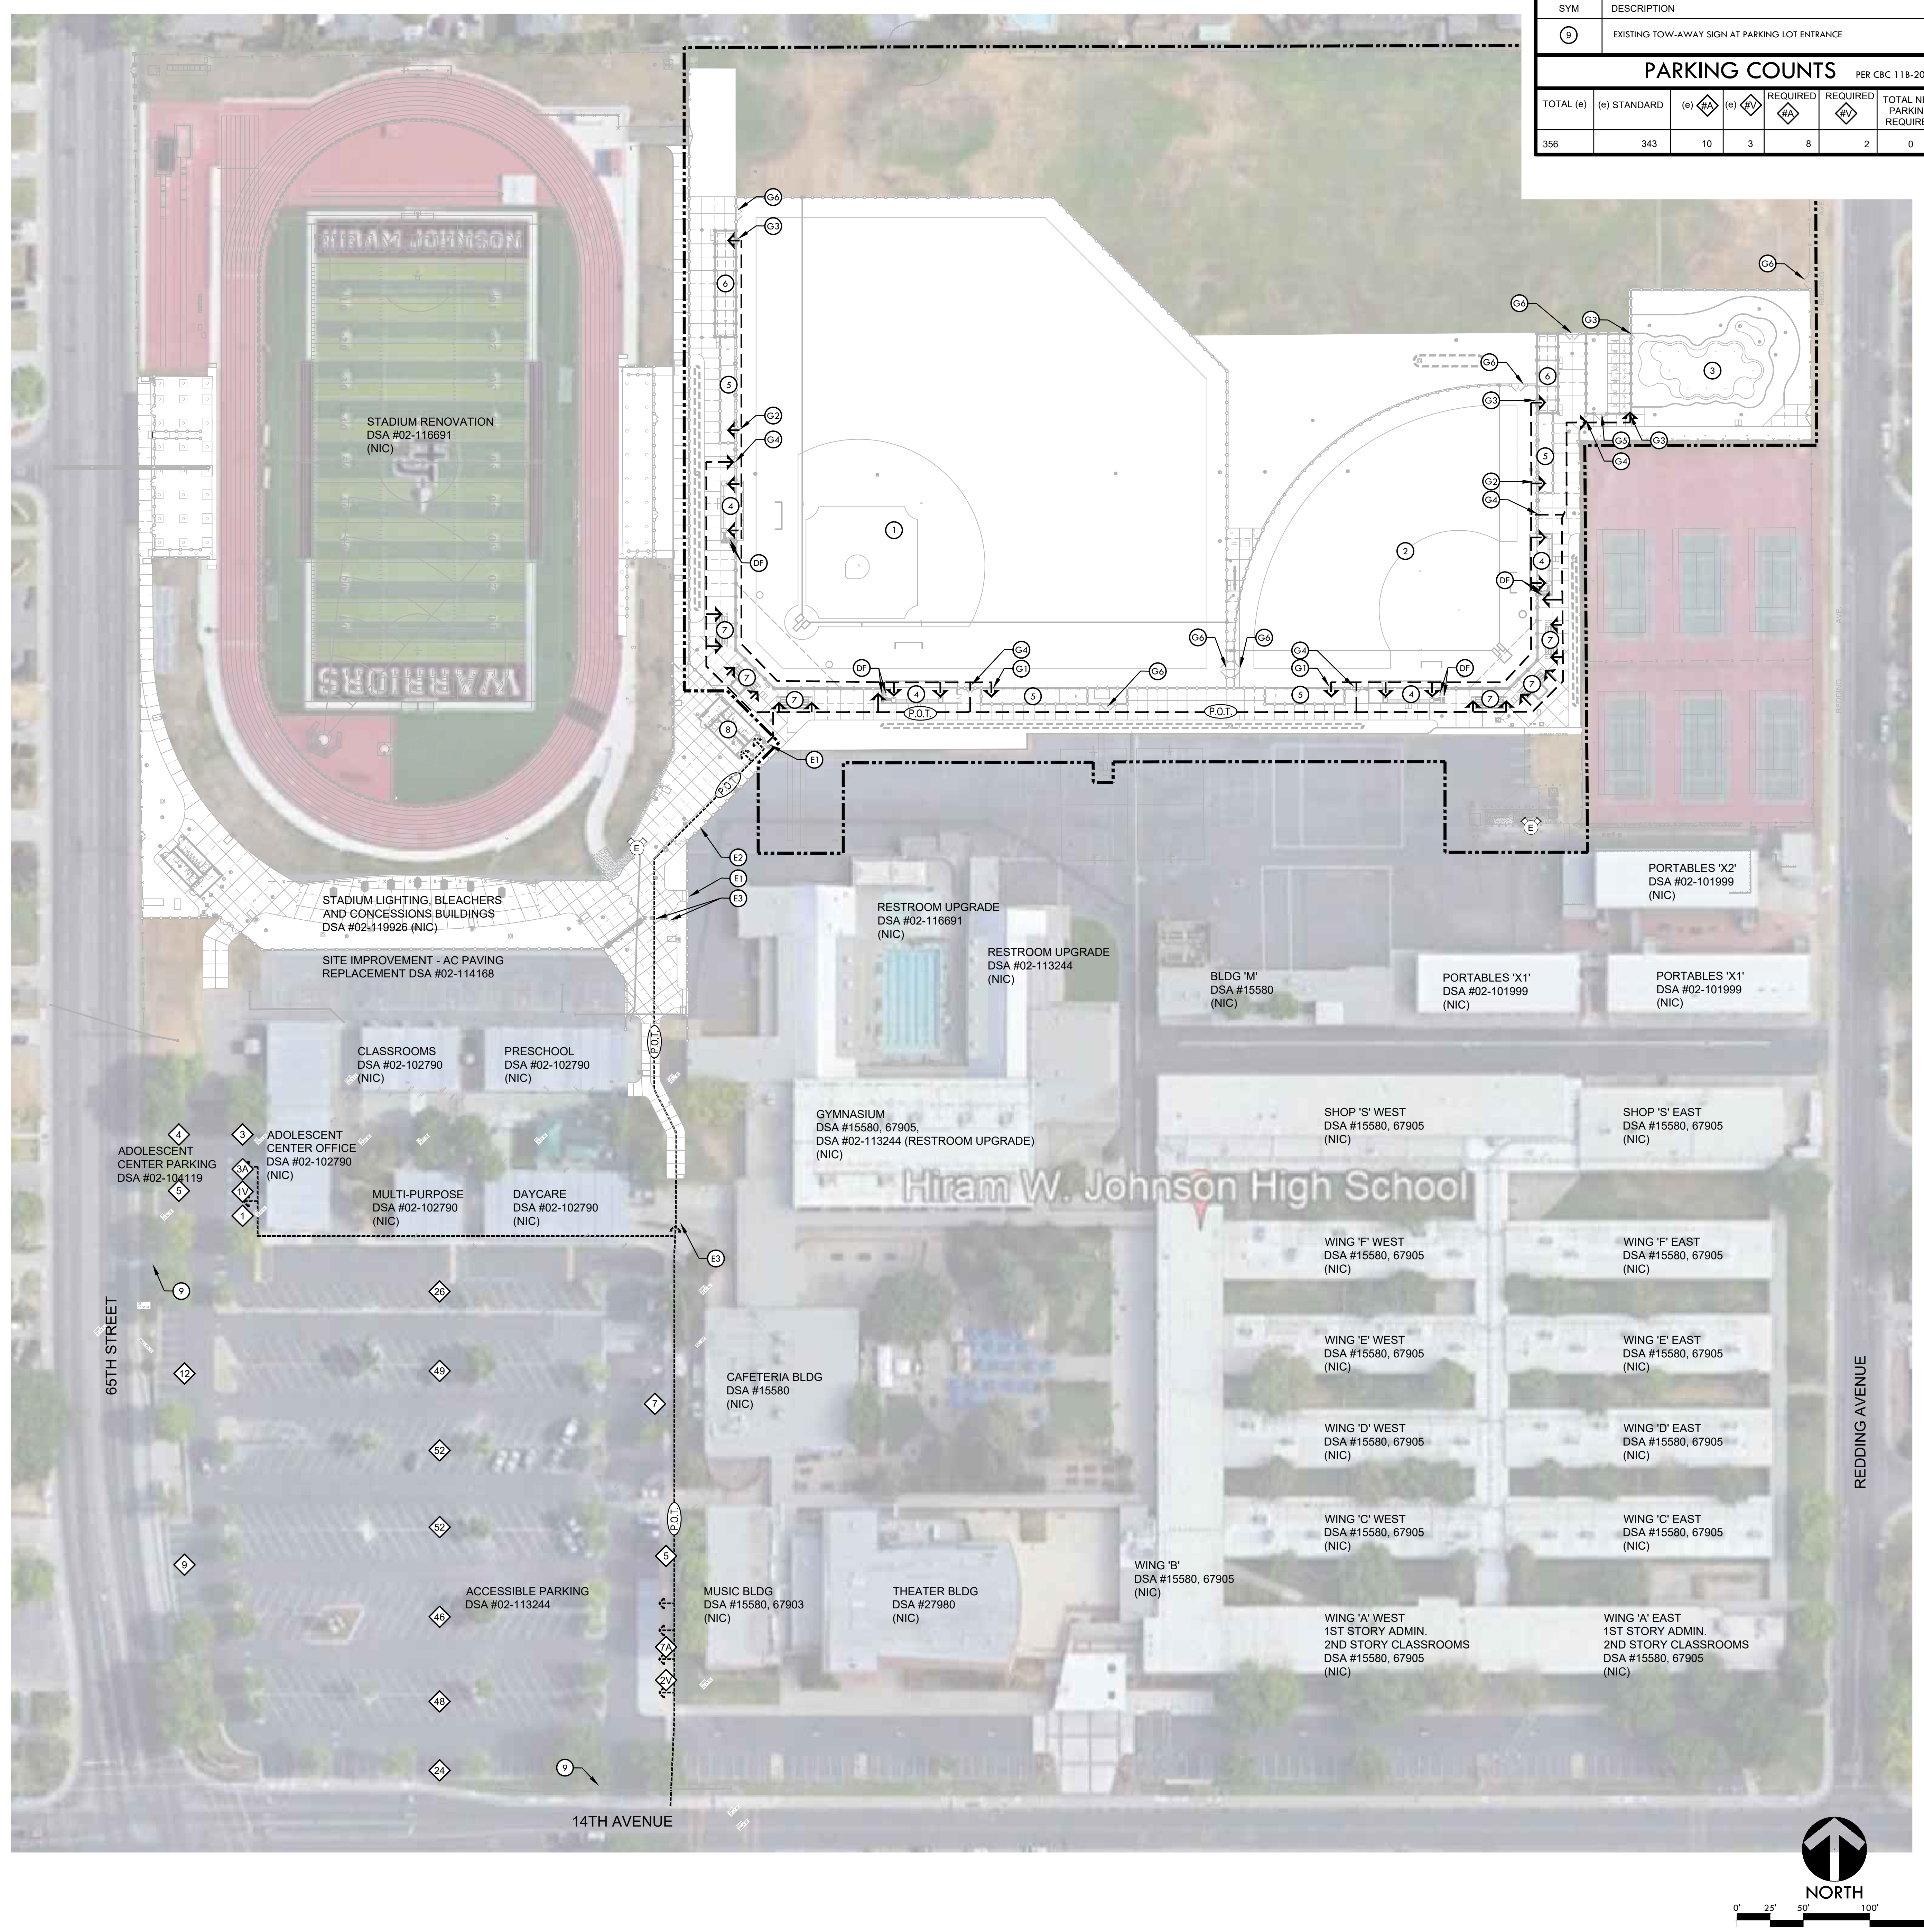

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EXISTING CONDITIONS LEGEND

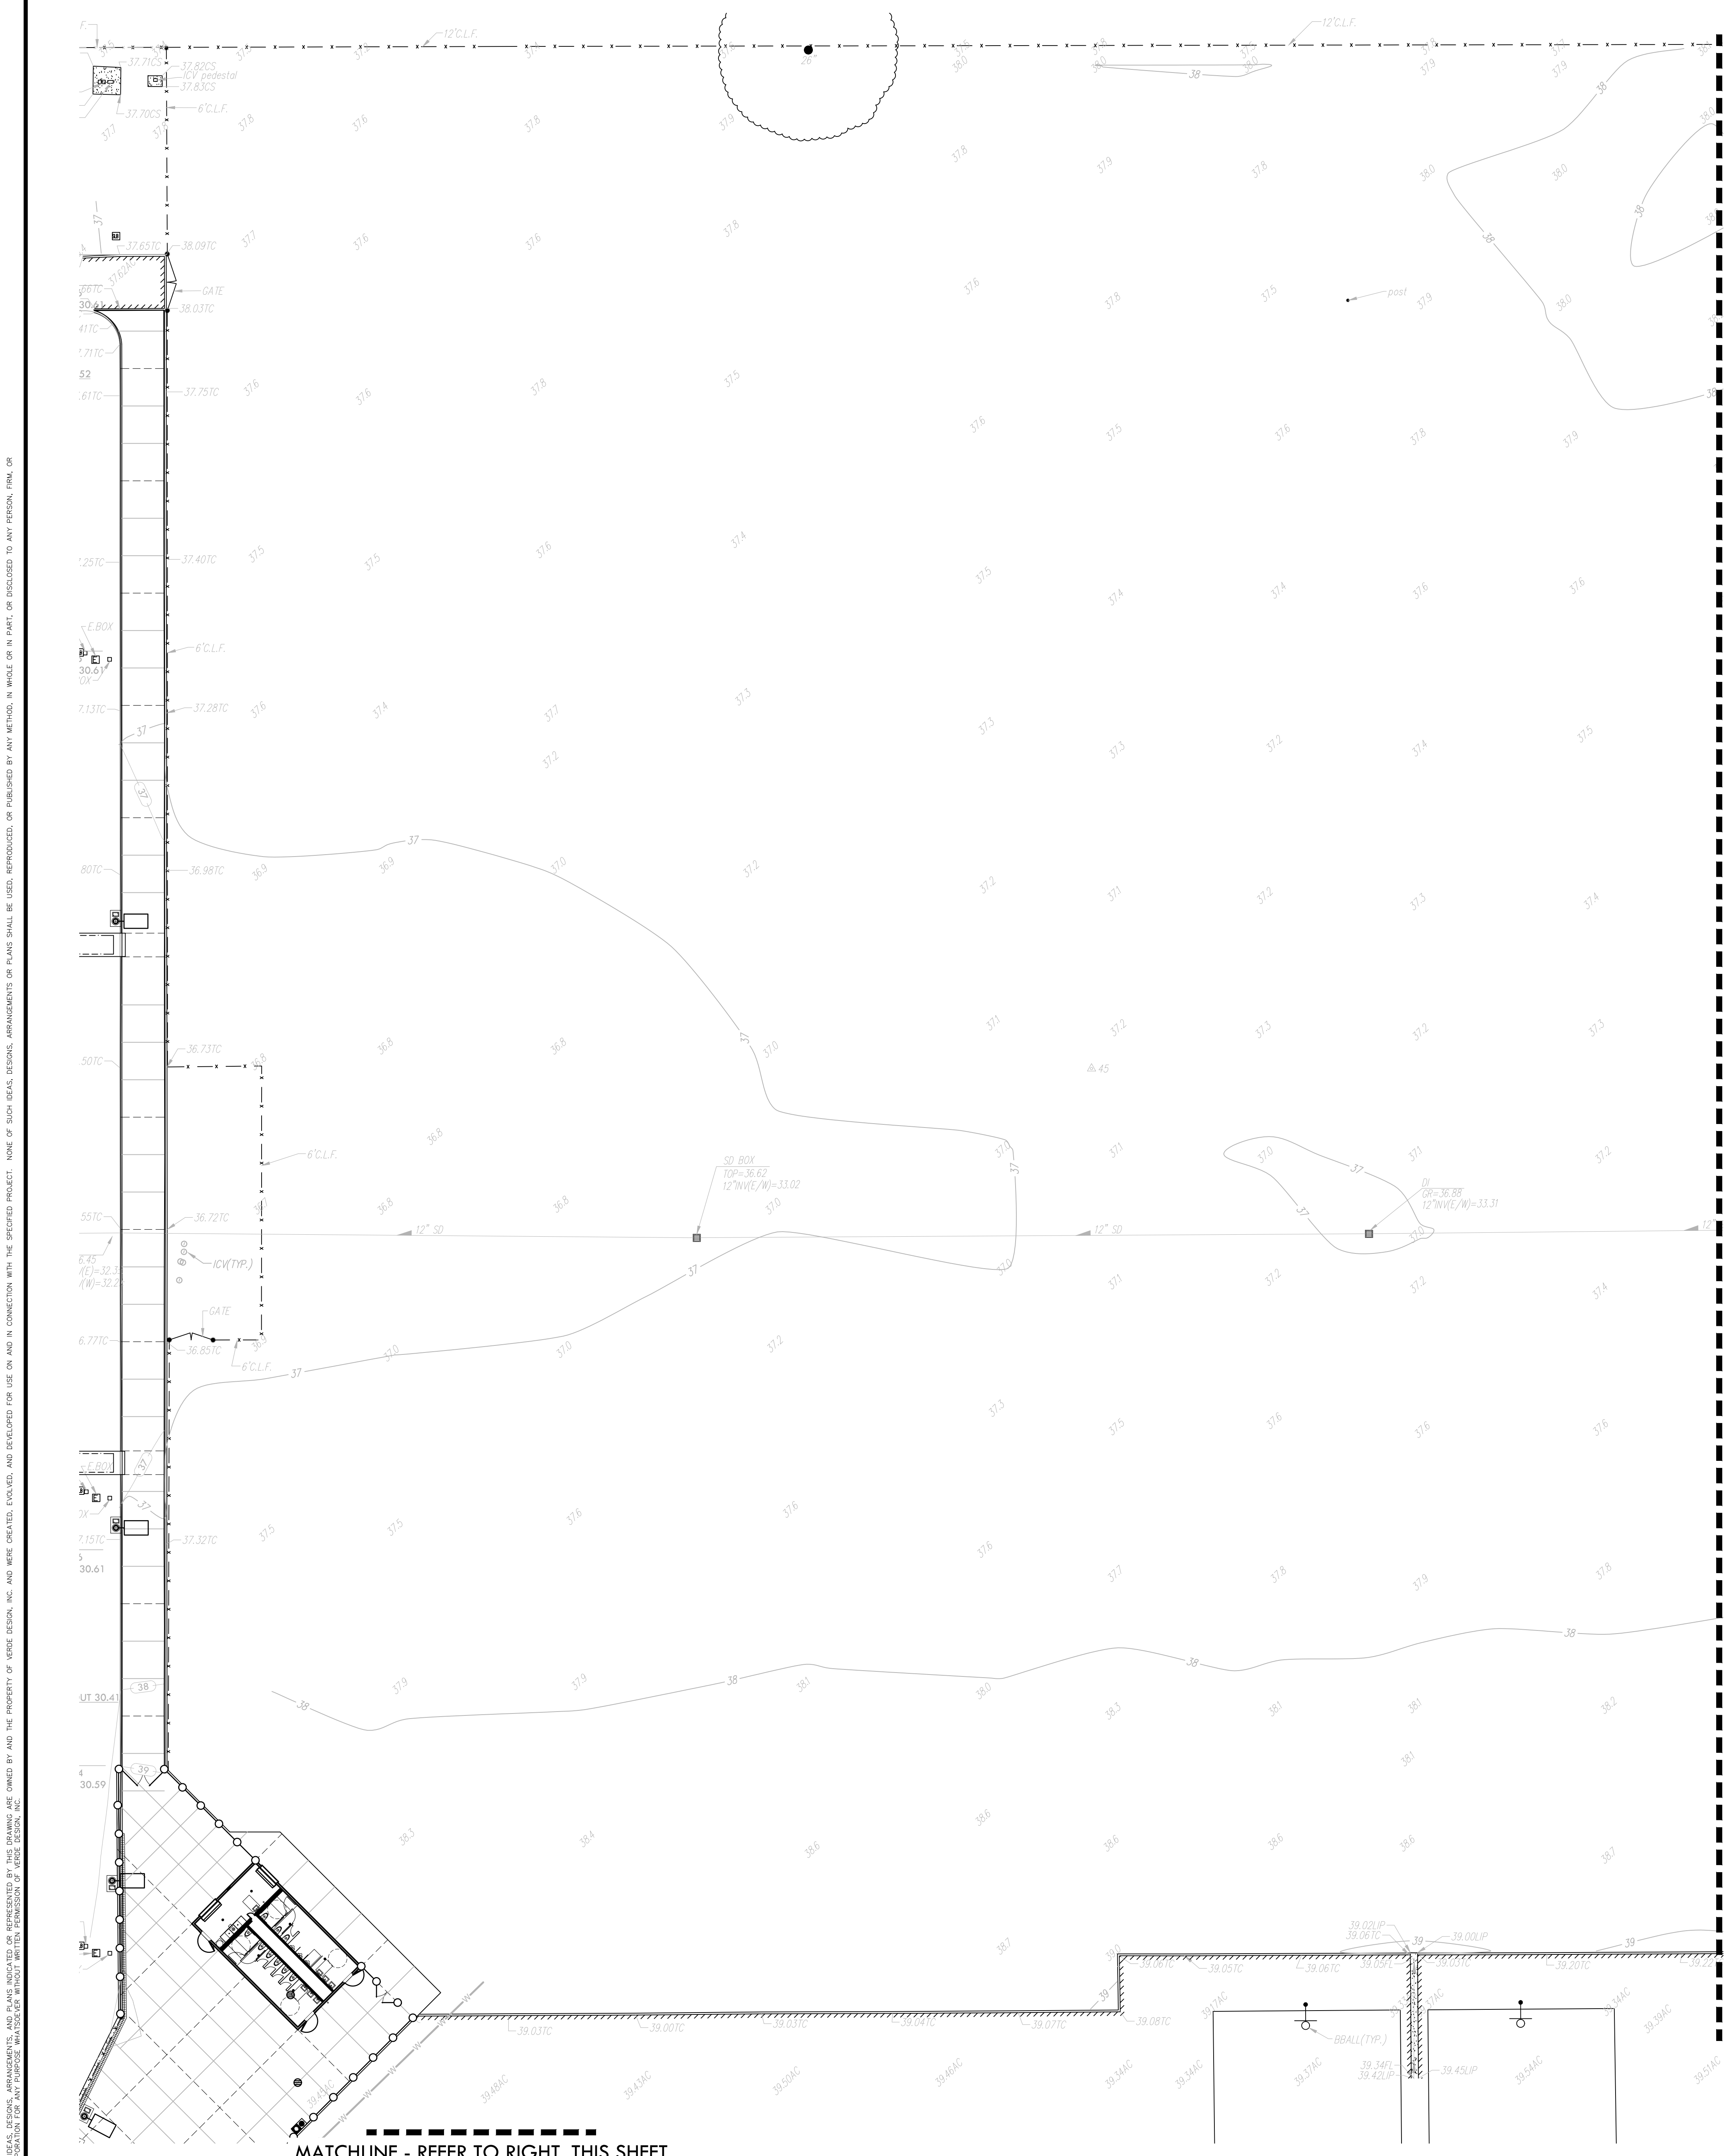- ⊕ = ELECTRIC MANHOLE
 - ⊖ = UTILITY POLE (WITH GUY WIRE)
 - ⊕ = ELECTRIC METER
 - ⊕ = ELECTRIC BOX
 - ⊕ = STREET LIGHTING BOX
 - ⊕ = LIGHT STANDARD
 - ⊕ = SIGNAL LIGHT
 - ⊕ = FLOOD LIGHT
 - ⊕ = ELECTRICAL OUTLET
 - G — = GAS LINE (SIZE INDICATED)
 - G --- = GAS LINE (record information)
 - G --- = GAS LINE (UNDERGROUND LOCATING)
 - ⊕ = GAS MANHOLE
 - ⊕ = GAS VALVE
 - ⊕ = GAS METER
 - t — = telephone line
 - t --- = telephone line (record information)
 - t --- = telephone line (UNDERGROUND LOCATING)
 - ⊕ = STORM DRAIN BOX
 - ⊕ = TRAFFIC SIGNAL BOX
- AC ASPHALTIC CONCRETE
 - ACC ACCESSORY
 - ACU AIR CONDITIONING UNIT
 - AD AREA DRAIN
 - APN ASSESSOR'S PARCEL NUMBER
 - ARV AIR RELEASE VALVE
 - BBALL BASKETBALL POLE
 - BCM BRASS CAP MONUMENT
 - BFP BACK FLOW PREVENTER
 - BL BUILDING
 - BLDG BUILDING
 - BOL BUILD-OFF VALVE
 - BR BRICK
 - B.W.F. BARBED WIRE FENCE
 - COM COMMUNICATION
 - CAB CABINET
 - CATV CABLE TELEVISION
 - CIP CAPPED IRON PIPE
 - CL.F. CHAIN LINK FENCE
 - CMF CORRUGATED METAL PIPE
 - CD CLEANDIT
 - COL COLUMN
 - COND. CONCRETE
 - COND. CONDENSATE
 - CPF CONTROL POINT FOUND
 - CPZ CONTROL POINT SET
 - CS CONCRETE SURFACE
 - CS CONCRETE SURFACE
 - DF DRINKING FOUNTAIN
 - DG DECOMPOSED GRANITE
 - DI DROP INLET
 - DIA DIAMETER
 - DRVY DRIVEWAY
 - DWG DRAWING
 - EP ELECTRIC
 - EP EDGE OF PAVEMENT
 - ESMT EASEMENT
 - FA FIRE ALARM
 - FDC FIRE DEPARTMENT CONNECTION
 - FTE FINISHED FLOOR ELEVATION
 - FH FIRE HYDRANT
 - FL FLOWLINE
 - FO FIBER OPTIC
 - FS FIRE SERVICE
 - GB GRADE BREAK
 - GR GROUND ROD BOX
 - GRB GROUND ROD
 - GV GAS VALVE
 - HB HOSE BIBB
 - HBD HEADER BOARD
 - HR HIGH PRESSURE
 - HRV HIGH VOLTAGE ELECTRIC
 - HPV HIGH VOLTAGE FENCE
 - ICP IN CONCRETE
 - ICV IRRIGATION CONTROL VALVE
 - INVV INVERT ELEVATION
 - IRK IRRIGATION
 - JP JOINT UTILITY POLE
 - JT JOINT BENCH
 - LANDG LANDING
 - LVE LOW VOLTAGE ELECTRIC
 - MA MANHOLE
 - MS METAL STORAGE CONTAINER
 - NTS NOT TO SCALE
 - DN OVERHEAD
 - DHANG OVERHANG
 - DIP OPEN IRON PIPE
 - DSHP L.D. STEEL POST HOLE
 - P/L PROPERTY LINE
 - PA PLANTER AREA
 - PB PARKING BUMPER
 - PH POSTHOLE
 - PIV POST INDICATOR VALVE
 - PP POWER POLE
 - PRKG PARKING
 - PUE PUBLIC UTILITY EASEMENT
 - PVC POLYVINYL CHLORIDE
 - R RUBBER
 - RG ROLLING GATE
 - RIM MANHOLE RIM ELEVATION
 - ROW RIGHT OF WAY
 - RW RETAINING WALL
 - RWL RAIN WATER LEADER
 - SD STORM DRAIN
 - SDMH STORM DRAIN MANHOLE
 - SIG SIGNAL
 - SLB STREET LIGHT BOX
 - SSC/SJ SANITARY SEWER
 - SSWH SANITARY SEWER CLEANOUT
 - STC STEEL
 - TEL TELEPHONE
 - TBALL TETHER BALL POLE
 - TBM TEMPORARY BENCHMARK
 - TC TOP OF CURB
 - TOW TOP OF WALL
 - TP TELEPHONE POLE
 - TRW TOP OF RETAINING WALL
 - UG UNDERGROUND
 - UNK UNKNOWN
 - V VENT
 - VBALL VOLLEYBALL
 - W WATER
 - W WITH
 - WF WOOD FENCE
 - W.F. WROUGHT IRON FENCE
 - W.R.F. WOOD RAIL FENCE
 - XF TRANSFORMER
 - XWALK CROSSWALK

EXISTING CONDITIONS NOTES

- SURVEY PROVIDED BY: WARREN CONSULTING ENGINEERS, INC.
- BENCHMARK NO. 318-B2C, ELEV. 38.544. FOUND MAG NAIL WITH CITY WASHER IN SIDEWALK JOINT AT 6900 14TH AVE.
 - BASIS OF BEARINGS, ASSUMED BEARING OF REDDING AVENUE BEARING DUE NORTH-SOUTH, BEARING ESTABLISHED FROM FOUND CITY TIES FROM THE CENTERLINE INTERSECTION OF 14TH STREET AND REDDING AVE. TO CENTERLINE INTERSECTION OF MCQUILLAN CIRCLE AND REDDING AVE.
 - TEMPORARY BENCHMARKS:

NUMBER	DESCRIPTION	NORTHING	EASTING	ELEVATION
2	CPS CHSELED "+"	9336.11	10000.65	39.94
3	CPS CHSELED "+"	9435.04	10002.23	42.35
4	CPS CHSELED "+"	9524.76	10001.25	42.61
5	CPS CHSELED "+"	9575.32	10000.98	40.49
6	CPS CHSELED "+"	9705.47	10003.34	40.58
7	CPS CHSELED "+"	9748.46	10002.26	41.24
8	CPS CHSELED "+"	9842.24	10001.72	40.66
9	CPS CHSELED "+"	9937.31	9961.69	40.56
14	CPS CHSELED "+"	10075.05	10287.51	39.46
15	CPS CHSELED "+"	9998.30	10317.87	40.02
16	CPS CHSELED "+"	9990.41	10481.11	40.10
17	CPS CHSELED "+"	10026.79	10578.84	39.77
18	CPS CHSELED "+"	9896.74	9729.87	40.62
19	CPS CHSELED "+"	9787.41	9659.64	40.22
20	CPS CHSELED "+"	9850.07	9414.25	38.76
23	CPS CHSELED "+"	9813.19	10578.40	39.16
24	CPS CHSELED "+"	9792.45	10341.40	40.64
25	CPS CHSELED "+"	9472.42	9880.34	42.57
26	CPS CHSELED "+"	9492.34	9753.50	42.61
27	CPS CHSELED "+"	9521.07	9770.33	42.64
28	CPS CHSELED "+"	9703.12	9735.68	40.66
29	CPF CHSELED "+"	9274.75	10432.38	38.07
30	CPF CHSELED "+"	9235.16	10448.80	38.08
31	CPF BM EL=38.544	9230.28	10519.87	38.54
32	CPF CHSELED "+"	9234.84	10538.69	38.33
33	CPF CHSELED "+"	9235.16	10577.38	38.64
34	CPF CHSELED "+"	9274.43	10592.98	38.60
35	CPF HILT NAIL+WASH	9275.23	10499.99	38.34
36	CPF CHSELED "+"	10249.13	10585.90	39.80
37	CPF CHSELED "+"	10247.58	10538.46	39.79
38	CPF CHSELED "+"	10207.10	10538.46	39.92
39	CPF CHSELED "+"	10010.56	10586.30	39.53
40	CPF CHSELED "+"	9964.86	10585.23	39.58
41	CPF CHSELED "+"	9774.07	10584.84	38.90
42	CPF CHSELED "+"	9275.52	10522.36	38.41
43	CPF CHSELED "+"	9447.40	10495.95	40.65
44	CPS CHSELED "+"	9441.81	10410.29	40.62
45	CPS PICKER	10306.22	9927.04	37.25
46	CPS CHSELED "+"	9937.79	9260.87	35.67
47	CPS CHSELED "+"	10574.82	9254.82	35.63
48	CPF CHSELED "+"	10484.29	10538.87	39.82
49	CPF CHSELED "+"	10445.04	10538.73	39.79
50	CPF CHSELED "+"	10441.20	10586.19	38.63
51	CPF PKNAIL@RED/MATA	10463.85	10558.81	40.18
52	CPS CHSELED "+"	9902.99	9518.05	38.66
4. DATE OF FIELD REVIEW: 02/28/22
5. EXISTING UTILITIES BASED ON VISIBLE SURFACE STRUCTURES AND RECORD INFORMATION.

EXISTING CONDITIONS LEGEND

- = PROPERTY LINE
- = CENTERLINE
- = easement
- ⊕ = PROPERTY CORNER FOUND AS NOTED
- ⊕ = PROPERTY CORNER NOTHING FOUND OR SET
- ⊕ = TEMPORARY BENCHMARK (SEE TBM LIST FOR INFO)
- = SWALE OR DRAINAGE FLOW
- = DRAINAGE FLOW
- = FENCE (TYPE NOTED)
- ⊕ = TREE (SIZE/TYPE INDICATED)
- = SLOPE
- = CONTOUR
- = CONCRETE SURFACE
- = EDGE OF ASPHALT
- = EDGE OF BUILDING
- ⊕ = SIGN
- ⊕ = POST OR BILLBOARD
- 99.9 = GROUND ELEVATION
- 99.99 = HARD SURFACE ELEVATION
- 12"SD = storm drain line (size & direction of flow)
- 12"SD = storm drain line (record information)
- 12"SD = storm drain line (UNDERGROUND LOCATING)
- ⊕ = storm drain manhole
- ⊕ = storm drain cleanout
- ⊕ = drop inlet
- ⊕ = AREA DRAIN
- ⊕ = RAIN WATER LEADER
- ⊕ = downspout
- 12"SS = sanitary sewer line (size & direction of flow)
- 12"SS = sanitary sewer line (record information)
- 12"SS = sanitary sewer line (UNDERGROUND LOCATING)
- ⊕ = sanitary sewer manhole
- ⊕ = sanitary sewer cleanout
- = water line (size indicated)
- = water line (record information)
- = water line (UNDERGROUND LOCATING)
- ⊕ = water manhole
- ⊕ = water valve
- ⊕ = water meter
- ⊕ = water box
- ⊕ = IRRIGATION CONTROL VALVE
- ⊕ = FIRE HYDRANT
- ⊕ = backflow preventer
- ⊕ = SPRINKLER
- ⊕ = hose bibb
- OH-E = OVERHEAD ELECTRIC LINE
- E = UNDERGROUND ELECTRIC LINE
- E = UNDERGROUND ELECTRIC LINE (record information)
- E = UNDERGROUND ELECTRIC LINE (UNDERGROUND LOCATING)

MATCHLINE - REFER TO SHEET L1.2

MATCHLINE - REFER TO LEFT, THIS SHEET


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CONSULTANT

 WARREN CONSULTING ENGINEERS, INC.
 1117 WINDFIELD WAY, SUITE 110
 EL DORADO HILLS, CA 95672 (916)985-1870



SHEET TITLE
EXISTING CONDITIONS PLAN - BASEBALL FIELD


PROJECT NAME
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PROJECT ADDRESS
6879 14TH AVENUE SACRAMENTO, CA 95820

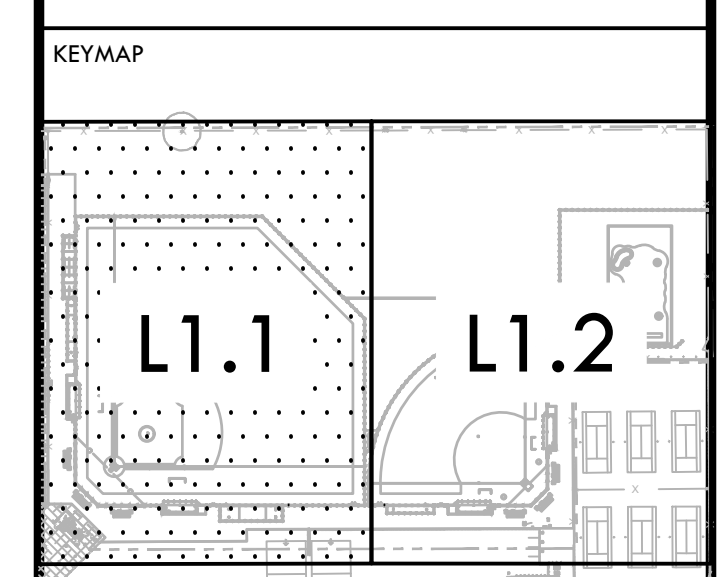SUBMITTAL	DATE
DD 50% SUBMITTAL	04/15/22
100% DSA SUBMITTAL	05/27/22
DSA BACK CHECK	08/11/22
DSA ADDENDUM SUBMITTAL	09/16/22

NO.	REVISIONS	DATE
1	ADDENDUM	09/16/22

DRAWN BY: [Signature] CHECKED BY: MB/CS
 DATE ISSUED: 09/16/2022 SCALE: 1" = 20'-0"
 PROJ. NO.: 2203200
 SHEET NO.: L1.1

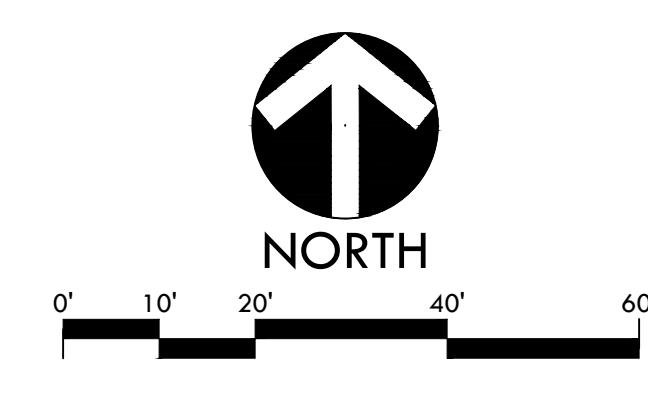


EROSION AND SEDIMENT CONTROL NOTES

1. THIS EROSION AND SEDIMENT CONTROL PLAN MAY NOT COVER ALL SITUATIONS THAT ARISE DURING CONSTRUCTION DUE TO UNANTICIPATED SITE CONDITIONS. CONTRACTOR SHALL IMPLEMENT BEST MANAGEMENT PRACTICES (BMPs) AND SHALL COMPLY WITH THE STATE REGULATIONS TO CONTROL THE DISCHARGE OF STORMWATER POLLUTANTS.
2. EROSION AND SEDIMENT CONTROL SHALL BE CONSTRUCTED DURING FIRST WEEK OF CONSTRUCTION.
3. EROSION AND SEDIMENT CONTROL SHALL REMAIN THROUGHOUT CONSTRUCTION AND BE REMOVED AND DISPOSED OF DURING MAINTENANCE PERIOD.
4. EROSION AND SEDIMENT CONTROL MAY BE ADJUSTED THROUGH CONSTRUCTION WITH APPROVAL OR AS DIRECTED BY DISTRICT'S REPRESENTATIVE.
5. CONTRACTOR SHALL SWEEP STREETS AND PARKING AREAS AFFECTED BY CONSTRUCTION WITH STREET SWEEPER AS REQUIRED TO KEEP PAVING CLEAN OF CONSTRUCTION DEBRIS.
6. CONTRACTOR IS RESPONSIBLE FOR REPAIRING CONSTRUCTION ENTRY AND STAGING AREAS TO AS WAS OR BETTER CONDITIONS.
7. REFER TO STORMWATER POLLUTION PREVENTION PLAN SPECIFICATION SECTION FOR ADDITIONAL INFORMATION AND CONTRACTOR REQUIREMENTS.


EROSION AND SEDIMENT CONTROL LEGEND

SYM	DESCRIPTION	DTL REF
	STORM DRAIN INLET FILTER FOR EXISTING AND PROPOSED STORM DRAINS (FILTER FABRIC TO BE SECURELY ATTACHED TO DRAINAGE STRUCTURE TOP AND PERIMETER WADDE)	B L2.1
	LIMIT OF WORK	
	TEMPORARY CONSTRUCTION FENCE	
	SEDIMENT RETENTION FIBER ROLL	A L2.1
	TEMPORARY CONCRETE WASHOUT FACILITY - PROVIDE A WASHOUT BIN FOR CONSTRUCTION WASHOUT AND REMOVE AT END OF CONSTRUCTION.	D L2.1
	CONSTRUCTION STAGING AREA	
	STABILIZED CONSTRUCTION ENTRY	C L2.1
	DIRECTION OF SURFACE FLOW	

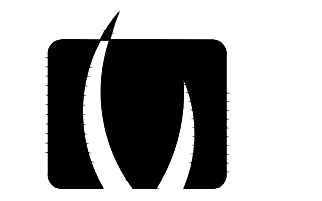

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CONSULTANT

KEYMAP

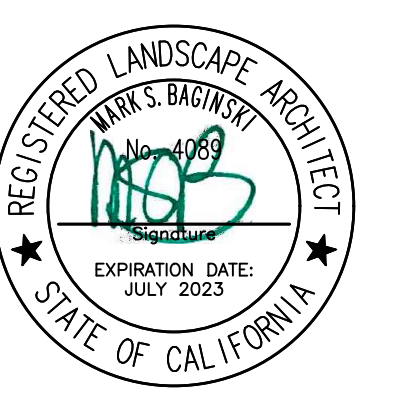SHEET TITLE

EROSION AND SEDIMENT CONTROL PLAN

PROJECT NAME

**HIRAM JOHNSON
 HIGH SCHOOL
 GOLF PRACTICE FACILITY,
 VARSITY BASEBALL AND
 SOFTBALL FIELDS**

PROJECT ADDRESS

**6879 14TH AVENUE
 SACRAMENTO, CA 95820**

SUBMITTAL	DATE
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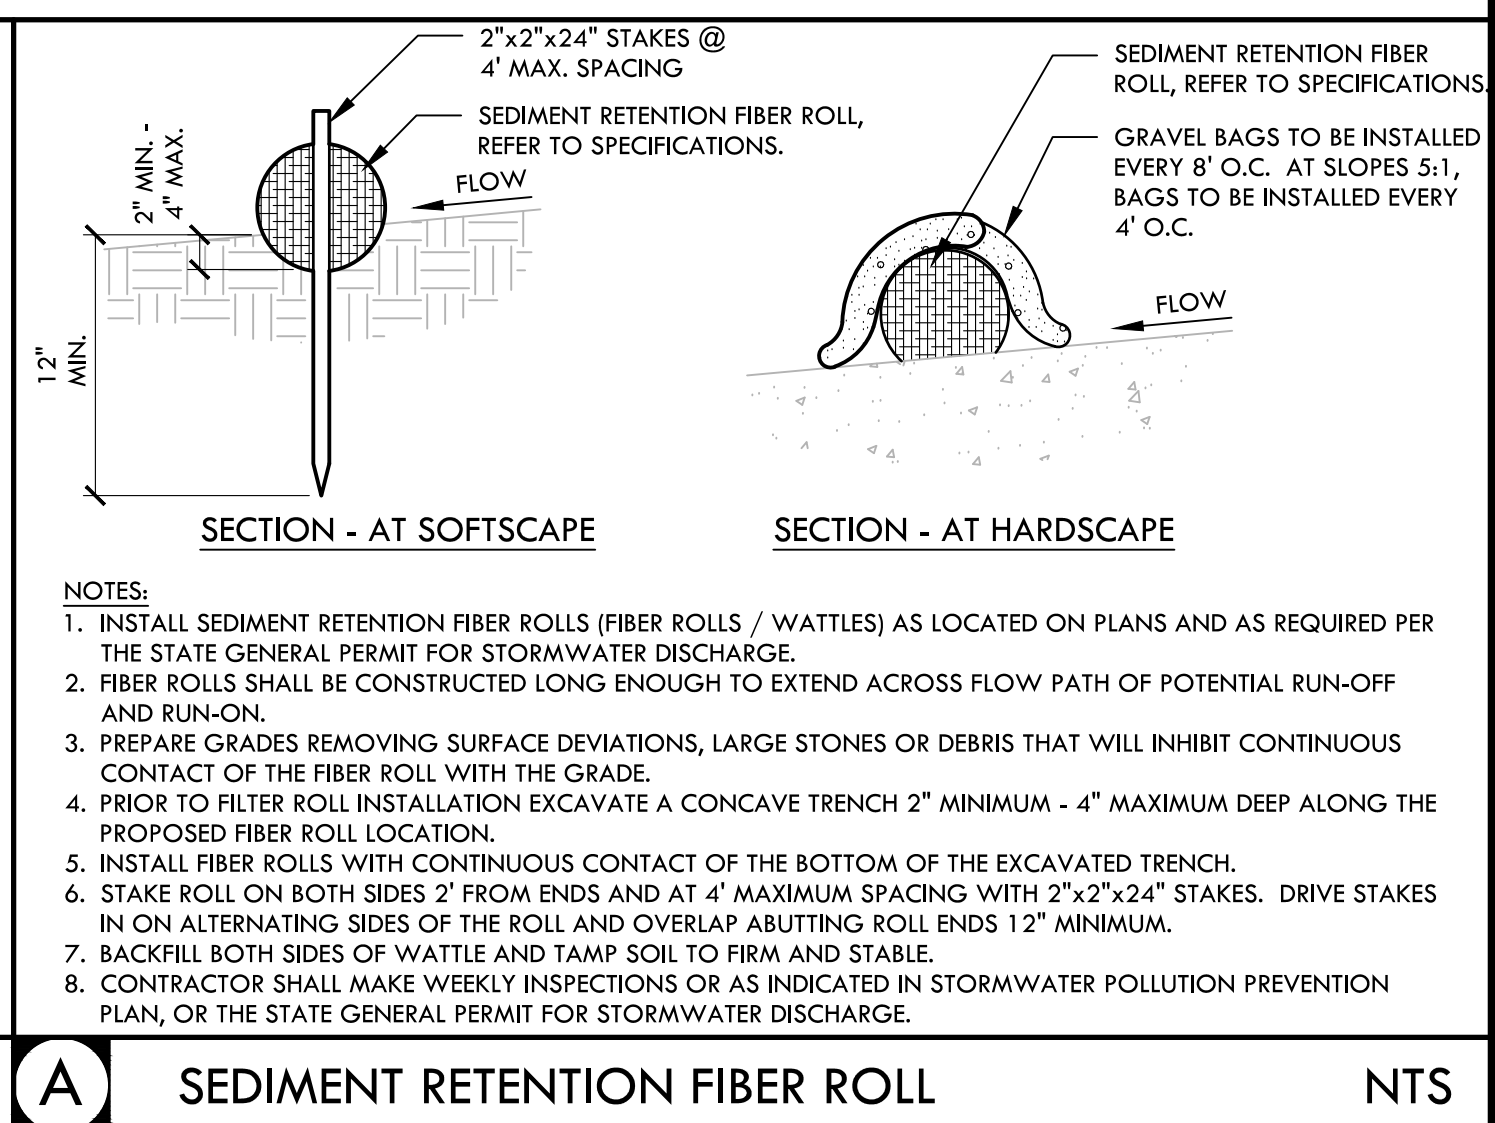
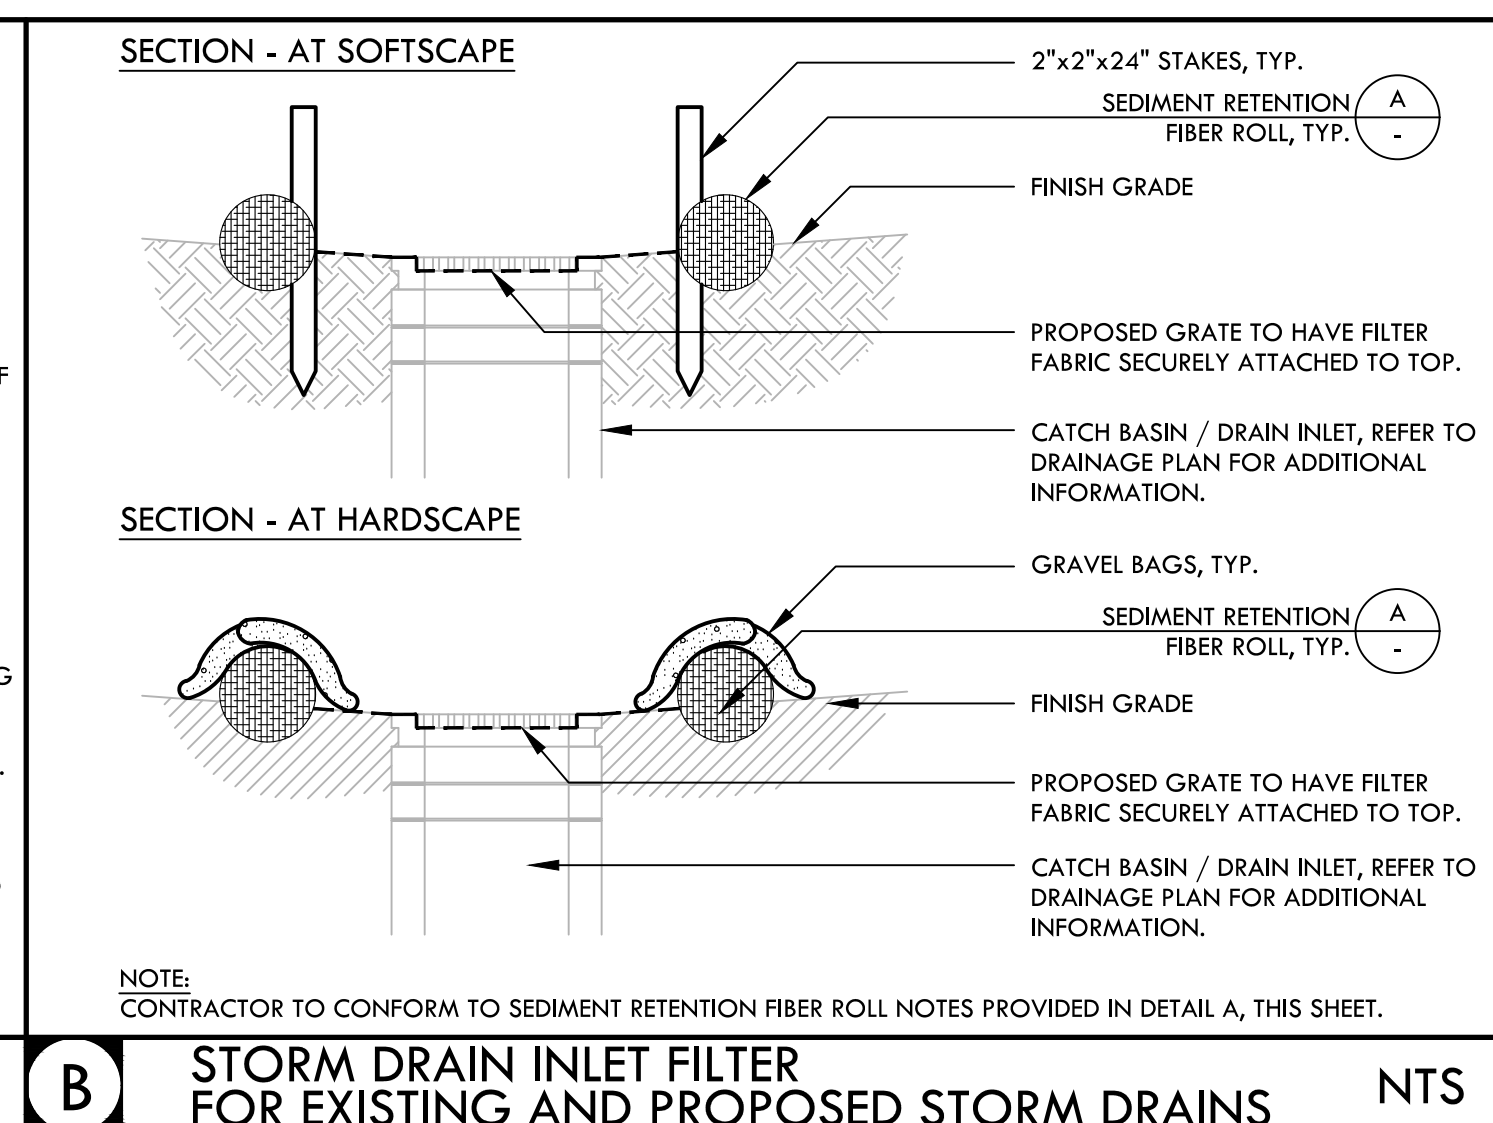
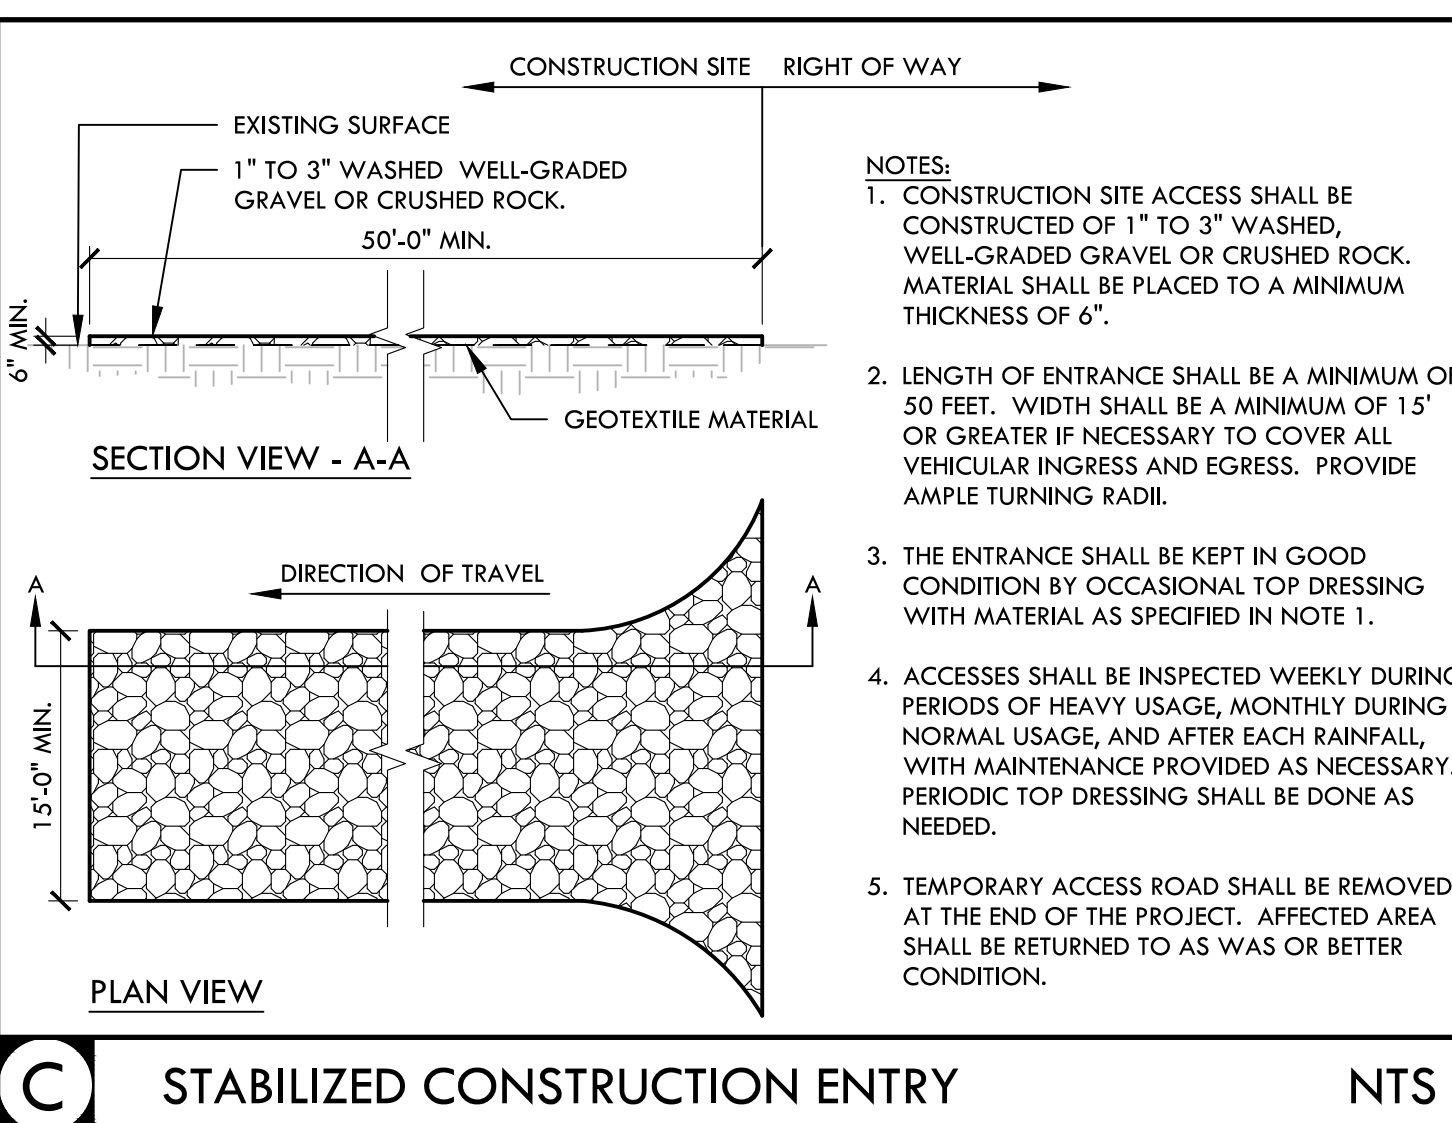
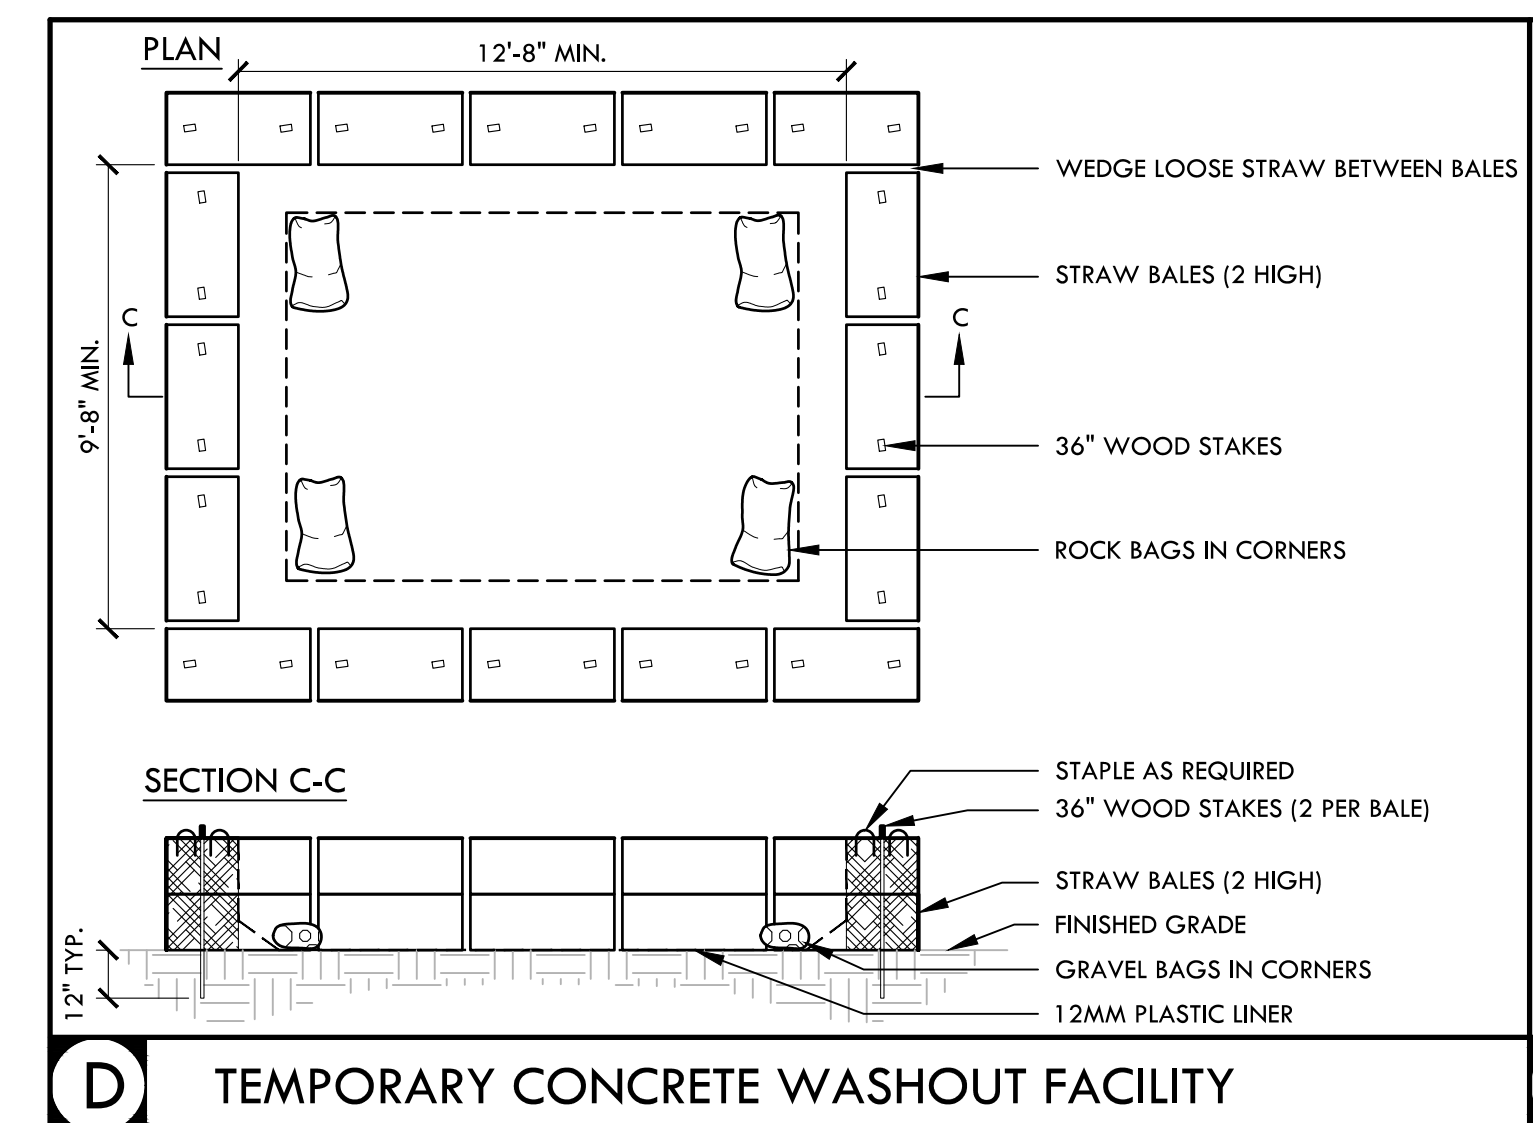
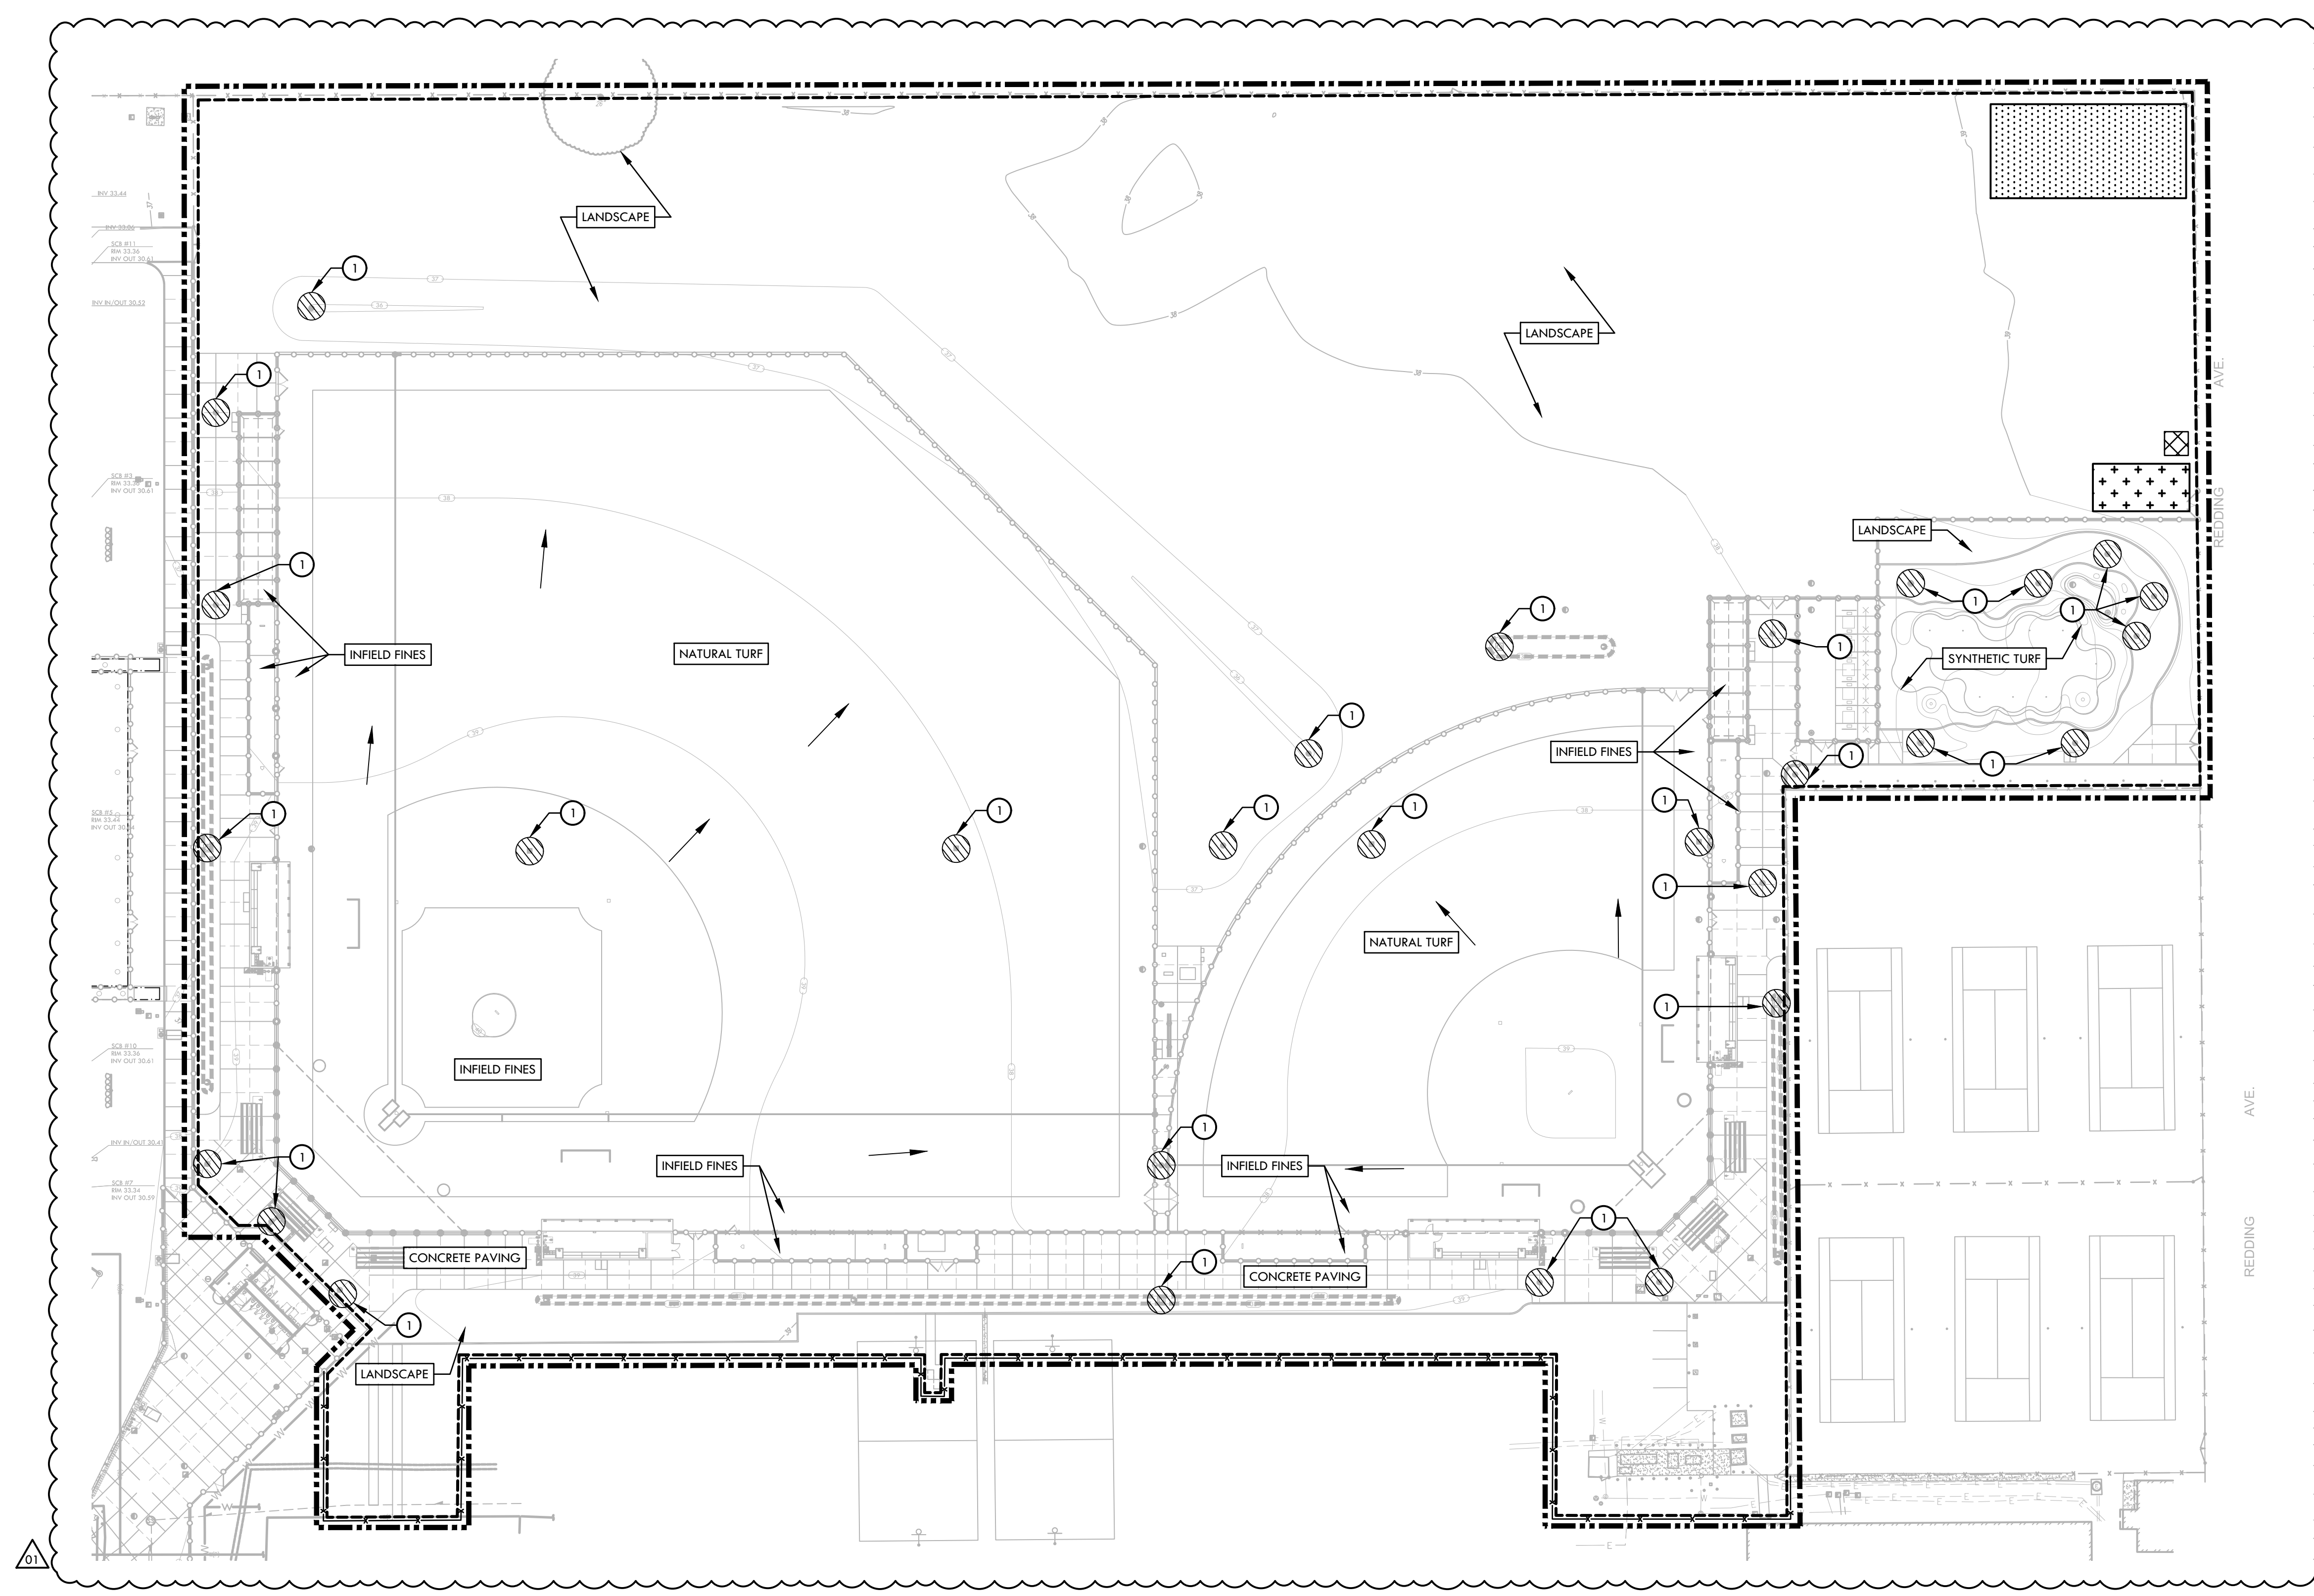
NO.	REVISIONS	DATE
△	ADDENDUM	09/16/22

DRAWN BY: **JC** CHECKED BY: **MB/CS**


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PROJ. NO.: **2203200**


SHEET NO.: **L2.1**



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MATCHLINE - REFER TO SHEET L3.2

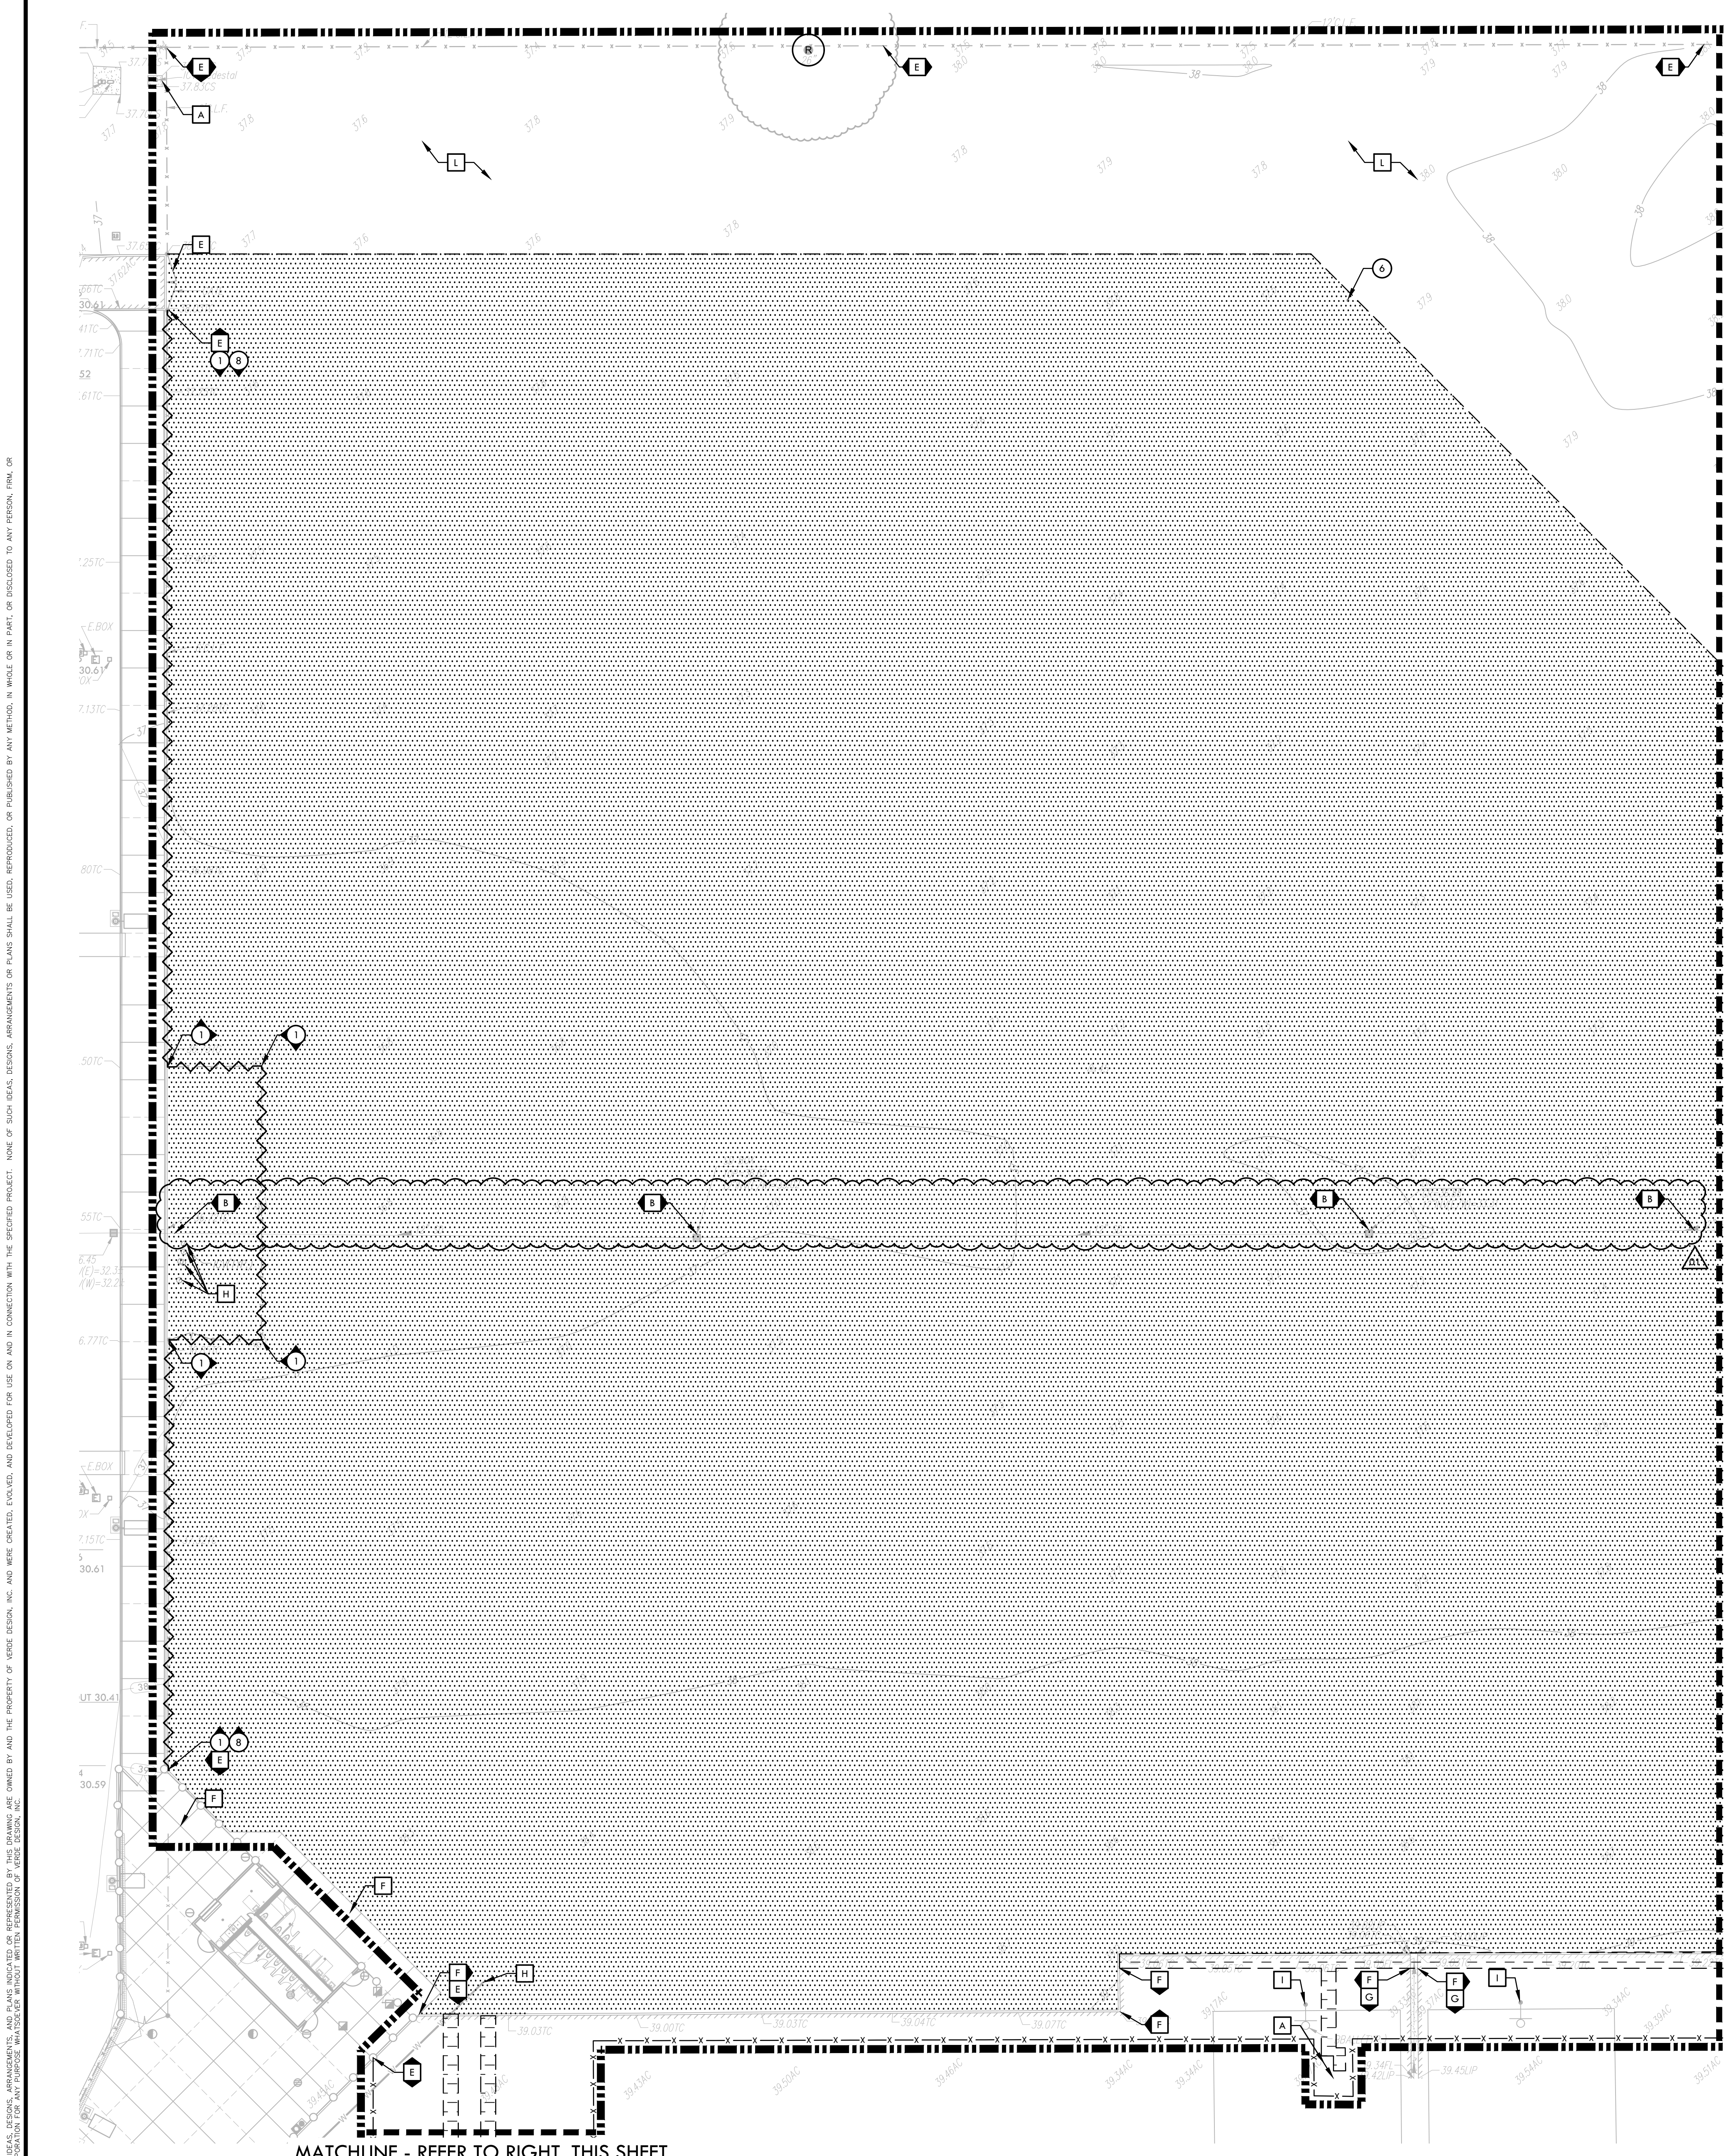

DEMOLITION NOTES

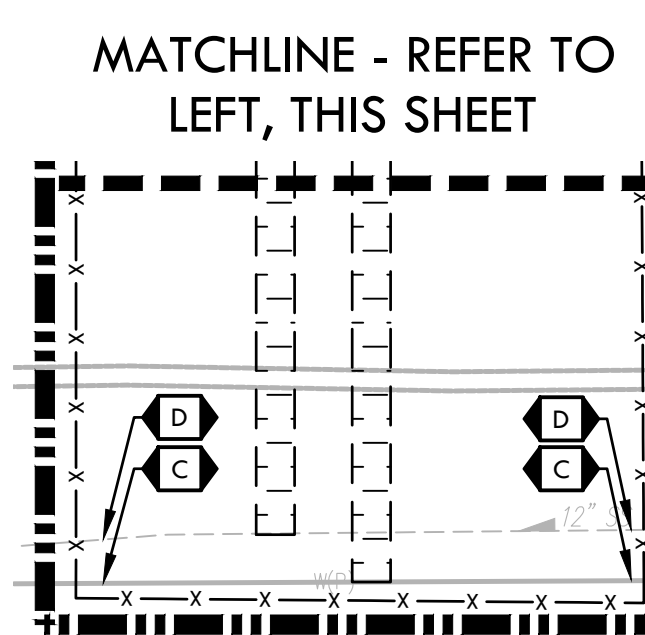1. THE CONTRACTOR SHALL PERFORM ALL CLEARING, DEMOLITION, REMOVAL OF OBSTRUCTIONS AND SITE PREPARATIONS NECESSARY FOR THE PROPER EXECUTION OF ALL WORK CONTAINED IN THE CONTRACT DOCUMENTS.
2. CONTRACTOR SHALL VERIFY LOCATION OF ALL EXISTING UTILITIES AND PROVIDE THE REQUIRED COORDINATION FOR THEIR TEMPORARY DISCONNECTION, PROTECTION, REMOVAL AND/OR STORAGE AS MAY BE REQUIRED DURING CONSTRUCTION. CONTRACTOR SHALL COORDINATE WITH THE DISTRICT TO DETERMINE WHETHER TEMPORARY SERVICES ARE NECESSARY.
3. THE CONTRACTOR SHALL VISIT THE SITE TO DETERMINE THE EXACT EXTENT AND DEPTH OF SITE DEMOLITION REQUIRED AND VERIFY COMPLIANCE WITH DRAWINGS. THE DISTRICT SHALL BE NOTIFIED IMMEDIATELY OF ANY DISCREPANCIES.
4. THE CONTRACTOR SHALL VERIFY THE LOCATIONS OF ALL EXISTING UTILITIES, STRUCTURES AND SERVICES BEFORE COMMENCING WORK. THE LOCATIONS OF UTILITIES, STRUCTURES AND SERVICES SHOWN IN THE CONTRACT DOCUMENTS SHALL BE DEEMED TO BE APPROXIMATIONS ONLY. ALL DISCREPANCIES BETWEEN WHAT IS SHOWN AND THE ACTUAL FIELD CONDITIONS SHALL BE REPORTED TO THE DISTRICT'S REPRESENTATIVE. THE CONTRACTOR SHALL CONTACT UNDERGROUND SERVICE ALERT (USA) AT (800) 222-2600 PRIOR TO ANY DEMOLITION OR EXCAVATION. UPON COMPLETION OF USA MARKING OPERATIONS, CONTRACTOR SHALL RECORD ALL UTILITY MARKINGS ON A SEPARATE SET OF DRAWINGS. THIS SET SHALL BE KEPT ON-SITE FOR REFERENCE FOR DURATION OF CONTRACT. NOTIFY THE DISTRICT'S REPRESENTATIVE IMMEDIATELY SHOULD CONFLICTS ARISE AND REDIRECT WORK TO AVOID DELAY.
5. ALL EXISTING ITEMS ARE TO REMAIN UNLESS OTHERWISE NOTED. THE CONTRACTOR SHALL BE RESPONSIBLE FOR REPAIRING OR REPLACING, AT CONTRACTOR'S EXPENSE, ANY EXISTING ITEM DAMAGED OR DESTROYED BY CONSTRUCTION OPERATIONS. CONTRACTOR SHALL ALSO BE RESPONSIBLE FOR REPAIRING OR REPLACING ANY AND ALL DAMAGES TO ADJACENT PROPERTIES. THE DAMAGED ITEMS SHALL BE RESTORED TO AN "AS-WAS" OR BETTER CONDITION OR REPLACED PER THE DISCRETION OF THE DISTRICT'S REPRESENTATIVE.
6. PRIOR TO ANY DEMOLITION WORK, CONTRACTOR SHALL INSTALL SELF-SUPPORTING INTERLOCKING CHAIN-LINK TEMPORARY CONSTRUCTION FENCING TO ENCLOSE AND SECURE THE PROJECT AREA LIMIT OF WORK. THE FENCING SHALL CONTAIN PEDESTRIAN AND/OR VEHICULAR ACCESS GATES AS NECESSARY AND SHALL BE MINIMUM 6 FEET HIGH WITH A TOP AND BOTTOM RAIL WITH KICKED TOP AND BOTTOM SERVAE (NO BARBED WIRE PERMITTED). SHALL INCLUDE FULL HEIGHT GREEN SHADE CLOTH COVERING. THE CONSTRUCTION FENCING WORK SHALL BE SUBJECT TO THE DISCRETION OF THE DISTRICT'S REPRESENTATIVE.
7. PRIOR TO ANY DEMOLITION WORK, CONTRACTOR SHALL PROTECT ALL EXISTING PLANT MATERIAL NOT SCHEDULED FOR REMOVAL BY INSTALLING TEMPORARY 4 FOOT HIGH "BLAZE ORANGE" CONSTRUCTION SAFETY FENCING AT THE EIR/LINE OR PERMETER. THE FENCING SHALL BE SECURED WITH DRIVEN METAL STAKES. ALL TREE PROTECTION WORK SHALL BE SUBJECT TO THE DISCRETION OF THE DISTRICT'S REPRESENTATIVE.
8. REFER TO SPECIFICATIONS FOR ADDITIONAL CLEARING, GRUBBING, TOPSOIL STOCKPILING AND OTHER PERTINENT INFORMATION.
9. CONTRACTOR TO FLUSH AND PERFORM A VIDEO INSPECTION OF ALL INSTALLED STORM WATER AND SANITARY SEWER PIPING WITHIN AREA OF WORK PRIOR TO START OF CONSTRUCTION AND AFTER COMPLETION. PROVIDE FLASH DRIVE TO DISTRICT FOR EACH SESSION.
10. SITE MAY CONTAIN UNDOCUMENTED STRUCTURES. CONTRACTOR SHALL NOTIFY DISTRICT REPRESENTATIVE UPON DISCOVERY PRIOR TO CONTINUING WORK.
11. CONTRACTOR IS RESPONSIBLE FOR THE CONTINUED IRRIGATION OF THE EXISTING VEGETATION TO REMAIN FOR THE DURATION OF CONSTRUCTION.


DEMOLITION LEGEND

SYM	DESCRIPTION
	LIMIT OF WORK
	KEY LEGEND CALLOUT - ITEMS TO BE DEMOLISHED AND REMOVED
	KEY LEGEND CALLOUT - ITEMS TO REMAIN AND BE PROTECTED
	EXISTING SURFACE VEGETATION TO BE REMOVED PER SPECIFICATIONS. REMOVE EXCESS SOIL FROM SITE AND DISPOSE IN LEGAL MANNER. REFER TO EARTHWORK SPECIFICATIONS FOR INFORMATION.
	DEMOLISH AND REMOVE EXISTING HARDSCAPE PAVING INCLUDING BASE MATERIAL AND DISPOSE IN LEGAL MANNER.
	TEMPORARY CONSTRUCTION FENCING
	LIMIT OF CLEAR AND GRUB
	DEMOLISH AND REMOVE EXISTING UTILITY LINE, AND/OR FENCE, INCLUDING POSTS, FABRIC, CURBS, EDGEBANDS AND FOOTINGS
	EXISTING TREE TO REMAIN AND BE PROTECTED, REFER TO SPECIFICATIONS


- ITEMS TO BE PROTECTED**
- A ELECTRICAL BOX, SERVICE CONDUIT AND LINES TO REMAIN AND BE PROTECTED. REFER TO ELECTRICAL PLANS FOR ADDITIONAL INFORMATION. BOXES LOCATED IN PAVEMENT SHALL BE ADJUSTED TO BE FLUSH WITH ADJACENT GRADES, REFER TO GRADING PLAN FOR ADDITIONAL INFORMATION. CONTRACTOR TO FIELD VERIFY AND CONFORM LID TYPES WITH DISTRICT'S REPRESENTATIVE.
 - B DRAINAGE STRUCTURE AND/OR DRAIN LINE TO REMAIN AND BE PROTECTED. REFER TO GRADING AND UTILITY PLAN FOR ADDITIONAL INFORMATION. REFER TO DRAINAGE PLAN FOR ADDITIONAL INFORMATION.
 - C WATER STRUCTURE AND/OR LINE TO REMAIN AND BE PROTECTED. REFER TO UTILITY PLAN FOR ADDITIONAL INFORMATION.
 - D SANITARY SEWER LINE AND/OR STRUCTURES TO REMAIN AND BE PROTECTED. REFER TO GRADING AND UTILITY PLAN FOR ADDITIONAL INFORMATION.
 - E FENCING AND/OR GATE, INCLUDING POSTS, FABRIC, AND EDGEBANDS/CURB TO REMAIN AND BE PROTECTED.
 - F HARDSCAPE PAVING TO REMAIN AND BE PROTECTED.
 - G CONCRETE V-SWALE TO REMAIN AND BE PROTECTED.
 - H IRRIGATION LINE/VALVE/QUICK COUPLER/BOX/EQUIPMENT. REFER TO IRRIGATION DEMOLITION AND IRRIGATION PLANS FOR ADDITIONAL INFORMATION.
 - I BASKETBALL BACKBOARD AND POLES TO REMAIN AND BE PROTECTED.
 - J STORAGE CONTAINERS TO BE RELOCATED PER THE DIRECTION OF THE DISTRICT.
 - K BOLLARD TO REMAIN AND BE PROTECTED.
 - L LANDSCAPE AREA TO REMAIN AND BE PROTECTED. CONTRACTOR SHALL BE RESPONSIBLE TO REPAIR ANY DAMAGED AREAS TO AS-WAS OR BETTER CONDITION AT NO ADDITIONAL COST TO THE DISTRICT.

- ITEMS TO BE DEMOLISHED**
- 1 FENCING AND/OR GATE, INCLUDING POSTS, FABRIC, AND EDGEBANDS/CURB, INCLUDING FOOTINGS, TO BE DEMOLISHED AND REMOVED IN A LEGAL MANNER.
 - 2 EXISTING IRRIGATION. REFER TO IRRIGATION DEMOLITION AND IRRIGATION PLANS FOR ADDITIONAL INFORMATION.
 - 3 BLEACHERS INCLUDING FOOTINGS AND PAD TO BE DEMOLISHED AND REMOVED IN A LEGAL MANNER.
 - 4 EXISTING BASEBALL AND SOFTBALL BASES/HOME PLATES TO BE REMOVED AND TURNED OVER TO THE DISTRICT.
 - 5 EXISTING BENCH TO BE REMOVED AND TURNED OVER TO THE DISTRICT.
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 - 7 DRAIN STRUCTURE AND/OR LINE TO BE DEMOLISHED AND REMOVED. ALL DRAIN LINES TO BE ABANDONED IF NOT CONSTRUCTING FUTURE IMPROVEMENTS. ALL LINES OBSTRUCTING FUTURE IMPROVEMENTS TO BE DEMOLISHED AND REMOVED. LINES NOT DEMOLISHED THAT ARE 2" AND LARGER TO BE SLURRY FILLED.
 - 8 EXISTING HARDSCAPE TO BE DEMOLISHED AND REMOVED IN A LEGAL MANNER.

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 Fax: 916.415.6525
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STAMP
 CONSULTANT
 KEYMAP

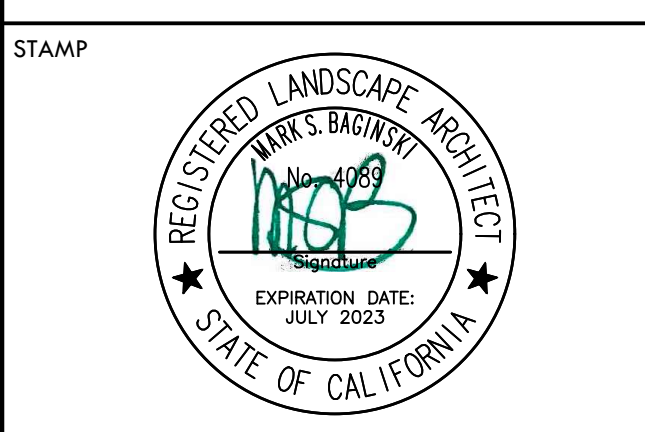

SHEET TITLE
DEMOLITION PLAN - BASEBALL FIELD

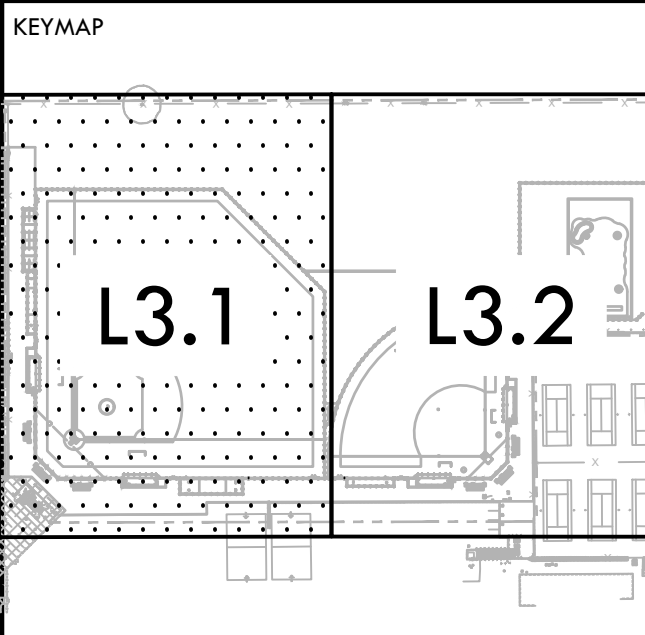PROJECT NAME
HIRAM JOHNSON HIGH SCHOOL GOLF PRACTICE FACILITY, VARSITY BASEBALL AND SOFTBALL FIELDS


PROJECT ADDRESS
6879 14TH AVENUE SACRAMENTO, CA 95820



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DD 50% SUBMITTAL	04/15/22
100% DSA SUBMITTAL	05/27/22
DSA BACK CHECK	08/11/22
DSA ADDENDUM SUBMITTAL	09/16/22

NO.	REVISIONS	DATE
1	ADDENDUM	09/16/22
2		
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DRAWN BY: JC
 CHECKED BY: MB/CS
 DATE ISSUED: 09/16/2022
 SCALE:
 PROJ. NO.: 2203200

SHEET NO.: **L3.1**



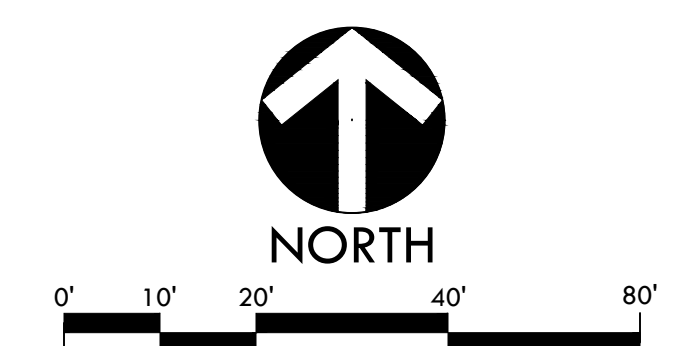

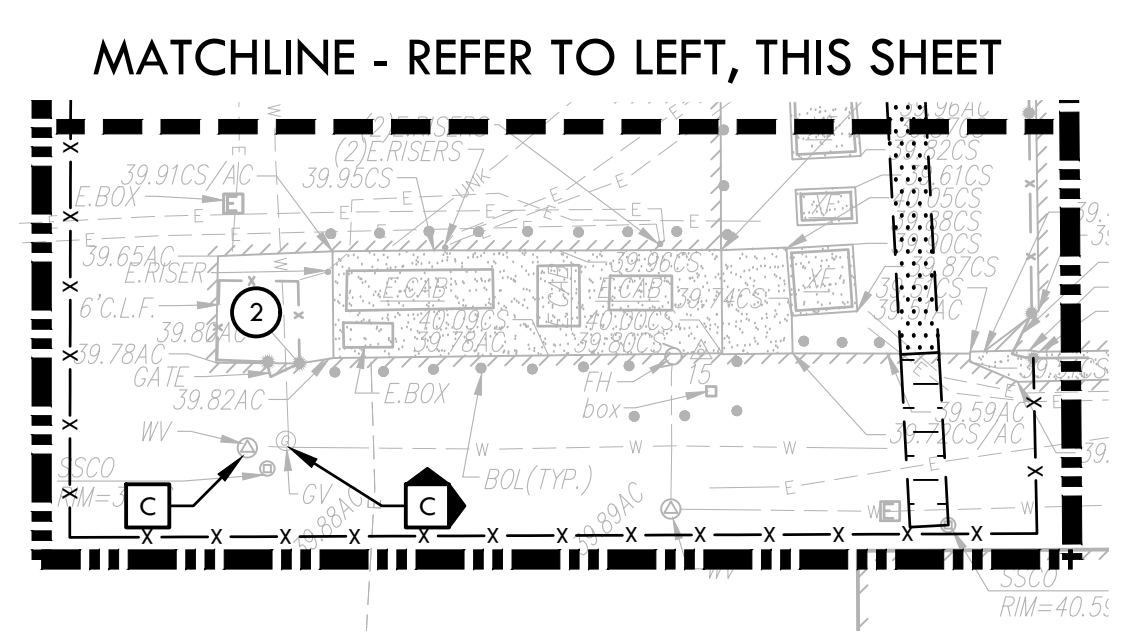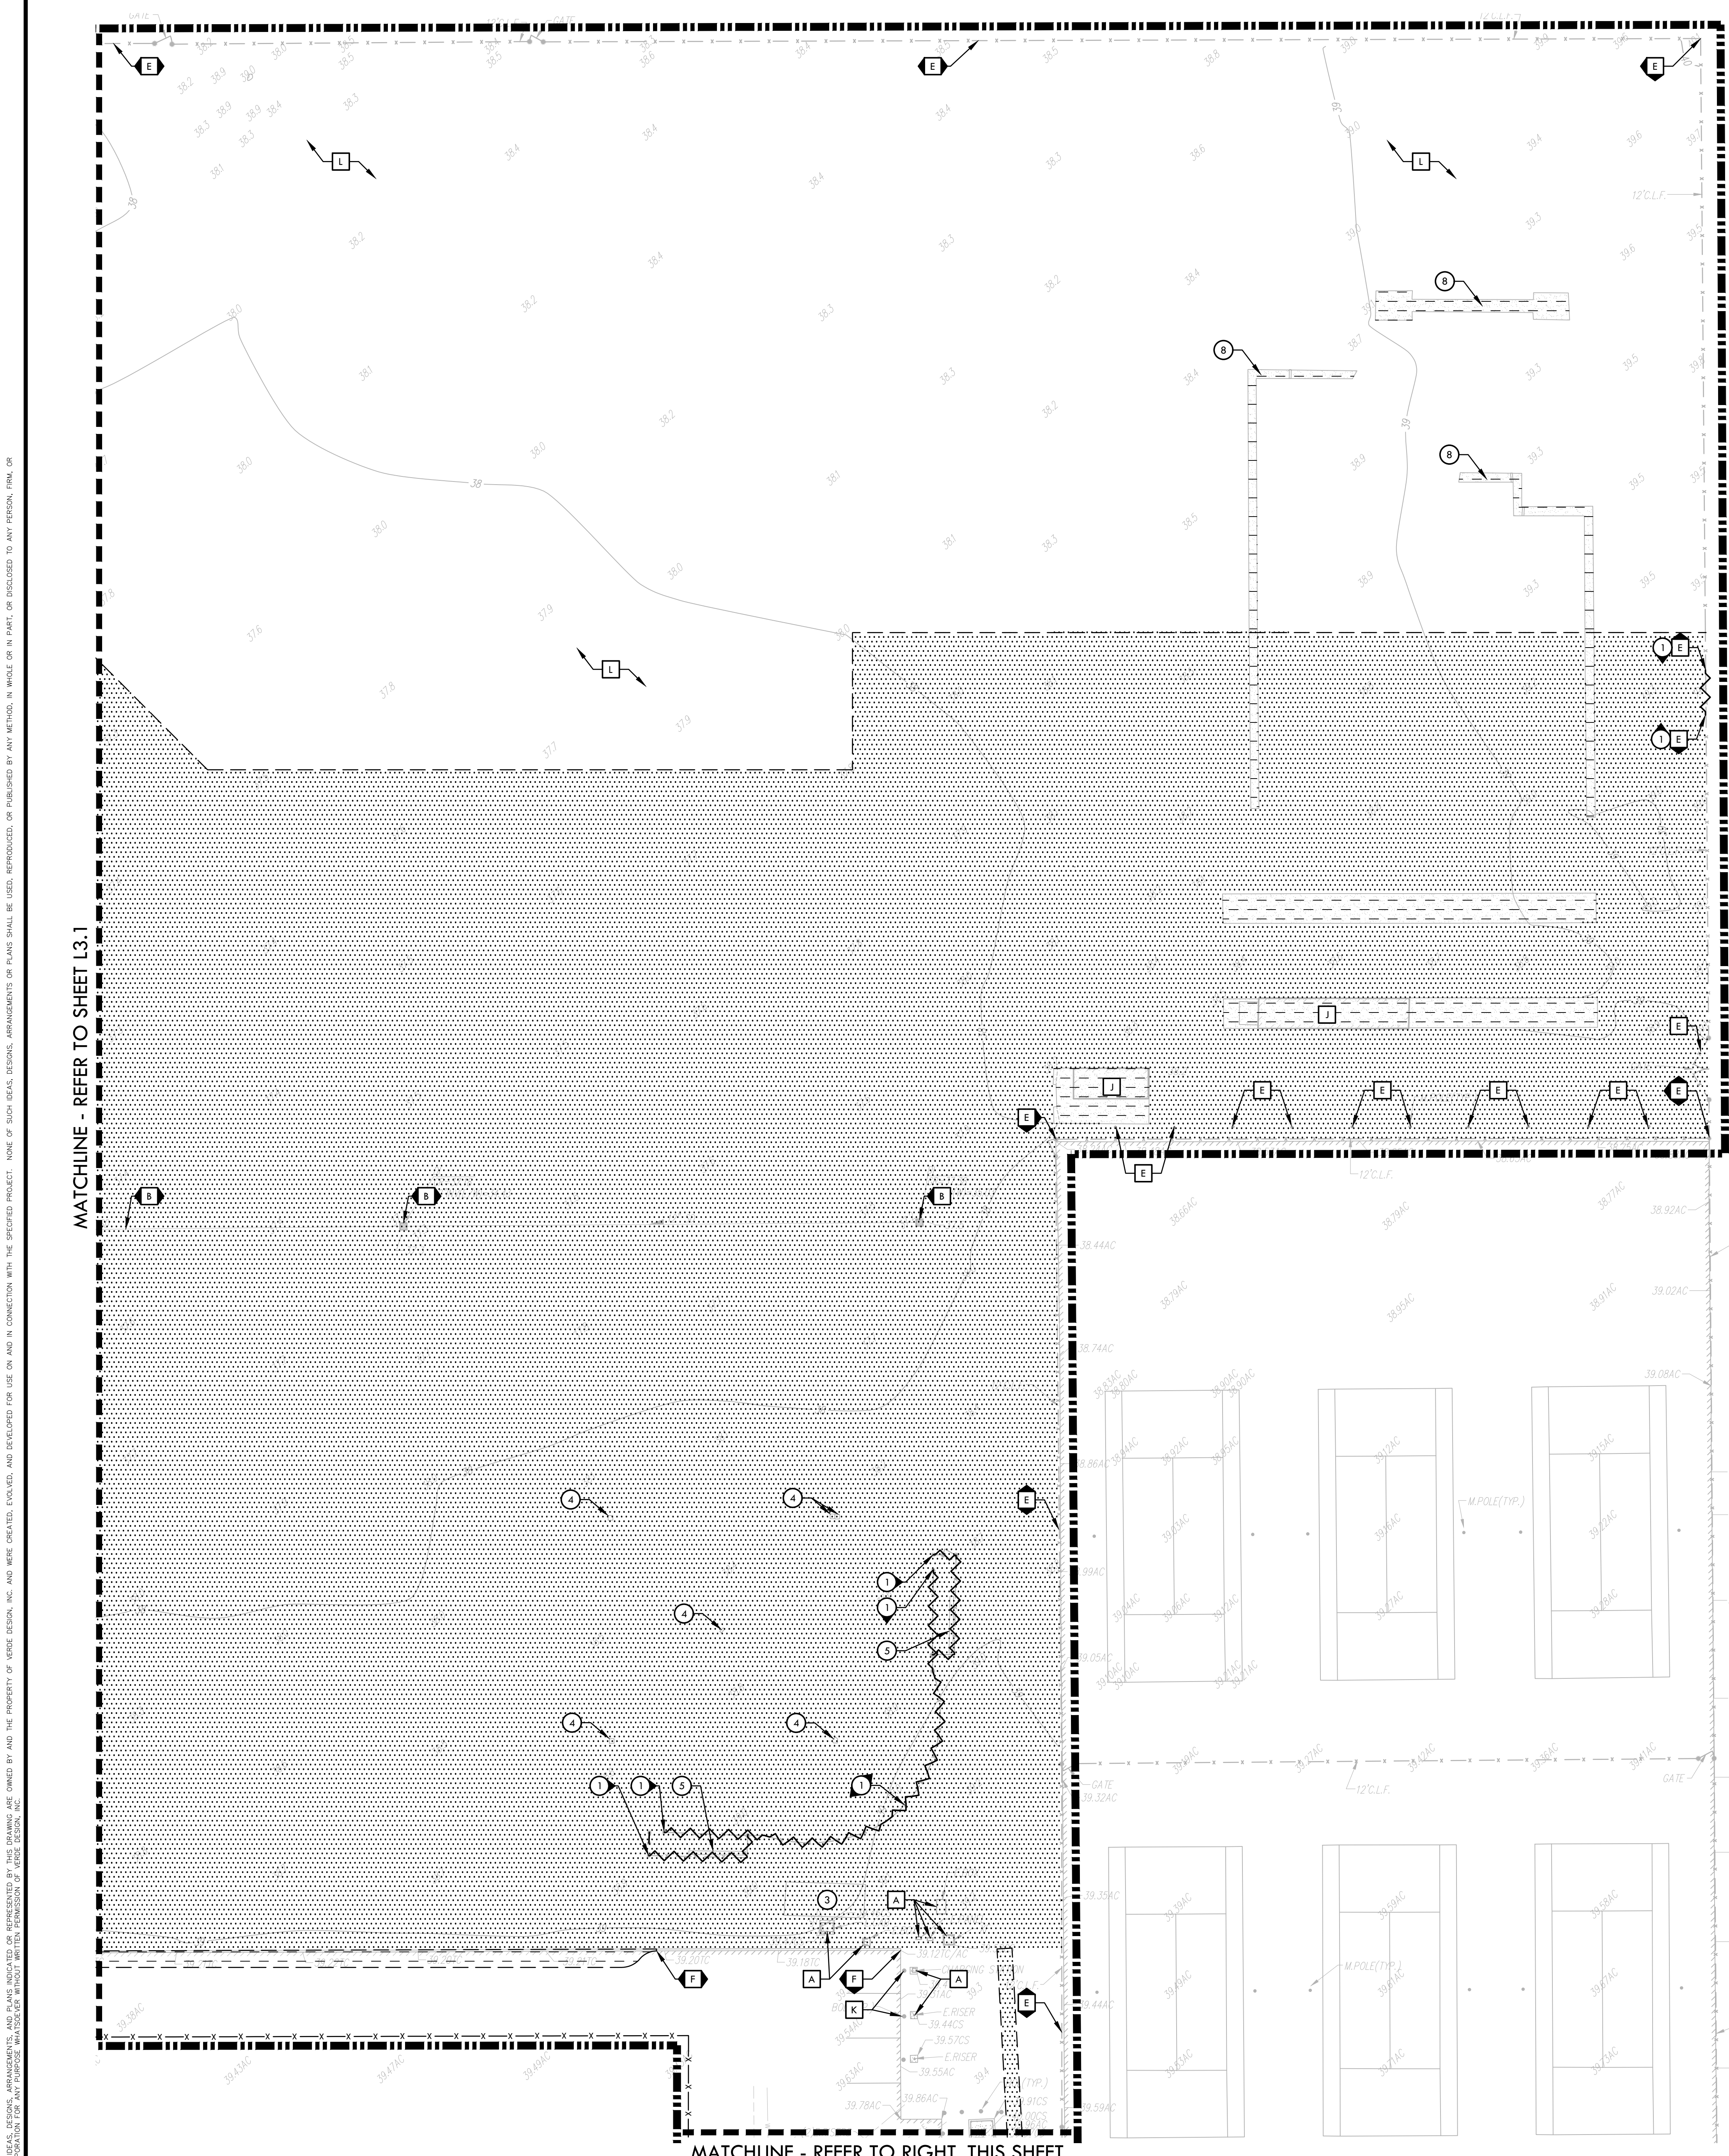DEMOLITION NOTES

1. THE CONTRACTOR SHALL PERFORM ALL CLEARING, DEMOLITION, REMOVAL OF OBSTRUCTIONS AND SITE PREPARATIONS NECESSARY FOR THE PROPER EXECUTION OF ALL WORK CONTAINED IN THE CONTRACT DOCUMENTS.
2. CONTRACTOR SHALL VERIFY LOCATION OF ALL EXISTING UTILITIES AND PROVIDE THE REQUIRED COORDINATION FOR THEIR TEMPORARY DISCONNECTION, PROTECTION, REMOVAL AND/OR STORAGE AS MAY BE REQUIRED DURING CONSTRUCTION. CONTRACTOR SHALL COORDINATE WITH THE DISTRICT TO DETERMINE WHETHER TEMPORARY SERVICES ARE NECESSARY.
3. THE CONTRACTOR SHALL VISIT THE SITE TO DETERMINE THE EXACT EXTENT AND DEPTH OF SITE DEMOLITION REQUIRED AND VERIFY COMPLIANCE WITH DRAWINGS. THE DISTRICT SHALL BE NOTIFIED IMMEDIATELY OF ANY DISCREPANCIES.
4. THE CONTRACTOR SHALL VERIFY THE LOCATIONS OF ALL EXISTING UTILITIES, STRUCTURES AND SERVICES BEFORE COMMENCING WORK. THE LOCATIONS OF UTILITIES, STRUCTURES AND SERVICES SHOWN IN THE CONTRACT DOCUMENTS SHALL BE DEEMED TO BE APPROXIMATIONS ONLY. ALL DISCREPANCIES BETWEEN WHAT IS SHOWN AND THE ACTUAL FIELD CONDITIONS SHALL BE REPORTED TO THE DISTRICT'S REPRESENTATIVE. THE CONTRACTOR SHALL CONTACT UNDERGROUND SERVICE ALERT (USA) AT (800) 222-2600 PRIOR TO ANY DEMOLITION OR EXCAVATION. UPON COMPLETION OF USA MARKING OPERATIONS, CONTRACTOR SHALL RECORD ALL UTILITY MARKINGS ON A SEPARATE SET OF DRAWINGS. THIS SET SHALL BE KEPT ON-SITE FOR REFERENCE FOR DURATION OF CONTRACT. NOTIFY THE DISTRICT'S REPRESENTATIVE IMMEDIATELY SHOULD CONFLICTS ARISE AND REDIRECT WORK TO AVOID DELAY.
5. ALL EXISTING ITEMS ARE TO REMAIN UNLESS OTHERWISE NOTED. THE CONTRACTOR SHALL BE RESPONSIBLE FOR REPAIRING OR REPLACING, AT CONTRACTOR'S EXPENSE, ANY EXISTING ITEM DAMAGED OR DESTROYED BY CONSTRUCTION OPERATIONS. CONTRACTOR SHALL ALSO BE RESPONSIBLE FOR REPAIRING OR REPLACING ANY AND ALL DAMAGES TO ADJACENT PROPERTIES. THE DAMAGED ITEMS SHALL BE RESTORED TO AN "AS-WAS" OR BETTER CONDITION OR REPLACED PER THE DISCRETION OF THE DISTRICT'S REPRESENTATIVE.
6. PRIOR TO ANY DEMOLITION WORK, CONTRACTOR SHALL INSTALL SELF-SUPPORTING INTERLOCKING CHAIN-LINK TEMPORARY CONSTRUCTION FENCING TO ENCLOSE AND SECURE THE PROJECT AREA LIMIT OF WORK. THE FENCING SHALL CONTAIN PEDESTRIAN AND/OR VEHICULAR ACCESS GATES AS NECESSARY AND SHALL BE MINIMUM 6 FEET HIGH WITH A TOP AND BOTTOM RAIL WITH KICKLED TOP AND BOTTOM SERVICE (NO BARBED WIRE PERMITTED). SHALL INCLUDE FULL HEIGHT GREEN SHADE CLOTH COVERING. THE CONSTRUCTION FENCING WORK SHALL BE SUBJECT TO THE DISCRETION OF THE DISTRICT'S REPRESENTATIVE.
7. PRIOR TO ANY DEMOLITION WORK, CONTRACTOR SHALL PROTECT ALL EXISTING PLANT MATERIAL NOT SCHEDULED FOR REMOVAL BY INSTALLING TEMPORARY 4 FOOT HIGH "BLAZE ORANGE" CONSTRUCTION SAFETY FENCING AT THE ENDLINE OR PERIMETER. THE FENCING SHALL BE SECURED WITH DRIVEN METAL STAKES. ALL TREE PROTECTION WORK SHALL BE SUBJECT TO THE DISCRETION OF THE DISTRICT'S REPRESENTATIVE.
8. REFER TO SPECIFICATIONS FOR ADDITIONAL CLEARING, GRUBBING, TOPSOIL STOCKPILING AND OTHER PERTINENT INFORMATION.
9. CONTRACTOR TO FLUSH AND PERFORM A VIDEO INSPECTION OF ALL INSTALLED STORM WATER AND SANITARY SEWER PIPING WITHIN AREA OF WORK PRIOR TO START OF CONSTRUCTION AND AFTER COMPLETION. PROVIDE FLASH DRIVE TO DISTRICT FOR EACH SESSION.
10. SITE MAY CONTAIN UNDOCUMENTED STRUCTURES. CONTRACTOR SHALL NOTIFY DISTRICT REPRESENTATIVE UPON DISCOVERY PRIOR TO CONTINUING WORK.
11. CONTRACTOR IS RESPONSIBLE FOR THE CONTINUED IRRIGATION OF THE EXISTING VEGETATION TO REMAIN FOR THE DURATION OF CONSTRUCTION.

DEMOLITION LEGEND

SYM	DESCRIPTION
	LIMIT OF WORK
	KEY LEGEND CALLOUT - ITEMS TO BE DEMOLISHED AND REMOVED
	KEY LEGEND CALLOUT - ITEMS TO REMAIN AND BE PROTECTED
	EXISTING SURFACE VEGETATION TO BE REMOVED PER SPECIFICATIONS. REMOVE EXCESS SOIL FROM SITE AND DISPOSE IN LEGAL MANNER. REFER TO EARTHWORK SPECIFICATIONS FOR INFORMATION.
	DEMOLISH AND REMOVE EXISTING HARDSCAPE PAVING INCLUDING BASE MATERIAL AND DISPOSE IN LEGAL MANNER.
	TEMPORARY CONSTRUCTION FENCING
	LIMIT OF CLEAR AND GRUB
	DEMOLISH AND REMOVE EXISTING UTILITY LINE, AND/OR FENCE, INCLUDING POSTS, FABRIC, CURBS, EDGEBANDS AND FOOTINGS
	EXISTING TREE TO REMAIN AND BE PROTECTED, REFER TO SPECIFICATIONS

ITEMS TO BE PROTECTED


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- J STORAGE CONTAINERS TO BE RELOCATED PER THE DIRECTION OF THE DISTRICT.
- K BOLLARD TO REMAIN AND BE PROTECTED.
- L LANDSCAPE AREA TO REMAIN AND BE PROTECTED. CONTRACTOR SHALL BE RESPONSIBLE TO REPAIR ANY DAMAGED AREAS TO AS-WAS OR BETTER CONDITION AT NO ADDITIONAL COST TO THE DISTRICT.

ITEMS TO BE DEMOLISHED

- 1 FENCING AND/OR GATE, INCLUDING POSTS, FABRIC, AND EDGEBANDS/CURB, INCLUDING FOOTINGS, TO BE DEMOLISHED AND REMOVED IN A LEGAL MANNER.
- 2 EXISTING IRRIGATION. REFER TO IRRIGATION DEMOLITION AND IRRIGATION PLANS FOR ADDITIONAL INFORMATION.
- 3 BLEACHERS INCLUDING FOOTINGS AND PAD TO BE DEMOLISHED AND REMOVED IN A LEGAL MANNER.
- 4 EXISTING BASEBALL AND SOFTBALL BASES/HOME PLATES TO BE REMOVED AND TURNED OVER TO THE DISTRICT.
- 5 EXISTING BENCH TO BE REMOVED AND TURNED OVER TO THE DISTRICT.
- 6 EXISTING BASEBALL AND/OR SOFTBALL FOUL POLE/EQUIPMENT, INCLUDING FOOTINGS, TO BE DEMOLISHED AND REMOVED IN A LEGAL MANNER.
- 7 DRAIN STRUCTURE AND/OR LINE TO BE DEMOLISHED AND REMOVED. ALL DRAIN LINES TO BE ABANDONED. IF NOT IMPROVEMENTS. ALL LINES OBSTRUCTING FUTURE IMPROVEMENTS TO BE DEMOLISHED AND REMOVED. LINES NOT DEMOLISHED THAT ARE 2" AND LARGER TO BE SLURRY FILLED.
- 8 EXISTING HARDSCAPE TO BE DEMOLISHED AND REMOVED IN A LEGAL MANNER.

NORTH


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Folsom, CA 95630
Tel: 916.411.5654
Fax: 916.411.56525
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STAMP

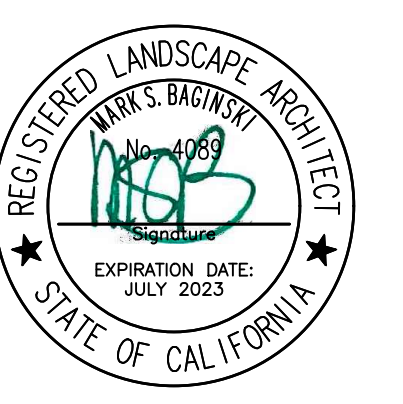CONSULTANT

KEYMAP



SHEET TITLE

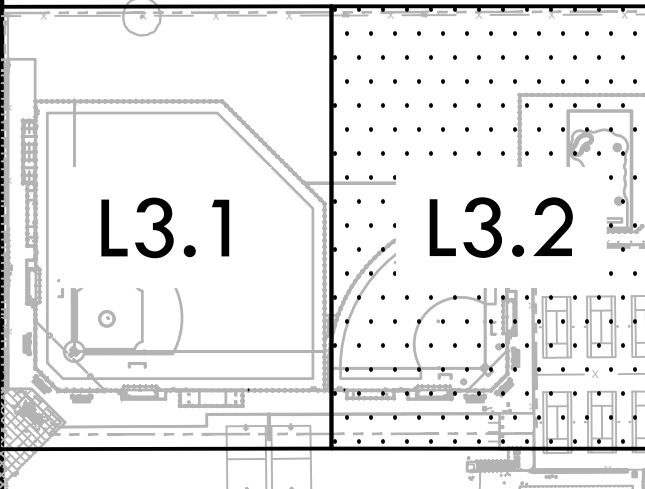**DEMOLITION
PLAN -
SOFTBALL FIELD AND
GOLF**

PROJECT NAME

**HIRAM JOHNSON
HIGH SCHOOL
GOLF PRACTICE FACILITY,
VARSITY BASEBALL AND
SOFTBALL FIELDS**

PROJECT ADDRESS

**6879 14TH AVENUE
SACRAMENTO, CA 95820**


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DD 50% SUBMITTAL	04/15/22
100% DSA SUBMITTAL	05/27/22
DSA BACK CHECK	08/11/22
DSA ADDENDUM SUBMITTAL	09/16/22

NO.	REVISIONS	DATE
▲	ADDENDUM	09/16/22
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DRAWN BY	JC	CHECKED BY	MB/CS
DATE ISSUED	09/16/2022	SCALE	
PROJ. NO.	2203200	SHEET NO.	L3.2

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IRRIGATION DEMOLITION NOTES

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- CONTRACTOR TO NOTE THAT THE LATERAL LINES CONNECTING THESE ZONES ARE NOT SHOWN AND THESE LATERAL LINES ARE ALSO TO BE DEMOLISHED AND REMOVED.
- CONTRACTOR SHALL REFER TO DETAILS AND SPECIFICATIONS FOR ADDITIONAL INFORMATION.
- IRRIGATION LAYOUT IS BASED ON AS BUILTS. CONTRACTOR IS RESPONSIBLE TO VERIFY IRRIGATION ZONES PRIOR TO START OF DEMOLITION.

IRRIGATION DEMOLITION LEGEND

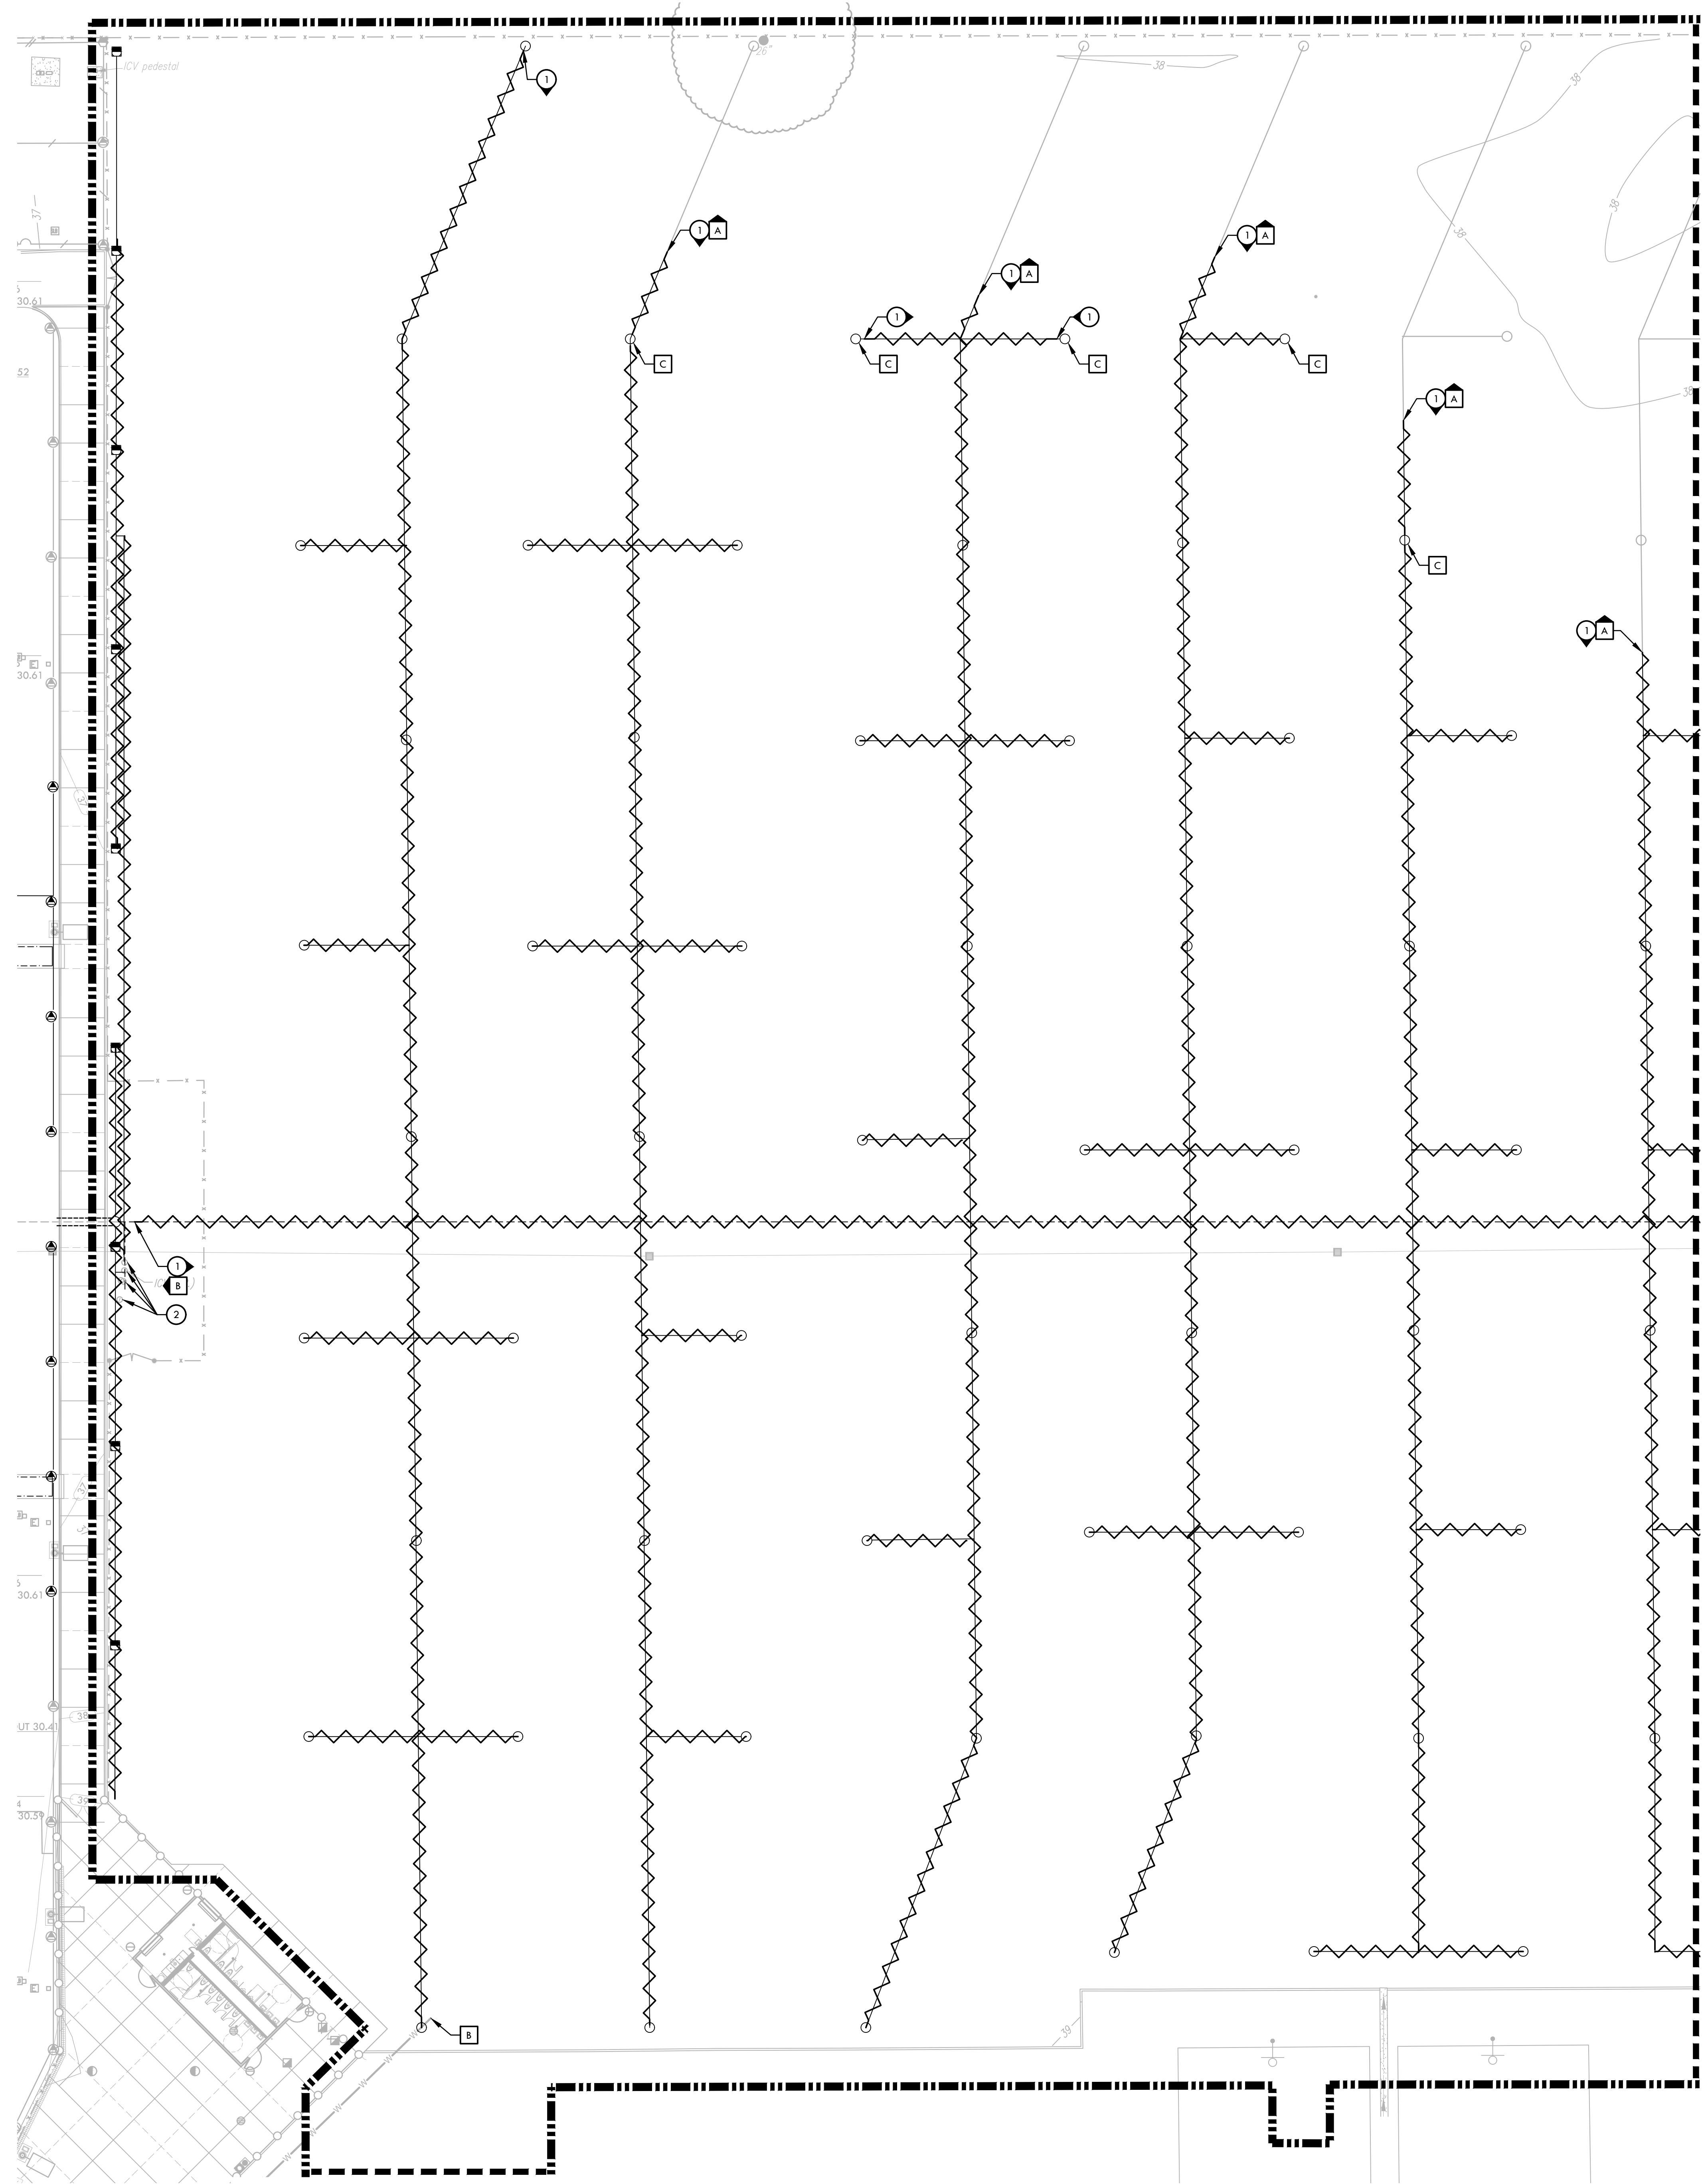
DESCRIPTION	SYMBOL
LIMIT OF WORK	--- --
IRRIGATION VALVE, GATE/BALL VALVE OR QUICK COUPLER TO REMAIN	⊕
IRRIGATION VALVE, GATE/BALL VALVE OR QUICK COUPLER TO BE REMOVED OR RELOCATED. REFER TO PLANS FOR ADDITIONAL INFORMATION.	⊕
ROTORS OR SPRAY HEADS TO REMAIN AND BE PROTECTED.	○
ROTORS OR SPRAY HEADS TO BE REMOVED AND RETURNED TO THE DISTRICT.	○
MAIN LINE TO REMAIN AND BE PROTECTED.	—
IRRIGATION MAIN LINE TO BE DEMOLISHED AND REMOVED. CONTRACTOR MAY NEED TO INSTALL LOOP FIRST TO ENSURE IRRIGATION SYSTEM REMAINS OPERABLE DURING CONSTRUCTION.	~
LATERAL LINE TO REMAIN AND BE PROTECTED.	—
LATERAL LINE TO BE REMOVED.	~

IRRIGATION DEMOLITION ITEMS

- ITEMS TO BE DEMOLISHED AND/OR REMOVED**
- EXISTING IRRIGATION LATERAL LINE, MAIN LINE AND HEADS SHOWN FOR REFERENCE ONLY. CONTRACTOR SHALL BE RESPONSIBLE TO FIELD VERIFY LOCATION. CONTRACTOR TO CUT IRRIGATION LATERAL LINE OR MAIN LINE AT APPROXIMATE LOCATION SHOWN.
 - EXISTING IRRIGATION CONTROL VALVE TO BE FIELD VERIFIED BEFORE DEMOLITION. CONTRACTOR TO RELOCATE VALVE AND REUSE FOR EXISTING IRRIGATION SYSTEM LOCATED NORTH OF IMPROVEMENTS. WIRE VALVES TO NEW CONTROLLER.
EXISTING IRRIGATION POINT OF CONNECTION ENCLOSURE. CONTRACTOR TO FIELD VERIFY LANDSCAPE AREAS BEING OPERATED BY THE CONTROLLER AND IRRIGATION BOOSTER PUMP. EXISTING IRRIGATION BOOSTER PUMP TO BE CAPPED AND ABANDONED WITHIN ENCLOSURE. CONTRACTOR SHALL BE RESPONSIBLE TO FIELD VERIFY AND TRACE EXISTING IRRIGATION MAIN LINE ROUTE AND CONNECT TO NEW MAIN LINE. COORDINATE WITH DISTRICT FOR EXISTING IRRIGATION CONTROLLER TO BE ABANDONED IN PLACE FOR STATIONS LOCATED OUTSIDE OF IMPROVEMENTS. CONTRACTOR SHALL BE RESPONSIBLE TO CONNECT VALVES TO NEW CONTROLLER.
- ITEMS TO BE PROTECTED OR RELOCATED**
- EXISTING IRRIGATION LATERAL LINE TO REMAIN AND BE PROTECTED. CONTRACTOR SHALL BE RESPONSIBLE TO CONNECT ZONE TO MAIN LINE, IRRIGATION CONTROLLER AND ENSURE HEAD-TO-HEAD COVERAGE IS ACHIEVED WITHIN ZONE INCLUDING BUT NOT LIMITED TO EXTENDING NEW LATERAL LINE, ADDING ADDITIONAL HEADS OR RELOCATING HEADS.
 - EXISTING IRRIGATION MAIN LINE TO REMAIN AND BE PROTECTED. CONNECT AND EXTEND NEW MAIN LINE AS SHOWN ON IRRIGATION PLANS.
 - EXISTING IRRIGATION ROTOR TO BE ADJUSTED/RELOCATED TO ACHIEVE HEAD-TO-HEAD COVERAGE. CONTRACTOR SHALL BE RESPONSIBLE TO ADJUST EXISTING ROTOR INCLUDING BUT NOT LIMITED TO ADJUSTING SPRAY PATTERN, RELOCATING HEAD AND EXTENDING LATERAL LINE.


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 www.VerdeDesign.com

STAMP



CONSULTANT

KEYMAP



SHEET TITLE

IRRIGATION DEMOLITION PLAN - BASEBALL FIELD

PROJECT NAME

HIRAM JOHNSON HIGH SCHOOL GOLF PRACTICE FACILITY, VARSITY BASEBALL AND SOFTBALL FIELDS

PROJECT ADDRESS

**6879 14TH AVENUE
SACRAMENTO, CA 95820**

SUBMITTAL	DATE
DD 50% SUBMITTAL	04/15/22
100% DSA SUBMITTAL	05/27/22
DSA BACK CHECK	08/11/22
DSA ADDENDUM SUBMITTAL	09/16/22

NO.	REVISIONS	DATE
△	ADDENDUM	09/16/22
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DRAWN BY: JC CHECKED BY: MB/CS



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PROJ. NO.: 2203200

SHEET NO.: **L3.3**

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 PLOT DATE: 09-15-22 PLOTTED BY: station27



IRRIGATION DEMOLITION NOTES

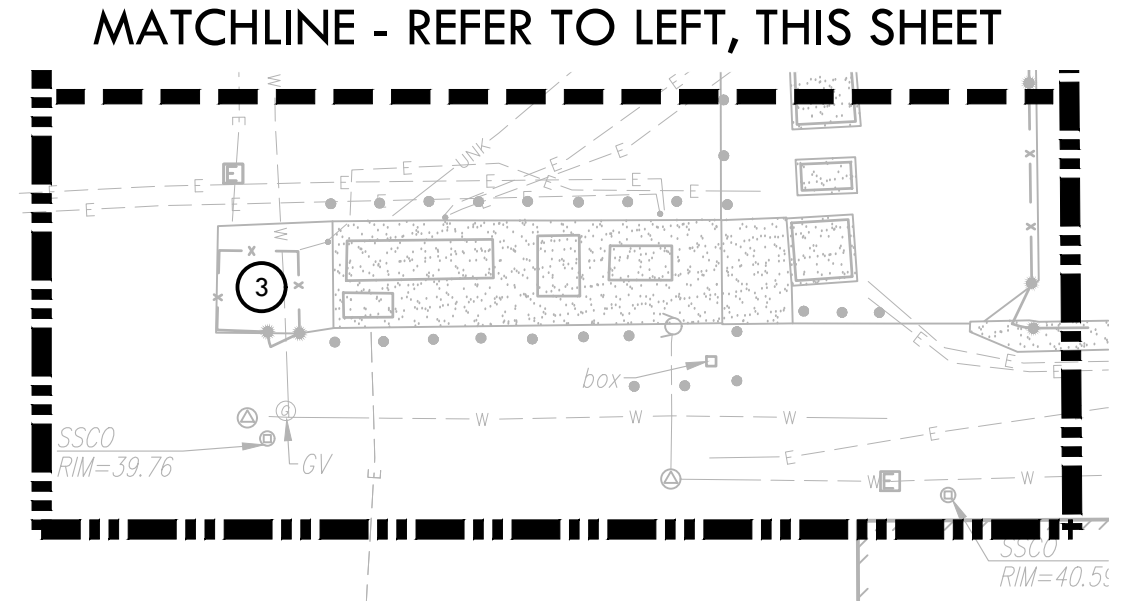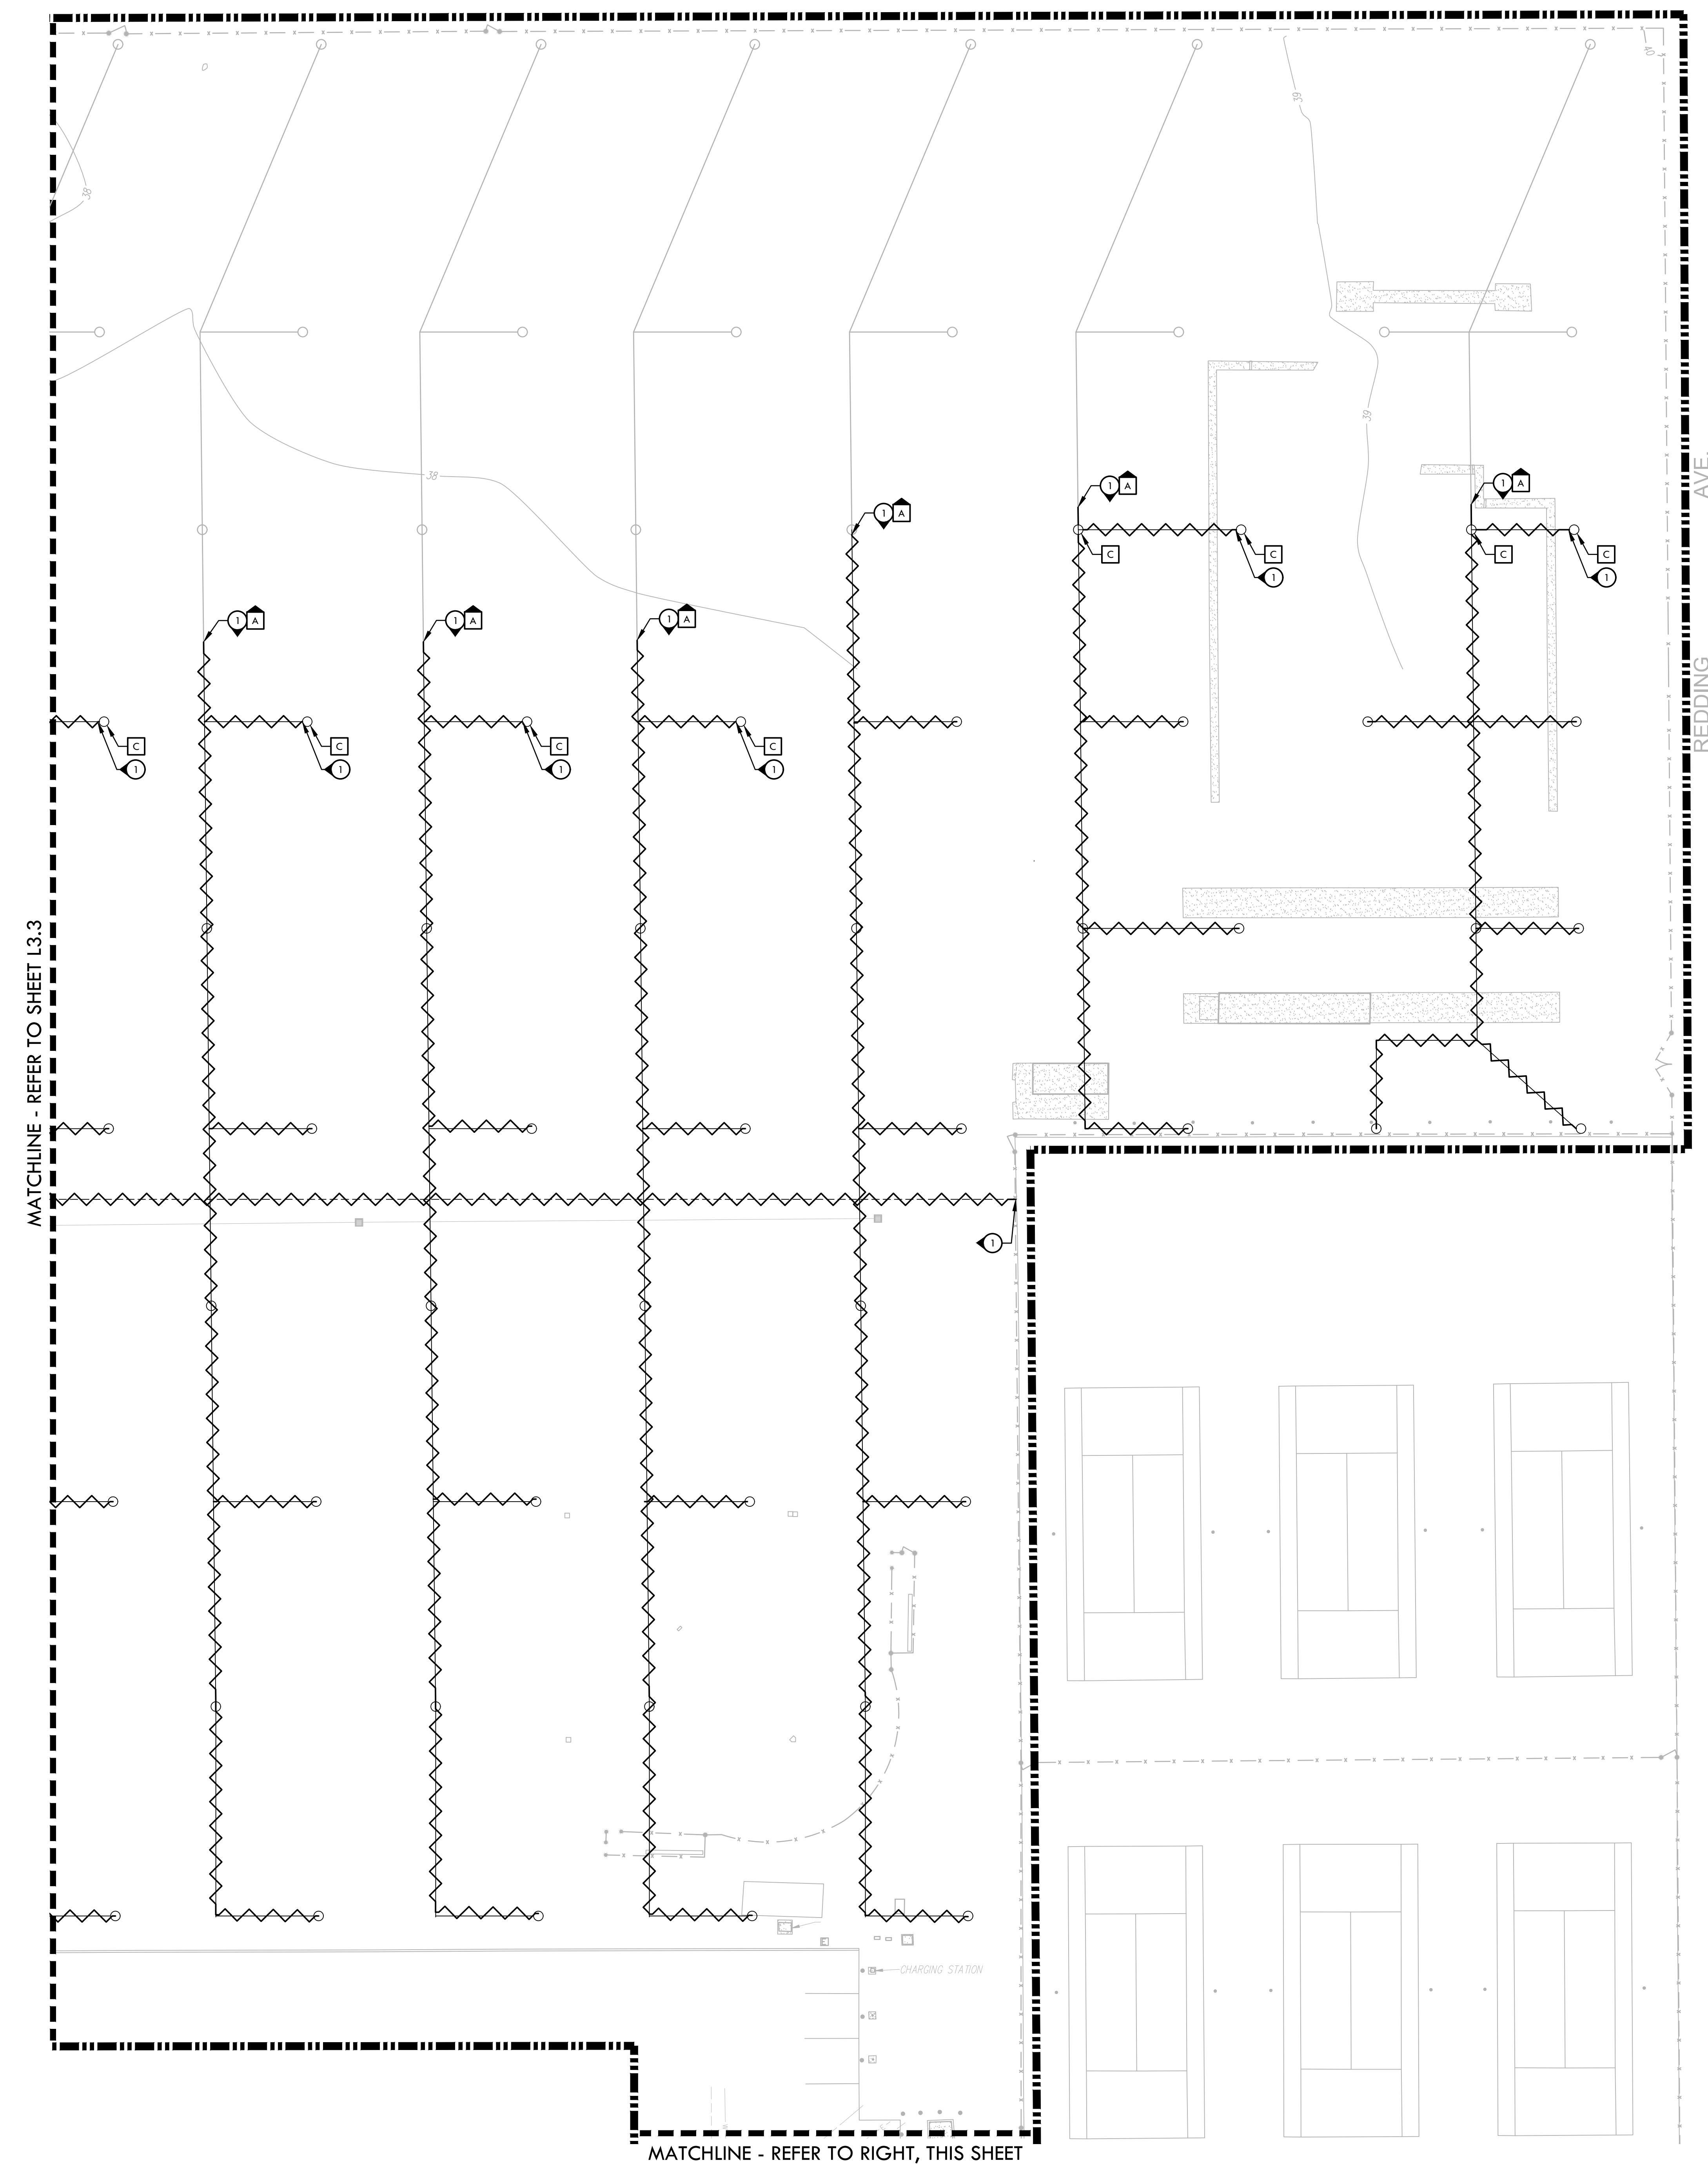- THIS PLAN IS FOR REFERENCE ONLY AND DOES NOT NECESSARILY REPRESENT WHAT WAS INSTALLED OR WHAT MAY EXIST AT THIS TIME. SYSTEM COMPONENTS, MANUFACTURER, MODEL NO'S, LOCATION, SIZE AND DEPTH ARE TO BE DETERMINED BY THE CONTRACTOR PRIOR TO COMMENCING ANY CONSTRUCTION WORK. ANY DAMAGE TO THE EXISTING SYSTEM TO REMAIN OR ADDITIONAL WORK INCURRED DUE TO DISCREPANCIES BETWEEN THIS SHEET AND EXISTING CONDITIONS WILL BE THE RESPONSIBILITY OF THE CONTRACTOR. THERE WILL BE NO CHANGE ORDERS APPROVED DUE TO THE LACK OF THE CONTRACTOR'S SITE INVESTIGATION, LOGGING OF PERTINENT INFORMATION, AND MOVING FORWARD WITHOUT DETERMINING THE CORRECT DISPOSITION OF THE EXISTING IRRIGATION SYSTEM.
- CONTRACTOR TO NOTE THAT THE LATERAL LINES CONNECTING THESE ZONES ARE NOT SHOWN AND THESE LATERAL LINES ARE ALSO TO BE DEMOLISHED AND REMOVED.
- CONTRACTOR SHALL REFER TO DETAILS AND SPECIFICATIONS FOR ADDITIONAL INFORMATION.
- IRRIGATION LAYOUT IS BASED ON AS BUILTS. CONTRACTOR IS RESPONSIBLE TO VERIFY IRRIGATION ZONES PRIOR TO START OF DEMOLITION.

IRRIGATION DEMOLITION LEGEND

SYMBOL	DESCRIPTION
--- (dashed line)	LIMIT OF WORK
⊕	IRRIGATION VALVE, GATE/BALL VALVE OR QUICK COUPLER TO REMAIN
⊕ (with circle)	IRRIGATION VALVE, GATE/BALL VALVE OR QUICK COUPLER TO BE REMOVED OR RELOCATED. REFER TO PLANS FOR ADDITIONAL INFORMATION.
○	ROTORS OR SPRAY HEADS TO REMAIN AND BE PROTECTED.
○ (with circle)	ROTORS OR SPRAY HEADS TO BE REMOVED AND RETURNED TO THE DISTRICT.
---	MAIN LINE TO REMAIN AND BE PROTECTED.
--- (with circle)	IRRIGATION MAIN LINE TO BE DEMOLISHED AND REMOVED. CONTRACTOR MAY NEED TO INSTALL LOOP FIRST TO ENSURE IRRIGATION SYSTEM REMAINS OPERABLE DURING CONSTRUCTION.
---	LATERAL LINE TO REMAIN AND BE PROTECTED.
---	LATERAL LINE TO BE REMOVED.

IRRIGATION DEMOLITION ITEMS

- ITEMS TO BE DEMOLISHED AND/OR REMOVED**
- EXISTING IRRIGATION LATERAL LINE, MAIN LINE AND HEADS SHOWN FOR REFERENCE ONLY. CONTRACTOR SHALL BE RESPONSIBLE TO FIELD VERIFY LOCATION. CONTRACTOR TO CUT IRRIGATION LATERAL LINE OR MAIN LINE AT APPROXIMATE LOCATION SHOWN.
 - EXISTING IRRIGATION CONTROL VALVE TO BE FIELD VERIFIED BEFORE DEMOLITION. CONTRACTOR TO RELOCATE VALVE AND REUSE FOR EXISTING IRRIGATION SYSTEM LOCATED NORTH OF IMPROVEMENTS. WIRE VALVES TO NEW CONTROLLER.
- EXISTING IRRIGATION POINT OF CONNECTION ENCLOSURE.**
 CONTRACTOR TO FIELD VERIFY LANDSCAPE AREAS BEING OPERATED BY THE CONTROLLER AND IRRIGATION BOOSTER PUMP. EXISTING IRRIGATION BOOSTER PUMP TO BE CAPED AND ABANDONED WITHIN ENCLOSURE. CONTRACTOR SHALL BE RESPONSIBLE TO FIELD VERIFY AND TRACE EXISTING IRRIGATION MAIN LINE ROUTE AND CONNECT TO NEW MAIN LINE. COORDINATE WITH DISTRICT FOR EXISTING IRRIGATION CONTROLLER TO BE ABANDONED IN PLACE FOR STATIONS LOCATED OUTSIDE OF IMPROVEMENTS. CONTRACTOR SHALL BE RESPONSIBLE TO CONNECT VALVES TO NEW CONTROLLER.
- ITEMS TO BE PROTECTED OR RELOCATED**
- EXISTING IRRIGATION LATERAL LINE TO REMAIN AND BE PROTECTED. CONTRACTOR SHALL BE RESPONSIBLE TO CONNECT ZONE TO MAIN LINE, IRRIGATION CONTROLLER AND ENSURE HEAD-TO-HEAD COVERAGE IS ACHIEVED WITHIN ZONE INCLUDING BUT NOT LIMITED TO EXTENDING NEW LATERAL LINE, ADDING ADDITIONAL HEADS OR RELOCATING HEADS.
 - EXISTING IRRIGATION MAIN LINE TO REMAIN AND BE PROTECTED. CONNECT AND EXTEND NEW MAIN LINE AS SHOWN ON IRRIGATION PLANS.
 - EXISTING IRRIGATION ROTOR TO BE ADJUSTED/RELOCATED TO ACHIEVE HEAD-TO-HEAD COVERAGE. CONTRACTOR SHALL BE RESPONSIBLE TO ADJUST EXISTING ROTOR INCLUDING BUT NOT LIMITED TO ADJUSTING SPRAY PATTERN, RELOCATING HEAD AND EXTENDING LATERAL LINE.

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CONSULTANT

KEYMAP

SHEET TITLE

IRRIGATION DEMOLITION PLAN - SOFTBALL FIELD AND GOLF

PROJECT NAME

HIRAM JOHNSON HIGH SCHOOL GOLF PRACTICE FACILITY, VARSITY BASEBALL AND SOFTBALL FIELDS

PROJECT ADDRESS

**6879 14TH AVENUE
SACRAMENTO, CA 95820**


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DSA ADDENDUM SUBMITTAL	09/16/22



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DRAWN BY: JC
 CHECKED BY: MB/CS

DATE ISSUED: 09/16/2022
 SCALE: 1" = 20'-0"

PROJ. NO.: 2203200
 SHEET NO.: **L3.4**



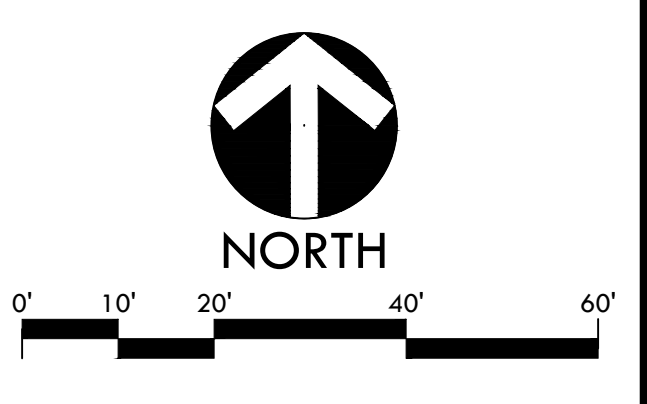

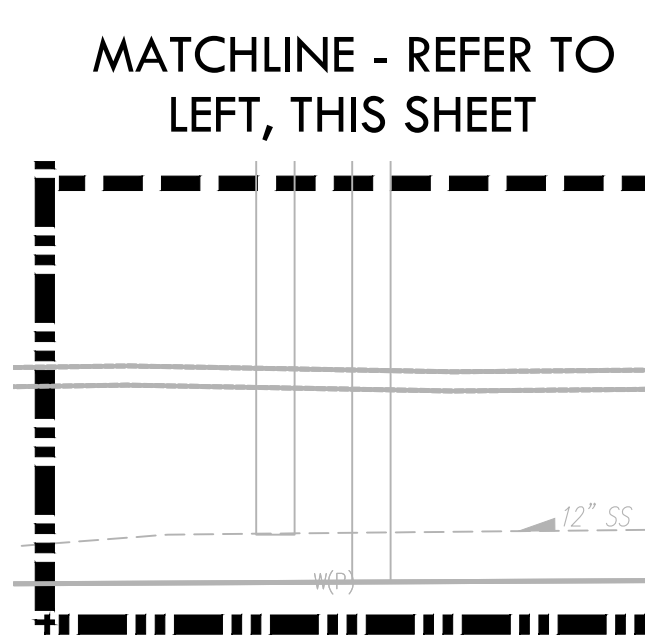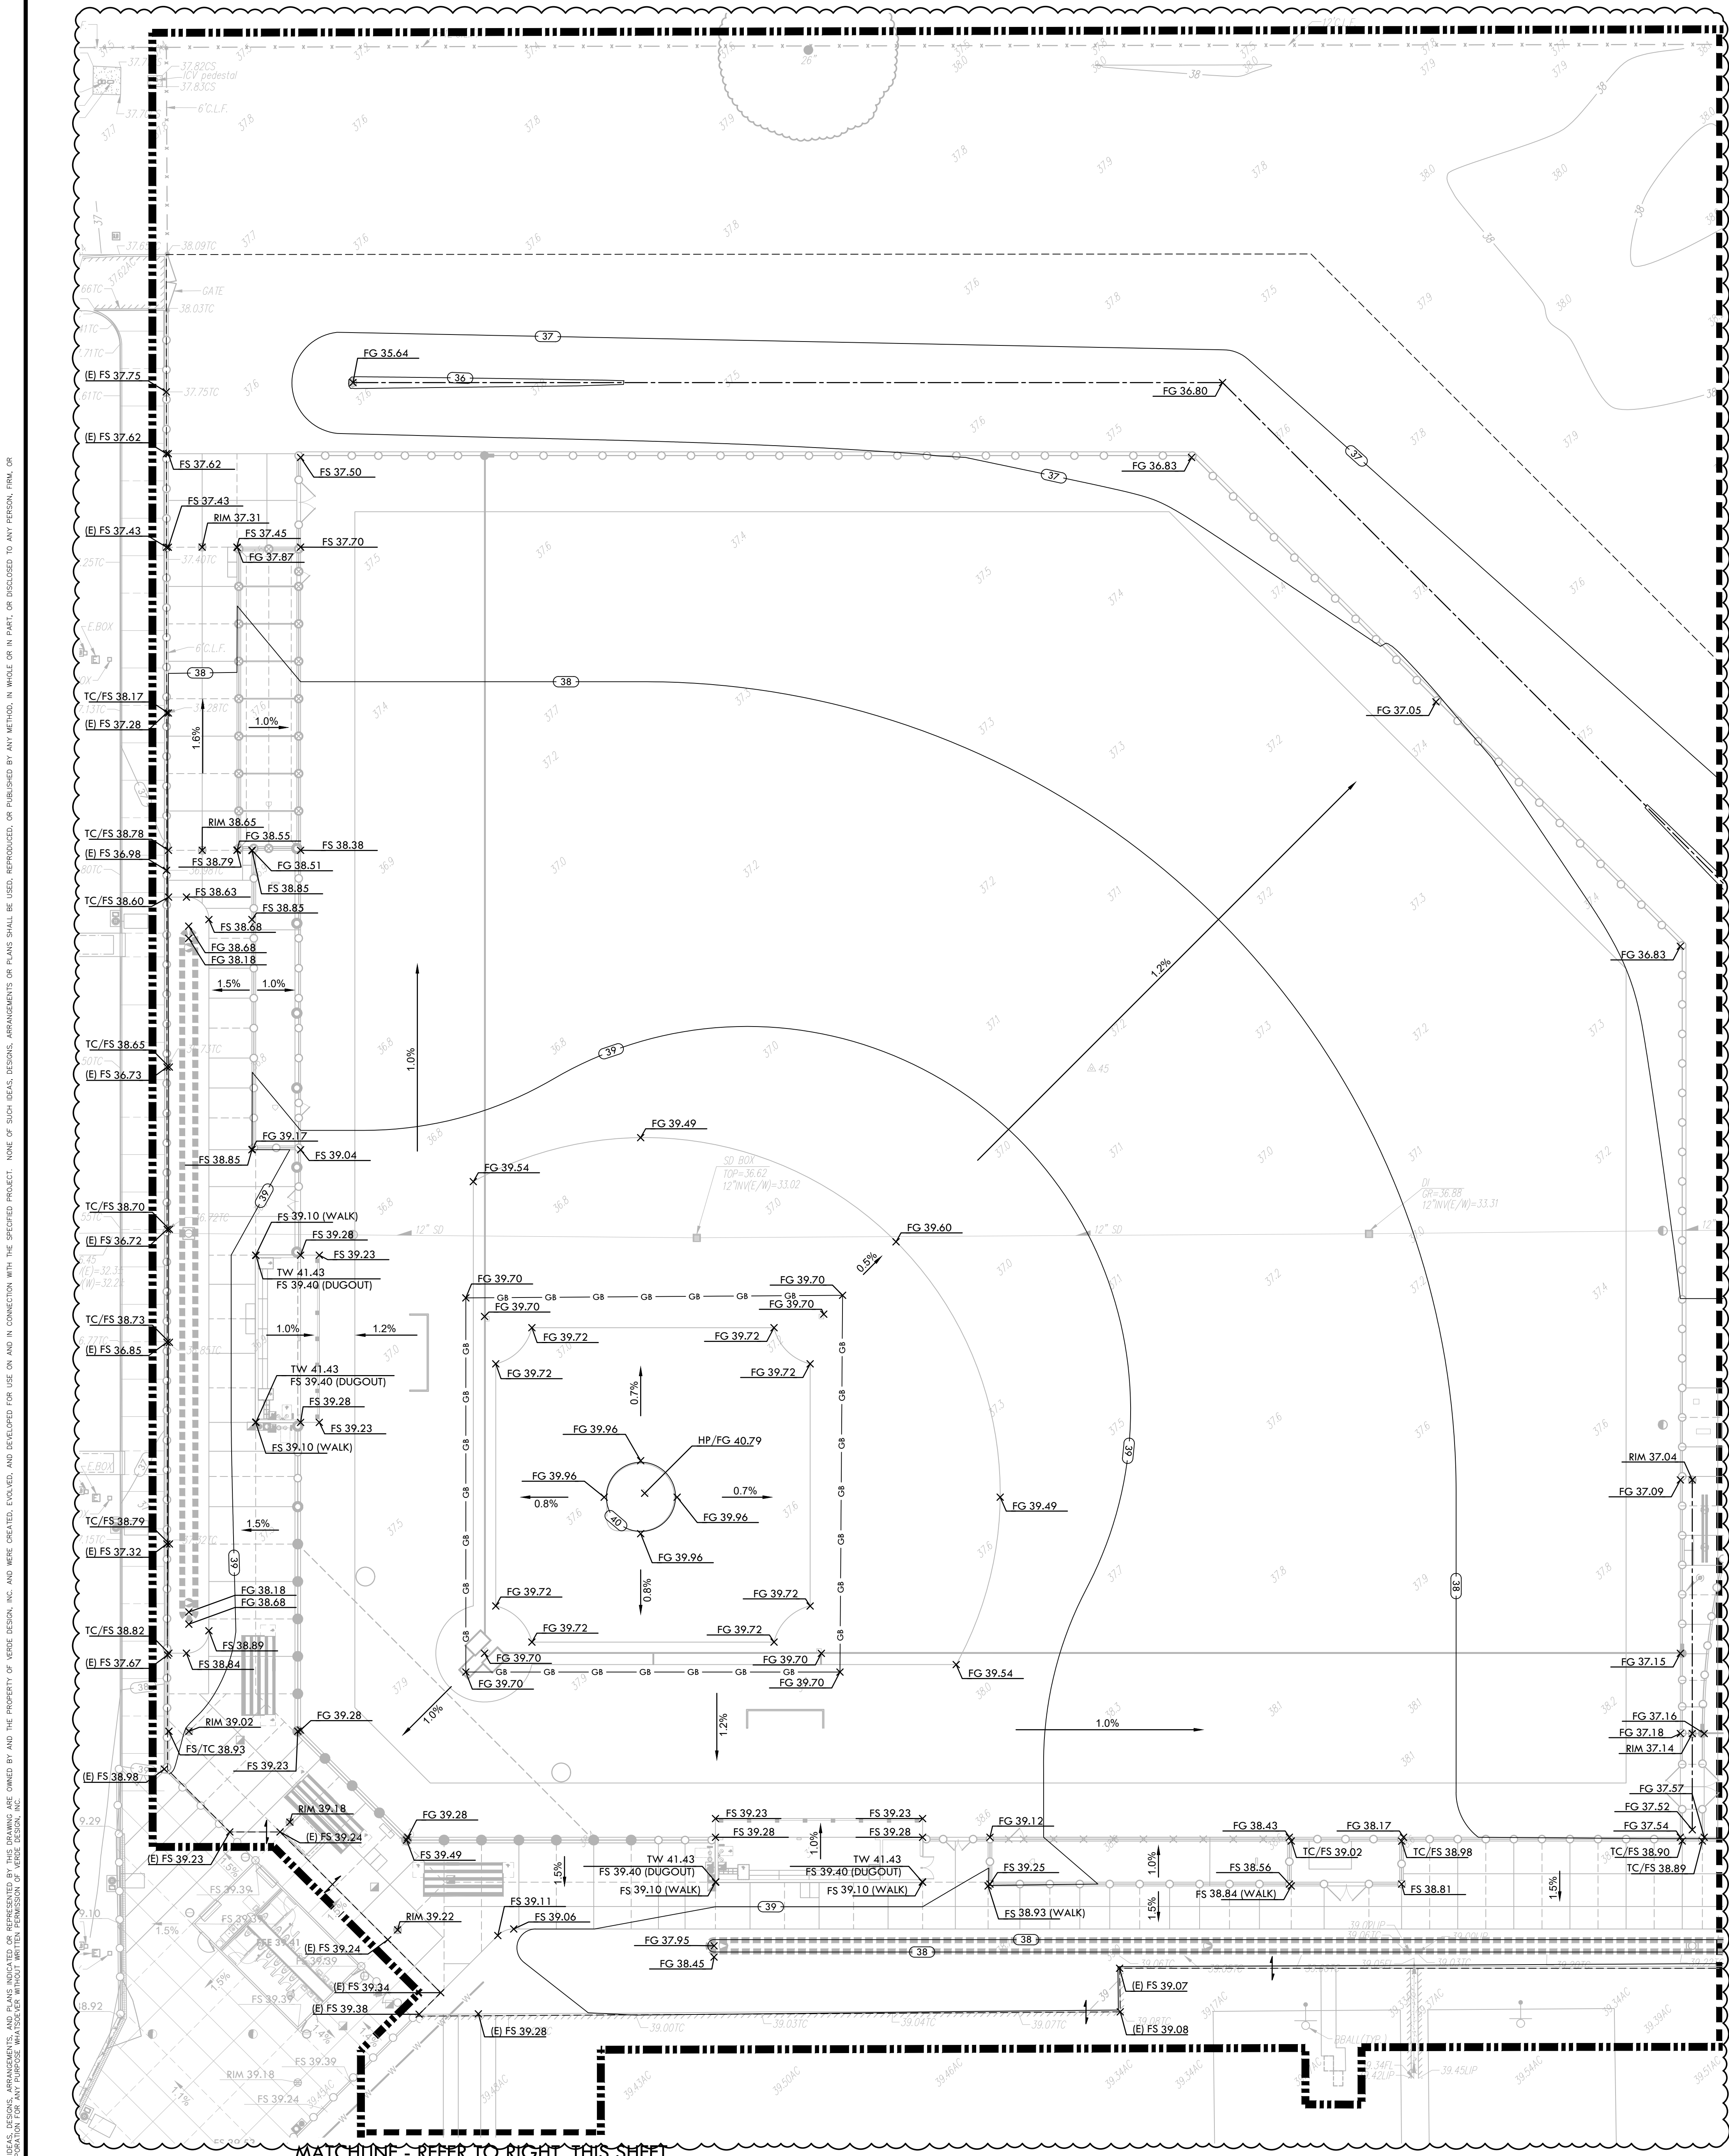GRADING NOTES

- EXISTING GRADES ARE BASED ON INFORMATION PROVIDED BY WARREN CONSULTING ENGINEERS, INC. CONTRACTOR SHALL VERIFY EXISTING GRADES FOR ACCURACY PRIOR TO THE START OF GRADING. NOTIFY THE DISTRICT'S REPRESENTATIVE IMMEDIATELY SHOULD CONFLICTS ARISE AND REDIRECT WORK TO AVOID DELAY.
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- ALL EXISTING DRAINAGE STRUCTURES, BOXES, UTILITY VAULTS ETC. SHALL BE BROUGHT TO FINAL FINISH GRADE PRIOR TO FINAL SURFACE TREATMENT.

GRADING LEGEND


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--- GB ---	GRADE BREAK
---	CENTERLINE OF SWALE
---	BOTTOM OF BIORETENTION AREA
○ 38	PROPOSED CONTOUR
X FG 35.00	PROPOSED FINISH GRADE ELEVATION OF SOFTSCAPE
X FS 35.00	PROPOSED FINISH SURFACE ELEVATION OF HARDSCAPE
X FT 35.00	PROPOSED TOP OF INFILL ELEVATION OF SYNTHETIC TURF
X SG 35.00	PROPOSED SUBGRADE ELEVATION
X TC 35.50	PROPOSED TOP OF CURB ELEVATION
X TW 37.00	PROPOSED TOP OF WALL ELEVATION
X RIM 35.00	PROPOSED RIM ELEVATION OF DRAIN
↑	CONFORM TO EXISTING GRADE
---	FLOW DIRECTION IN SOFTSCAPE
○ 38	EXISTING CONTOUR
37.5	EXISTING ELEVATION
1.00%	SLOPE AND DIRECTION
(E)	EXISTING
HP	HIGH POINT
LP	LOW POINT

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CONSULTANT	
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SHEET TITLE
**GRADING PLAN -
BASEBALL FIELD**


PROJECT NAME
**HIRAM JOHNSON
HIGH SCHOOL
GOLF PRACTICE FACILITY,
VARSITY BASEBALL AND
SOFTBALL FIELDS**

PROJECT ADDRESS
**6879 14TH AVENUE
SACRAMENTO, CA 95820**



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100% DSA SUBMITTAL	05/27/22
DSA BACK CHECK	08/11/22
DSA ADDENDUM SUBMITTAL	09/16/22

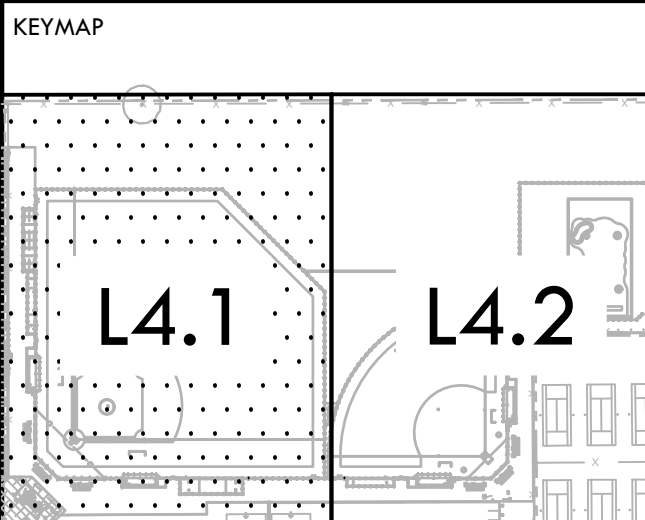NO.	REVISIONS	DATE
△	ADDENDUM	09/16/22
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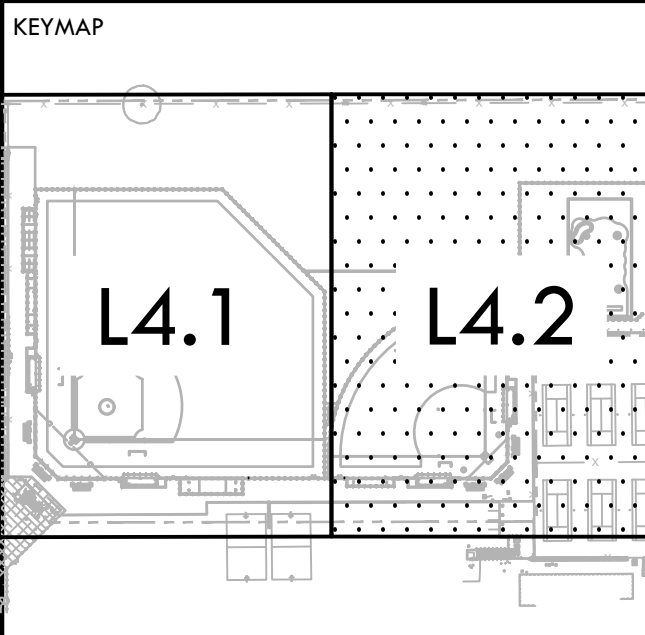
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SYM	DESCRIPTION
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--- GB ---	GRADE BREAK
- - - -	CENTERLINE OF SWALE
-----	BOTTOM OF BIORETENTION AREA
○ 38	PROPOSED CONTOUR
X FG 35.00	PROPOSED FINISH GRADE ELEVATION OF SOFTSCAPE
X FS 35.00	PROPOSED FINISH SURFACE ELEVATION OF HARDSCAPE
X FT 35.00	PROPOSED TOP OF INFILL ELEVATION OF SYNTHETIC TURF
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↑	CONFORM TO EXISTING GRADE
~	FLOW DIRECTION IN SOFTSCAPE
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38.1	EXISTING ELEVATION
1.00%	SLOPE AND DIRECTION
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SHEET TITLE
**GRADING PLAN -
 SOFTBALL FIELD AND
 GOLF**


PROJECT NAME
**HIRAM JOHNSON
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 GOLF PRACTICE FACILITY,
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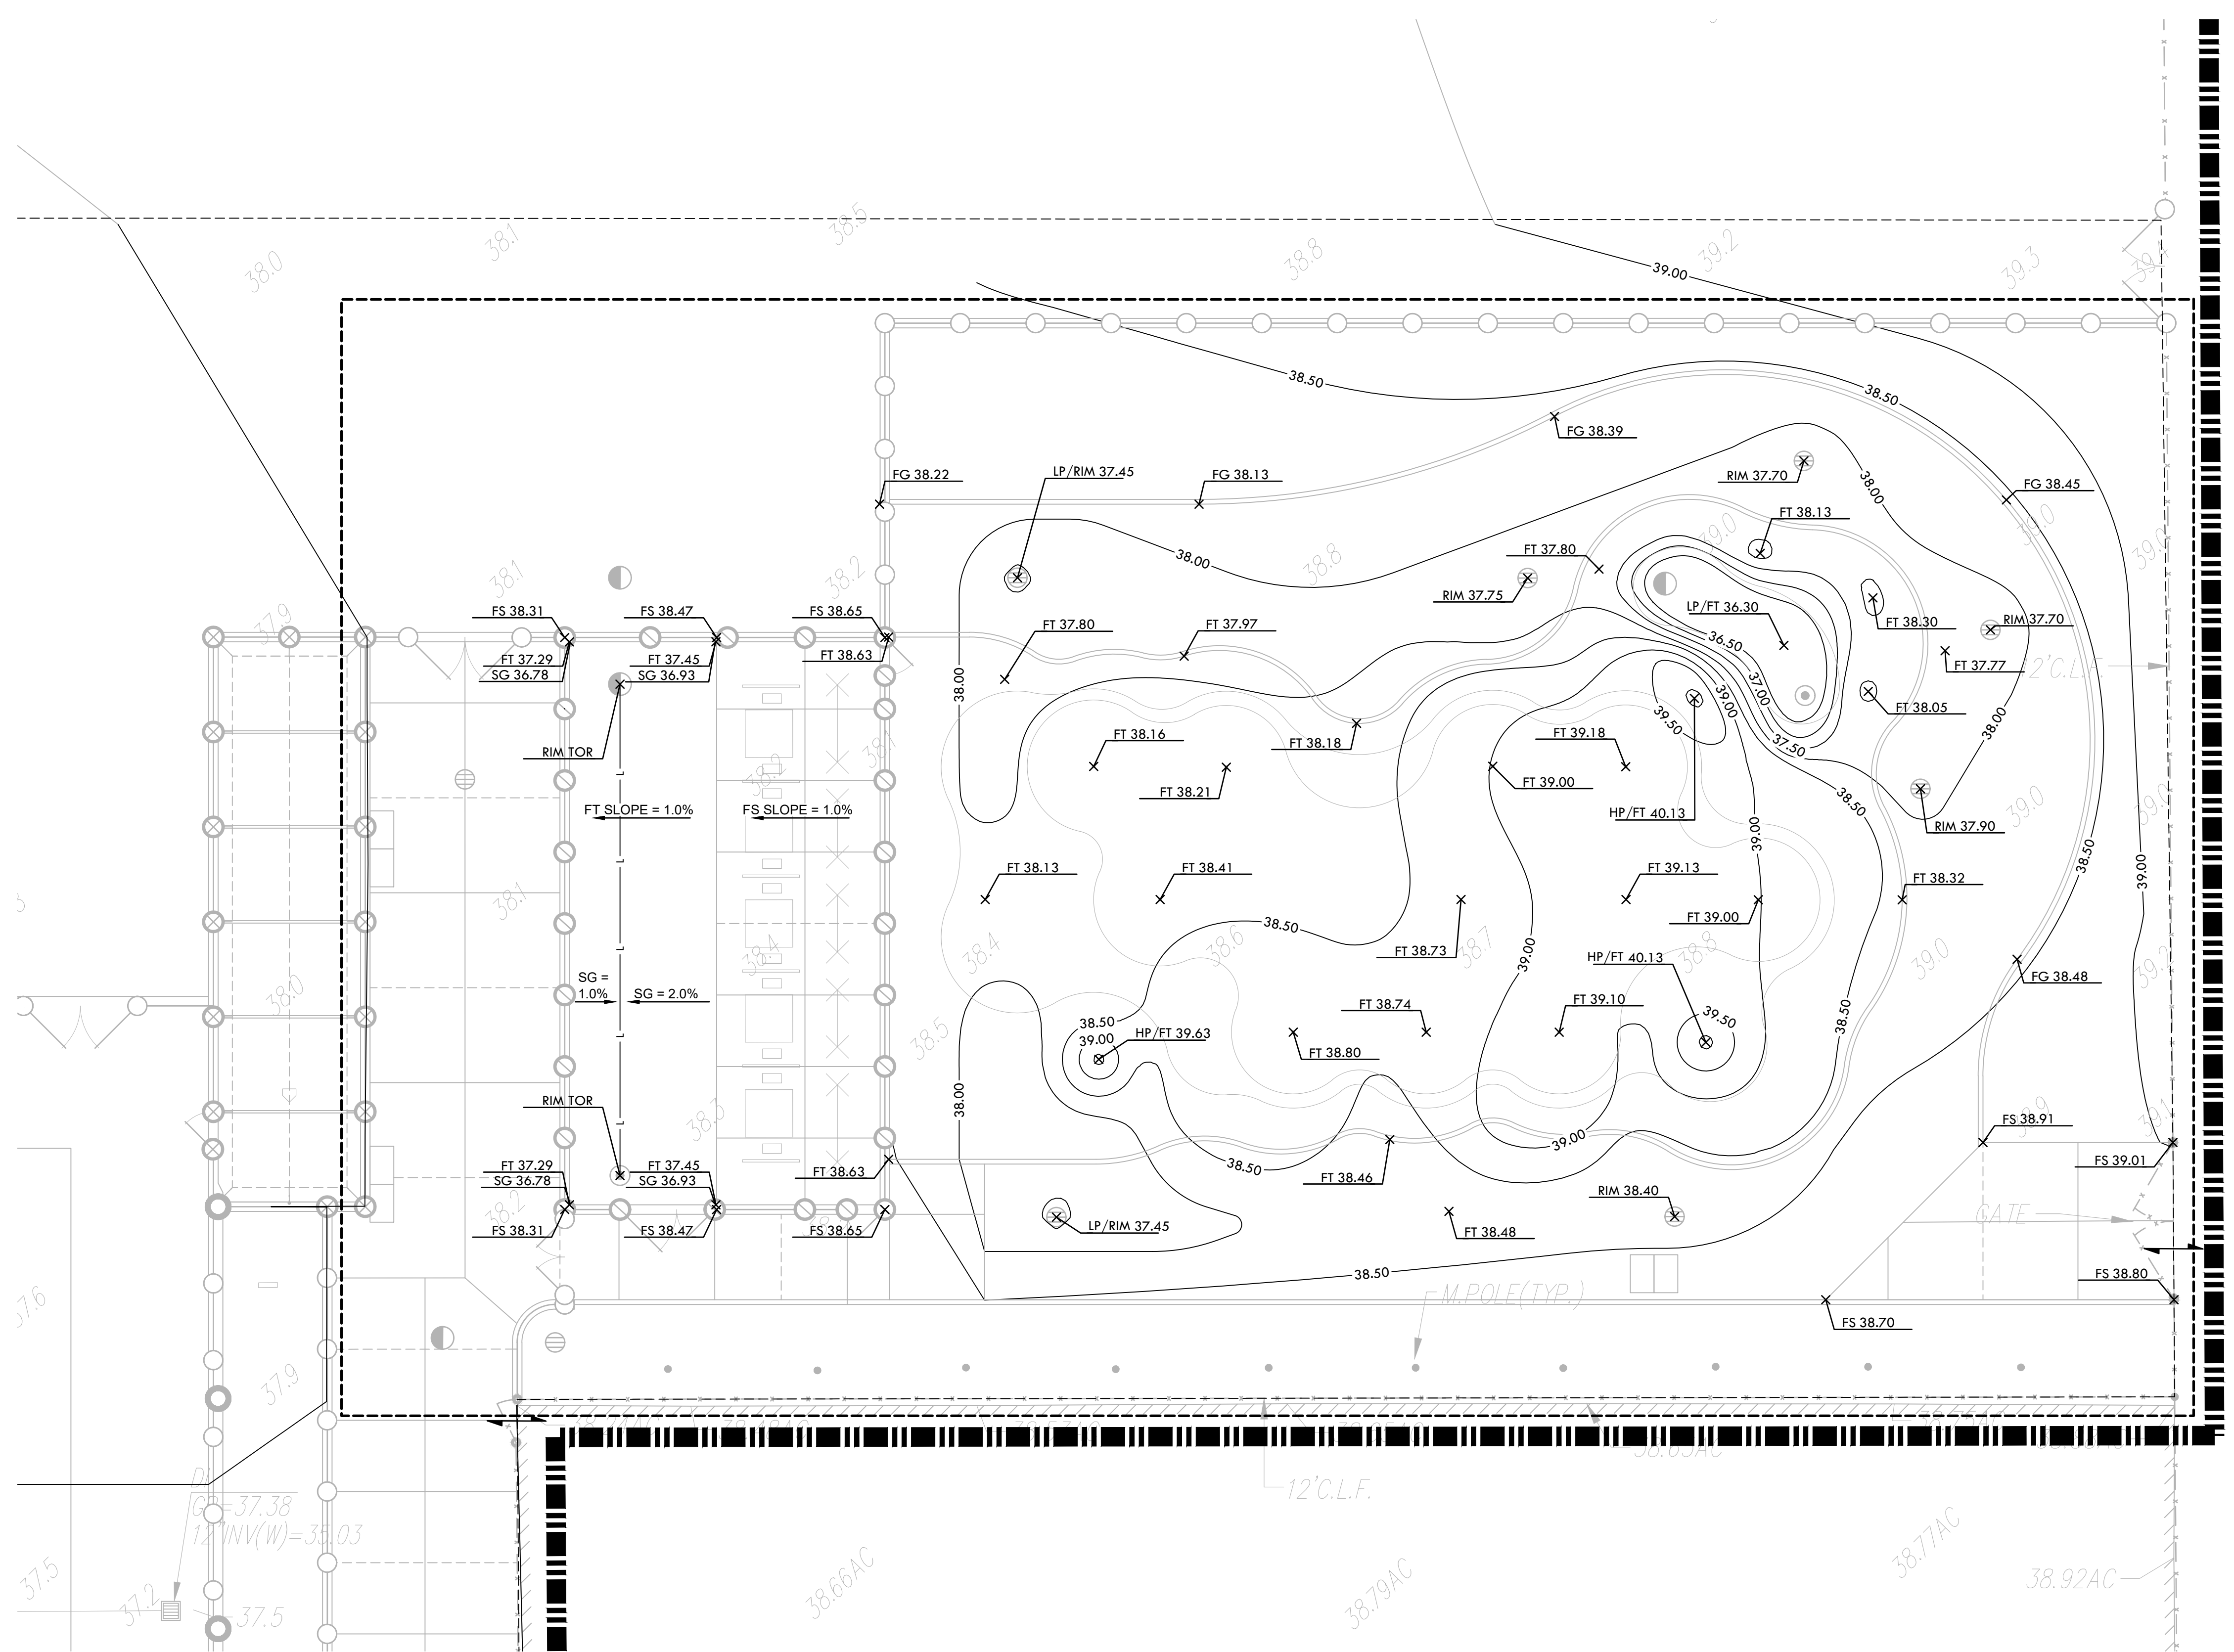
PROJECT ADDRESS
**6879 14TH AVENUE
 SACRAMENTO, CA 95820**

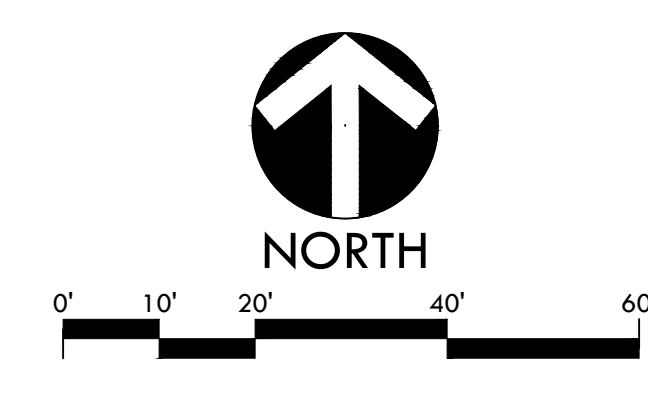SUBMITTAL	DATE
DD 50% SUBMITTAL	04/15/22
100% DSA SUBMITTAL	05/27/22
DSA BACK CHECK	08/11/22
DSA ADDENDUM SUBMITTAL	09/16/22

NO.	REVISIONS	DATE
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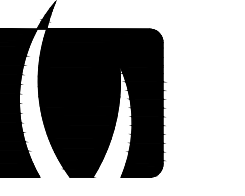
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 PROJ. NO.: **2203200**
 SHEET NO.: **L4.2**

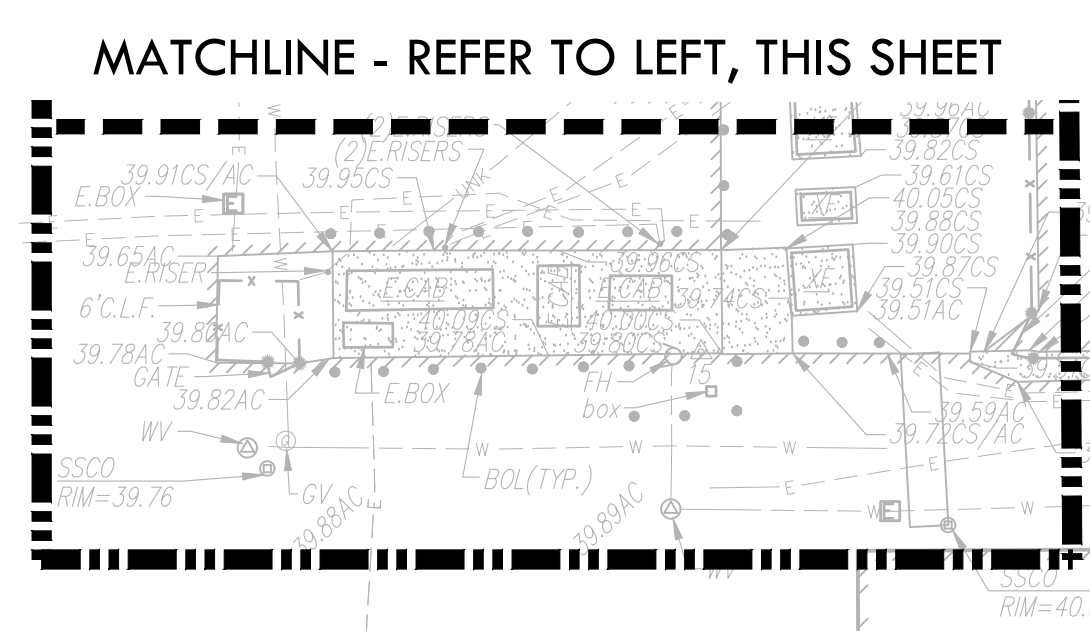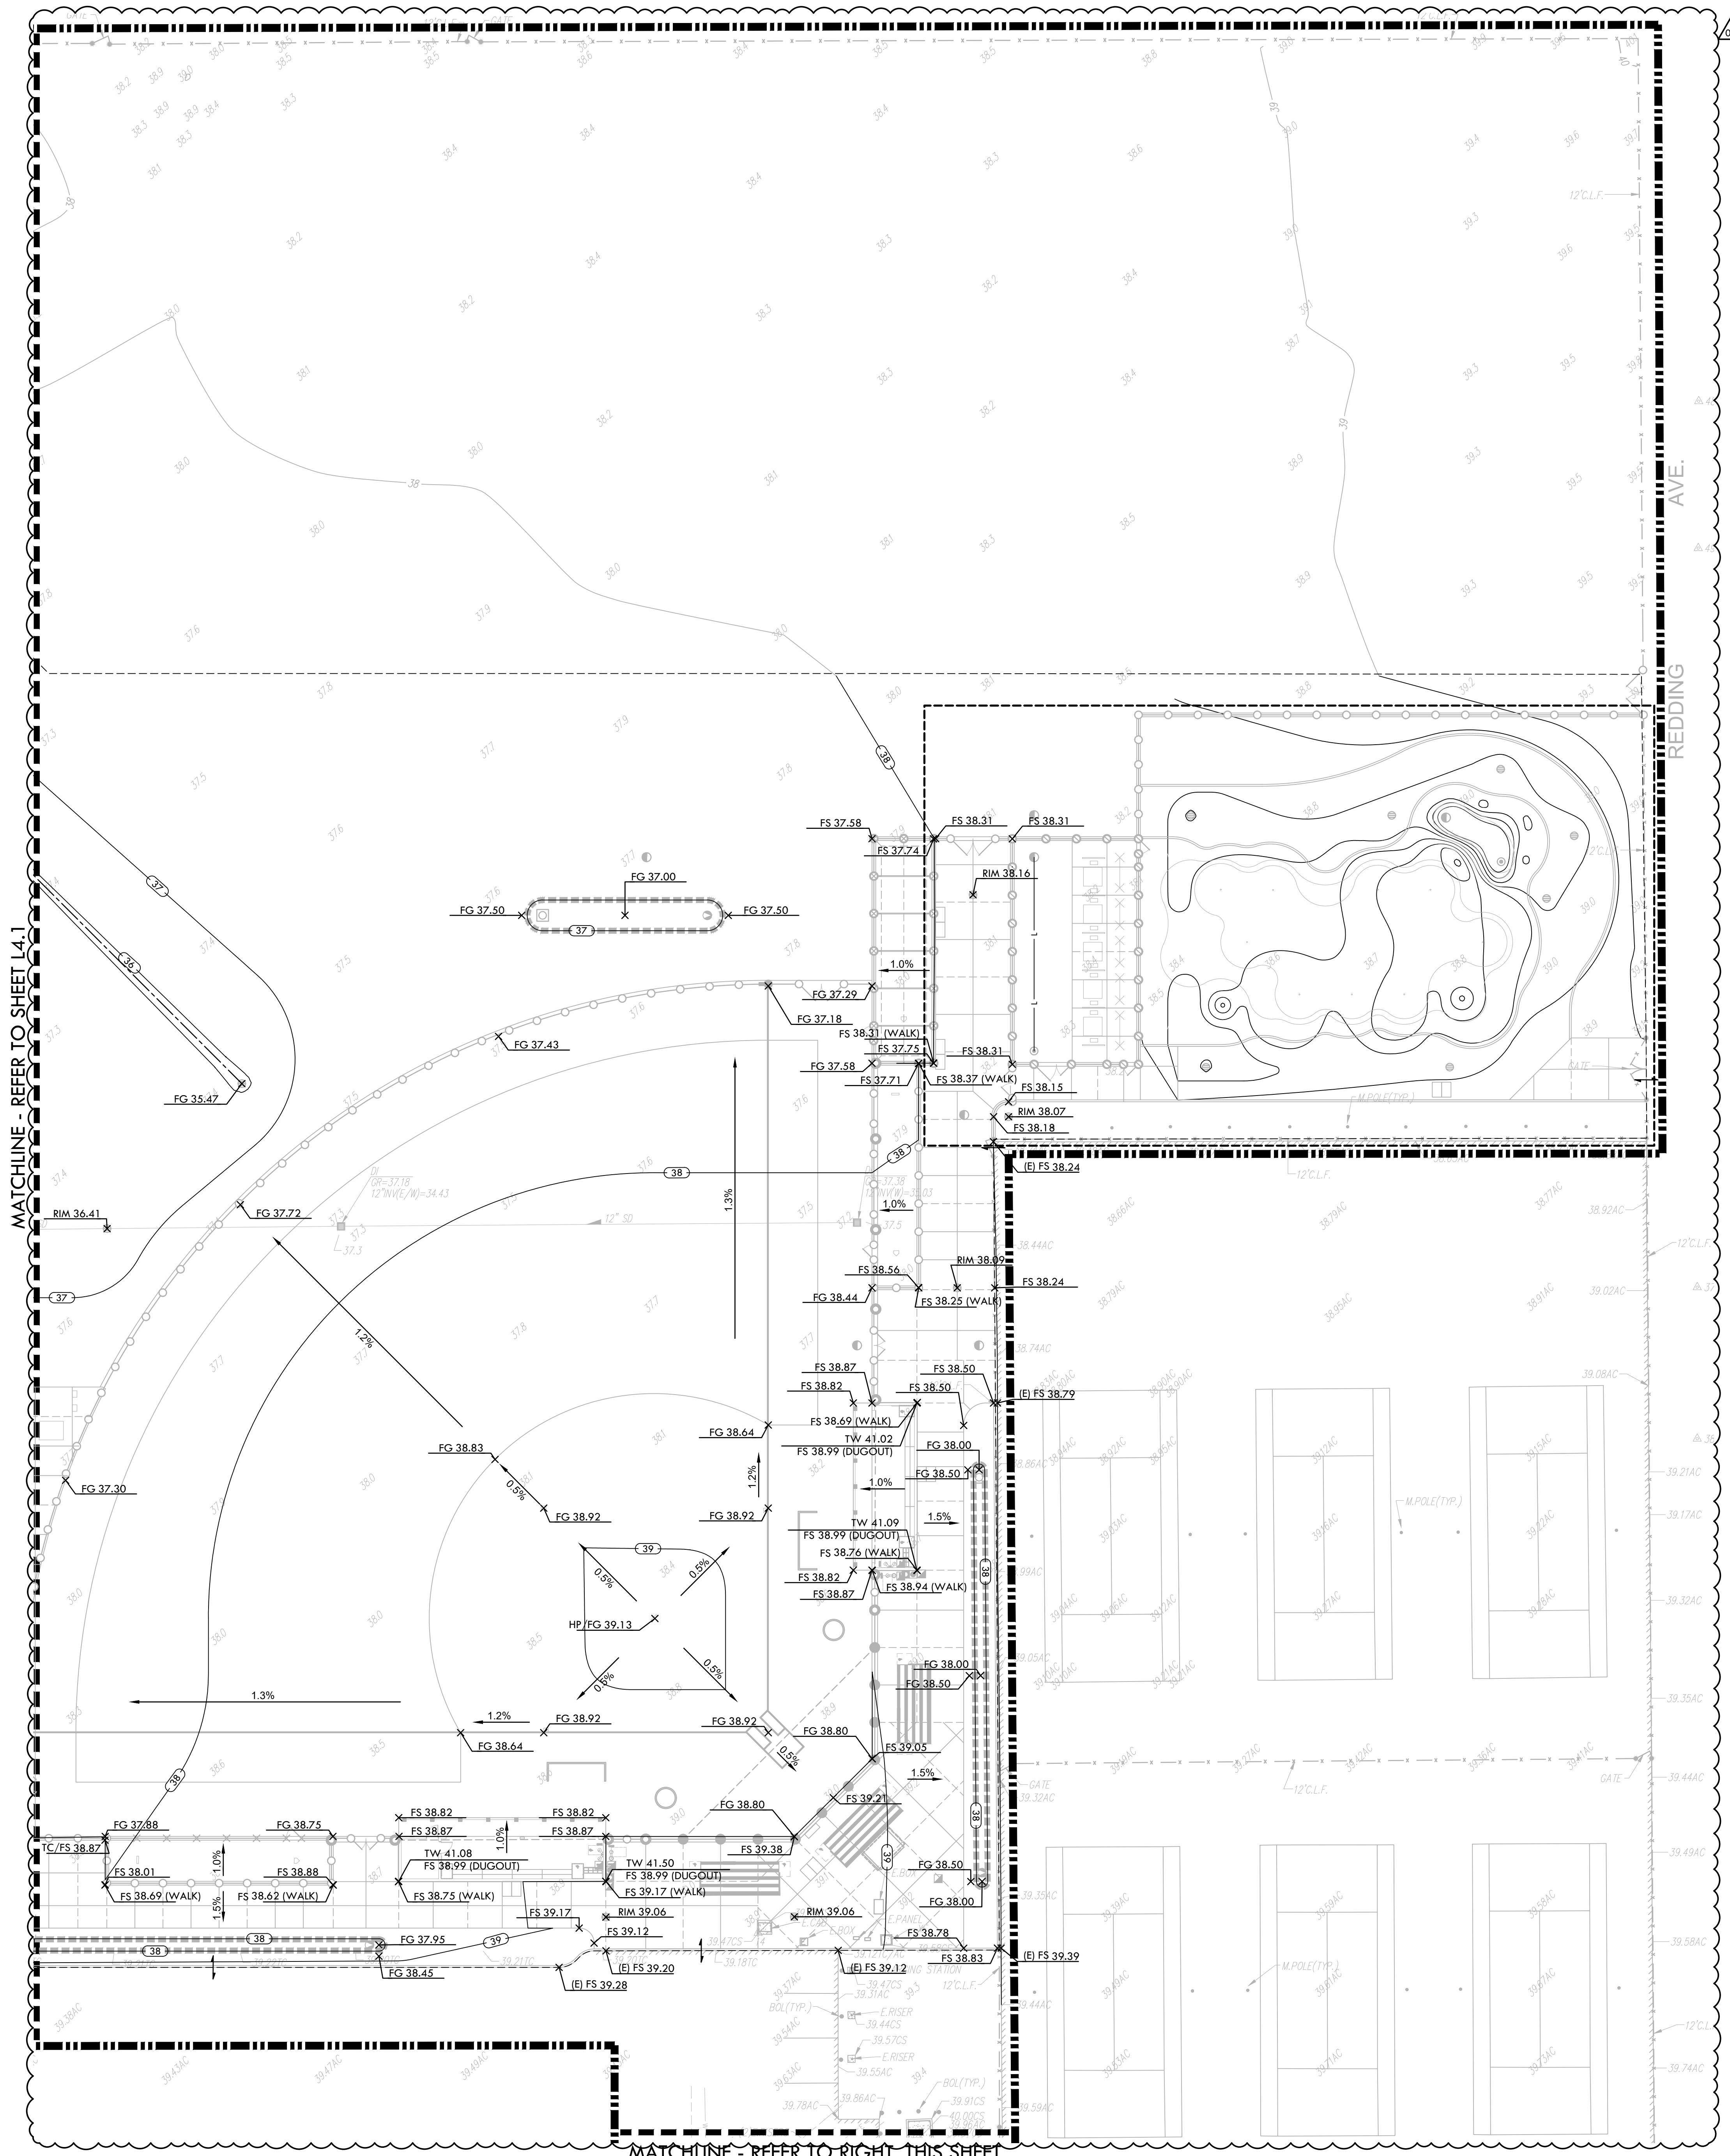

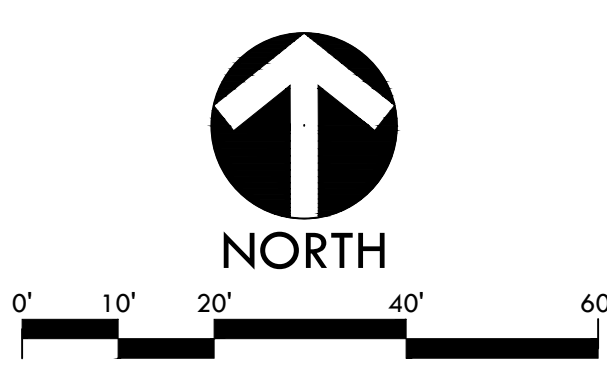

GRADING NOTES


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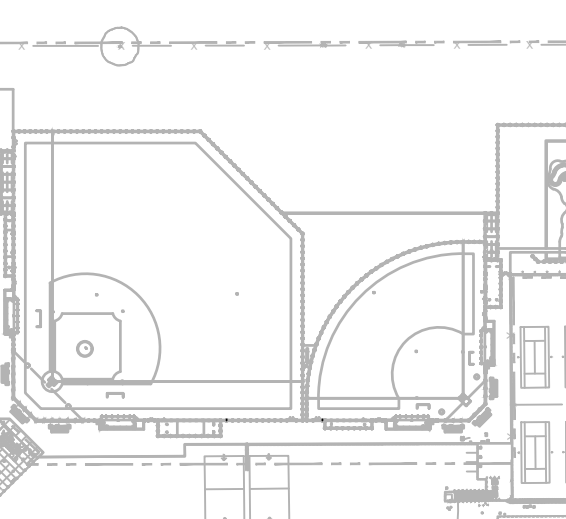
GRADING LEGEND

SYM	DESCRIPTION
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GB	GRADE BREAK
---	CENTERLINE OF SWALE
---	BOTTOM OF BIORETENTION AREA
○	PROPOSED CONTOUR
FG 35.00	PROPOSED FINISH GRADE ELEVATION OF SOFTSCAPE
FS 35.00	PROPOSED FINISH SURFACE ELEVATION OF HARDSCAPE
FT 35.00	PROPOSED TOP OF INFILL ELEVATION OF SYNTHETIC TURF
SG 35.00	PROPOSED SUBGRADE ELEVATION
TC 35.50	PROPOSED TOP OF CURB ELEVATION
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↑	CONFORM TO EXISTING GRADE
→	FLOW DIRECTION IN SOFTSCAPE
---	EXISTING CONTOUR
38.50	EXISTING ELEVATION
1.00%	SLOPE AND DIRECTION
(E)	EXISTING
HP	HIGH POINT
LP	LOW POINT



CONSULTANT

KEYMAP

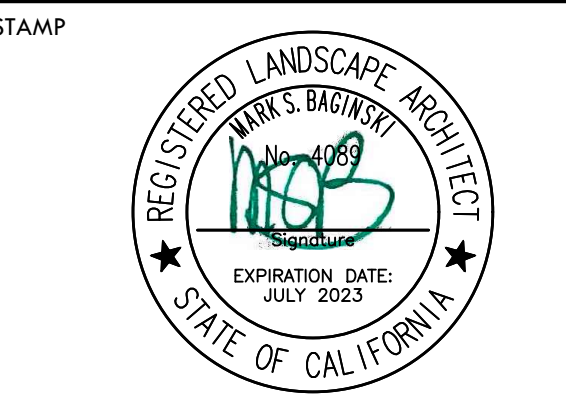

SHEET TITLE
**GRADING PLAN -
 SOFTBALL FIELD AND
 GOLF**

PROJECT NAME
**HIRAM JOHNSON
 HIGH SCHOOL
 GOLF PRACTICE FACILITY,
 VARSITY BASEBALL AND
 SOFTBALL FIELDS**

PROJECT ADDRESS
**6879 14TH AVENUE
 SACRAMENTO, CA 95820**


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DSA ADDENDUM SUBMITTAL	09/16/22

NO.	REVISIONS	DATE
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4		



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 DATE ISSUED: 09/16/2022
 SCALE: 1" = 10'-0"

PROJ. NO. 2203200

SHEET NO. L4.3

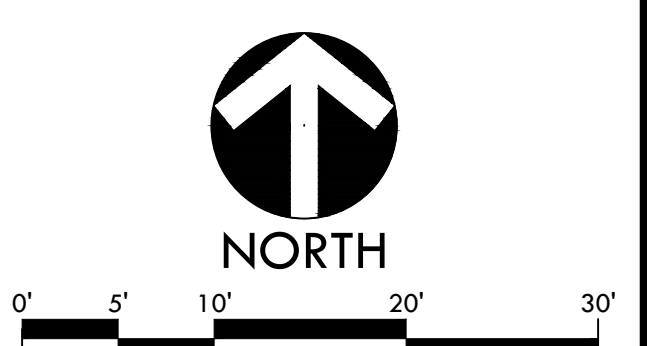


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CHEMICAL TREATMENT LEGEND	
SYM	DESCRIPTION
---	PROJECT LIMIT OF WORK
- - - -	LOCATIONS OF DEEP EDGES AT PERIMETER OF CHEMICAL TREATMENT AREAS (REFER TO MATERIALS PLAN AND DETAILS FOR MORE INFORMATION)
■	AREA OF CHEMICAL TREATMENT, REFER TO SPECIFICATIONS & GEOTECHNICAL REPORT
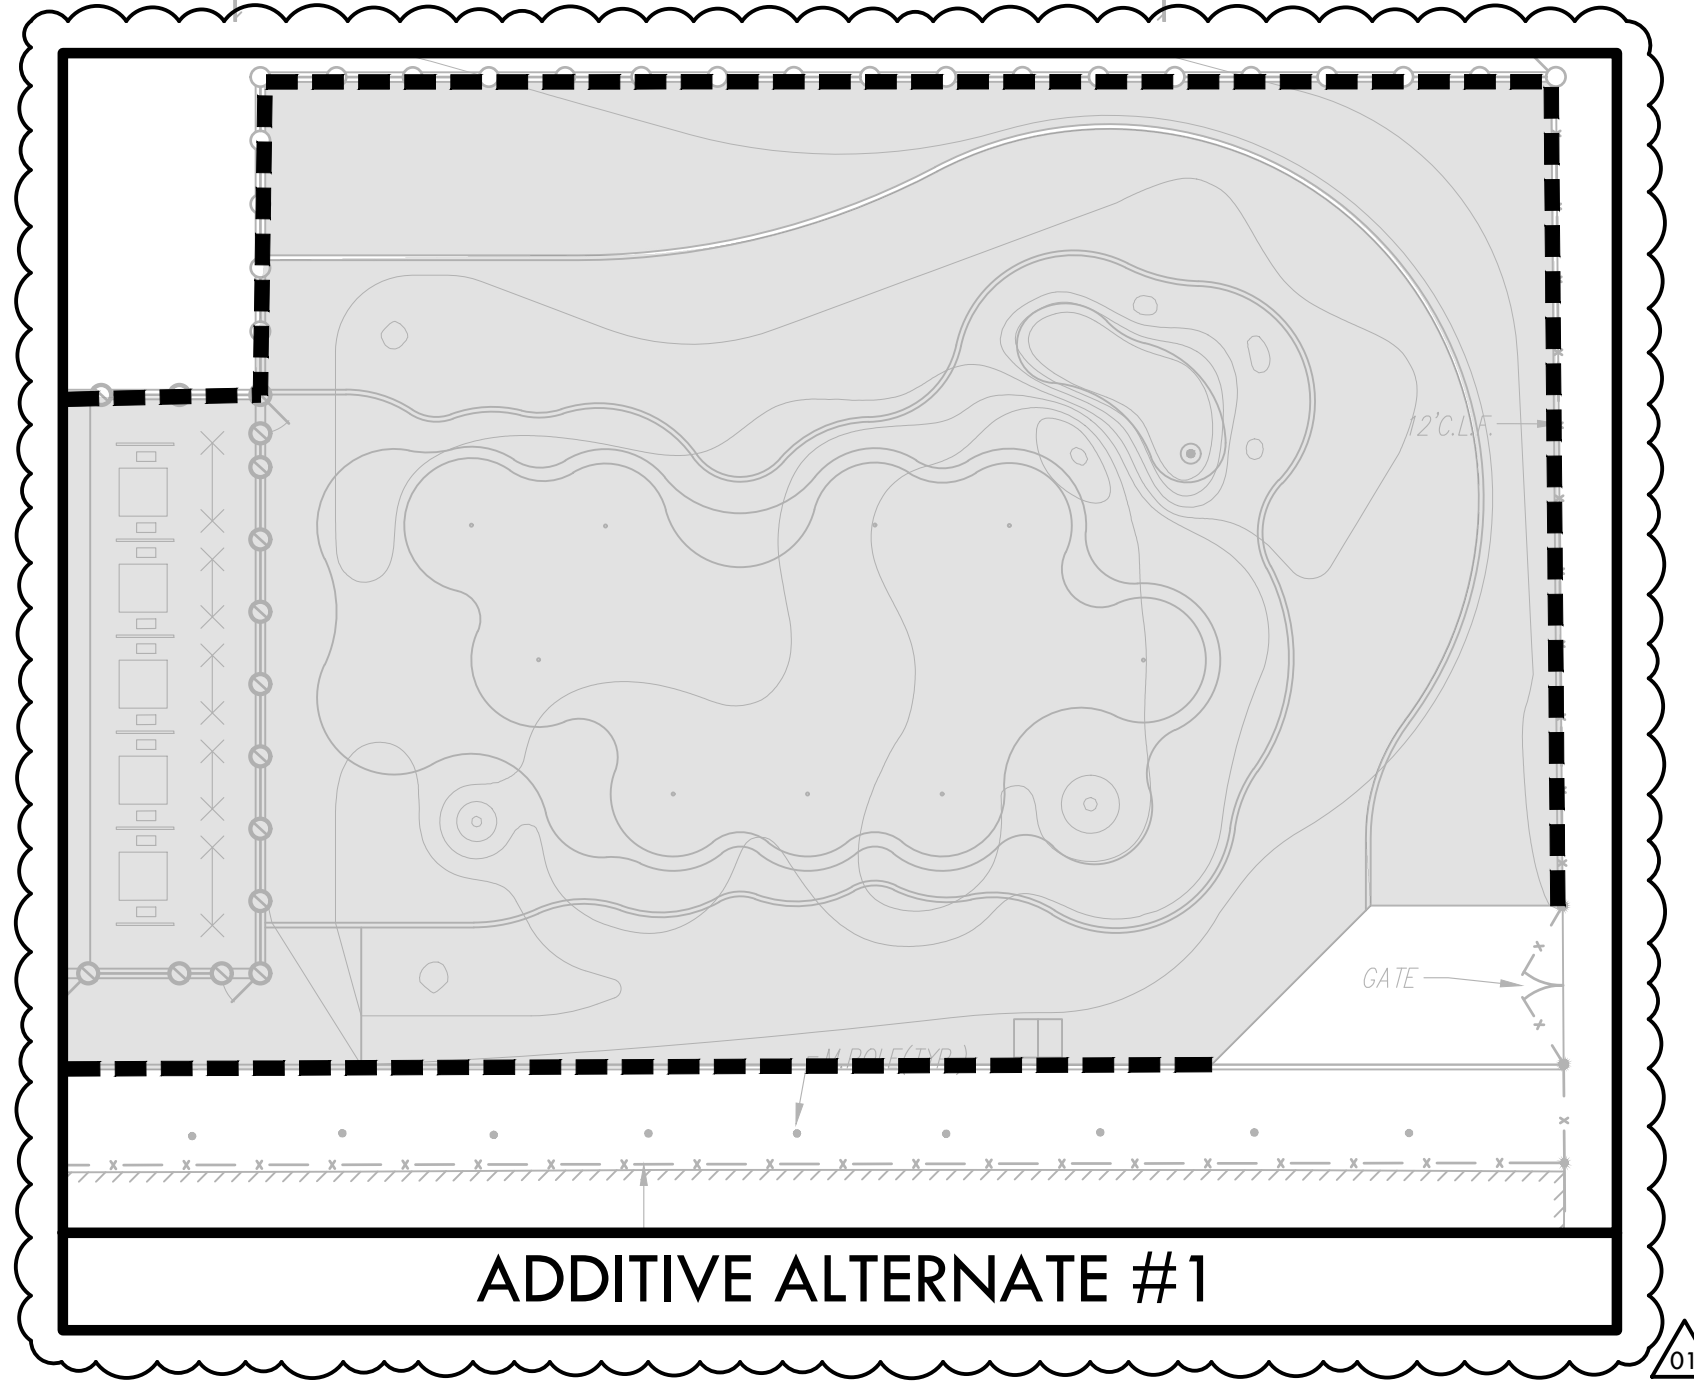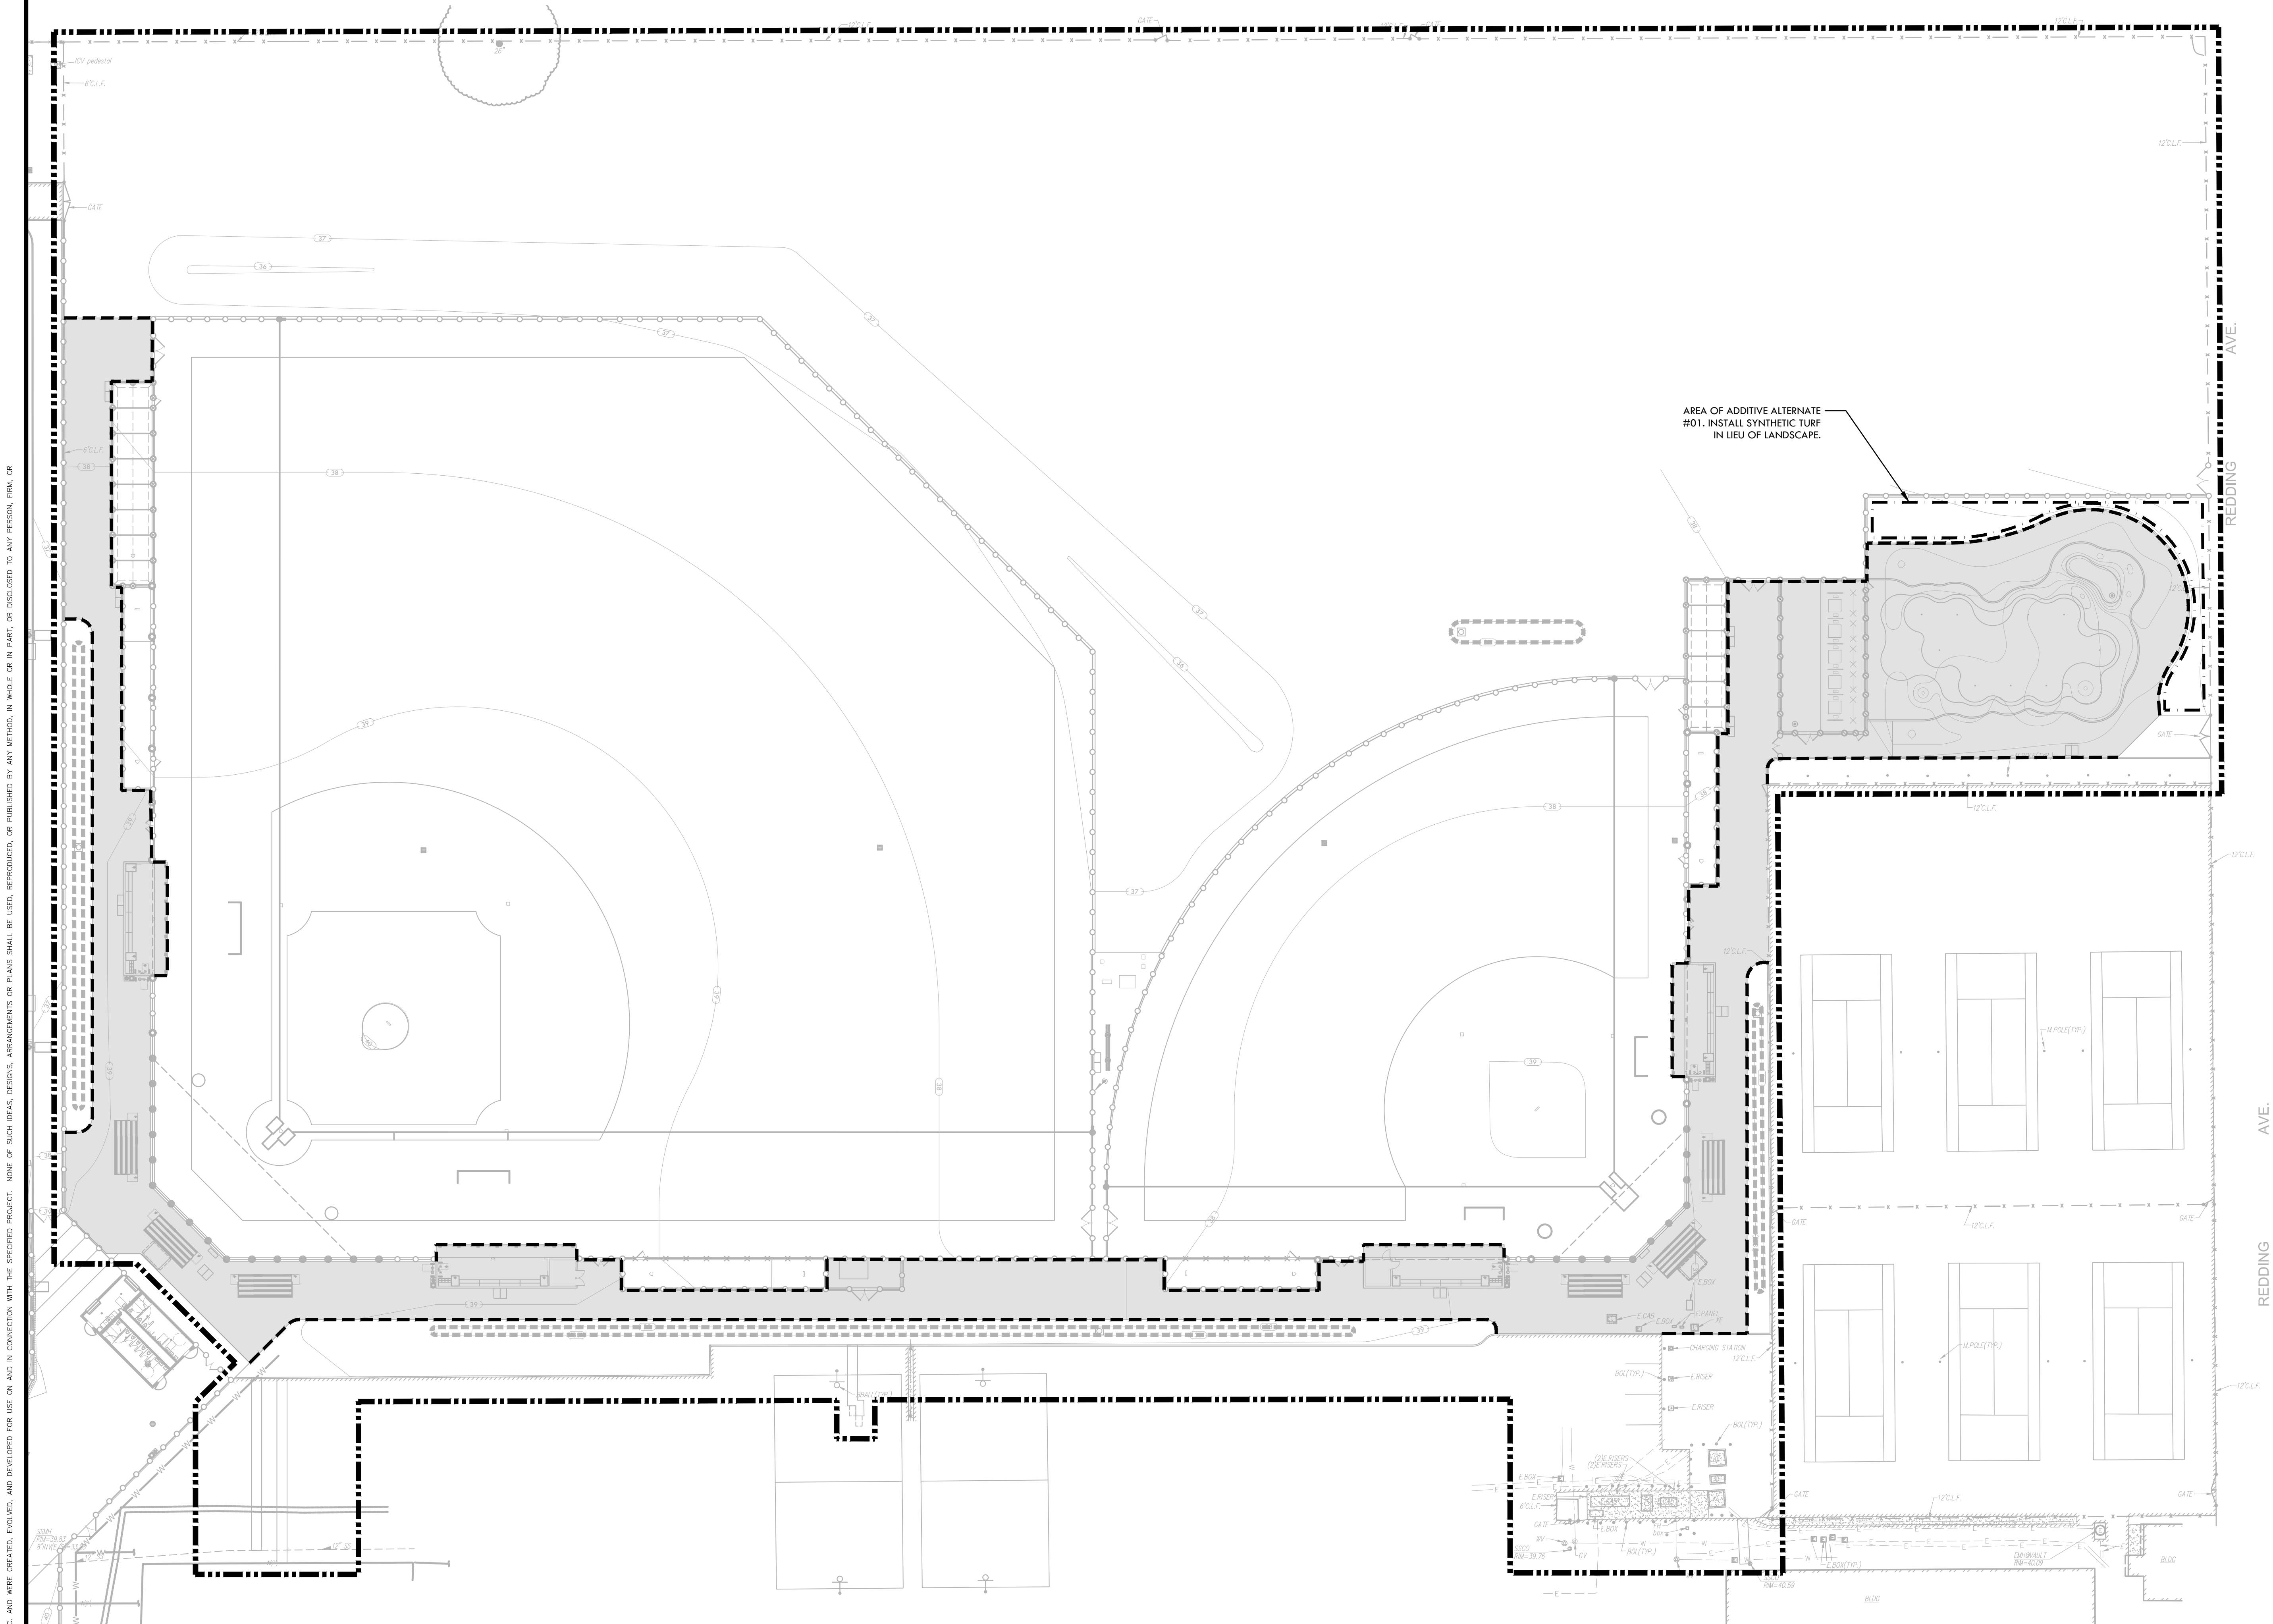
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SHEET TITLE
**GRADING PLAN -
 CHEMICAL TREATMENT**


PROJECT NAME
**HIRAM JOHNSON
 HIGH SCHOOL
 GOLF PRACTICE FACILITY,
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 SOFTBALL FIELDS**

PROJECT ADDRESS
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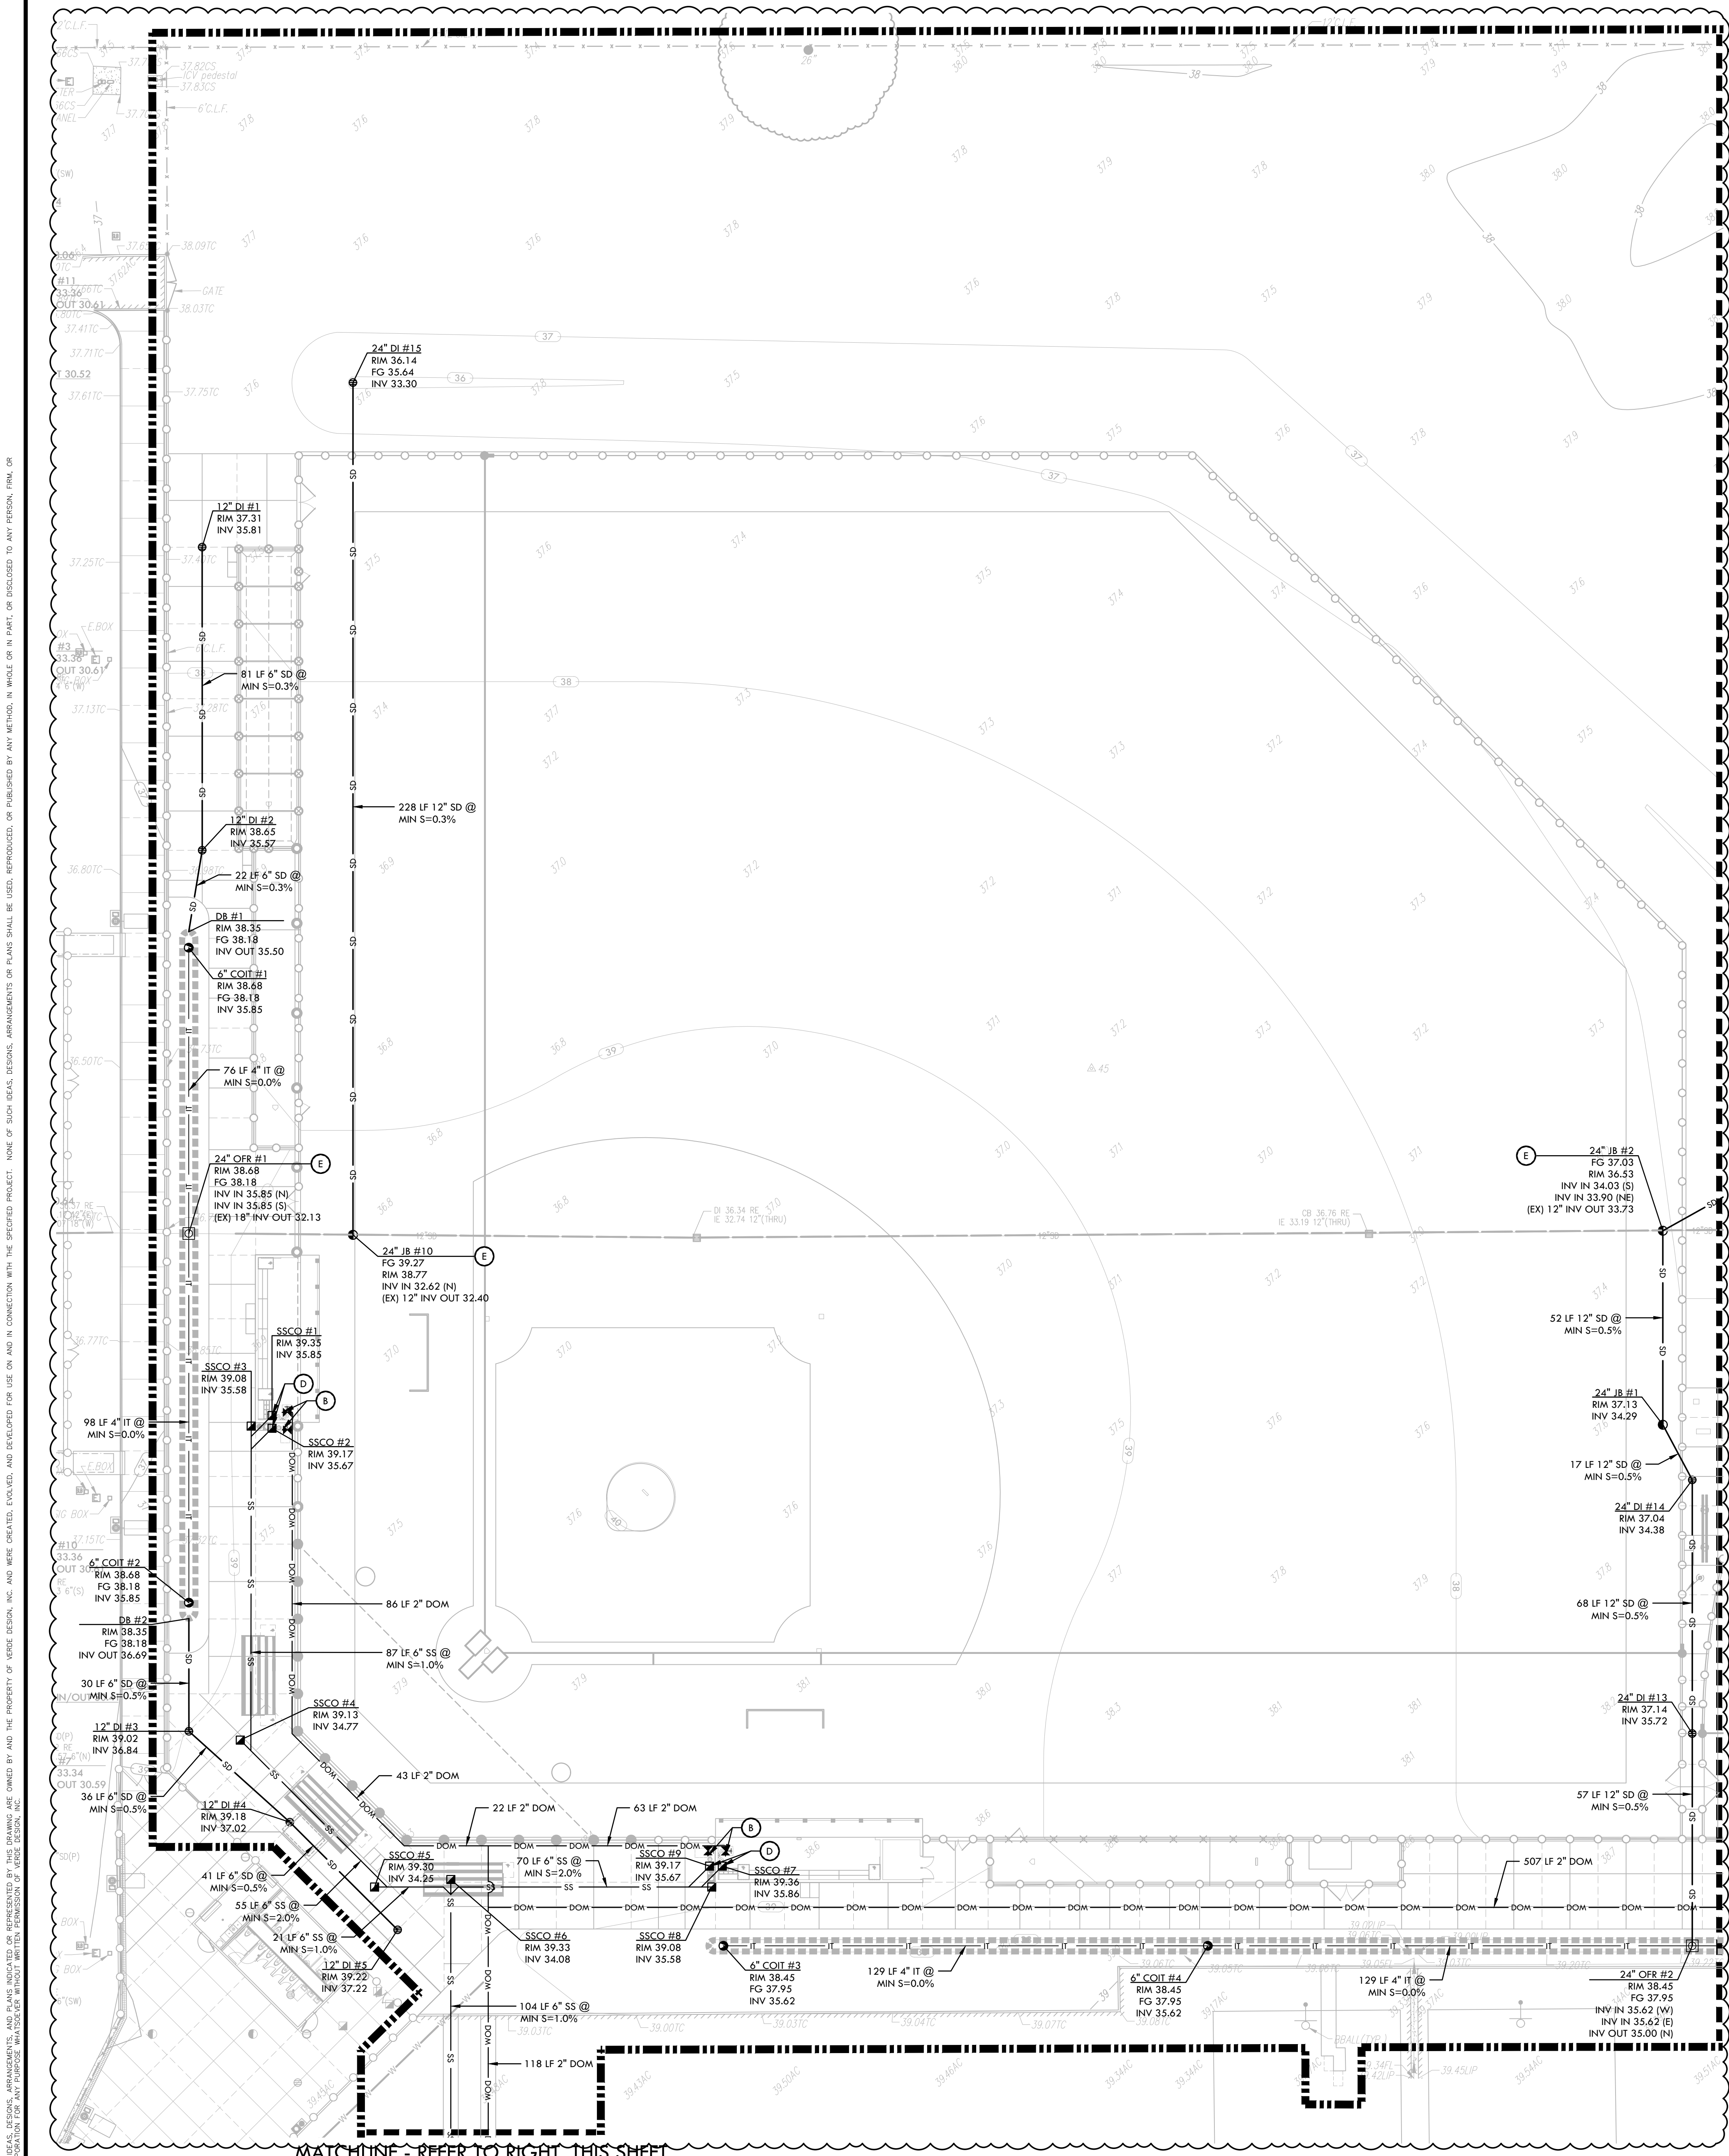
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DSA BACK CHECK	08/11/22
DSA ADDENDUM SUBMITTAL	09/16/22

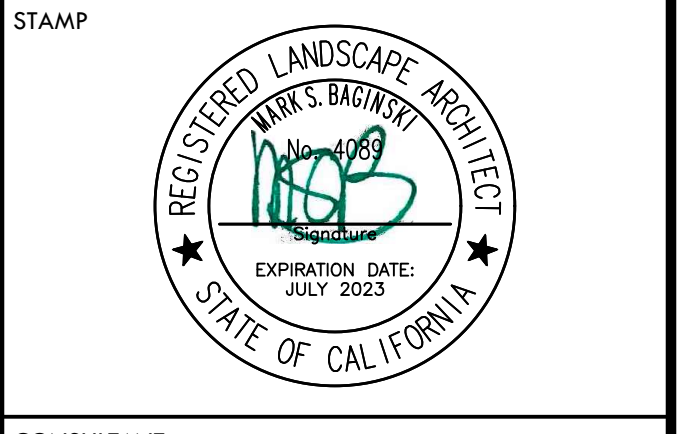NO.	REVISIONS	DATE
▲	ADDENDUM	09/16/22
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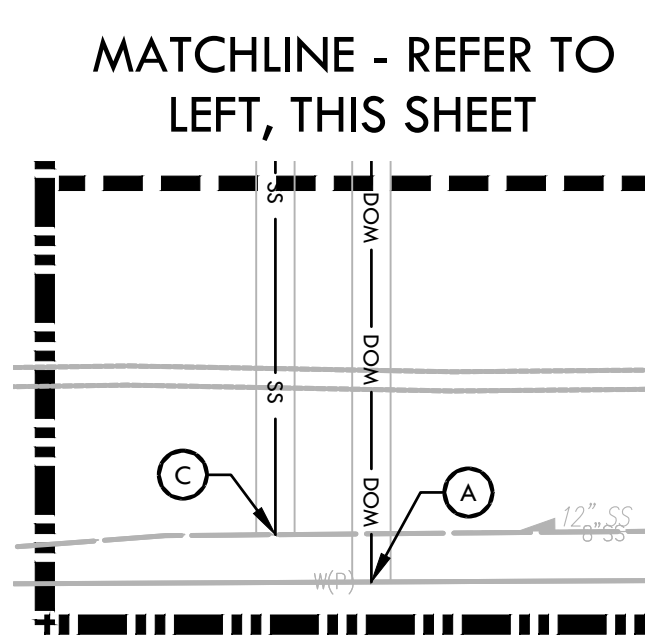
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DATE ISSUED 09/16/2022	SCALE 1" = 30'-0"
PROJ. NO. 2203200	SHEET NO. L4.4



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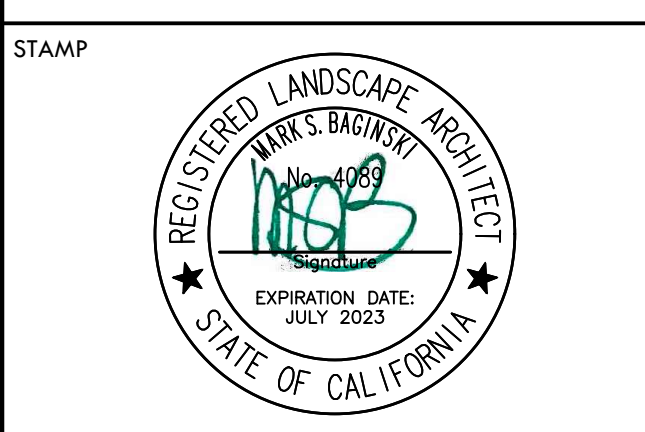
MATCHLINE - REFER TO SHEET L5.2

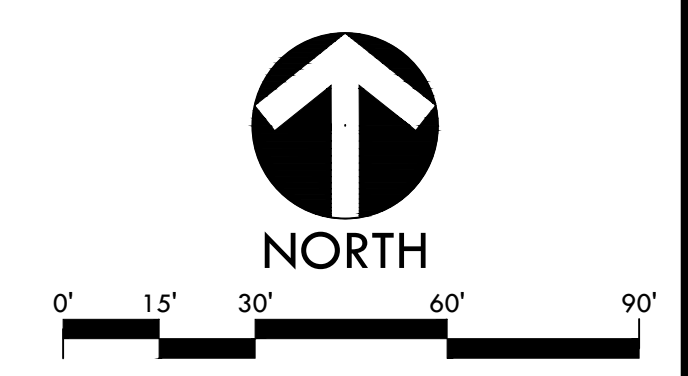

DRAINAGE & UTILITY NOTES

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2. ALL EXISTING DRAINAGE STRUCTURES, BOXES, UTILITY VAULTS ETC. TO REMAIN, SHALL BE BROUGHT TO FINAL FINISH GRADE PRIOR TO FINAL SURFACE TREATMENT.
3. THE CONTRACTOR IS TO PROTECT DRAINAGE SYSTEM FROM DEBRIS, INCLUDING SOIL, ROCK MATERIAL, AND TRASH FROM ENTERING THE PIPE DURING CONSTRUCTION. CONTRACTOR SHALL AVOID PLACING CONSTRUCTION VEHICLES OVER INSTALLED DRAINAGE TRENCHES TO PREVENT CRUSHING OF PIPE.
4. COORDINATE ALL SLEEVING AND UTILITY LOCATIONS AS SHOWN ON THE PLANS AND DETAILS CONTAINED WITHIN THESE CONTRACT DOCUMENTS.
5. THE CONTRACTOR IS TO ENSURE THAT ALL REMAINING ACTIVE AND NEW DRAINAGE AND UTILITY LINES ARE PROTECTED AND UNDEGRADED FROM TRENCHING AND FOOTING EXCAVATIONS FOR NEW FOOTINGS, PARTICULARLY FOR NEW FENCING AND WALLS.
6. ALL ABANDONED STORM LINES SHALL REMAIN IN PLACE UNLESS IN CONFLICT WITH PROPOSED DRAINAGE, UTILITY, OR SUBGRADING OPERATIONS, IN WHICH CASE ABANDONED PIPE IN CONFLICT SHALL BE REMOVED. REMAINING ABANDONED STORM PIPE SHALL BE SEALED WITH APPROPRIATELY SIZED CONCRETE CAP (3 SACK MIX) 0' ENVELOPE OUTSIDE AND INSIDE DIAMETER OF PIPE.
7. PRIOR TO ALL DRAINAGE AND UTILITY WORK, CONTRACTOR SHALL BE RESPONSIBLE FOR VERIFYING ALL POTENTIAL DRAINAGE CONNECTIONS AND EXISTING UTILITY BY POTHOLES. IN ADDITION, ALL DOWNSTREAM CONNECTIONS TO EXISTING STRUCTURES SHALL BE THE START OF THESE OPERATIONS, AND GRADES SHALL BE VERIFIED.
8. WHEN WORK HAS TO OCCUR UNDER THE DRIFLINE OF EXISTING TREES NOT SCHEDULED FOR REMOVAL, THE CONTRACTOR SHALL USE ALL POSSIBLE CARE TO AVOID INJURY TO THE TREES AND TREE ROOTS. GRADE IN LINES RADIAL TO THE EXISTING TREES RATHER THAN TANGENTIAL. ALL PARTIAL CUTS OR TEARS THROUGH ROOTS TWO INCHES IN DIAMETER AND LARGER SHALL BE CUT CLEAN. TRENCHES ADJACENT TO TREES SHALL BE FILLED WITHIN 24 HOURS AFTER EXCAVATION, BUT WHERE THIS IS NOT POSSIBLE, THE SIDE OF THE TRENCH ADJACENT TO THE TREE, AND ANY EXPOSED ROOTS SHALL BE KEPT SHADED AND MOIST WITH DAMPENED BURLAP OR CANVAS.
9. ALL DRAIN LINES LEAVING COMBOS, WATER CANNONS AND QUICK COUPLERS SHALL BE DAYLIGHTED TO NEAREST SUBDRAIN TRENCH.

VERDE DESIGN
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Tel: 916.415.6554
Fax: 916.415.6525
www.VerdeDesign.com



DRAINAGE & UTILITY LEGEND

SYM	DESCRIPTION	DETAIL NUMBER SHEET NUMBER
---	LIMIT OF WORK	
⊙	JUNCTION BOX (JB), SIZE PER PLAN	(F) D1.1
⊙	JUNCTION BOX IN SYNTHETIC TURF (JB _T), SIZE PER PLAN	(I) D1.1
⊙	STORM DRAIN INLET (DI), SIZE PER PLAN	(F) D1.1
⊙	SANITARY SEWER CLEANOUT (SSCO), SIZE PER PLAN	(H) D1.1
⊙	CLEANOUT IN SYNTHETIC TURF (COIT), SIZE PER PLAN	(E) D1.1
⊙	CLEANOUT IN BIORETENTION AREA (COIT), SIZE PER PLAN	(A) D1.2
⊙	OVERFLOW RISER (OFR) WITH GRATE/STANDPIPE AT BIORETENTION AREA, SIZE PER PLAN	(C) D1.2
---	BOTTOM OF BIORETENTION AREA	(D) D1.2
---	SOLID WALL STORM DRAIN, SIZE PER PLAN	(S, D) D1.1
---	DOMESTIC WATER LINE, SIZE PER PLAN	(S, D) D1.1
---	SANITARY SEWER LINE, SIZE PER PLAN	(S, D) D1.1
---	PERFORATED SUBDRAIN LINE, SIZE PER PLAN	(N) D1.1
---	DOMESTIC WATER GATE VALVE	(A, B) D6.1
(E)	EXISTING	
CB	CATCH BASIN	
DB	DRAINAGE BUBBLER	(E) D1.2
INV	INVERT	
JB	JUNCTION BOX	
RIM	RIM ELEVATION	
LF	LINEAR FEET	
S=0.5%	SLOPE	
MIN.	MINIMUM	
(A)	DOMESTIC WATER POINT OF CONNECTION. CONTRACTOR TO VERIFY LOCATION PRIOR TO INITIATING DRAINAGE IMPROVEMENTS.	
(B)	DOMESTIC WATER CONNECTION TO DRINKING FOUNTAIN	
(C)	SANITARY SEWER POINT OF CONNECTION. CONTRACTOR TO VERIFY LOCATION AND INVERT ELEVATION PRIOR TO INITIATING DRAINAGE IMPROVEMENTS. ANY DISCREPANCY TO BE PROVIDED TO DISTRICT IN WRITING.	
(D)	SANITARY SEWER CONNECTION TO DRINKING FOUNTAIN	
(E)	STORM DRAIN POINT OF CONNECTION. CONTRACTOR TO VERIFY LOCATION AND INVERT ELEVATION PRIOR TO INITIATING DRAINAGE IMPROVEMENTS. ANY DISCREPANCY TO BE PROVIDED TO DISTRICT IN WRITING.	

CONSULTANT

STAMP

KEYMAP

SHEET TITLE

DRAINAGE AND UTILITY PLAN - BASEBALL FIELD

PROJECT NAME

HIRAM JOHNSON HIGH SCHOOL GOLF PRACTICE FACILITY, VARSITY BASEBALL AND SOFTBALL FIELDS


PROJECT ADDRESS

**6879 14TH AVENUE
SACRAMENTO, CA 95820**

SUBMITTAL	DATE
DD 50% SUBMITTAL	04/15/22
100% DSA SUBMITTAL	05/27/22
DSA BACK CHECK	08/11/22
DSA ADDENDUM SUBMITTAL	09/16/22



NO.	REVISIONS	DATE
1	ADDENDUM	09/16/22

DRAWN BY: DK
CHECKED BY: MB/CS
DATE ISSUED: 09/16/2022
SCALE: 1" = 20'-0"
PROJ. NO.: 2203200
SHEET NO.: L5.1

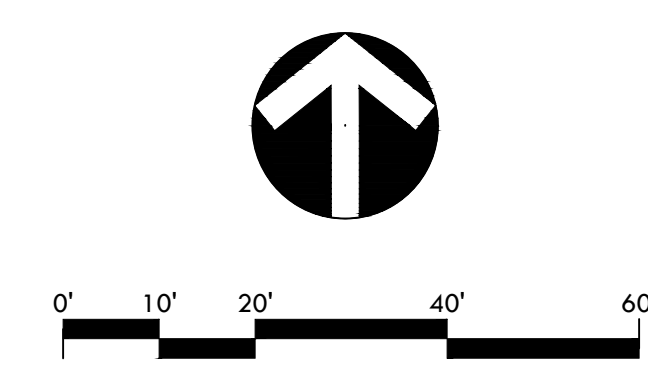

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DRAWING NAME: I:\Projects\2022\2203200 - Hiram Johnson Golf Baseball Softball\CAD\DRN.dwg
 PLOT DATE: 09-15-22 PLOTTED BY: station27

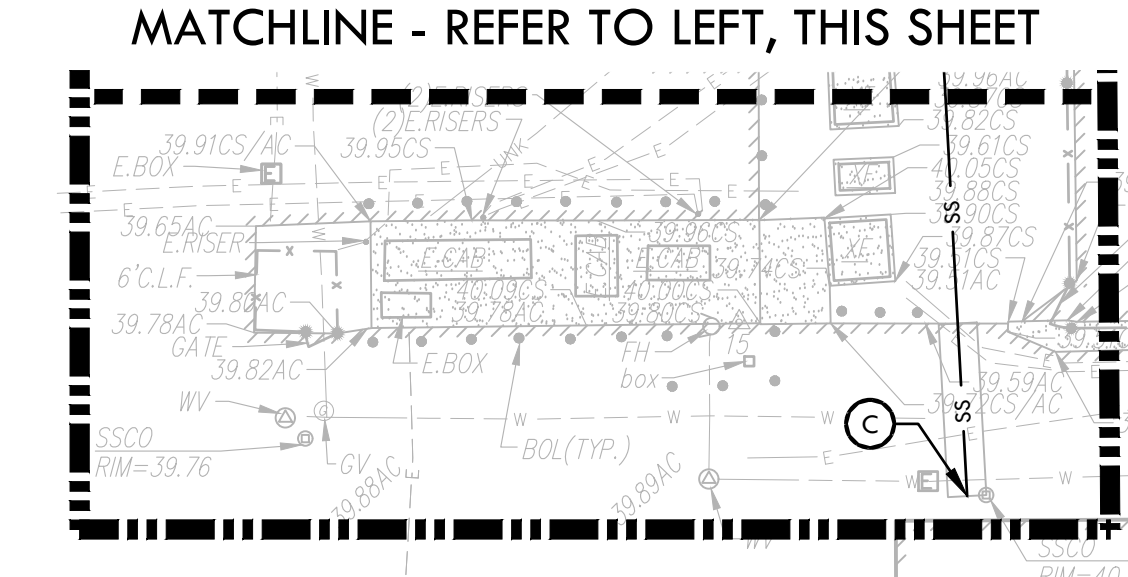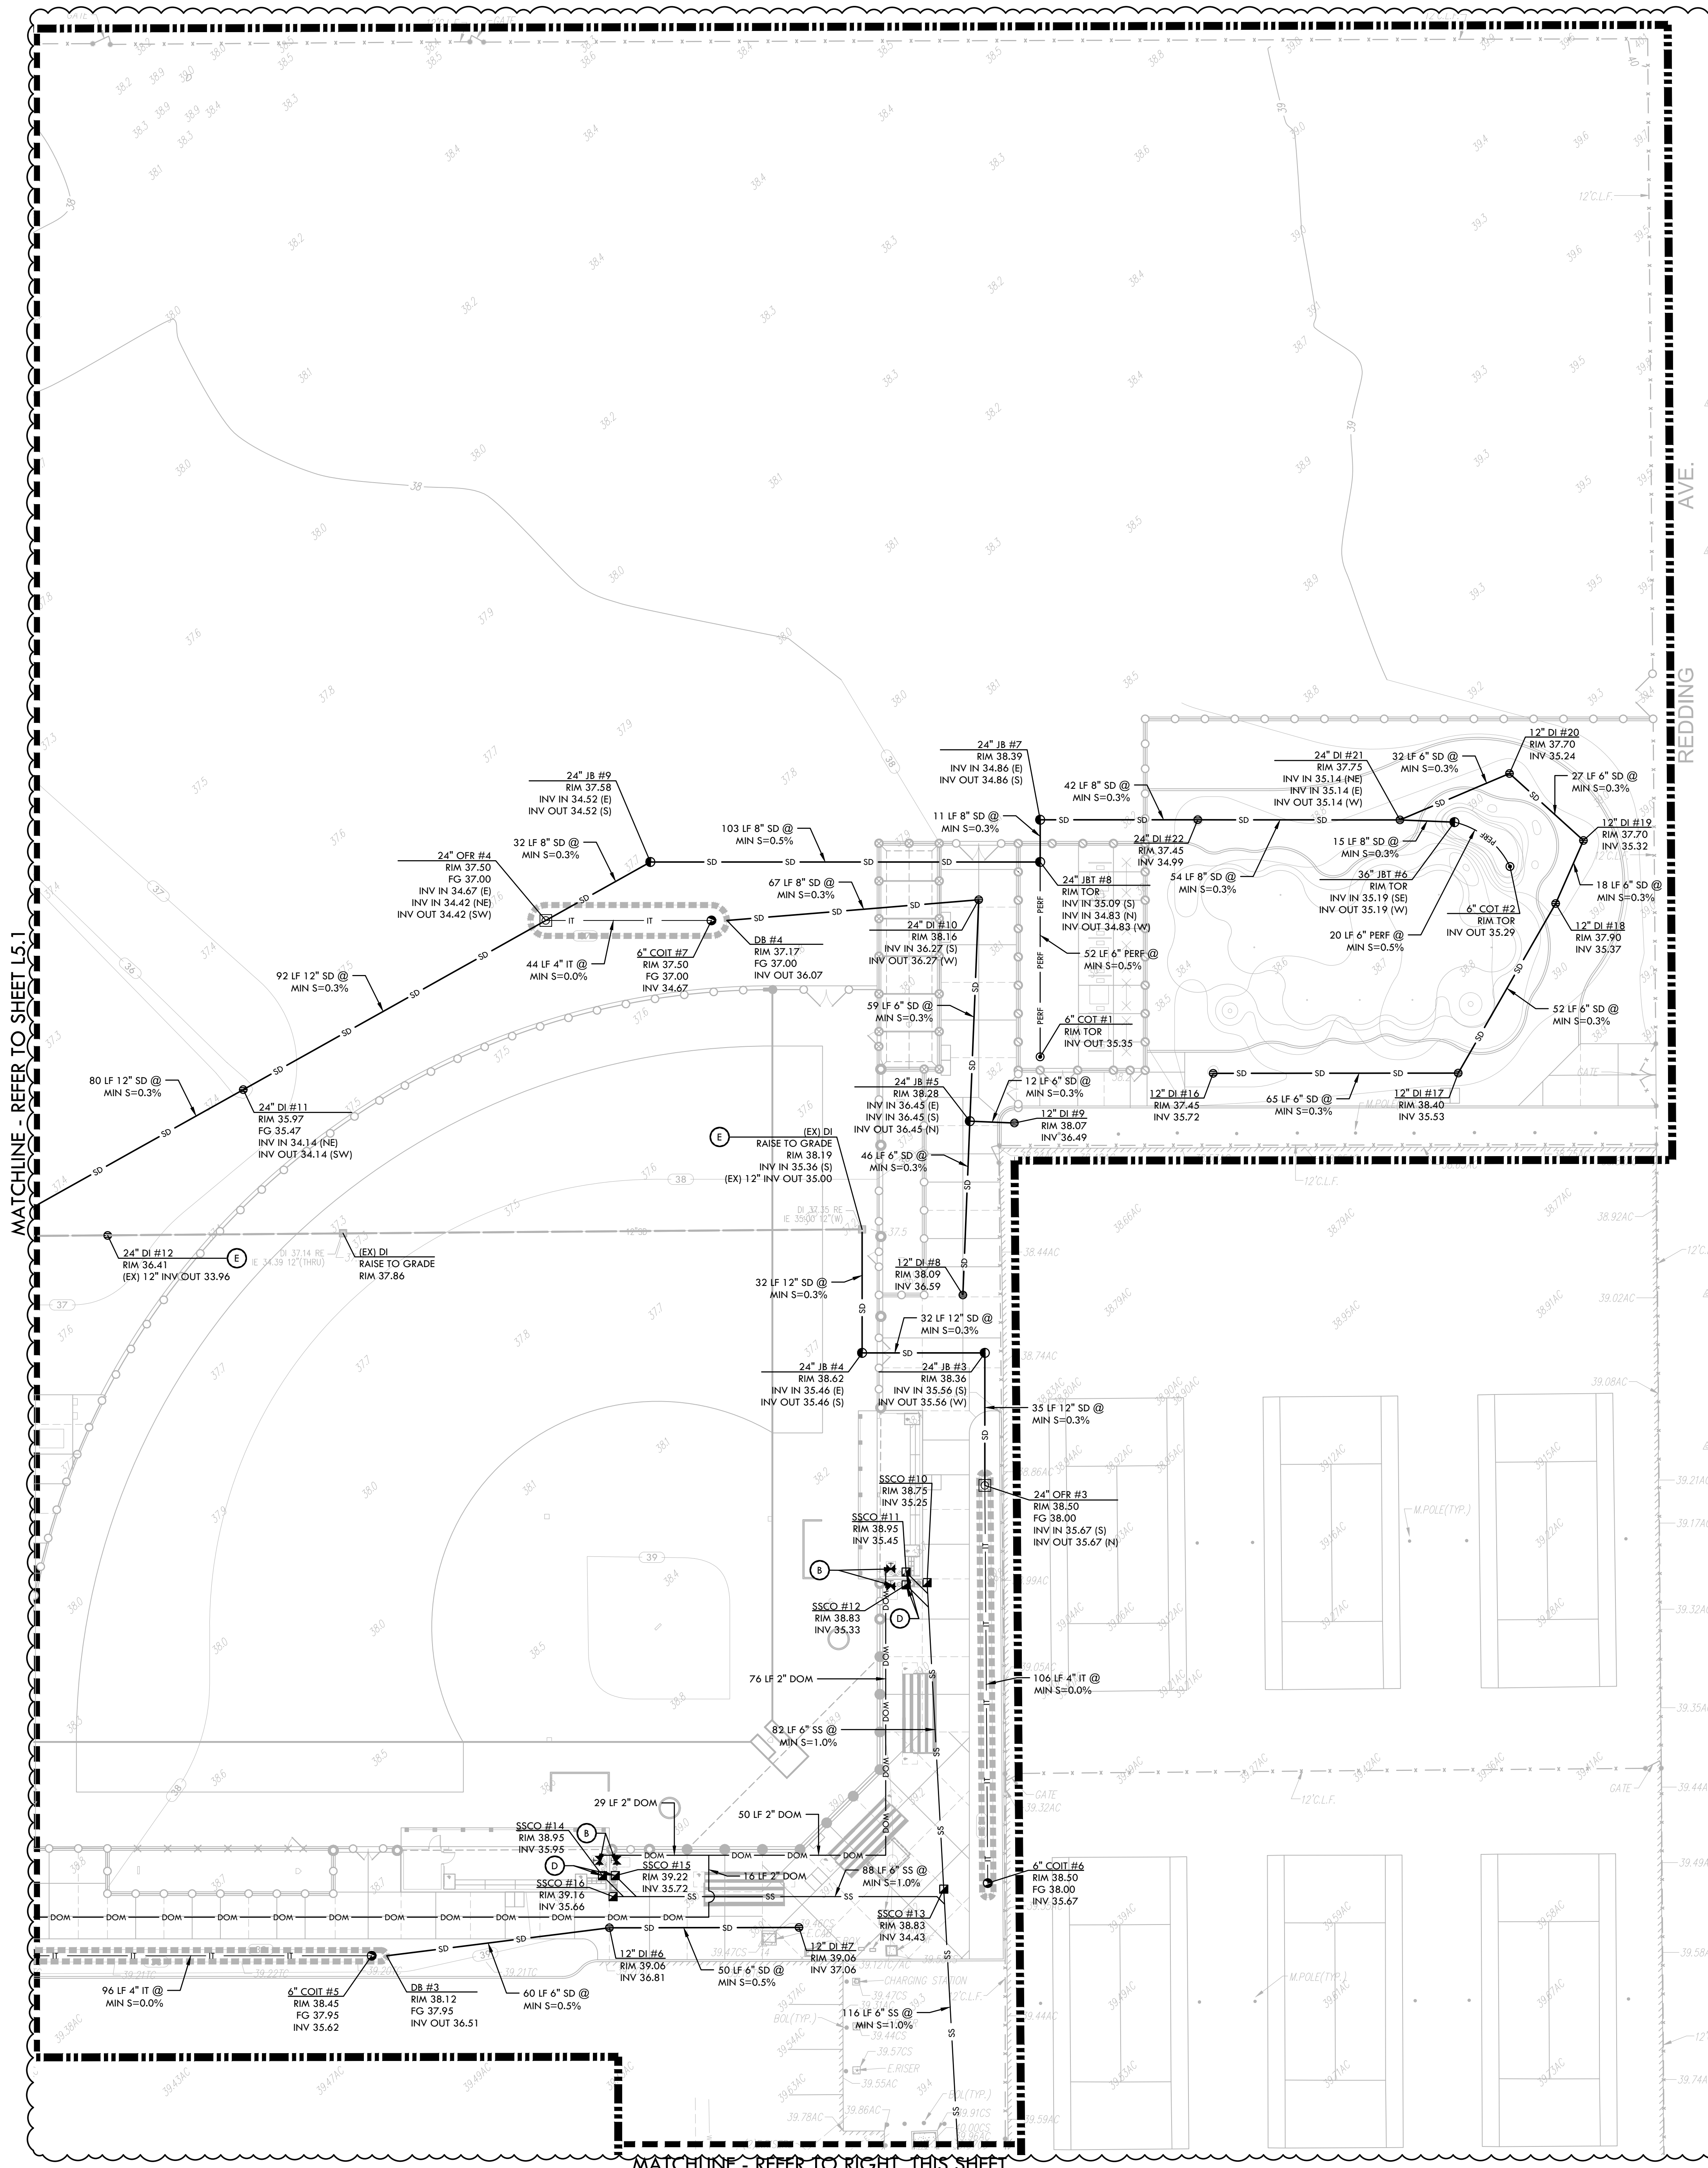

DRAINAGE & UTILITY NOTES

- THE CONTRACTOR SHALL VERIFY THE LOCATIONS OF ALL EXISTING UTILITIES, STRUCTURES, AND SERVICES BEFORE COMMENCING WORK. THE LOCATIONS OF UTILITIES, STRUCTURES, AND SERVICES SHOWN IN THE CONTRACT DOCUMENTS SHALL BE DEEMED TO BE APPROXIMATIONS ONLY. ALL DISCREPANCIES BETWEEN WHAT IS SHOWN AND THE ACTUAL FIELD CONDITIONS SHALL BE REPORTED TO THE DISTRICT REPRESENTATIVE. THE CONTRACTOR SHALL CONTACT LINER GROUND SERVICE ALERT (LSA) AT (800) 227-2200 PRIOR TO ANY DEMOLITION OR EXCAVATION. UPON COMPLETION OF USA MARKING OPERATIONS, CONTRACTOR SHALL RECORD ALL UTILITY MARKINGS ON A SEPARATE SET OF DRAWINGS. THIS SET SHALL BE KEPT ON-SITE FOR REFERENCE FOR DURATION OF CONTRACT.
- ALL EXISTING DRAINAGE STRUCTURES, BOXES, UTILITY VAULTS ETC. TO REMAIN, SHALL BE BROUGHT TO FINAL FINISH GRADE PRIOR TO FINAL SURFACE TREATMENT.
- THE CONTRACTOR IS TO PROTECT DRAINAGE SYSTEM FROM DEBRIS, INCLUDING SOIL, ROCK MATERIAL, AND TRASH FROM ENTERING THE PIPE DURING CONSTRUCTION. CONTRACTOR SHALL AVOID PLACING CONSTRUCTION VEHICLES OVER INSTALLED DRAINAGE TRENCHES TO PREVENT CRUSHING OF PIPE.
- COORDINATE ALL SLEEVING AND UTILITY LOCATIONS AS SHOWN ON THE PLANS AND DETAILS CONTAINED WITHIN THESE CONTRACT DOCUMENTS.
- THE CONTRACTOR IS TO ENSURE THAT ALL REMAINING ACTIVE AND NEW DRAINAGE AND UTILITY LINES ARE PROTECTED AND UNDAMAGED FROM TRENCHING AND FOOTING EXCAVATIONS FOR NEW FOOTINGS, PARTICULARLY FOR NEW FENCING AND WALLS.
- ALL ABANDONED STORM LINES SHALL REMAIN IN PLACE UNLESS IN CONFLICT WITH PROPOSED DRAINAGE, UTILITY, OR SUBGRADING OPERATIONS, IN WHICH CASE ABANDONED PIPE IN CONFLICT SHALL BE REMOVED. REMAINING ABANDONED STORM PIPE SHALL BE SEALED WITH APPROPRIATELY SIZED CONCRETE CAP (3 SACK MIX) 0" ENVELOPE OUTSIDE AND INSIDE DIAMETER OF PIPE.
- PRIOR TO ALL DRAINAGE AND UTILITY WORK, CONTRACTOR SHALL BE RESPONSIBLE FOR VERIFYING ALL POTENTIAL DRAINAGE CONNECTIONS AND EXISTING UTILITY BY POTHOLES. IN ADDITION, ALL DOWNSTEAM CONNECTIONS TO EXISTING STRUCTURES SHALL BE THE START OF THESE OPERATIONS, AND GRADES SHALL BE VERIFIED.
- WHEN WORK HAS TO OCCUR UNDER THE DRIPLINE OF EXISTING TREES NOT SCHEDULED FOR REMOVAL, THE CONTRACTOR SHALL USE ALL POSSIBLE CARE TO AVOID INJURY TO THE TREES AND TREE ROOTS. GRADE IN LINES RADIAL TO THE EXISTING TREES RATHER THAN TANGENTIAL. ALL PARTIAL CUTS OR TEARS THROUGH ROOTS TWO INCHES IN DIAMETER AND LARGER SHALL BE CUT CLEAN. TRENCHES ADJACENT TO TREES SHALL BE FILLED WITHIN 24 HOURS AFTER EXCAVATION, BUT WHERE THIS IS NOT POSSIBLE, THE SIDE OF THE TRENCH ADJACENT TO THE TREE, AND ANY EXPOSED ROOTS SHALL BE KEPT SHADED AND MOIST WITH DAMPENED BURLAP OR CANVAS.
- ALL DRAIN LINES LEAVING COMBOS, WATER CANNONS AND QUICK COUPLERS SHALL BE DAYLIGHTING TO NEAREST SUBDRAIN TRENCH.


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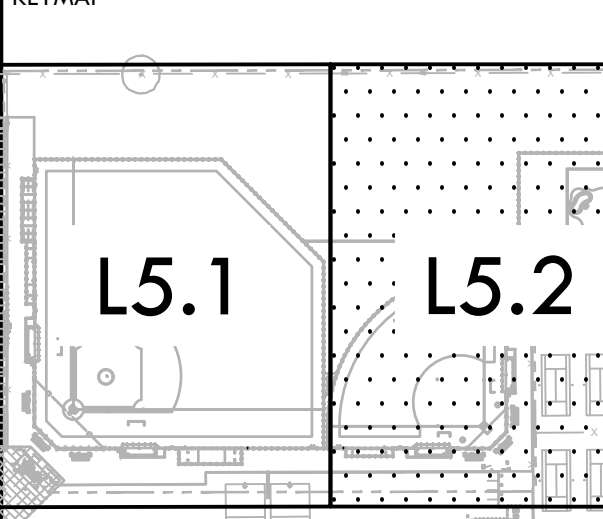
STAMP

 REGISTERED LANDSCAPE ARCHITECT
 STATE OF CALIFORNIA
 EXPIRATION DATE: JULY 2023

CONSULTANT

DRAINAGE & UTILITY LEGEND

SYM	DESCRIPTION	DETAIL NUMBER	SHEET NUMBER
---	LIMIT OF WORK		
⊙	JUNCTION BOX (JB), SIZE PER PLAN	F	D11
⊙	JUNCTION BOX IN SYNTHETIC TURF (JB#), SIZE PER PLAN	I	D11
⊙	STORM DRAIN INLET (DI), SIZE PER PLAN	F	D11
⊙	SANITARY SEWER CLEANOUT (SSCO), SIZE PER PLAN	H	D11
⊙	CLEANOUT IN SYNTHETIC TURF (COT), SIZE PER PLAN	E	D11
⊙	CLEANOUT IN BIORETENTION AREA (COTI), SIZE PER PLAN	A	D12
⊙	OVERFLOW RISER (OFR) WITH GRATE/STANDPIPE AT BIORETENTION AREA, SIZE PER PLAN	C	D12
---	BOTTOM OF BIORETENTION AREA	D	D12
---	SOLID WALL STORM DRAIN, SIZE PER PLAN	B, D	D11
---	DOMESTIC WATER LINE, SIZE PER PLAN	C, D	D11
---	SANITARY SEWER LINE, SIZE PER PLAN	B, D	D11
---	PERFORATED SUBDRAIN LINE, SIZE PER PLAN	N	D11
---	DOMESTIC WATER GATE VALVE	A, B	D6-1
(E)	EXISTING		
CB	CATCH BASIN		
DB	DRAINAGE SUBBLER	E	D12
INV	INVERT		
JB	JUNCTION BOX		
RIM	RIM ELEVATION		
LF	LINEAR FEET		
S=0.5%	SLOPE		
MIN.	MINIMUM		
(A)	DOMESTIC WATER POINT OF CONNECTION. CONTRACTOR TO VERIFY LOCATION PRIOR TO INITIATING DRAINAGE IMPROVEMENTS.		
(B)	DOMESTIC WATER CONNECTION TO DRINKING FOUNTAIN		
(C)	SANITARY SEWER POINT OF CONNECTION. CONTRACTOR TO VERIFY LOCATION AND INVERT ELEVATION PRIOR TO INITIATING DRAINAGE IMPROVEMENTS. ANY DISCREPANCY TO BE PROVIDED TO DISTRICT IN WRITING.		
(D)	SANITARY SEWER CONNECTION TO DRINKING FOUNTAIN		
(E)	STORM DRAIN POINT OF CONNECTION. CONTRACTOR TO VERIFY LOCATION AND INVERT ELEVATION PRIOR TO INITIATING DRAINAGE IMPROVEMENTS. ANY DISCREPANCY TO BE PROVIDED TO DISTRICT IN WRITING.		

KEYMAP


SHEET TITLE
DRAINAGE AND UTILITY PLAN - SOFTBALL FIELD AND GOLF


PROJECT NAME
HIRAM JOHNSON HIGH SCHOOL GOLF PRACTICE FACILITY, VARSITY BASEBALL AND SOFTBALL FIELDS


PROJECT ADDRESS
6879 14TH AVENUE SACRAMENTO, CA 95820

SUBMITTAL	DATE
DD 50% SUBMITTAL	04/15/22
100% DSA SUBMITTAL	05/27/22
DSA BACK CHECK	08/11/22
DSA ADDENDUM SUBMITTAL	09/16/22

NO.	REVISIONS	DATE
1	ADDENDUM	09/16/22

DRAWN BY: DK
 CHECKED BY: MB/CS
 DATE ISSUED: 09/16/2022
 SCALE: 1" = 20'-0"
 PROJ. NO.: 2203200
 SHEET NO.: **L5.2**

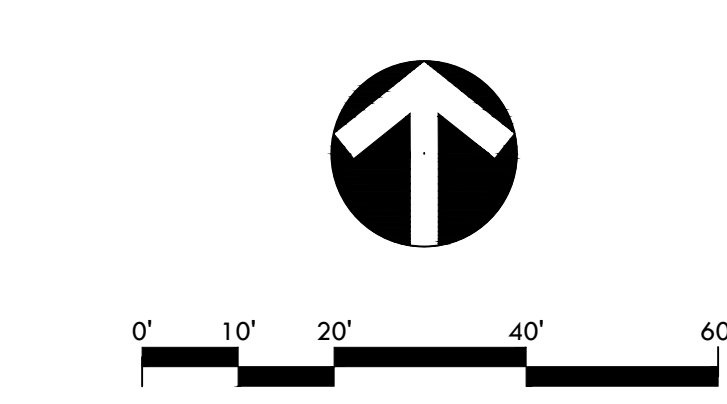

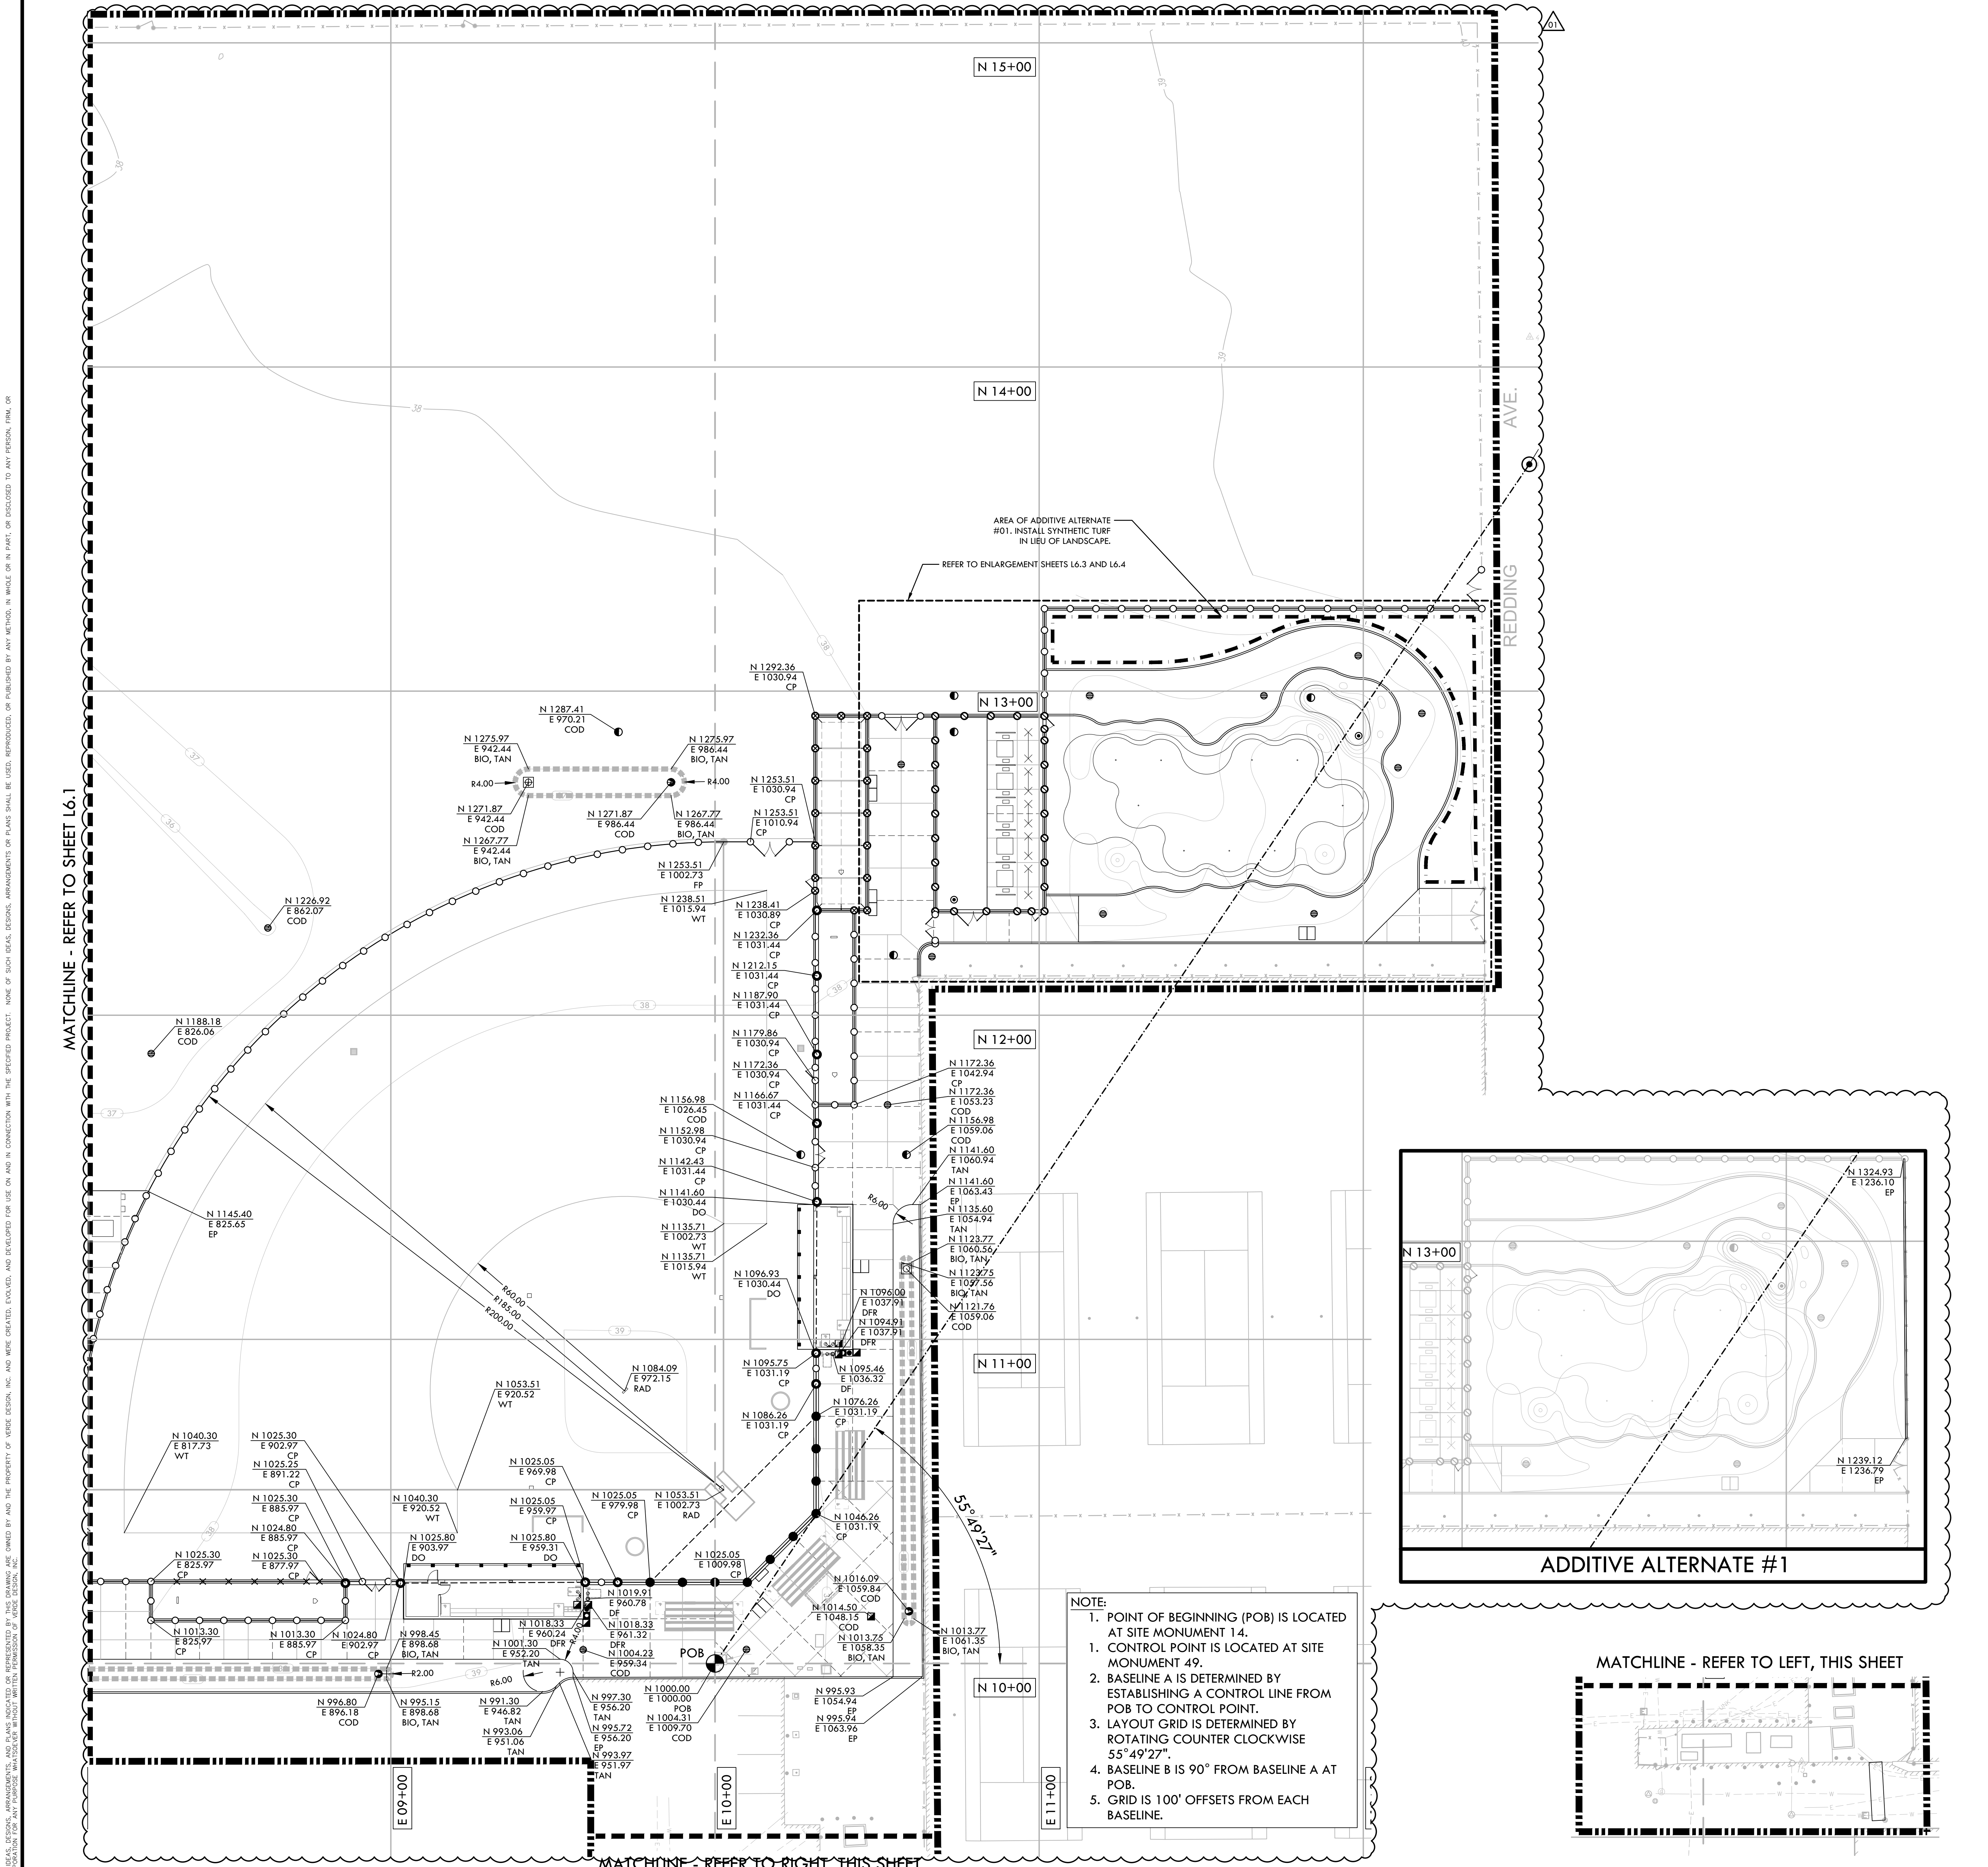

LAYOUT NOTES

1. THE CONTRACTOR SHALL COORDINATE ALL CONSTRUCTION ELEMENTS INCLUDING UTILITY LOCATIONS AND REQUIRED SLEEVING PRIOR TO INSTALLATION. VERIFY CRITICAL DIMENSIONS, REFERENCE POINT LOCATIONS AND CONSTRUCTION CONDITIONS PRIOR TO INITIATING CONSTRUCTION. TEMPORARY BENCHMARKS OR REFERENCE POINTS SHALL BE SET BY THE CONTRACTOR AS NECESSARY. NOTIFY THE OWNER'S REPRESENTATIVE IMMEDIATELY SHOULD DISCREPANCY ARISE AND REDIRECT WORK TO AVOID DELAYS.
2. ALL DIMENSIONS SHALL BE VERIFIED IN FIELD AND CHALKED, STRING-LINED OR FLAGGED BY THE CONTRACTOR PRIOR TO CONSTRUCTION. ANY MINOR ADJUSTMENTS MADE TO ACHIEVE OVERALL DESIGN LAYOUT SHALL BE ACCEPTED BY THE OWNER PRIOR TO CONSTRUCTION.
3. LAYOUT IS BASED ON THE POINT(S) OF BEGINNING (P.O.B.) AND BASELINE(S) OR GRID SYSTEM AS SHOWN. DIMENSIONS SHOWN ARE ROUNDED TO THE NEAREST INCH.
4. ALL LAYOUT AND GRADES SHALL BE COMPLETED BY A LICENSED SURVEYOR.
5. SURVEY PROVIDED BY: WARREN CONSULTING ENGINEERS, INC. (FIELD COMPLETION DATE: 02/25/22, FINAL ISSUED DATE: 02/28/22)
 5.1. ELEVATIONS SHOWN HEREON ARE BASED UPON MAG NAIL WITH CITY WASHER IN SIDEWALK JOINT AT 6900 14TH AVENUE, BENCHMARK NO. 318-82C, ELEVATION: 38.544 (NAV088) DATUM.




LAYOUT LEGEND

SYM	DESCRIPTION
	POINT OF BEGINNING - LOCATED ON SHEET L6.2
	ANCHOR POINT FOR CONTROL LINE - LOCATED ON SHEET L6.3
	RADIUS POINT / CENTER MARK
	PROPOSED ANGLE BETWEEN ELEMENTS
	ALIGN EDGES OF ELEMENTS
	DISTANCE BETWEEN ELEMENTS
	CENTER LINES
	BASELINE
	CONTROL LINE
	NORTHING/EASTING LAYOUT COORDINATE CALLOUT
	CENTER OF DRAINAGE STRUCTURE
	CENTER OF CONTROL POINT
	CENTER OF POST
	CURB
	EDGE OF DUGOUT
	CENTER OF DRINKING FOUNTAIN RAIL
	EDGEBAND
	EDGE OF PAVEMENT
	CENTER OF FOUL POST
	CENTER OF FLAG POST
	CENTER OF GOLF CUP
	CENTER OF LIGHT POLE
	POINT OF BEGINNING FOR GRID LAYOUT
	RADIUS POINT
	CENTER OF SCOREBOARD FOOTING
	TANGENT POINT
	EDGE OF WARNING TRACK

STAMP

CONSULTANT

KEYMAP

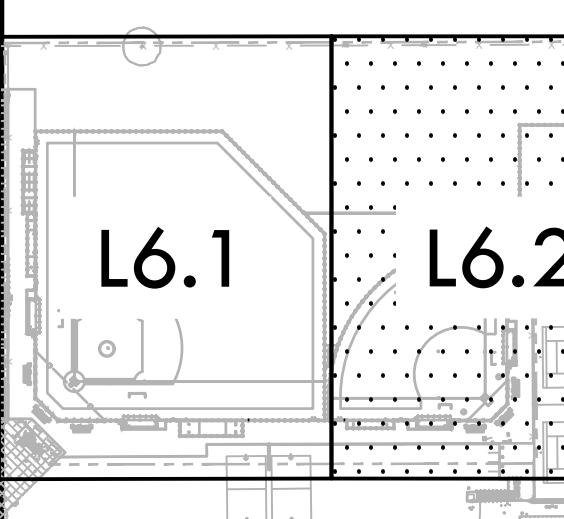

SHEET TITLE

LAYOUT PLAN - SOFTBALL FIELD AND GOLF

PROJECT NAME

HIRAM JOHNSON HIGH SCHOOL GOLF PRACTICE FACILITY, VARSITY BASEBALL AND SOFTBALL FIELDS


PROJECT ADDRESS


**6879 14TH AVENUE
SACRAMENTO, CA 95820**

SUBMITTAL	DATE
DD 50% SUBMITTAL	04/15/22
100% DSA SUBMITTAL	05/27/22
DSA BACK CHECK	08/11/22
DSA ADDENDUM SUBMITTAL	09/16/22

NO.	REVISIONS	DATE
▲	ADDENDUM	09/16/22

DRAWN BY: AC
 CHECKED BY: MB/CS
 DATE ISSUED: 09/16/2022
 SCALE: 1"=20'-0"
 PROJ. NO.: 2203200
 SHEET NO.: **L6.2**

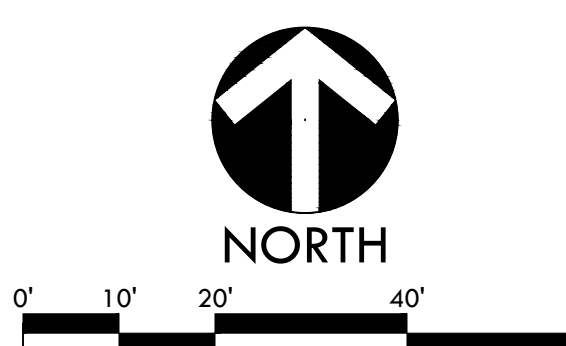

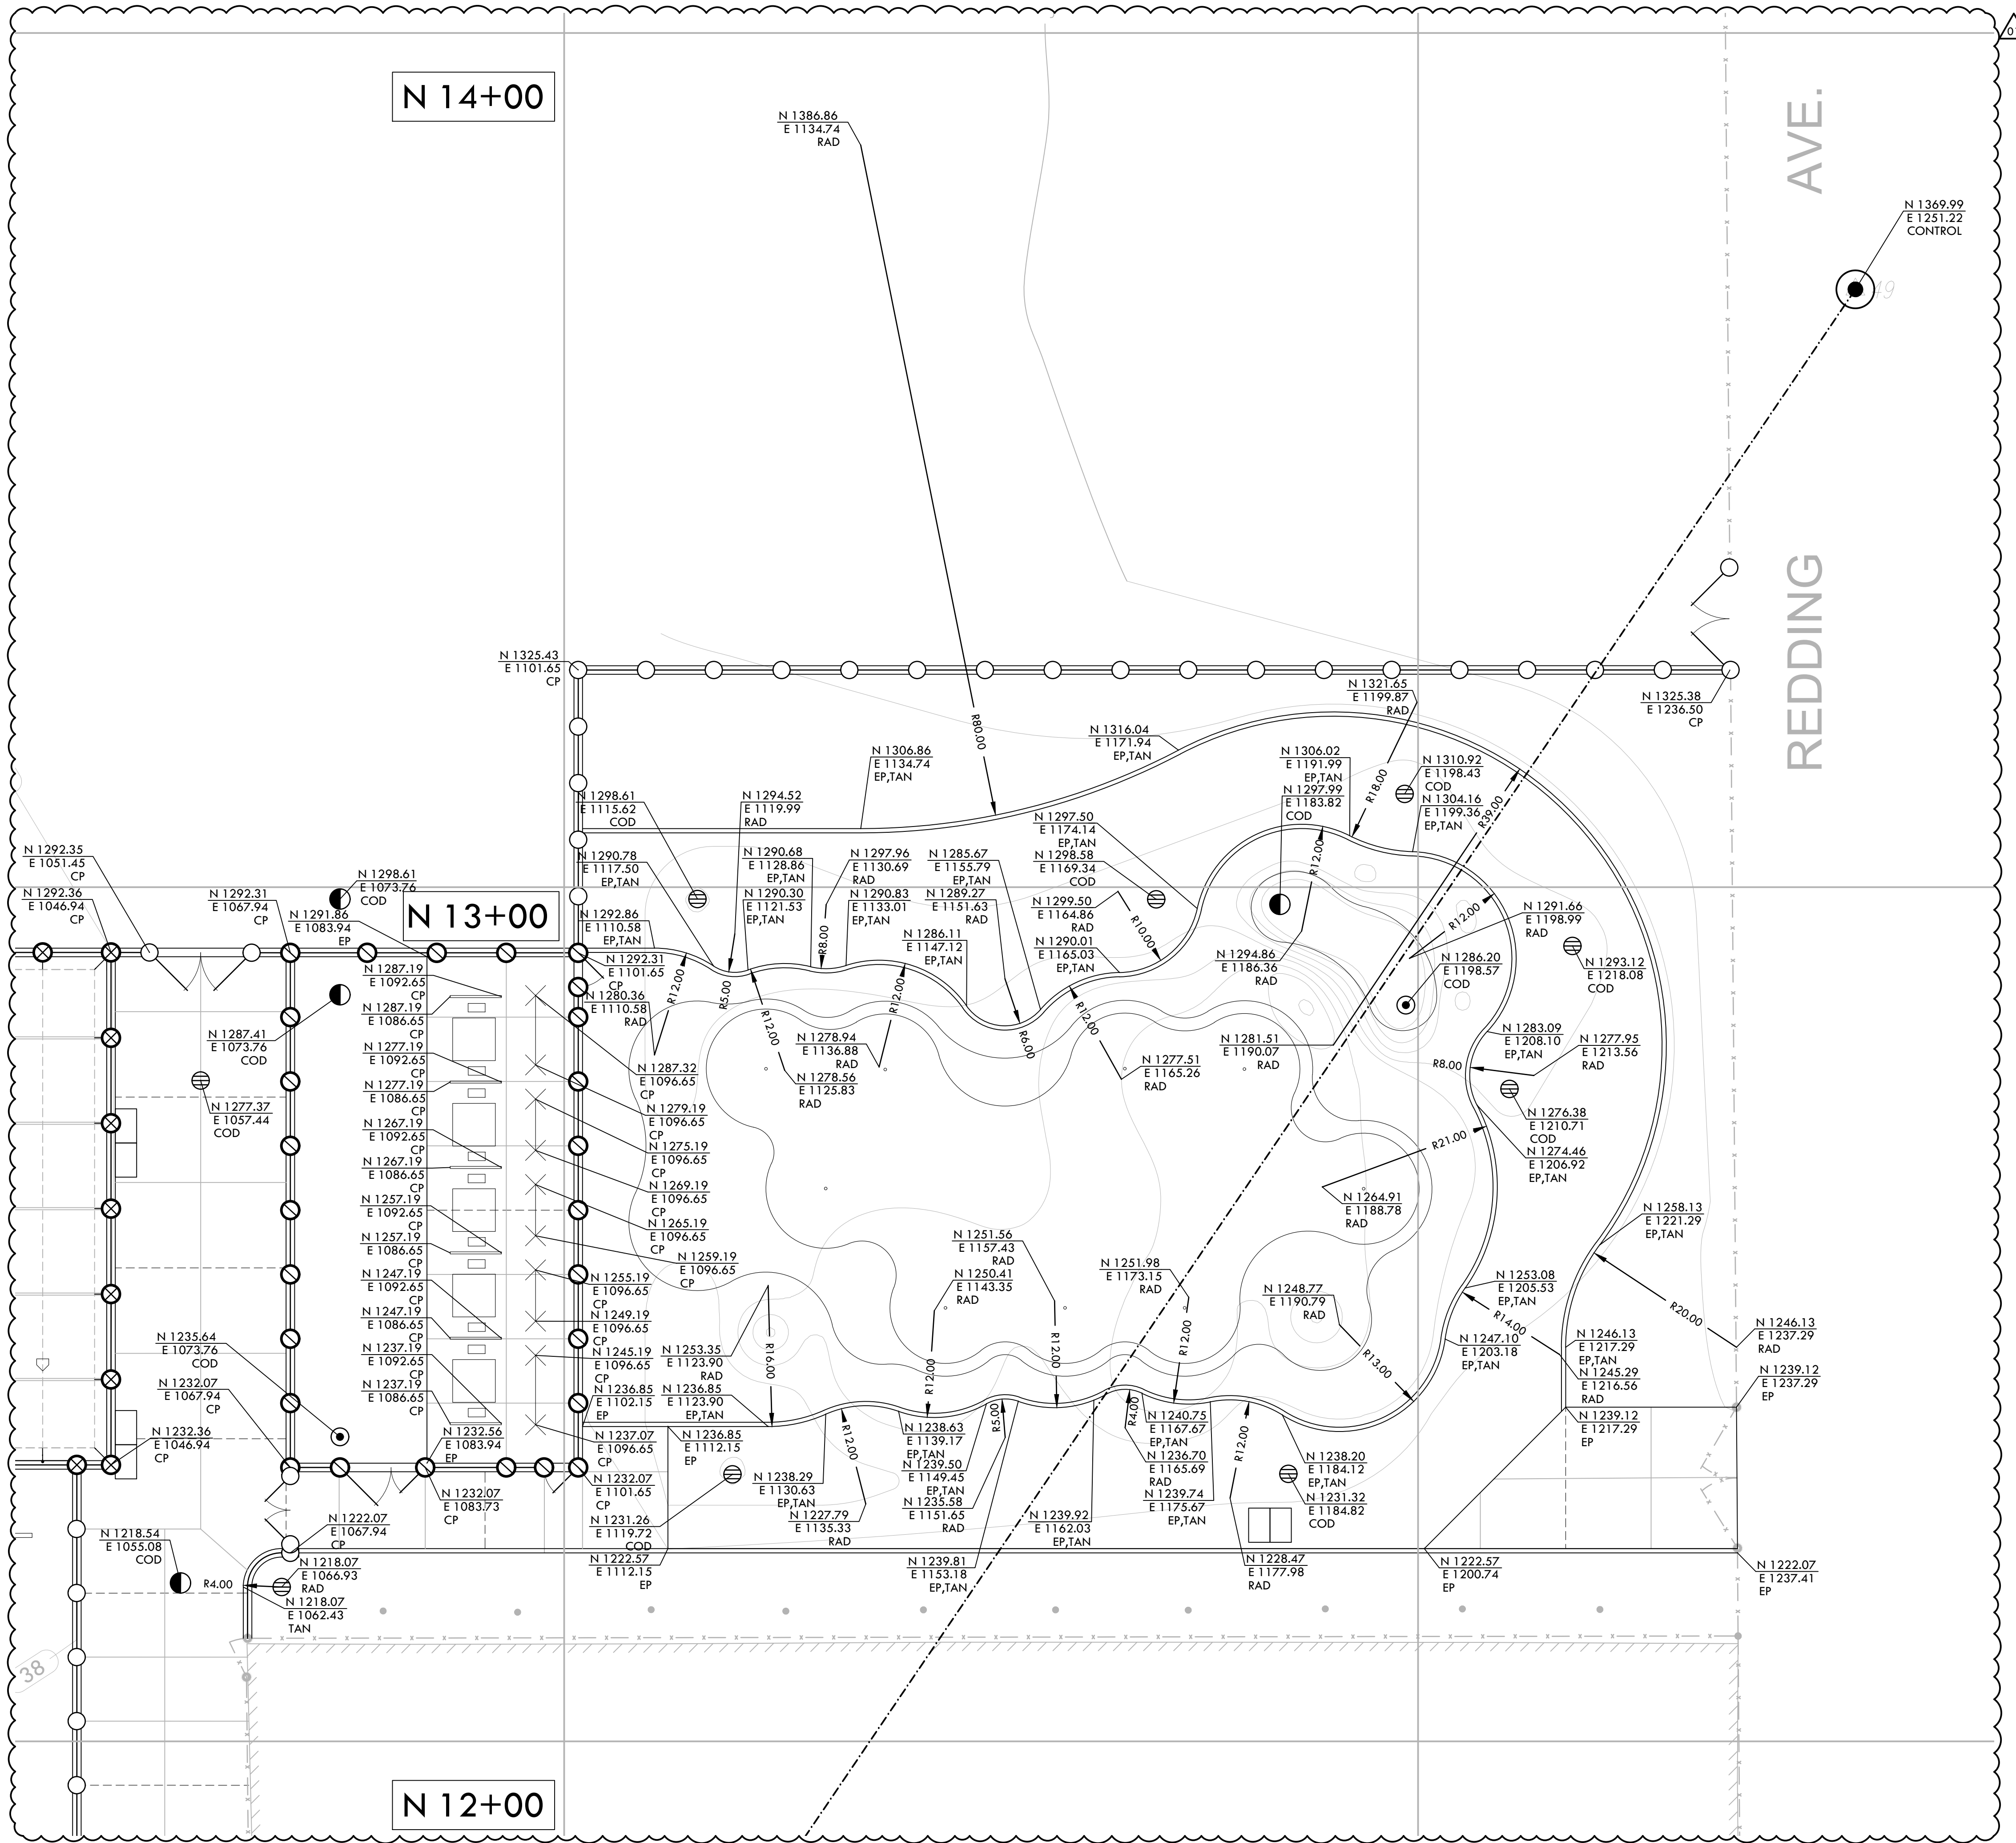

LAYOUT NOTES

1. THE CONTRACTOR SHALL COORDINATE ALL CONSTRUCTION ELEMENTS INCLUDING UTILITY LOCATIONS AND REQUIRED SLEEVING PRIOR TO INSTALLATION. VERIFY CRITICAL DIMENSIONS, REFERENCE POINT LOCATIONS AND CONSTRUCTION CONDITIONS PRIOR TO INITIATING CONSTRUCTION. TEMPORARY BENCHMARKS OR REFERENCE POINTS SHALL BE SET BY THE CONTRACTOR AS NECESSARY. NOTIFY THE OWNER'S REPRESENTATIVE IMMEDIATELY SHOULD DISCREPANCY ARISE AND REDIRECT WORK TO AVOID DELAYS.
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3. LAYOUT IS BASED ON THE POINT(S) OF BEGINNING (P.O.B.) AND BASELINE(S) OR GRID SYSTEM AS SHOWN. DIMENSIONS SHOWN ARE ROUNDED TO THE NEAREST INCH.
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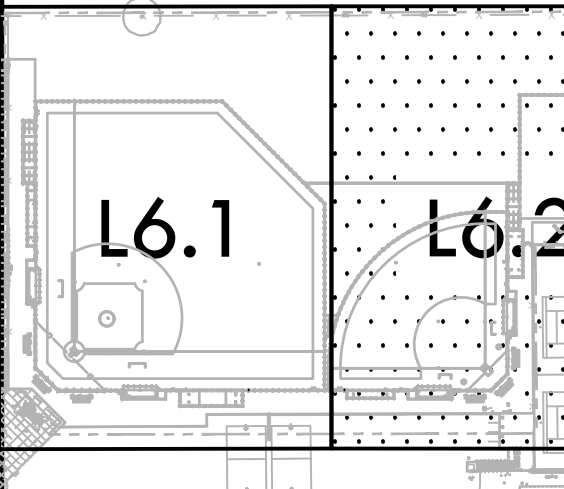


LAYOUT LEGEND

SYM	DESCRIPTION
	POINT OF BEGINNING - LOCATED ON SHEET L6.2
	ANCHOR POINT FOR CONTROL LINE - LOCATED ON SHEET L6.3
	RADIUS POINT / CENTER MARK
	PROPOSED ANGLE BETWEEN ELEMENTS
	ALIGN EDGES OF ELEMENTS
	DISTANCE BETWEEN ELEMENTS
	CENTER LINES
	BASELINE
	CONTROL LINE
	NORTHING/EASTING LAYOUT COORDINATE CALLOUT
	COD CENTER OF DRAINAGE STRUCTURE
	CON CENTER OF CONTROL POINT
	CP CENTER OF POST
	CURB
	DO EDGE OF DUGOUT
	DFR CENTER OF DRINKING FOUNTAIN RAIL
	EDGE BAND
	EP EDGE OF PAVEMENT
	FP CENTER OF FOUL POST
	FLG CENTER OF FLAG POST
	GC CENTER OF GOLF CUP
	LP CENTER OF LIGHT POLE
	POB POINT OF BEGINNING FOR GRID LAYOUT
	RAD RADIUS POINT
	SB CENTER OF SCOREBOARD FOOTING
	TAN TANGENT POINT
	WT EDGE OF WARNING TRACK

CONSULTANT

KEYMAP



SHEET TITLE

LAYOUT PLAN - GOLF ENLARGEMENT

PROJECT NAME

HIRAM JOHNSON HIGH SCHOOL GOLF PRACTICE FACILITY, VARSITY BASEBALL AND SOFTBALL FIELDS

PROJECT ADDRESS


6879 14TH AVENUE SACRAMENTO, CA 95820

SUBMITTAL	DATE
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100% DSA SUBMITTAL	05/27/22
DSA BACK CHECK	08/11/22
DSA ADDENDUM SUBMITTAL	09/16/22


NO.	REVISIONS	DATE
1	ADDENDUM	09/16/22

DRAWN BY	AC	CHECKED BY	MB/CS
DATE ISSUED	09/16/2022	SCALE	1"=10'-0"
PROJ. NO.	2203200		

SHEET NO. L6.3

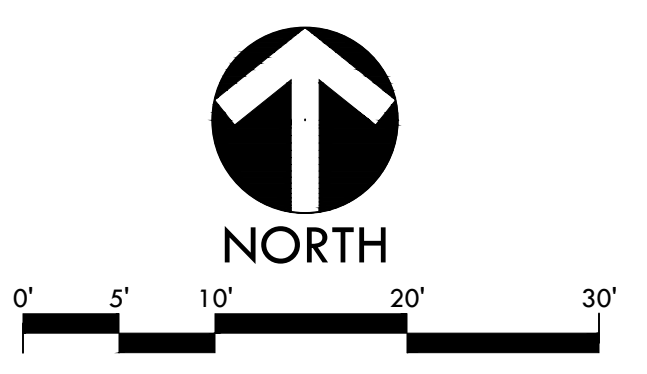


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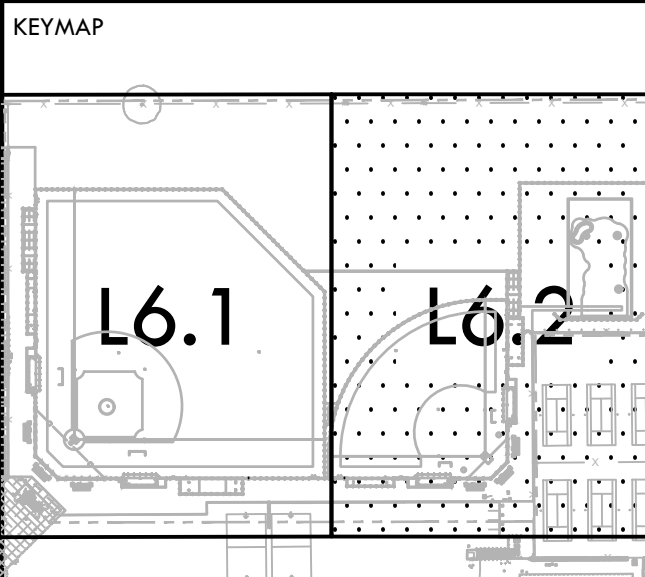
LAYOUT NOTES
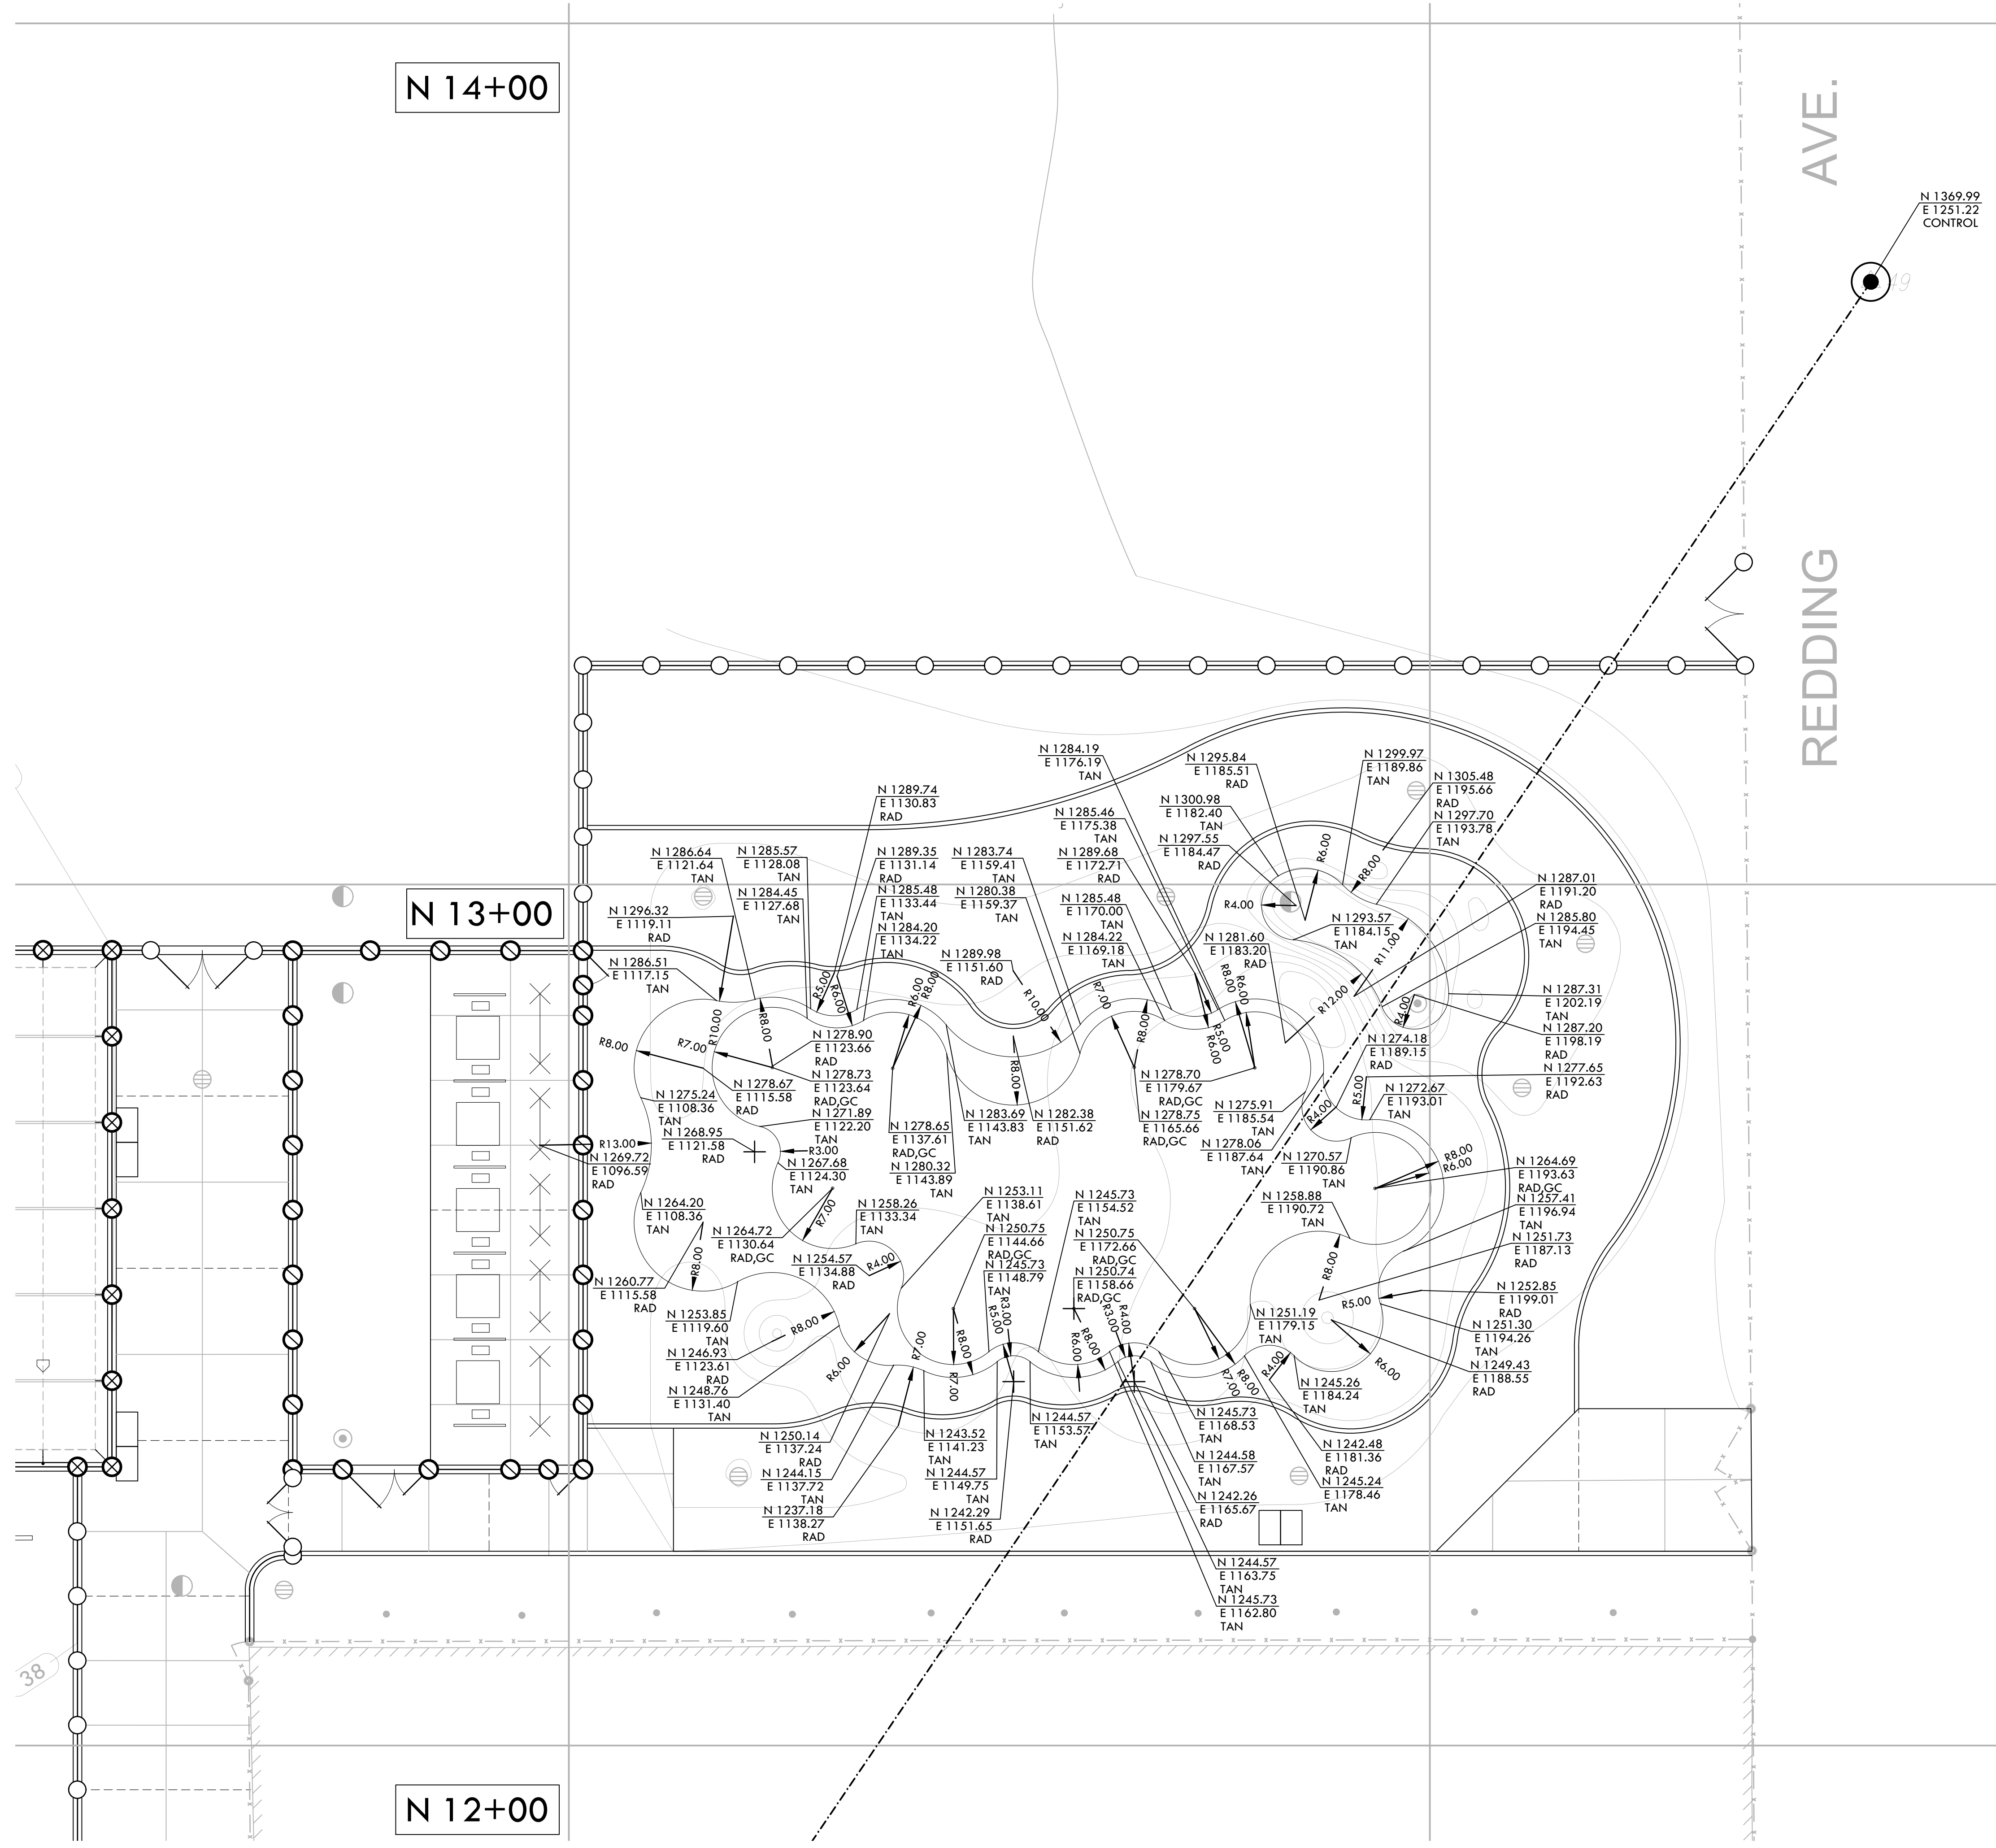
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3. LAYOUT IS BASED ON THE POINT(S) OF BEGINNING (P.O.B.) AND BASELINE(S) OR GRID SYSTEM AS SHOWN. DIMENSIONS SHOWN ARE ROUNDED TO THE NEAREST INCH.
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LAYOUT LEGEND

SYM	DESCRIPTION
	POINT OF BEGINNING - LOCATED ON SHEET L6.2
	ANCHOR POINT FOR CONTROL LINE - LOCATED ON SHEET L6.3
	RADIUS POINT / CENTER MARK
	PROPOSED ANGLE BETWEEN ELEMENTS
	ALIGN EDGES OF ELEMENTS
	DISTANCE BETWEEN ELEMENTS
	CENTER LINES
	BASELINE
	CONTROL LINE
	NORTHING/EASTING LAYOUT COORDINATE CALLOUT
	CENTER OF DRAINAGE STRUCTURE
	CENTER OF CONTROL POINT
	CENTER OF POST
	CURB
	EDGE OF DUGOUT
	CENTER OF DRINKING FOUNTAIN RAIL
	EDGE BAND
	EDGE OF PAVEMENT
	CENTER OF FOUL POST
	CENTER OF FLAG POST
	CENTER OF GOLF CUP
	CENTER OF LIGHT POLE
	POINT OF BEGINNING FOR GRID LAYOUT
	RADIUS POINT
	CENTER OF SCOREBOARD FOOTING
	TANGENT POINT
	EDGE OF WARNING TRACK

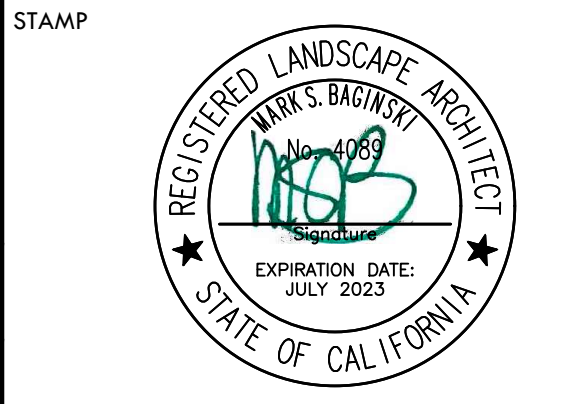

SHEET TITLE
LAYOUT PLAN - GOLF ENLARGEMENT

PROJECT NAME
HIRAM JOHNSON HIGH SCHOOL GOLF PRACTICE FACILITY, VARSITY BASEBALL AND SOFTBALL FIELDS


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DSA BACK CHECK	08/11/22
DSA ADDENDUM SUBMITTAL	09/16/22


NO.	REVISIONS	DATE
▲	ADDENDUM	09/16/22
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DRAWN BY AC	CHECKED BY MB/CS
DATE ISSUED 09/16/2022	SCALE 1"=10'-0"
PROJ. NO. 2203200	

SHEET NO.
L6.4



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MATERIAL LEGEND		
SYM	DESCRIPTION	DTL REF
19	12" WIDE TALL CURB	(O) D2.1
20	NOT USED	
21	18" EDGE BAND WITH FENCE	(G) D2.1
22	12" EDGE BAND WITH FENCE	(F) D2.1
23	24" TALL PROTECTIVE NETTING OVER 6' FENCE	(C) D3.2
24	BASEBALL BATTING CAGE	(E) D4.2
25	BASEBALL BULLPEN (1ST BASE)	(A) D4.3
26	BASEBALL BULLPEN (3RD BASE)	(G) D4.3
27	SOFTBALL BULLPEN (1ST BASE)	(A) D4.5
28	SOFTBALL BULLPEN (3RD BASE)	(H) D4.5
29	SOFTBALL BATTING CAGE	(E) D4.4
30	FENCE WITH SLATS	
31	FENCE CAP - YELLOW. REFER TO SPECIFICATIONS	
32	FENCE CAP - BLACK. REFER TO SPECIFICATIONS	
33	BACKSTOP NET HOOD LIMITS (OPTIONAL)	
34	GOLF PUTTING GREEN	(H) D5.1
35	GOLF DRIVING RANGE	(A) D5.1
36	ELECTRICAL PULL/SIGNAL BOX. REFER TO ELECTRICAL DRAWINGS.	
37	SAFETY NETTING OVER DUGOUT	(A/B) D3.1
38	18" WIDE TALL CURB	(R) D2.1
39	IRRIGATION EQUIPMENT. REFER TO IRRIGATION PLAN FOR ADDITIONAL INFORMATION.	

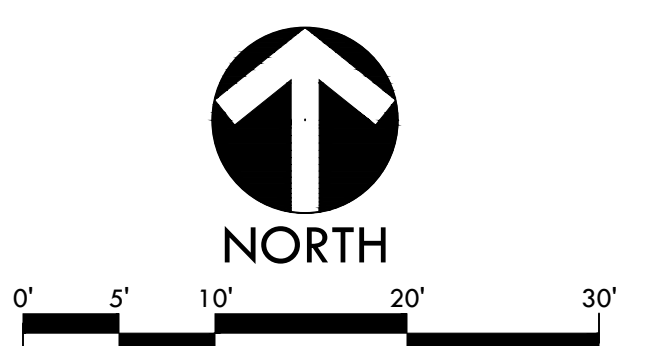MATERIAL NOTES		
1.	THE CONTRACTOR SHALL COORDINATE ALL CONSTRUCTION ELEMENTS INCLUDING UTILITY LOCATIONS AND REQUIRED SLEEPING PRIOR TO INSTALLATION. VERIFY CRITICAL DIMENSIONS, REFERENCE POINT LOCATIONS AND CONSTRUCTION CONDITIONS PRIOR TO INITIATING CONSTRUCTION. TEMPORARY BENCHMARKS OR REFERENCE POINTS SHALL BE SET BY THE CONTRACTOR AS NECESSARY. NOTIFY THE OWNER'S REPRESENTATIVE IMMEDIATELY SHOULD DISCREPANCY ARISE AND REDIRECT WORK TO AVOID DELAYS.	
2.	THE INTERFACE OF ALL PROPOSED IMPROVEMENTS TO EXISTING SITE SHALL CONFORM AND BE SMOOTH AND UNIFORM.	
3.	ALL REINFORCING AND FORMS SHALL BE SECURED IN PLACE AND ACCEPTED BY OWNER'S REPRESENTATIVE PRIOR TO PLACING ANY CONCRETE.	
4.	CONCRETE FINISHES SHALL BE AS NOTED. CONTRACTOR SHALL PROVIDE 4"x4" SAMPLES OF ALL SPECIFIED FINISHES OF CONCRETE USING THE SAME MATERIALS THAT WILL BE USED IN THE ACTUAL CONSTRUCTION FOR EACH TYPE SPECIFIED. SAMPLES SHALL BE PREPARED WELL ENOUGH IN ADVANCE OF SCHEDULED CONCRETE POUR TO ALLOW FOR REVIEW AND POSSIBLE RE-COURING OF UNACCEPTABLE SAMPLES. UNACCEPTABLE SAMPLES SHALL BE RE-PREPARED UNTIL ACCEPTED BY THE OWNER'S REPRESENTATIVE. ACCEPTED SAMPLES SHALL BE PROTECTED AND REMAIN ON SITE FOR REFERENCE UNTIL FINAL ACCEPTANCE.	
5.	ALL FENCES AND GATES SHOWN ON PLAN ARE GRAPHIC REPRESENTATIONS; REFER TO DETAILS AND SPECIFICATIONS FOR PRECISE LOCATION.	
6.	ASPHALT SHALL NOT BE INSTALLED UNTIL ALL EDGES AND SITE FURNISHING PADS ARE INSTALLED.	

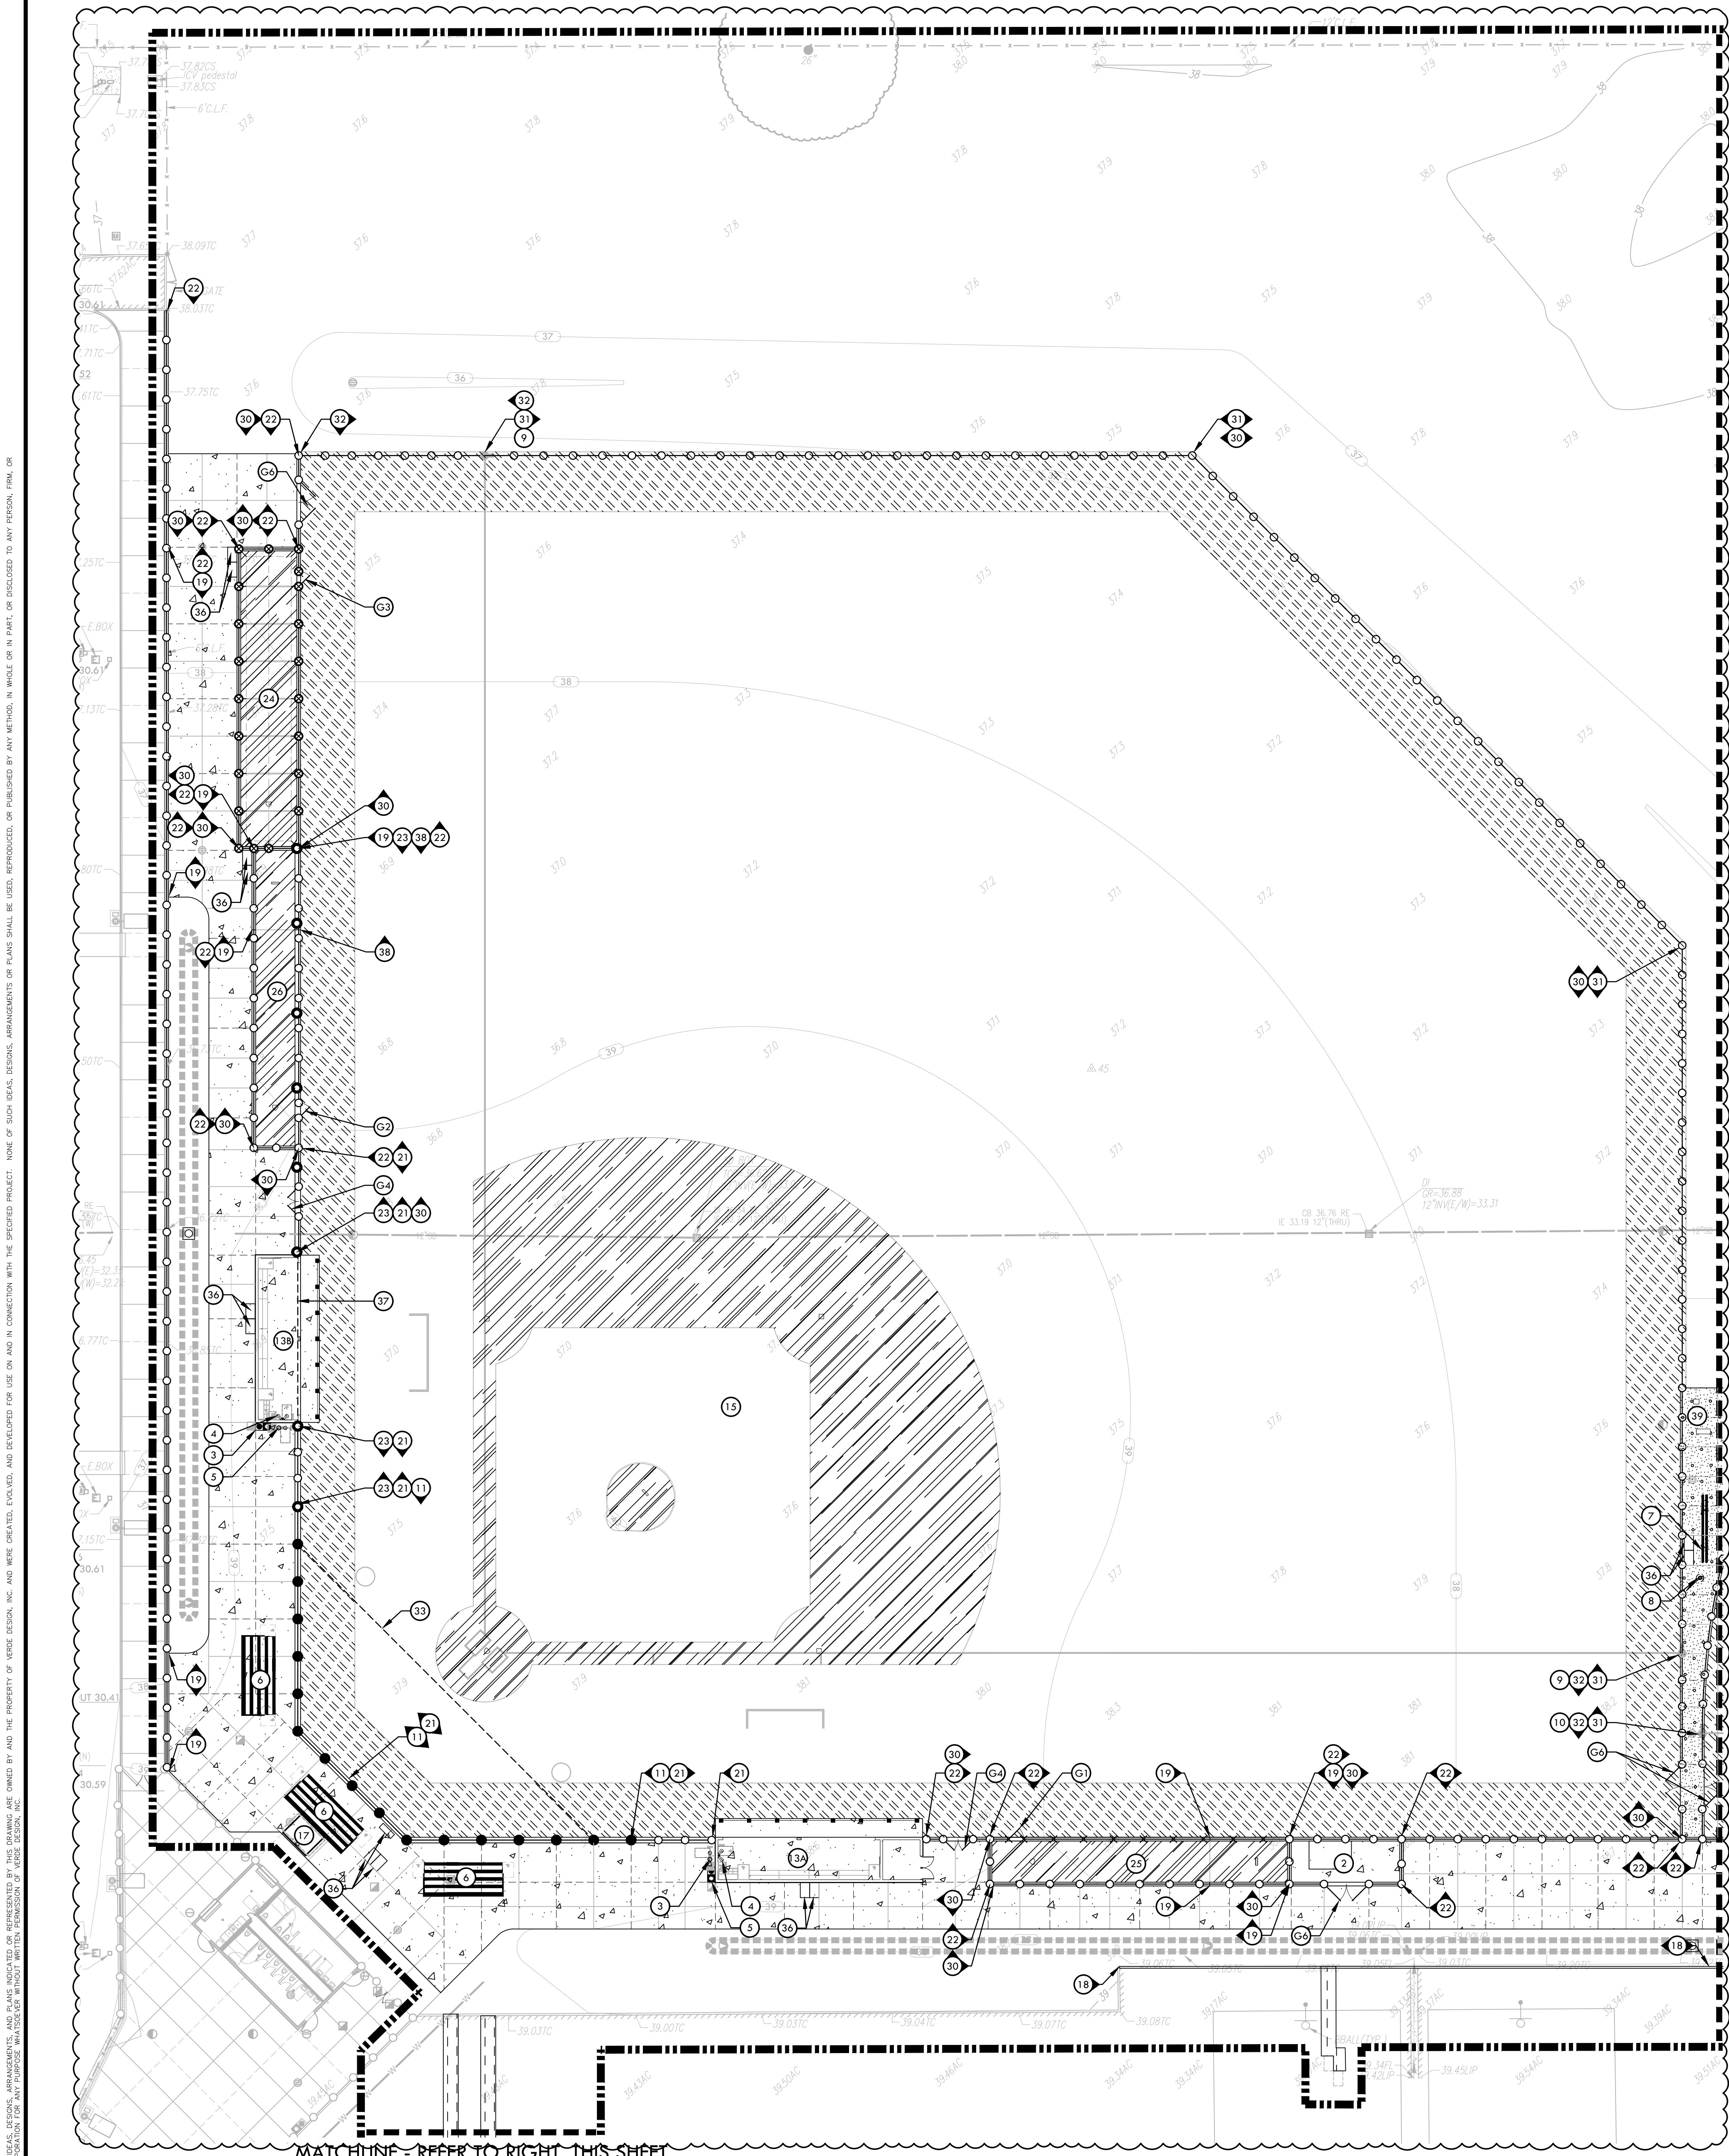MATERIAL LEGEND		
SYM	DESCRIPTION	DTL REF
(LIMIT OF WORK)	LIMIT OF WORK	
(CONCRETE PAVING - CHEMICALLY TREATED - PEDESTRIAN)	CONCRETE PAVING - CHEMICALLY TREATED - PEDESTRIAN	(A) D2.1
(CONCRETE PAVING - NON CHEMICALLY TREATED - PEDESTRIAN)	CONCRETE PAVING - NON CHEMICALLY TREATED - PEDESTRIAN	(D) D2.1
(ASPHALT PAVING - NON CHEMICALLY TREATED - VEHICULAR)	ASPHALT PAVING - NON CHEMICALLY TREATED - VEHICULAR	(P/Q) D2.1
(INFIELD FINES)	INFIELD FINES	(F) D4.1
(WARNING TRACK FINES)	WARNING TRACK FINES	(I) D4.1
(NOT USED)	NOT USED	
(SYNTHETIC TURF AT GOLF)	SYNTHETIC TURF AT GOLF	(L) D5.1
(EXPANSION JOINT SCORE JOINT)	EXPANSION JOINT SCORE JOINT	(E) D2.1
(42" CHAIN LINK FENCE)	42" CHAIN LINK FENCE	(E) D3.1
(GUARD RAIL SYSTEM)	GUARD RAIL SYSTEM	(H) D3.2
(6' CHAIN LINK FENCE)	6' CHAIN LINK FENCE	(F) D3.1
(NOT USED)	NOT USED	
(14' CHAIN LINK FENCE)	14' CHAIN LINK FENCE	(H) D3.1
(16' CHAIN LINK FENCE)	16' CHAIN LINK FENCE	(I) D3.1
(30' CHAIN LINK BACKSTOP)	30' CHAIN LINK BACKSTOP	(J) D3.1
(24' PROTECTIVE NETTING OVER 6' TALL CHAIN LINK FENCE)	24' PROTECTIVE NETTING OVER 6' TALL CHAIN LINK FENCE	(G) D3.2
(42" TALL X 4' WIDE CHAIN LINK SWING GATE - ACCESSIBLE)	42" TALL X 4' WIDE CHAIN LINK SWING GATE - ACCESSIBLE	(E) D3.1
(6' TALL X 4' WIDE CHAIN LINK SWING GATE - ACCESSIBLE)	6' TALL X 4' WIDE CHAIN LINK SWING GATE - ACCESSIBLE	(M) D3.1
(8' TALL X 4' WIDE CHAIN LINK SWING GATE WITH TRANSOM - ACCESSIBLE)	8' TALL X 4' WIDE CHAIN LINK SWING GATE WITH TRANSOM - ACCESSIBLE	(L) D3.1
(6' TALL X 8' WIDE CHAIN LINK DOUBLE SWING GATE)	6' TALL X 8' WIDE CHAIN LINK DOUBLE SWING GATE	(O) D3.1
(8' TALL X 10' WIDE DOUBLE SWING GATE - MIXED LEAF WITH TRANSOM)	8' TALL X 10' WIDE DOUBLE SWING GATE - MIXED LEAF WITH TRANSOM	(A) D3.2
(6' TALL X 12' WIDE CHAIN LINK DOUBLE SWING GATE)	6' TALL X 12' WIDE CHAIN LINK DOUBLE SWING GATE	(M) D3.2

MATERIAL LEGEND		
SYM	DESCRIPTION	DTL REF
(1)	SYNTHETIC TURF CONNECTION	(C) D5.1
(2)	ELECTRICAL EQUIPMENT CONCRETE PAD (REFER TO ELECTRICAL PLANS FOR ADDITIONAL INFORMATION).	
(3)	DRINKING FOUNTAIN	(H) D1.1
(4)	DRINKING FOUNTAIN IN DUGOUT	(M) D1.1
(5)	TRASH AND RECYCLING RECEPTACLE	(K) D2.1
(6)	PORTABLE BLEACHERS - 4 ROW. REFER TO SPECIFICATIONS	
(7)	SCOREBOARD. REFER TO STRUCTURAL DRAWINGS AND NEVCO PC DRAWINGS FOR ADDITIONAL INFORMATION.	
(8)	FLAG POLE. REFER TO STRUCTURAL DRAWINGS AND SPECIFICATIONS	
(9)	FOUL POLE AT BASEBALL	(G) D4.1
(10)	FOUL POLE AT SOFTBALL	(G) D4.1
(11)	BASEBALL BACKSTOP - WITH OPTIONAL NET HOOD, ALSO REFER TO STRUCTURAL DRAWINGS	(A) D3.3
(12)	SOFTBALL BACKSTOP - WITH OPTIONAL NET HOOD, ALSO REFER TO STRUCTURAL DRAWINGS	(B) D3.3
(13)	BASEBALL DUGOUT - 1ST BASE SIDE (HOME). REFER TO SHEET D4.6	
(13B)	BASEBALL DUGOUT - 3RD BASE SIDE (VISITOR). REFER TO SHEET D4.7	
(14)	SOFTBALL DUGOUT - 3RD BASE SIDE (HOME). REFER TO SHEET D4.9	
(14B)	SOFTBALL DUGOUT - 1ST BASE SIDE (VISITOR). REFER TO SHEET D4.8	
(15)	BASEBALL INFIELD	(A) D4.3
(16)	SOFTBALL INFIELD	(A) D4.4
(17)	ELEVATED SCORER'S TABLE (SPORTSFIELD SPECIALTIES MODEL #188 CUSTOM FAB CHAIRS OR APPROVED EQUAL ANY DEVIATION COORDINATE SIZE AND LOCATION)	
(18)	6" WIDE EDGE BAND	(M) D2.1

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 Fax: 916.415.6525
 www.VerdeDesign.com

STAMP

CONSULTANT
 KEYMAP

SHEET TITLE
**MATERIAL AND
 DETAIL REFERENCE
 PLAN - BASEBALL FIELD**


PROJECT NAME
**HIRAM JOHNSON
 HIGH SCHOOL
 GOLF PRACTICE FACILITY,
 VARSITY BASEBALL AND
 SOFTBALL FIELDS**

PROJECT ADDRESS
**6879 14TH AVENUE
 SACRAMENTO, CA 95820**




SUBMITTAL	DATE
DD 50% SUBMITTAL	04/15/22
100% DSA SUBMITTAL	05/27/22
DSA BACK CHECK	08/11/22
DSA ADDENDUM SUBMITTAL	09/16/22

NO.	REVISIONS	DATE
ADDENDUM		09/16/22

DRAWN BY: JC
 CHECKED BY: MB/CS
 DATE ISSUED: 09/16/2022
 SCALE:
 PROJ. NO.: 2203200
 SHEET NO.: L7.1

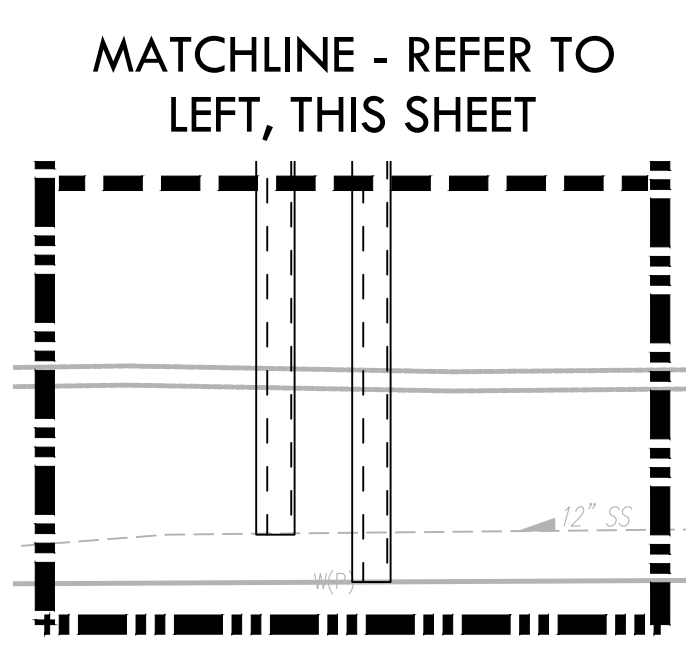

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MATERIAL LEGEND		
SYM	DESCRIPTION	DTL REF
19	12" WIDE TALL CURB	(O) D2.1
20	NOT USED	
21	18" EDGE BAND WITH FENCE	(G) D2.1
22	12" EDGE BAND WITH FENCE	(F) D2.1
23	24" TALL PROTECTIVE NETTING OVER 6' FENCE	(C) D3.2
24	BASEBALL BATTING CAGE	(E) D4.2
25	BASEBALL BULLPEN (1ST BASE)	(A) D4.5
26	BASEBALL BULLPEN (3RD BASE)	(G) D4.5
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28	SOFTBALL BULLPEN (3RD BASE)	(H) D4.5
29	SOFTBALL BATTING CAGE	(I) D4.4
30	FENCE WITH SLATS	
31	FENCE CAP - YELLOW. REFER TO SPECIFICATIONS	
32	FENCE CAP - BLACK. REFER TO SPECIFICATIONS	
33	BACKSTOP NET HOOD LIMITS (OPTIONAL)	
34	GOLF PUTTING GREEN	(H) D5.1
35	GOLF DRIVING RANGE	(A) D5.1
36	ELECTRICAL PULL/SIGNAL BOX. REFER TO ELECTRICAL DRAWINGS.	
37	SAFETY NETTING OVER DUGOUT	(A/B) D3.1
38	18" WIDE TALL CURB	(R) D2.1
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- | MATERIAL LEGEND | | |
|---|---|------------|
| SYM | DESCRIPTION | DTL REF |
| (LIMIT OF WORK) | LIMIT OF WORK | |
| (CONCRETE PAVING - CHEMICALLY TREATED - PEDESTRIAN) | CONCRETE PAVING - CHEMICALLY TREATED - PEDESTRIAN | (A) D2.1 |
| (CONCRETE PAVING - NON CHEMICALLY TREATED - PEDESTRIAN) | CONCRETE PAVING - NON CHEMICALLY TREATED - PEDESTRIAN | (B) D2.1 |
| (ASPHALT PAVING - NON CHEMICALLY TREATED - VEHICULAR) | ASPHALT PAVING - NON CHEMICALLY TREATED - VEHICULAR | (P/Q) D2.1 |
| (INFIELD FINES) | INFIELD FINES | (F) D4.1 |
| (WARNING TRACK FINES) | WARNING TRACK FINES | (I) D4.1 |
| (NOT USED) | NOT USED | |
| (SYNTHETIC TURF AT GOLF) | SYNTHETIC TURF AT GOLF | (L) D5.1 |
| (EXPANSION JOINT SCORE JOINT) | EXPANSION JOINT SCORE JOINT | (E) D2.1 |
| (42" CHAIN LINK FENCE) | 42" CHAIN LINK FENCE | (H) D3.1 |
| (GUARD RAIL SYSTEM) | GUARD RAIL SYSTEM | (H) D3.2 |
| (6' CHAIN LINK FENCE) | 6' CHAIN LINK FENCE | (F) D3.1 |
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| (30' CHAIN LINK BACKSTOP) | 30' CHAIN LINK BACKSTOP | (J) D3.3 |
| (24' PROTECTIVE NETTING OVER 6' TALL CHAIN LINK FENCE) | 24' PROTECTIVE NETTING OVER 6' TALL CHAIN LINK FENCE | (G) D3.2 |
| (42" TALL X 4' WIDE CHAIN LINK SWING GATE - ACCESSIBLE) | 42" TALL X 4' WIDE CHAIN LINK SWING GATE - ACCESSIBLE | (C) D3.1 |
| (6' TALL X 4' WIDE CHAIN LINK SWING GATE - ACCESSIBLE) | 6' TALL X 4' WIDE CHAIN LINK SWING GATE - ACCESSIBLE | (M) D3.1 |
| (8' TALL X 4' WIDE CHAIN LINK SWING GATE WITH TRANSOM - ACCESSIBLE) | 8' TALL X 4' WIDE CHAIN LINK SWING GATE WITH TRANSOM - ACCESSIBLE | (L) D3.1 |
| (6' TALL X 8' WIDE CHAIN LINK DOUBLE SWING GATE) | 6' TALL X 8' WIDE CHAIN LINK DOUBLE SWING GATE | (O) D3.1 |
| (8' TALL X 10' WIDE DOUBLE SWING GATE - MIXED LEAF WITH TRANSOM) | 8' TALL X 10' WIDE DOUBLE SWING GATE - MIXED LEAF WITH TRANSOM | (A) D3.2 |
| (6' TALL X 12' WIDE CHAIN LINK DOUBLE SWING GATE) | 6' TALL X 12' WIDE CHAIN LINK DOUBLE SWING GATE | (M) D3.2 |

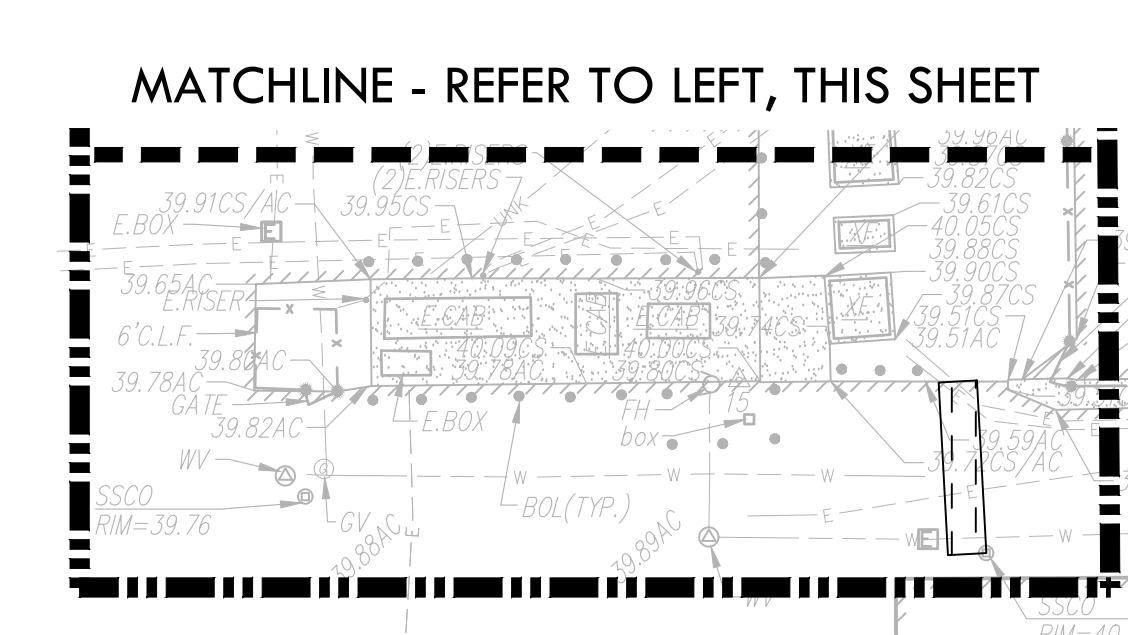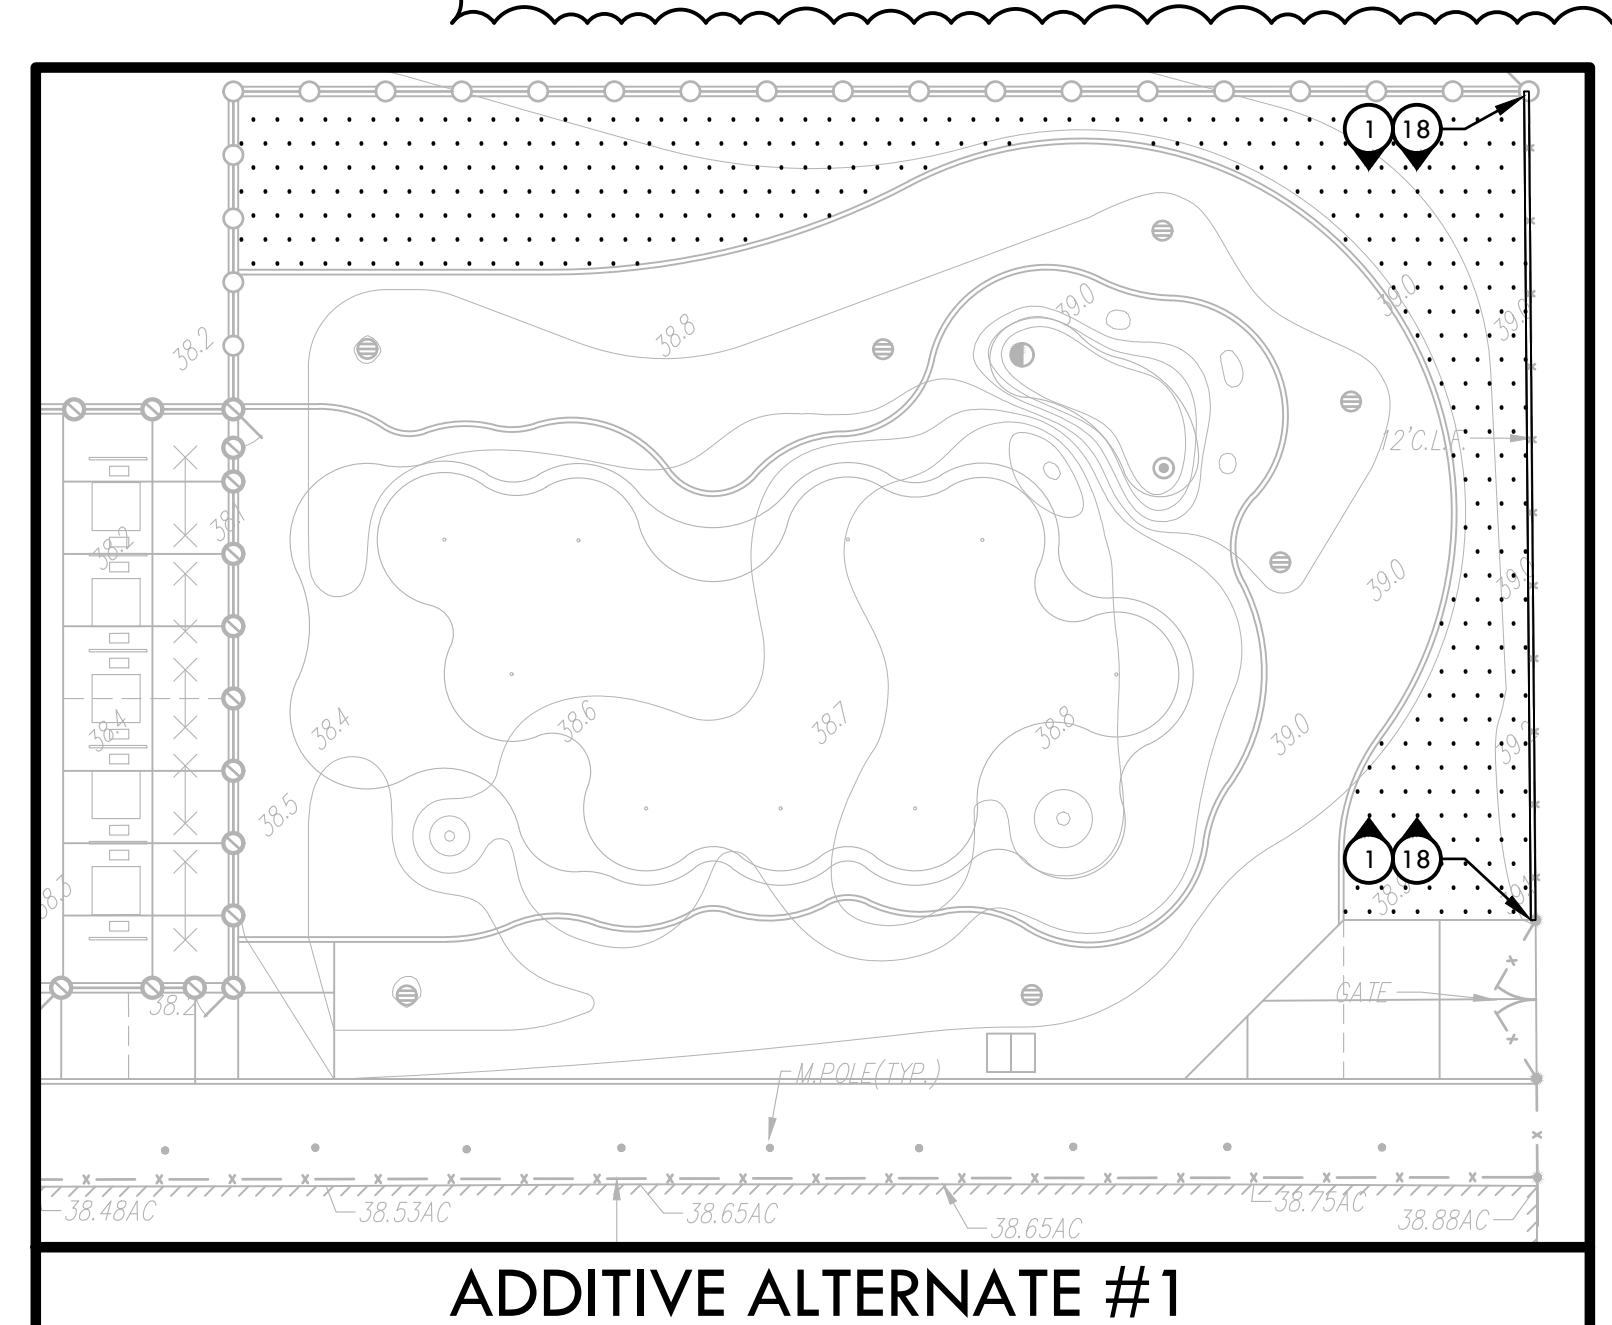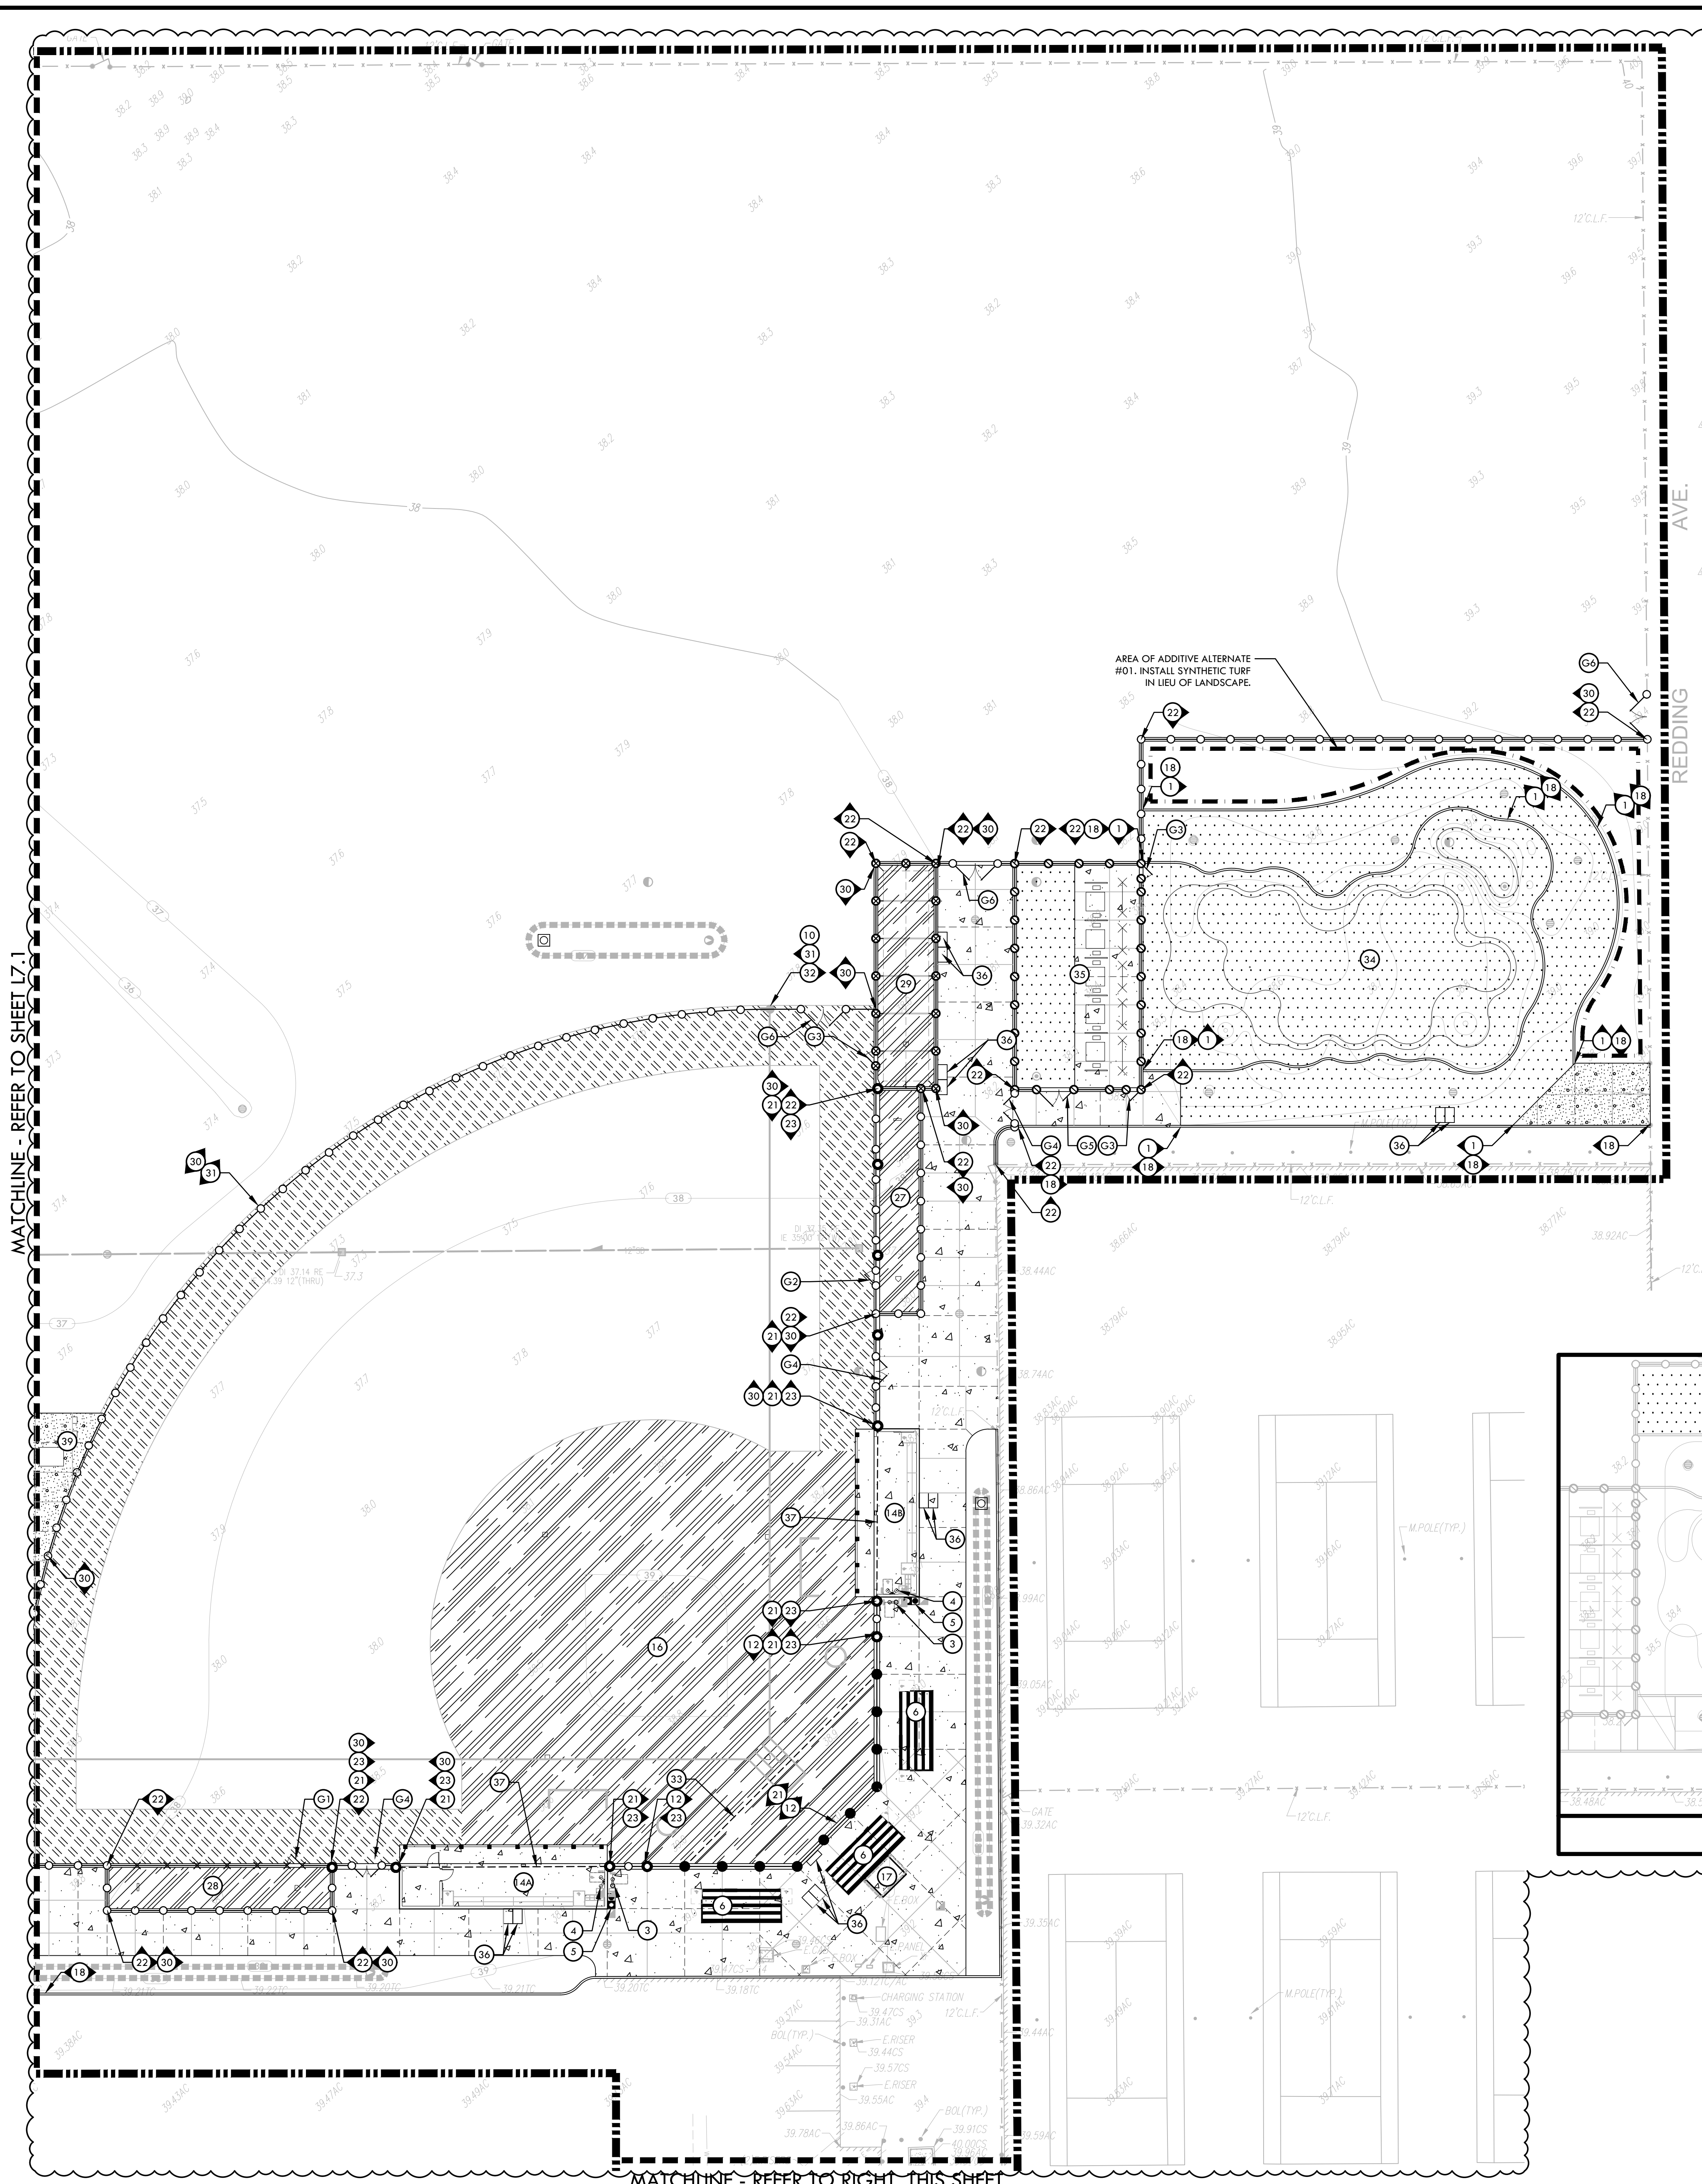MATERIAL NOTES		
1. THE CONTRACTOR SHALL COORDINATE ALL CONSTRUCTION ELEMENTS INCLUDING UTILITY LOCATIONS AND REQUIRED SLEEVING PRIOR TO INSTALLATION. VERIFY CRITICAL DIMENSIONS, REFERENCE POINT LOCATIONS AND CONSTRUCTION CONDITIONS PRIOR TO INITIATING CONSTRUCTION. TEMPORARY BENCHMARKS OR REFERENCE POINTS SHALL BE SET BY THE CONTRACTOR AS NECESSARY. NOTIFY THE OWNER'S REPRESENTATIVE IMMEDIATELY SHOULD DISCREPANCY ARISE AND REDIRECT WORK TO AVOID DELAYS.		
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4. CONCRETE FINISHES SHALL BE AS NOTED. CONTRACTOR SHALL PROVIDE 4"x4" SAMPLES OF ALL SPECIFIED FINISHES OF CONCRETE USING THE SAME MATERIALS THAT WILL BE USED IN THE ACTUAL CONSTRUCTION FOR EACH TYPE SPECIFIED. SAMPLES SHALL BE PREPARED WELL ENOUGH IN ADVANCE OF SCHEDULED CONCRETE POUR TO ALLOW FOR REVIEW AND POSSIBLE RE-COURING OF UNACCEPTABLE SAMPLES. UNACCEPTABLE SAMPLES SHALL BE RE-PREPARED UNTIL ACCEPTED BY THE OWNER'S REPRESENTATIVE. ACCEPTED SAMPLES SHALL BE PROTECTED AND REMAIN ON SITE FOR REFERENCE UNTIL FINAL ACCEPTANCE.		
5. ALL FENCES AND GATES SHOWN ON PLAN ARE GRAPHIC REPRESENTATIONS; REFER TO DETAILS AND SPECIFICATIONS FOR PRECISE LOCATION.		
6. ASPHALT SHALL NOT BE INSTALLED UNTIL ALL EDGES AND SITE FURNISHING PADS ARE INSTALLED.		

SYM	DESCRIPTION	DTL REF
(1)	SYNTHETIC TURF CONNECTION	(C) D5.1
(2)	ELECTRICAL EQUIPMENT CONCRETE PAD (REFER TO ELECTRICAL PLANS FOR ADDITIONAL INFORMATION).	
(3)	DRINKING FOUNTAIN	(H) D1.1
(4)	DRINKING FOUNTAIN IN DUGOUT	(M) D1.1
(5)	TRASH AND RECYCLING RECEPTACLE	(K) D2.1
(6)	PORTABLE BLEACHERS - 4 ROW. REFER TO SPECIFICATIONS	
(7)	SCOREBOARD. REFER TO STRUCTURAL DRAWINGS AND NEVCO PC DRAWINGS FOR ADDITIONAL INFORMATION.	
(8)	FLAG POLE. REFER TO STRUCTURAL DRAWINGS AND SPECIFICATIONS	
(9)	FOUL POLE AT BASEBALL	(G) D4.1
(10)	FOUL POLE AT SOFTBALL	(G) D4.1
(11)	BASEBALL BACKSTOP - WITH OPTIONAL NET HOOD, ALSO REFER TO STRUCTURAL DRAWINGS	(A) D3.3
(12)	SOFTBALL BACKSTOP - WITH OPTIONAL NET HOOD, ALSO REFER TO STRUCTURAL DRAWINGS	(B) D3.3
(13)	BASEBALL DUGOUT - 1ST BASE SIDE (HOME). REFER TO SHEET D4.6	
(13B)	BASEBALL DUGOUT - 3RD BASE SIDE (VISITOR). REFER TO SHEET D4.7	
(14)	SOFTBALL DUGOUT - 3RD BASE SIDE (HOME). REFER TO SHEET D4.9	
(14B)	SOFTBALL DUGOUT - 1ST BASE SIDE (VISITOR). REFER TO SHEET D4.8	
(15)	BASEBALL INFIELD	(A) D4.3
(16)	SOFTBALL INFIELD	(A) D4.4
(17)	ELEVATED SCORER'S TABLE (SPORTSFIELDS SPECIALTIES MODEL #518 CUSTOM FAB CHAIRS OR APPROVED EQUAL ANY DEVIATION COORDINATE SIZE AND LOCATION)	(M) D2.1
(18)	6" WIDE EDGE BAND	(M) D2.1

VERDE DESIGN
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 www.VerdeDesign.com

REGISTERED LANDSCAPE ARCHITECT
 HIRAM JOHNSON
 EXPIRATION DATE: JULY 2022
 STATE OF CALIFORNIA

STAMP

CONSULTANT

KEYMAP

SHEET TITLE

MATERIAL AND DETAIL REFERENCE PLAN - SOFTBALL FIELD AND GOLF

PROJECT NAME

HIRAM JOHNSON HIGH SCHOOL GOLF PRACTICE FACILITY, VARSITY BASEBALL AND SOFTBALL FIELDS

PROJECT ADDRESS

**6879 14TH AVENUE
SACRAMENTO, CA 95820**

SUBMITTAL	DATE
DD 50% SUBMITTAL	04/15/22
100% DSA SUBMITTAL	05/27/22
DSA BACK CHECK	08/11/22
DSA ADDENDUM SUBMITTAL	09/16/22

NO.	REVISIONS	DATE
ADDENDUM		09/16/22

DRAWN BY: JC CHECKED BY: MB/CS

DATE ISSUED: 09/16/2022 SCALE:


PROJ. NO. 2203200

SHEET NO. **L7.2**

NORTH

MATERIAL AND DETAIL REFERENCE PLAN - SOFTBALL FIELD AND GOLF


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MATCHLINE - REFER TO RIGHT, THIS SHEET

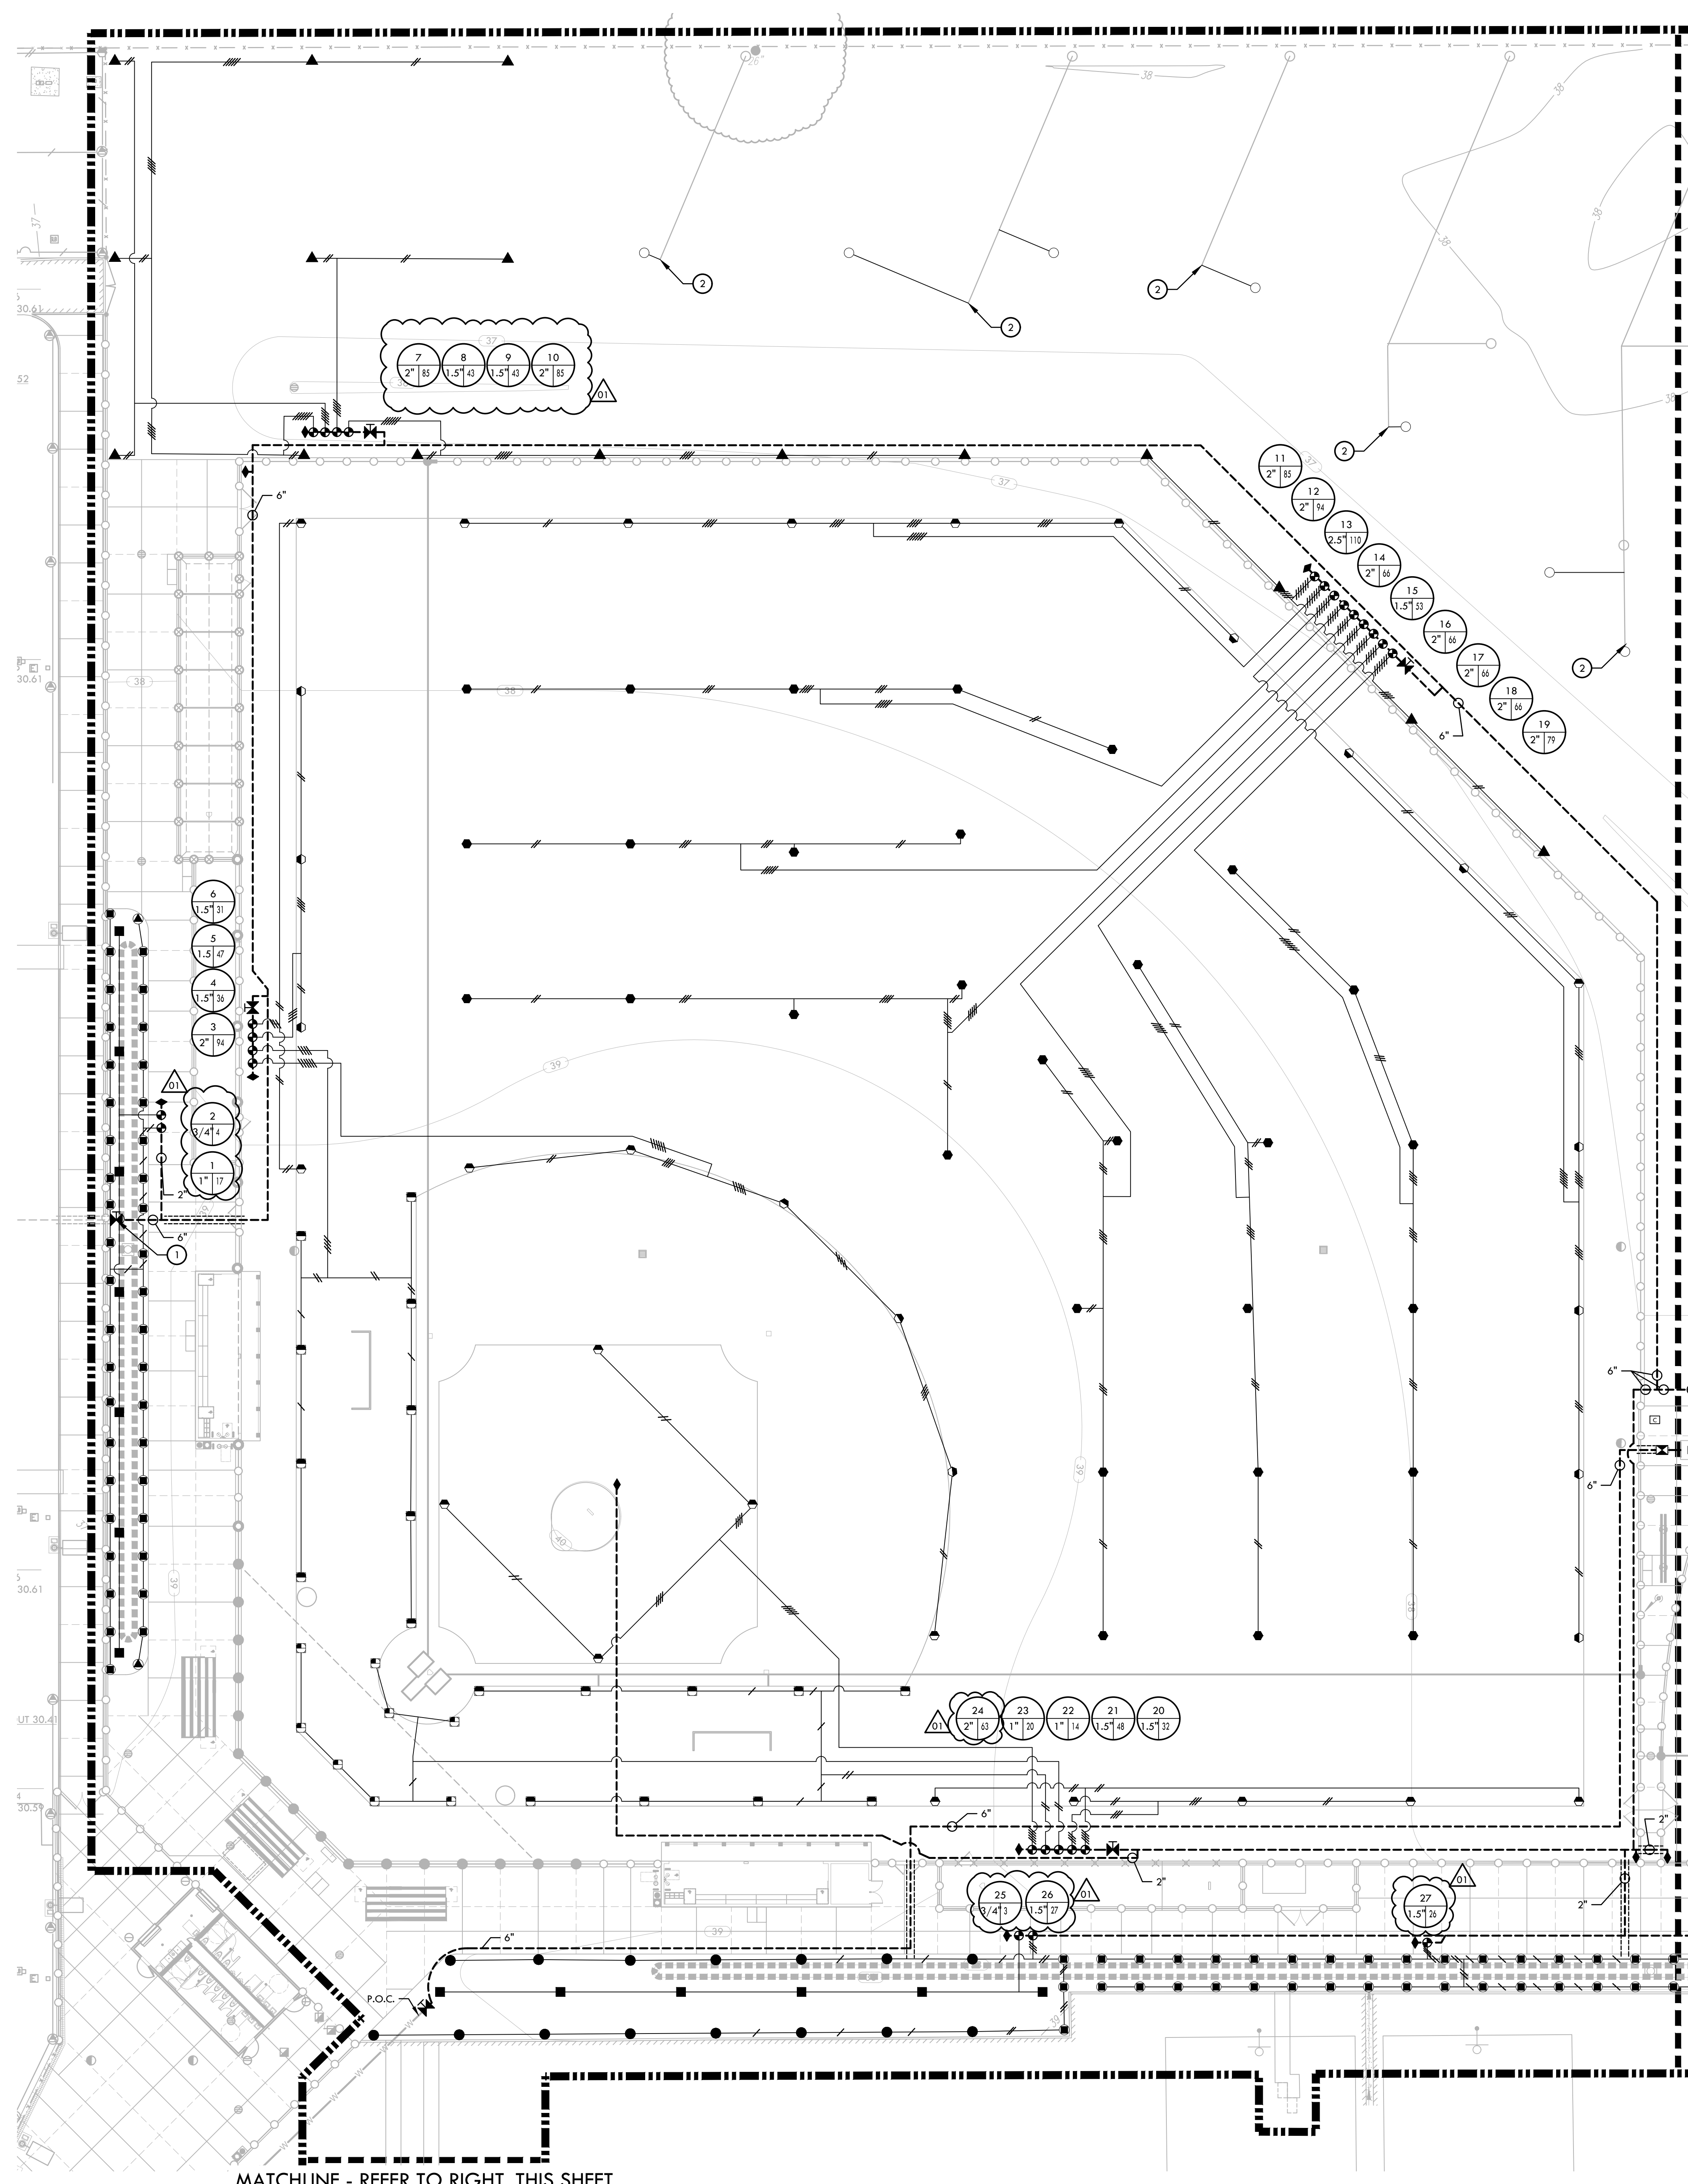MATCHLINE - REFER TO SHEET 18.2

MATCHLINE - REFER TO LEFT, THIS SHEET



IRRIGATION NOTES

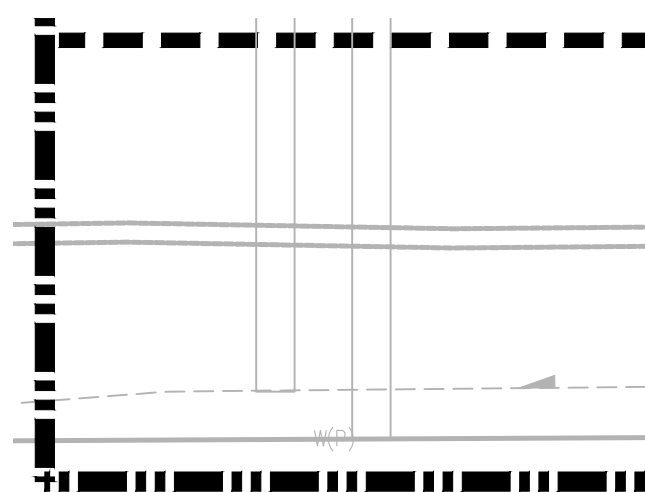- THE SYSTEM IS DESIGNED TO OPERATE AT A MAXIMUM FLOW OF 325 GPM WITH A MAXIMUM STATIC PSI AT THE IRRIGATION BOOSTER PUMP. CONTRACTOR SHALL VERIFY PRESSURE PRIOR TO BEGINNING WORK. CONTACT OWNER IMMEDIATELY SHOULD DISCREPANCY ARISE AND REDIRECT WORK TO AVOID DELAY.
- ALL WORK SHALL CONFORM TO LOCAL AND STATE CODES AND ORDINANCES. ALL IRRIGATION WORK SHALL CONFORM TO THE LANDSCAPE SECTION OF THE STANDARD PLAN DETAILS FOR PUBLIC WORKS CONSTRUCTION. PROJECT AND DETAILS AND SPECIFICATIONS SHALL TAKE PRECEDENCE OVER STANDARD PLAN DETAILS.
- ALL PLASTIC FITTINGS SHALL BE A MINIMUM OF 18" APART TO FACILITATE REMOVAL AND REPLACEMENT OF INDIVIDUAL FITTINGS. TRENCHING DEPTHS OF POTABLE WATER MAIN SHALL BE 24". ALL MAINS, LATERALS AND CONTROL WIRES SHALL BE INSTALLED IN SCHEDULE 40 PURPLE P.V.C. SLEEVES (OF APPROPRIATE SIZE) UNDER ALL A.C. AND P.C.C. PAVEMENT.
- IRRIGATION SYSTEM DESIGN IS DIAGRAMMATIC. WHERE PIPING, VALVES, QUICK COUPLERS, ETC. ARE SHOWN OUTSIDE FIELD, OR LIMIT OF WORK; INTENT IS FOR PIPING, VALVES, ETC., TO BE INSTALLED WITHIN FIELD AREAS OF PROPERTY. INDICATE EXACT LOCATIONS OF IRRIGATION EQUIPMENT ON RECORD DRAWINGS.
- CONTRACTOR SHALL ADJUST IRRIGATION HEADS FOR OPTIMUM COVERAGE WHILE REDUCING OVER SPRAY ONTO WALKWAYS AND ADJACENT STRUCTURES. VALVES SHALL BE ADJUSTED TO AVOID MISTING AS APPLICABLE. CONTRACTOR SHALL MAKE MINOR ADJUSTMENTS TO HEAD LOCATIONS IN FIELD AS NECESSARY ONLY WITH THE APPROVAL OF THE CITY ENGINEER.
- CONTRACTOR SHALL REFER TO DETAILS AND SPECIFICATIONS FOR ADDITIONAL INFORMATION.


IRRIGATION AND CONDUIT LEGEND

SYM.	MANUF.	MODEL NO. / DESCRIPTION	DSGN. RAD.	PSI	GPM	DYL REF.
●	HUNTER	I-50-06-SS-0N-15 DUAL OPPOSING NOZZLE	40'-50'	60	13.2	
●	HUNTER	I-50-06-SS-15 ADJUSTABLE SPRAY NOZZLE	40'-50'	60	15.7	
▲	HUNTER	I-50-06-SS-23 ADJUSTABLE SPRAY NOZZLE	52'	60	21.3	(G)
■	HUNTER	I-20-06-SS-MPR25 ADJUSTABLE SPRAY NOZZLE	30'	55	2.13-8.43	(D6.2)
■	HUNTER	I-20-06-SS-MPR25 ADJUSTABLE SPRAY NOZZLE	20'	55	1.11-4.25	(D6.2)
▲	HUNTER	PROS-06-PRS40-CV W/ MP800SR ROTATOR NOZZLES	8'	40	0.23-0.78	(D6.2)
■	HUNTER	PROS-06-PRS40-CV W/ MP1000 ROTATOR NOZZLES	12'	40	0.21-0.84	(D6.2)
●	HUNTER	PROS-06-PRS40-CV W/ MP2000 ROTATOR NOZZLES	16'	40	0.43-1.48	(D6.2)
●	HUNTER	PROS-06-PRS40-CV W/ MP3000 ROTATOR NOZZLES	25'	40	0.86-3.64	(D6.2)
■	HUNTER	18" ROOT ZONE WATERING SYSTEM RZWS-18-50-CV	-	40	0.50	(M)
○		EXISTING HEAD ADJUSTED/RELOCATED. CONTRACTOR SHALL BE RESPONSIBLE PIPE HEAD BACK TO ZONE AND ENSURE PROPER HEAD-TO-HEAD COVERAGE IS ACHIEVED.				(D6.2)
✕	NIBCO	GATE VALVES 2" AND SMALLER SHALL BE NIBCO T-113. FOR VALVES ABOVE 2" IN SIZE UTILIZE NIBCO F-619 FLANGED VALVE WITH SQUARE OPERATING NUT.				(C/D)
◆	RAIN BIRD	44NP QUICK COUPLER VALVE				(F)
⊕	SUPERIOR	REMOTE CONTROL VALVE - SUPERIOR 950, SIZE PER PLAN				(E)
Ⓜ	GRISWOLD	MASTER CONTROL VALVE - NORMALLY OPEN GRISWOLD 2160P - 4"				(C)
Ⓢ	CST	SADDLE MOUNTED FLOW SENSOR - CST MODEL FSI-S40-001				(D)
⊠	WILKINS	REDUCED PRESSURE BACKFLOW ASSEMBLY WITH FREEZE BLANKET - WILKINS 375 - 6", VIT PBB-60HP				(B)
Ⓢ		IRRIGATION CONTROLLER. HUNTER ACC2. CONTRACTOR TO COORDINATE WITH DISTRICT ON CONTROLLER INSTALLATION DURING CONSTRUCTION.				(B)
Ⓢ		IRRIGATION BOOSTER PUMP. PPS MODEL CB#HVI CO20X00325-065XXX243ONS-4				(A)
⊕		EXISTING VALVE, GATE/BALL VALVE OR QUICK COUPLER				(D6.1)
○		EXISTING ROTORS OR SPRAY HEADS				(D6.1)
---		EXISTING MAINLINE TO REMAIN AND BE PROTECTED. CONTRACTOR TO VERIFY SIZE AND APPROXIMATE LOCATION PRIOR TO CONSTRUCTION.				(D6.2)
---		EXISTING IRRIGATION LATERAL LINE				(D6.1)
---		LIMIT OF WORK				(D6.1)
---		3/4" LATERAL LINE - SCHEDULE 40 PVC PIPE & SOLVENT WELD FITTINGS, AT 18" DEPTH.				(D6.1)
---		1" LATERAL LINE - SCHEDULE 40 PVC PIPE & SOLVENT WELD FITTINGS, AT 18" DEPTH.				(D6.1)
---		1 1/4" LATERAL LINE - SCHEDULE 40 PVC PIPE & SOLVENT WELD FITTINGS, AT 18" DEPTH.				(D6.1)
---		1 1/2" LATERAL LINE - SCHEDULE 40 PVC PIPE & SOLVENT WELD FITTINGS, AT 18" DEPTH.				(D6.1)
---		2" LATERAL LINE - SCHEDULE 40 PVC PIPE & SOLVENT WELD FITTINGS, AT 18" DEPTH.				(D6.1)
---		2 1/2" LATERAL LINE - SCHEDULE 40 PVC PIPE & SOLVENT WELD FITTINGS, AT 18" DEPTH.				(D6.1)
---		4" LATERAL LINE - SCHEDULE 40 PVC PIPE & SOLVENT WELD FITTINGS, AT 18" DEPTH.				(D6.1)
---		MAIN LINE - CLASS 200 PVC PIPE & RING-TITE FITTINGS AT 24" DEPTH - SIZE AS NOTED.				(D6.1)
---		SLEEVES - CLASS 200 PVC. SIZE TO BE TWICE THE SIZE OF TOTAL PIPE DIAMETERS WITHIN THE SLEEVE, OR AS NOTED, WITH 30" COVER.				(D6.1)



CONSULTANT

KEYMAP

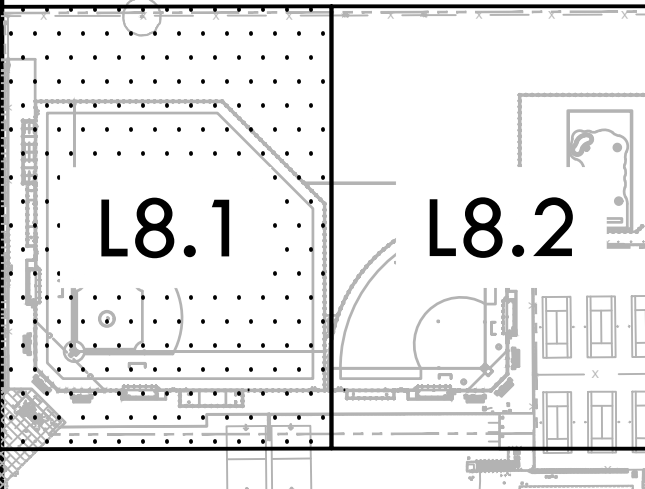

SHEET TITLE
IRRIGATION PLAN - BASEBALL FIELD

PROJECT NAME
HIRAM JOHNSON HIGH SCHOOL GOLF PRACTICE FACILITY, VARSITY BASEBALL AND SOFTBALL FIELDS


PROJECT ADDRESS
6879 14TH AVENUE SACRAMENTO, CA 95820


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DD 50% SUBMITTAL	04/15/22
100% DSA SUBMITTAL	05/27/22
DSA BACK CHECK	08/11/22
DSA ADDENDUM SUBMITTAL	09/16/22

NO.	REVISIONS	DATE
1	ADDENDUM	09/16/22

DRAWN BY: JC
CHECKED BY: MB/CS
DATE ISSUED: 09/16/2022
SCALE: 1" = 20'-0"

PROJ. NO.: 2203200
SHEET NO.: **L8.1**

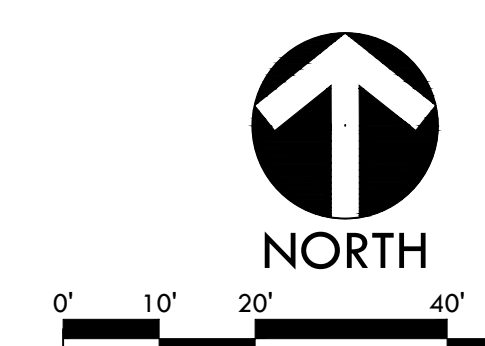

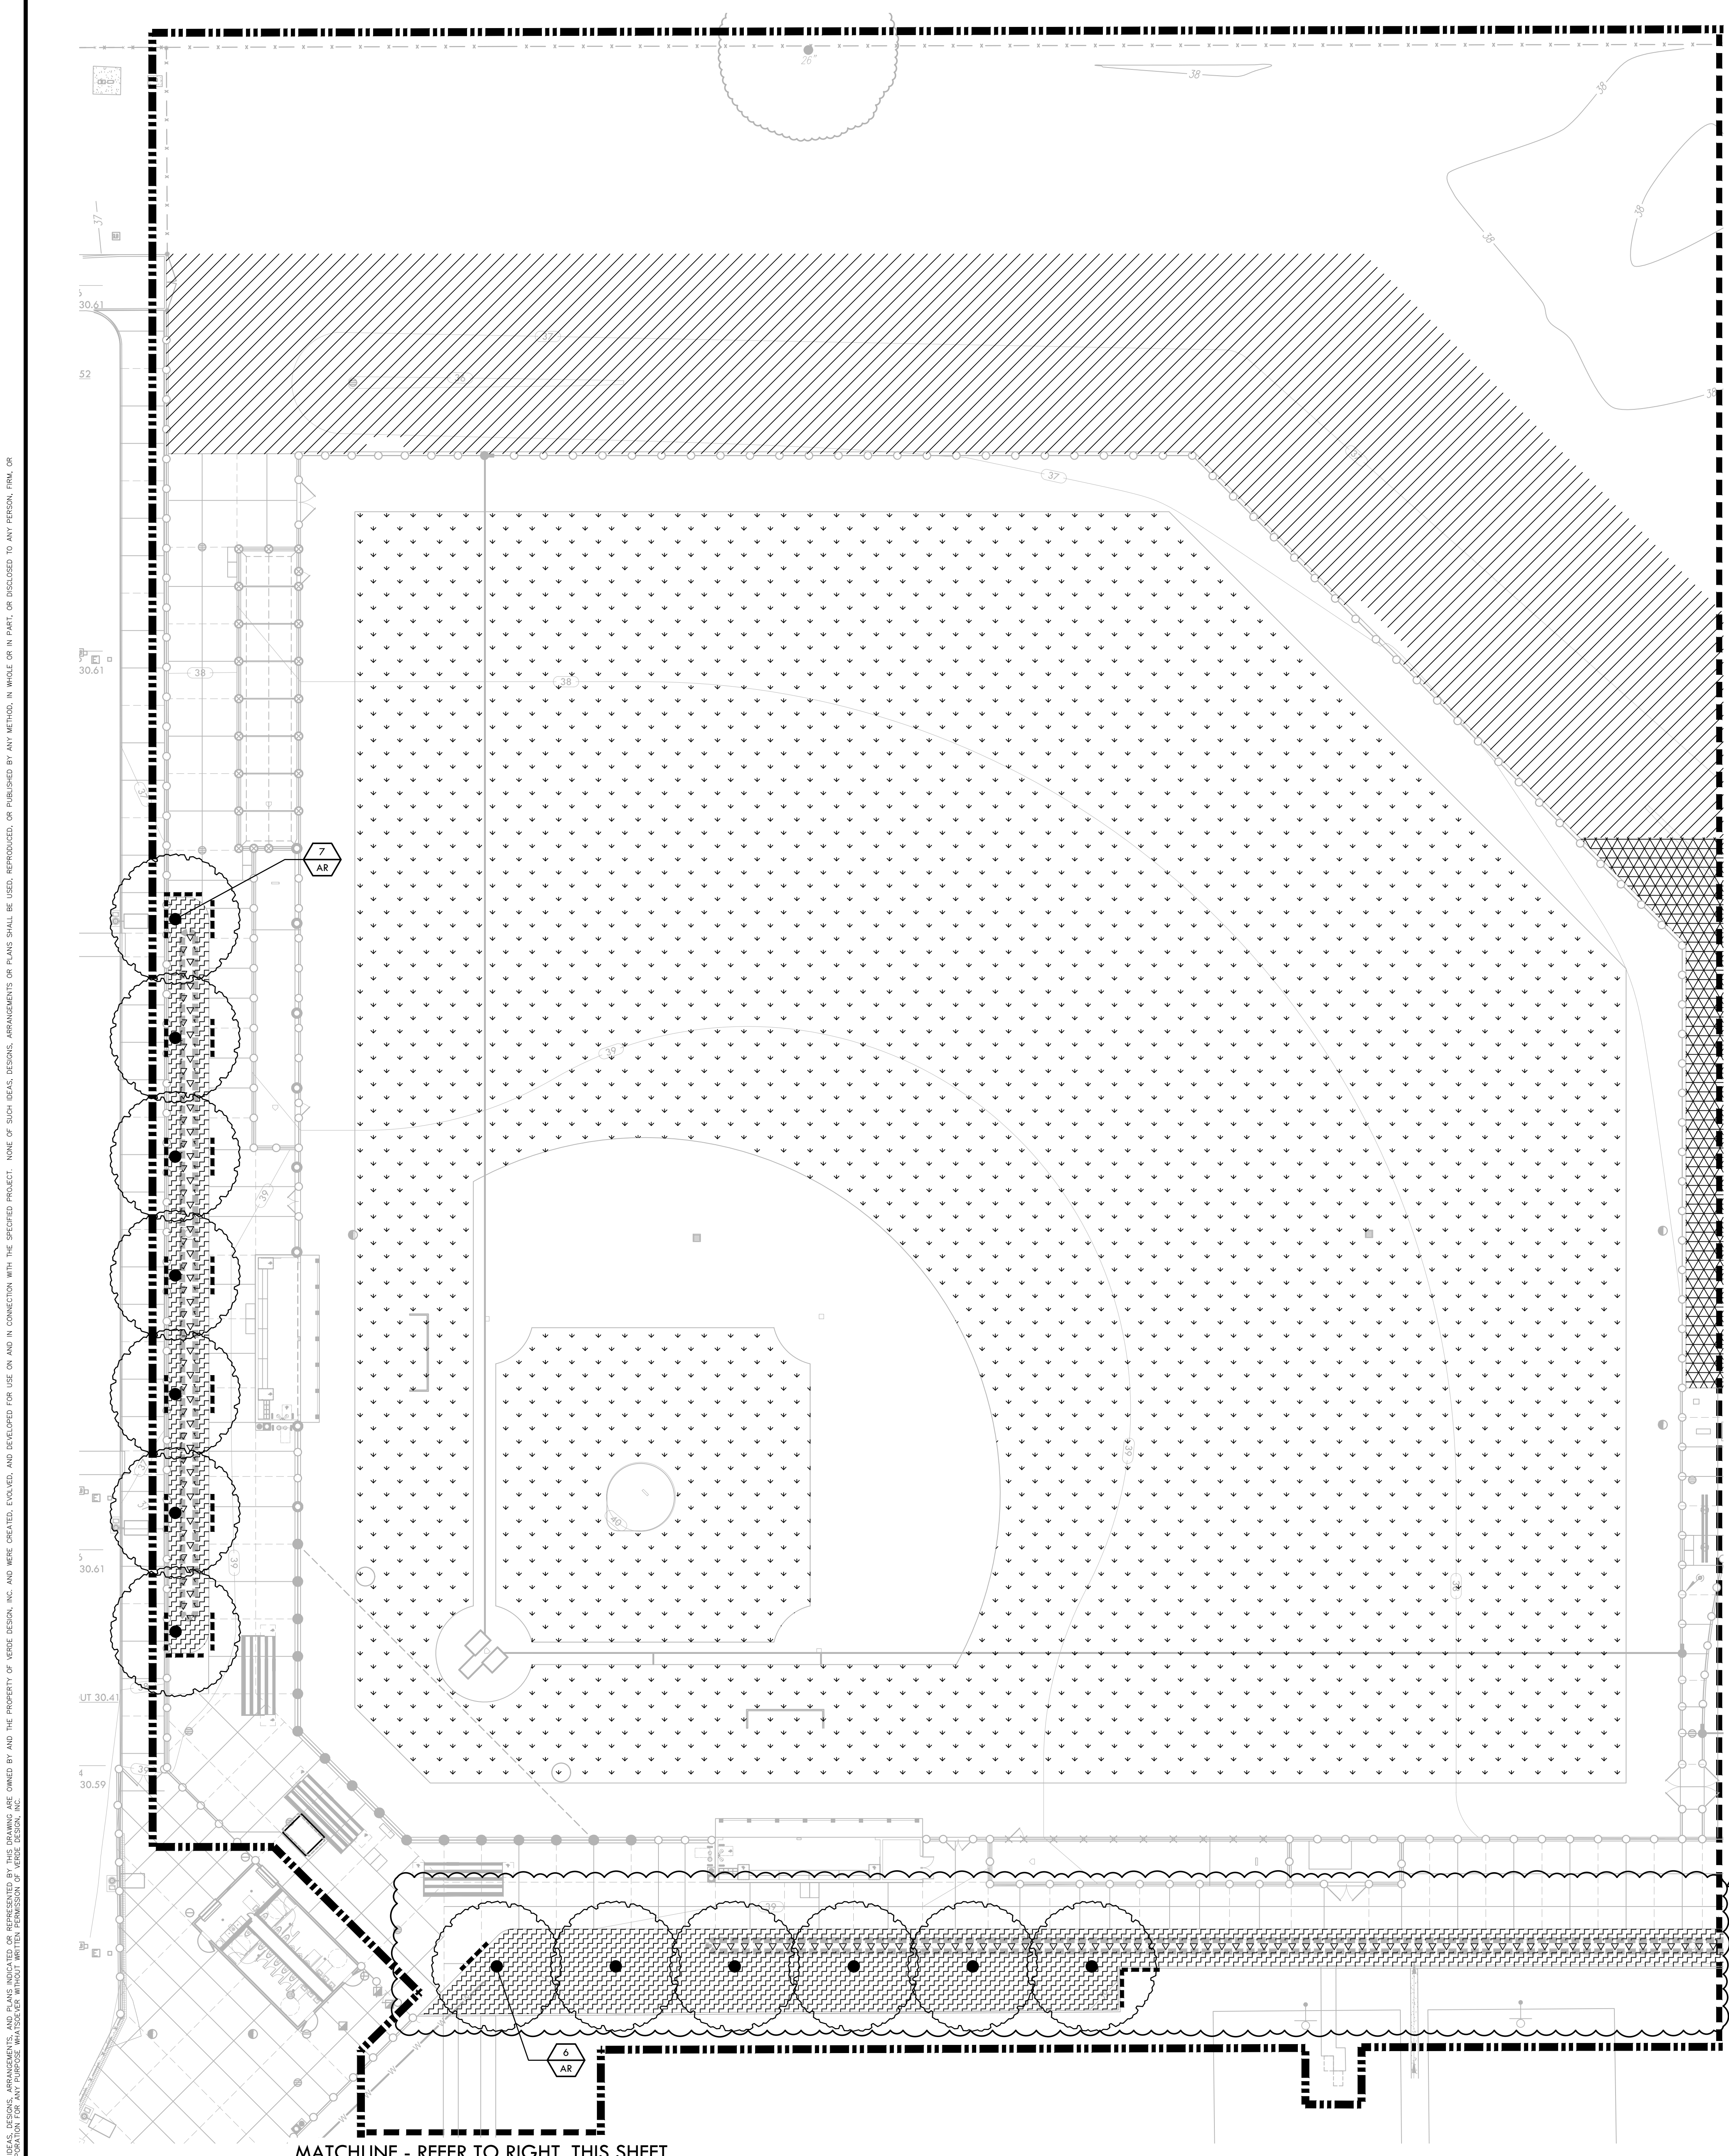

PLANTING NOTES

- CONTRACTOR SHALL PROTECT AND MAINTAIN ALL PLANT MATERIAL FROM TIME OF DELIVERY TO TIME OF FINAL ACCEPTANCE. OWNER SHALL NOT BE RESPONSIBLE FOR LOSSES DUE TO VANDALISM, THEFT OR SEVERE WEATHER.
- CONTRACTOR SHALL PLACE PLANT MATERIALS SO THEY DO NOT INTERFERE WITH IRRIGATION SYSTEM OR INHIBIT REQUIRED COVERAGE. PLANT LOCATIONS MAY BE ADJUSTED AS LONG AS DESIGN INTENT IS NOT COMPROMISED. CONTRACTOR SHALL SET OUT PLANT MATERIAL AS PER PLAN AND RECEIVE ACCEPTANCE FROM OWNER'S REPRESENTATIVE WITH RESPECT TO PLANT HEALTH AND LOCATION PRIOR TO INSTALLATION. CONTRACTOR SHALL GIVE MINIMUM 2 WORKING DAYS NOTICE FOR OBSERVATION AND SHALL HAVE ALL PLANT MATERIAL IN SPECIFIED LOCATIONS FOR REVIEW AT ONE TIME. CONTRACTOR SHALL REPLACE ANY MATERIAL AS REQUESTED BY OWNER'S REPRESENTATIVE.
- ALL NON-TURF PLANTING AREAS SHALL RECEIVE A 3" LAYER OF BARK MULCH TOP DRESS (UNLESS NOTED OTHERWISE). REFER TO SPECIFICATIONS.
- WHEN WORK HAS TO OCCUR UNDER THE DRIPLINE OF EXISTING TREES NOT SCHEDULED FOR REMOVAL, THE CONTRACTOR SHALL USE ALL POSSIBLE CARE TO AVOID INJURY TO THE TREES AND TREE ROOTS. GRADE IN LINES RADIAL TO THE EXISTING TREES RATHER THAN TANGENTIAL. ALL PARTIAL CUTS OR TEARS THROUGH ROOTS TWO INCHES IN DIAMETER AND LARGER SHALL BE CUT CLEAN. TRENCHES ADJACENT TO TREES SHALL BE FILLED WITHIN 24 HOURS AFTER EXCAVATION, BUT WHERE THIS IS NOT POSSIBLE, THE SIDE OF THE TRENCH ADJACENT TO THE TREE, AND ANY EXPOSED ROOTS SHALL BE KEPT SHADED AND MOIST WITH DAMPENED BURLAP OR CANVAS.
- ALL SHRUB AND TREE AREA SHALL RECEIVE A WEED FABRIC LAYER. INSTALL WITH STAPLES, 3" OVERLAP AND COVER WITH MULCH.
- ALL TURF, MULCH AND PLANTERS TO RECEIVE SOIL AMENDMENTS AND SOIL PREPARATION PER SPECIFICATIONS UNLESS OTHERWISE NOTED.

PLANTING LEGEND

SYM.	QTY.	SIZE	BOTANICAL/COMMON NAME	SPACING	WATER USE REQUIREMENTS PER WUCOLS REGION 2 - CENTRAL VALLEY	DET REF
TREES						
	13	15 GAL	ACER RUBRUM RED MAPLE	35' O.C.	MEDIUM	N D6.2
SHRUBS/GROUNDCOVER						
	834	1 GAL	JUNCUS PATENS CALIFORNIA GRAY RUSH	24" O.C.	MEDIUM	O D6.2
	917	1 GAL	CAREX PRAEGRACILIS CLUSTERED FIELD SEDGE	1'-6" O.C.	MEDIUM	O D6.2
			TURF - SOD, HYBRID BERMUDA, REFER TO SPECIFICATIONS		HIGH	
			NATIVE PRESERVATION MIX AS SUPPLIED BY DELTA BLUEGRASS CO.		HIGH	
			AREA FOR LANDSCAPE REPAIR. CONTRACTOR TO REPAIR LANDSCAPE TO MATCH EXISTING TO AN AS-WAS OR BETTER CONDITION.		HIGH	
			3" DEP. MULCH ONLY AREA - REFER TO SPECIFICATIONS		N/A	
			AREA TO BE BACKILLED AND REPAIRED TO MATCH SURROUNDING LANDSCAPE		N/A	
			TREE ROOT BARRIER			P D6.2
MISC.						
	1		IF ADDITIVE ALTERNATE 01 IS AWARDED, CONTRACTOR SHALL NOT INSTALL NATIVE PRESERVATION MIX LANDSCAPE			


HARDSCAPE SHADE

35' Diameter Tree Tree Symbol	Shade Percentage	Quantity	Total Shade (sf)
	100%		
	(962 sf/tree)	0	
	75%		
	(722 sf/tree)	2	1,444
	50%		
	(481 sf/tree)	11	5,291
	25%		
	(240 sf/tree)	0	0
		Sum	6,735

New Hardscape(sf)	Shade Required - 20% (sf)	Shade Provided (sf)	Percent Shade
26,819	5,364	6,735	25%



CONSULTANT

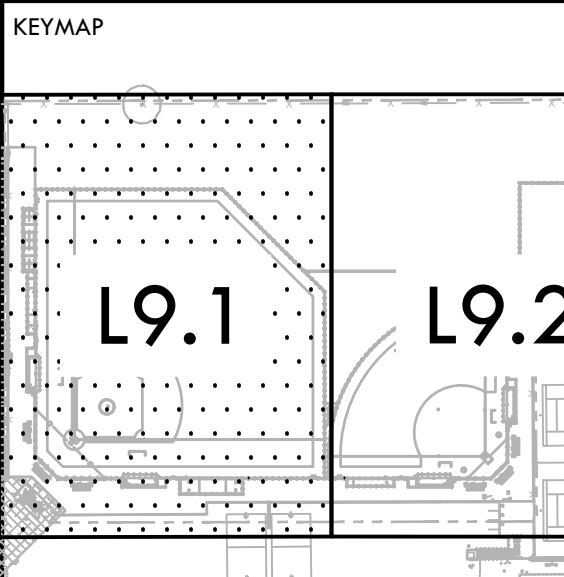

SHEET TITLE
**PLANTING PLAN -
BASEBALL FIELD**

PROJECT NAME
**HIRAM JOHNSON
HIGH SCHOOL
GOLF PRACTICE FACILITY,
VARSITY BASEBALL AND
SOFTBALL FIELDS**


PROJECT ADDRESS
**6879 14TH AVENUE
SACRAMENTO, CA 95820**

SUBMITTAL	DATE
DD 50% SUBMITTAL	04/15/22
100% DSA SUBMITTAL	05/27/22
DSA BACK CHECK	08/11/22
DSA ADDENDUM SUBMITTAL	09/16/22

NO.	REVISIONS	DATE
▲	ADDENDUM	09/16/22
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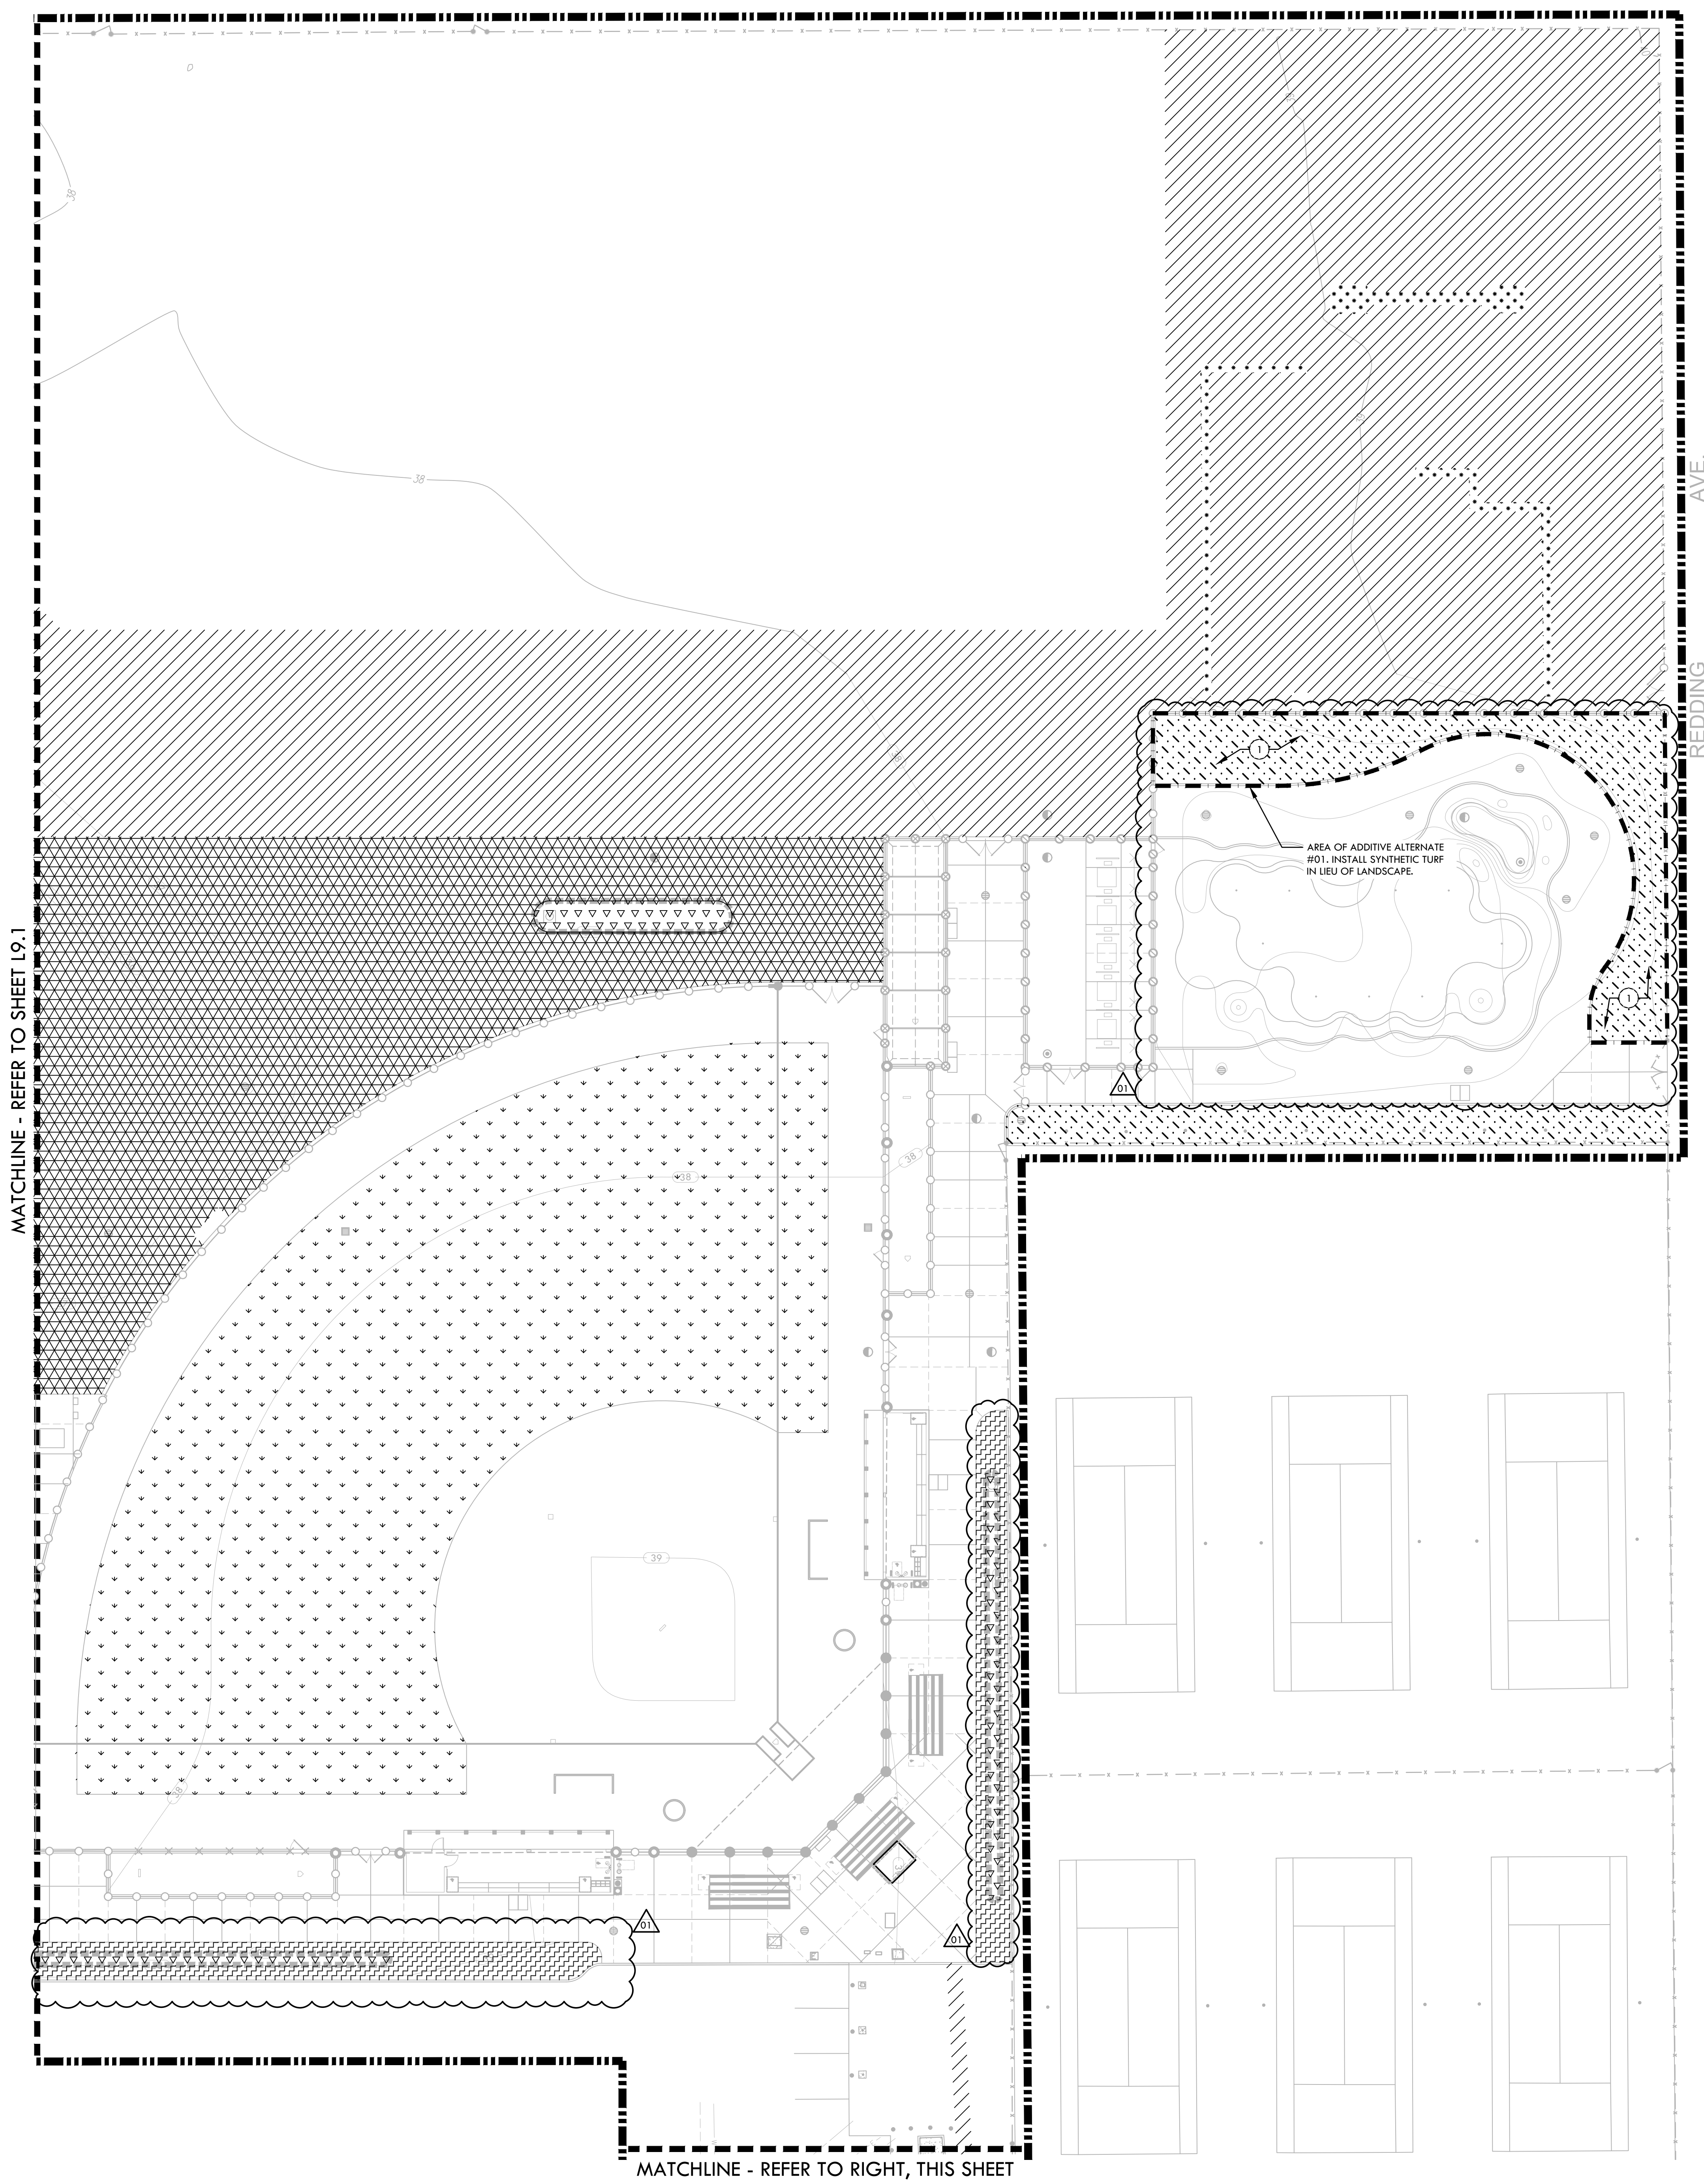
PROJ. NO.: 2203200
SHEET NO.: L9.1



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MATCHLINE - REFER TO SHEET L9.1

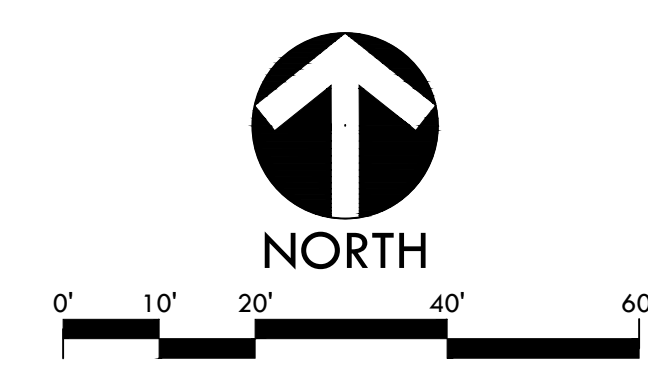

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PLANTING NOTES


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PLANTING LEGEND

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TREES						
	13	15 GAL	ACER RUBRUM RED MAPLE	35' O.C.	MEDIUM	(N) D6.2
SHRUBS/GROUNDCOVER						
	834	1 GAL	JUNCUS PATENS CALIFORNIA GRAY RUSH	24" O.C.	MEDIUM	(O) D6.2
	917	1 GAL	CAREX PRAEGRACILIS CLUSTERED FIELD SEDGE	1'-6" O.C.	MEDIUM	(O) D6.2
	TURF - SOD, HYBRID BERMUDA, REFER TO SPECIFICATIONS			-	HIGH	
	NATIVE PRESERVATION MIX AS SUPPLIED BY DELTA BLUEGRASS CO.			-	HIGH	
	AREA FOR LANDSCAPE REPAIR. CONTRACTOR TO REPAIR LANDSCAPE TO MATCH EXISTING TO AN AS-WAS OR BETTER CONDITION.			-	HIGH	
	3" DEP. MULCH ONLY AREA - REFER TO SPECIFICATIONS			-	N/A	
	AREA TO BE BACKFILLED AND REPAIRED TO MATCH SURROUNDING LANDSCAPE			-	N/A	
	TREE ROOT BARRIER			-		(P) D6.2
MISC.						
	IF ADDITIVE ALTERNATE 01 IS AWARDED, CONTRACTOR SHALL NOT INSTALL NATIVE PRESERVATION MIX LANDSCAPE					




VERDE DESIGN
 LANDSCAPE ARCHITECTURE
 CIVIL ENGINEERING
 SPORT PLANNING & DESIGN
 1843 Iron Point Rd., Suite 140
 Folsom, CA 95630
 Tel: 916.415.6554
 Fax: 916.415.6525
 www.VerdeDesign.com

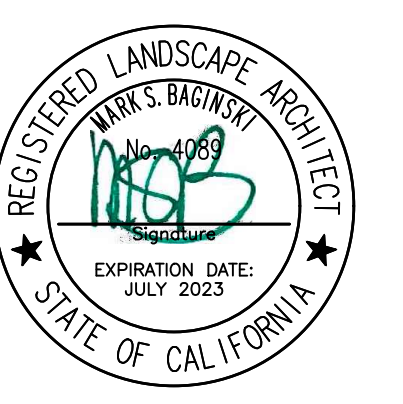

STAMP

CONSULTANT

KEYMAP

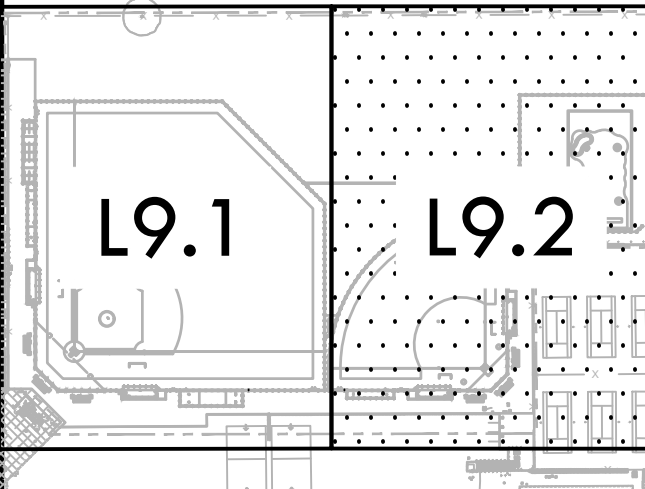

SHEET TITLE

**PLANTING PLAN -
SOFTBALL FIELD AND
GOLF**

PROJECT NAME

**HIRAM JOHNSON
HIGH SCHOOL
GOLF PRACTICE FACILITY,
VARSITY BASEBALL AND
SOFTBALL FIELDS**


PROJECT ADDRESS

**6879 14TH AVENUE
SACRAMENTO, CA 95820**


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100% DSA SUBMITTAL	05/27/22
DSA BACK CHECK	08/11/22
DSA ADDENDUM SUBMITTAL	09/16/22

NO.	REVISIONS	DATE
▲	ADDENDUM	09/16/22
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DATE ISSUED 09/16/2022	SCALE 1" = 20'-0"
PROJ. NO. 2203200	SHEET NO. L9.2

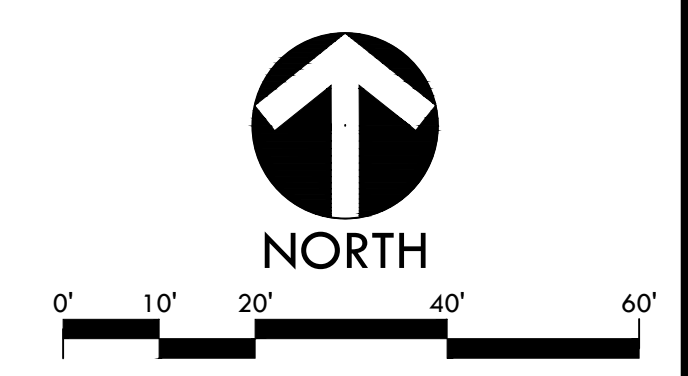

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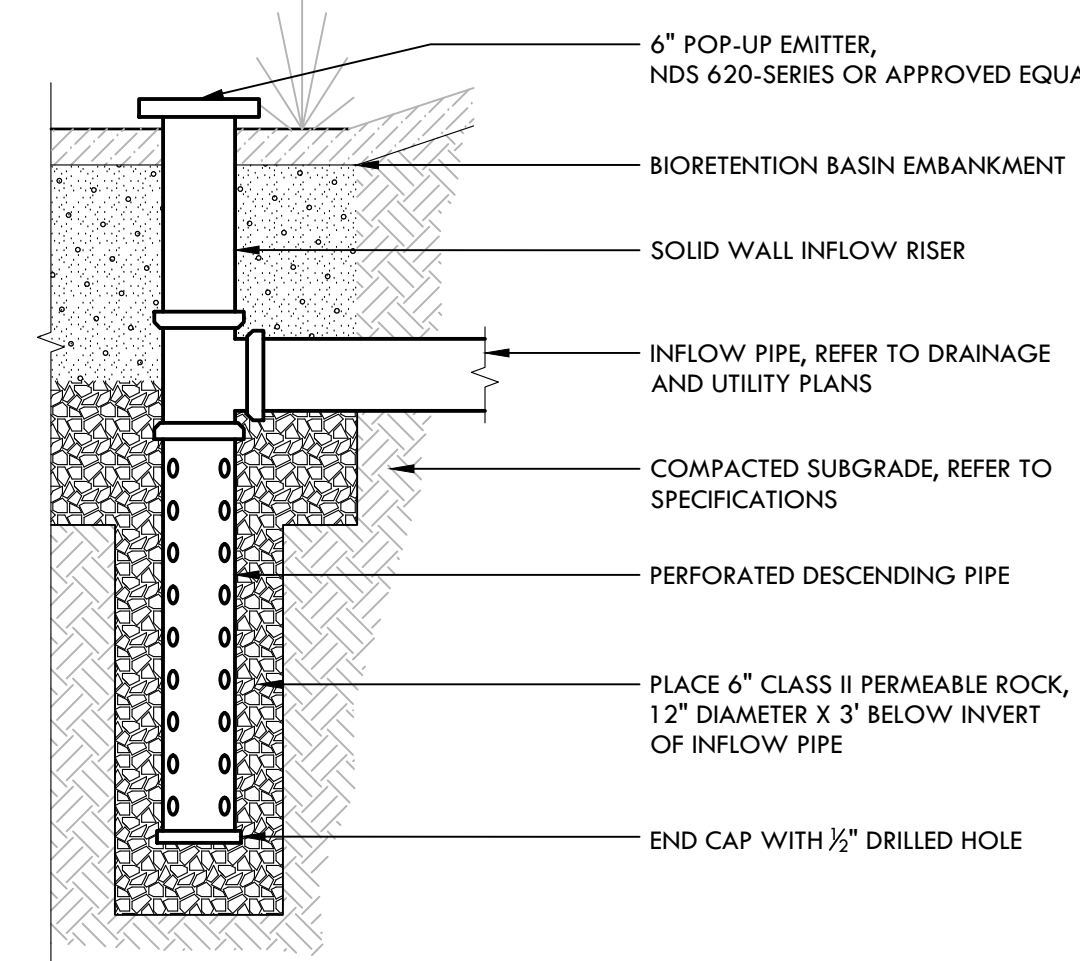


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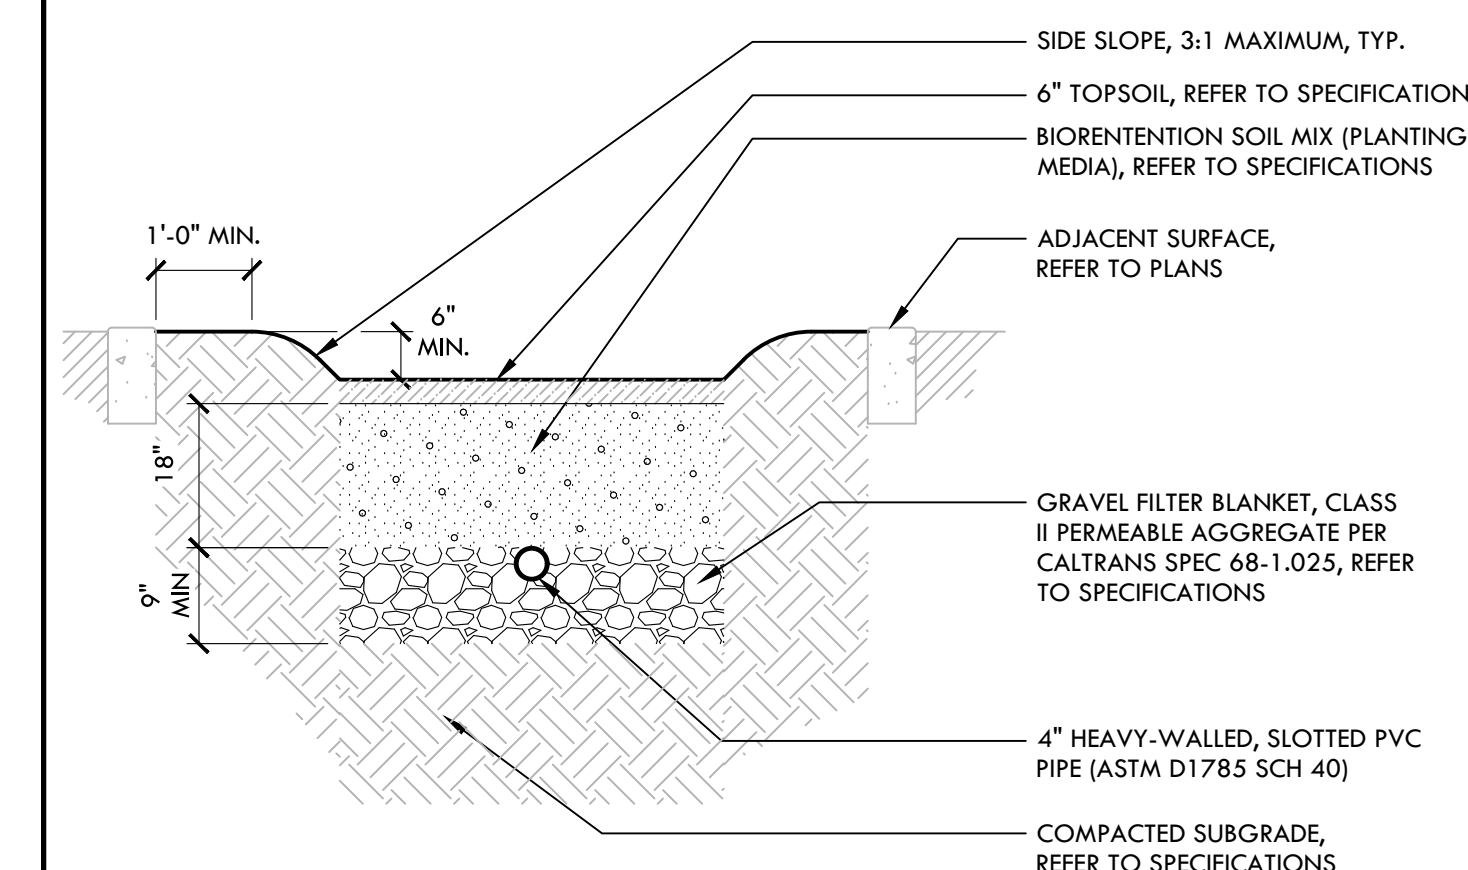
E DRAINAGE BUBBLER
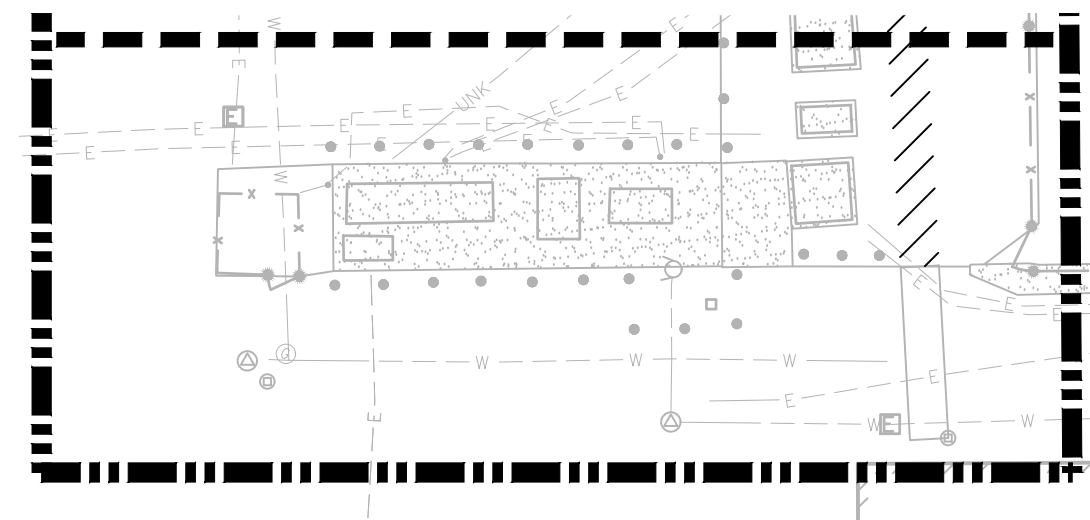
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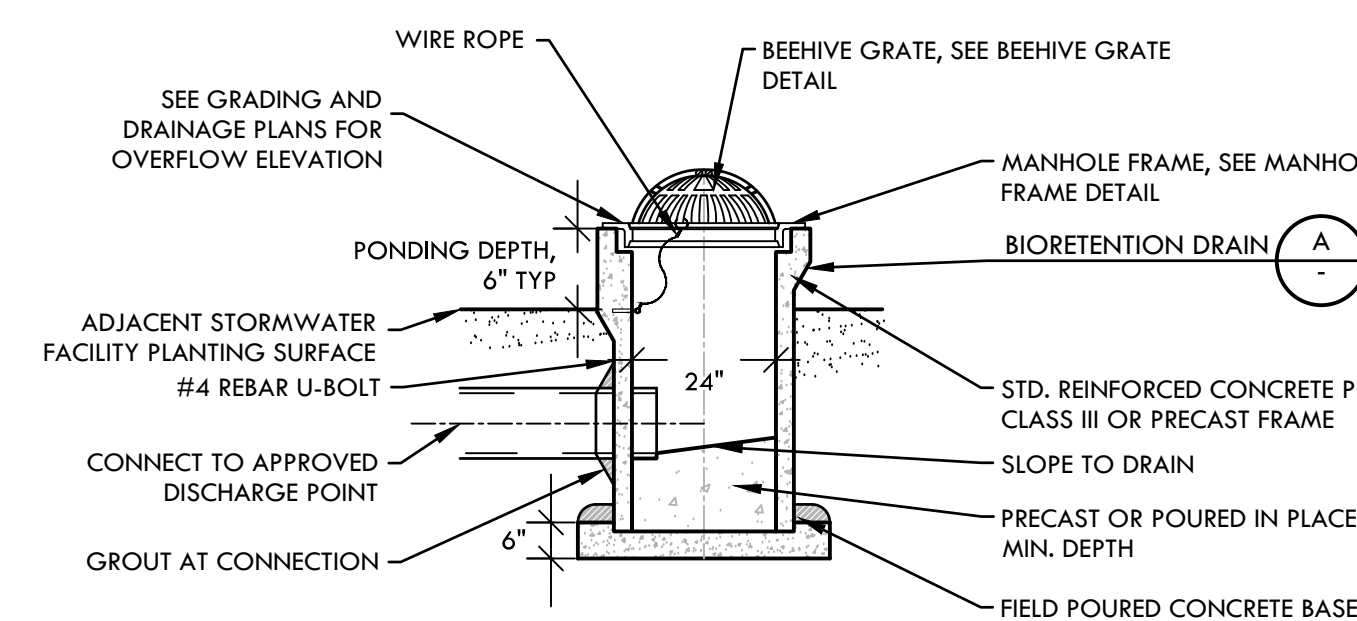


D BIORETENTION AREA

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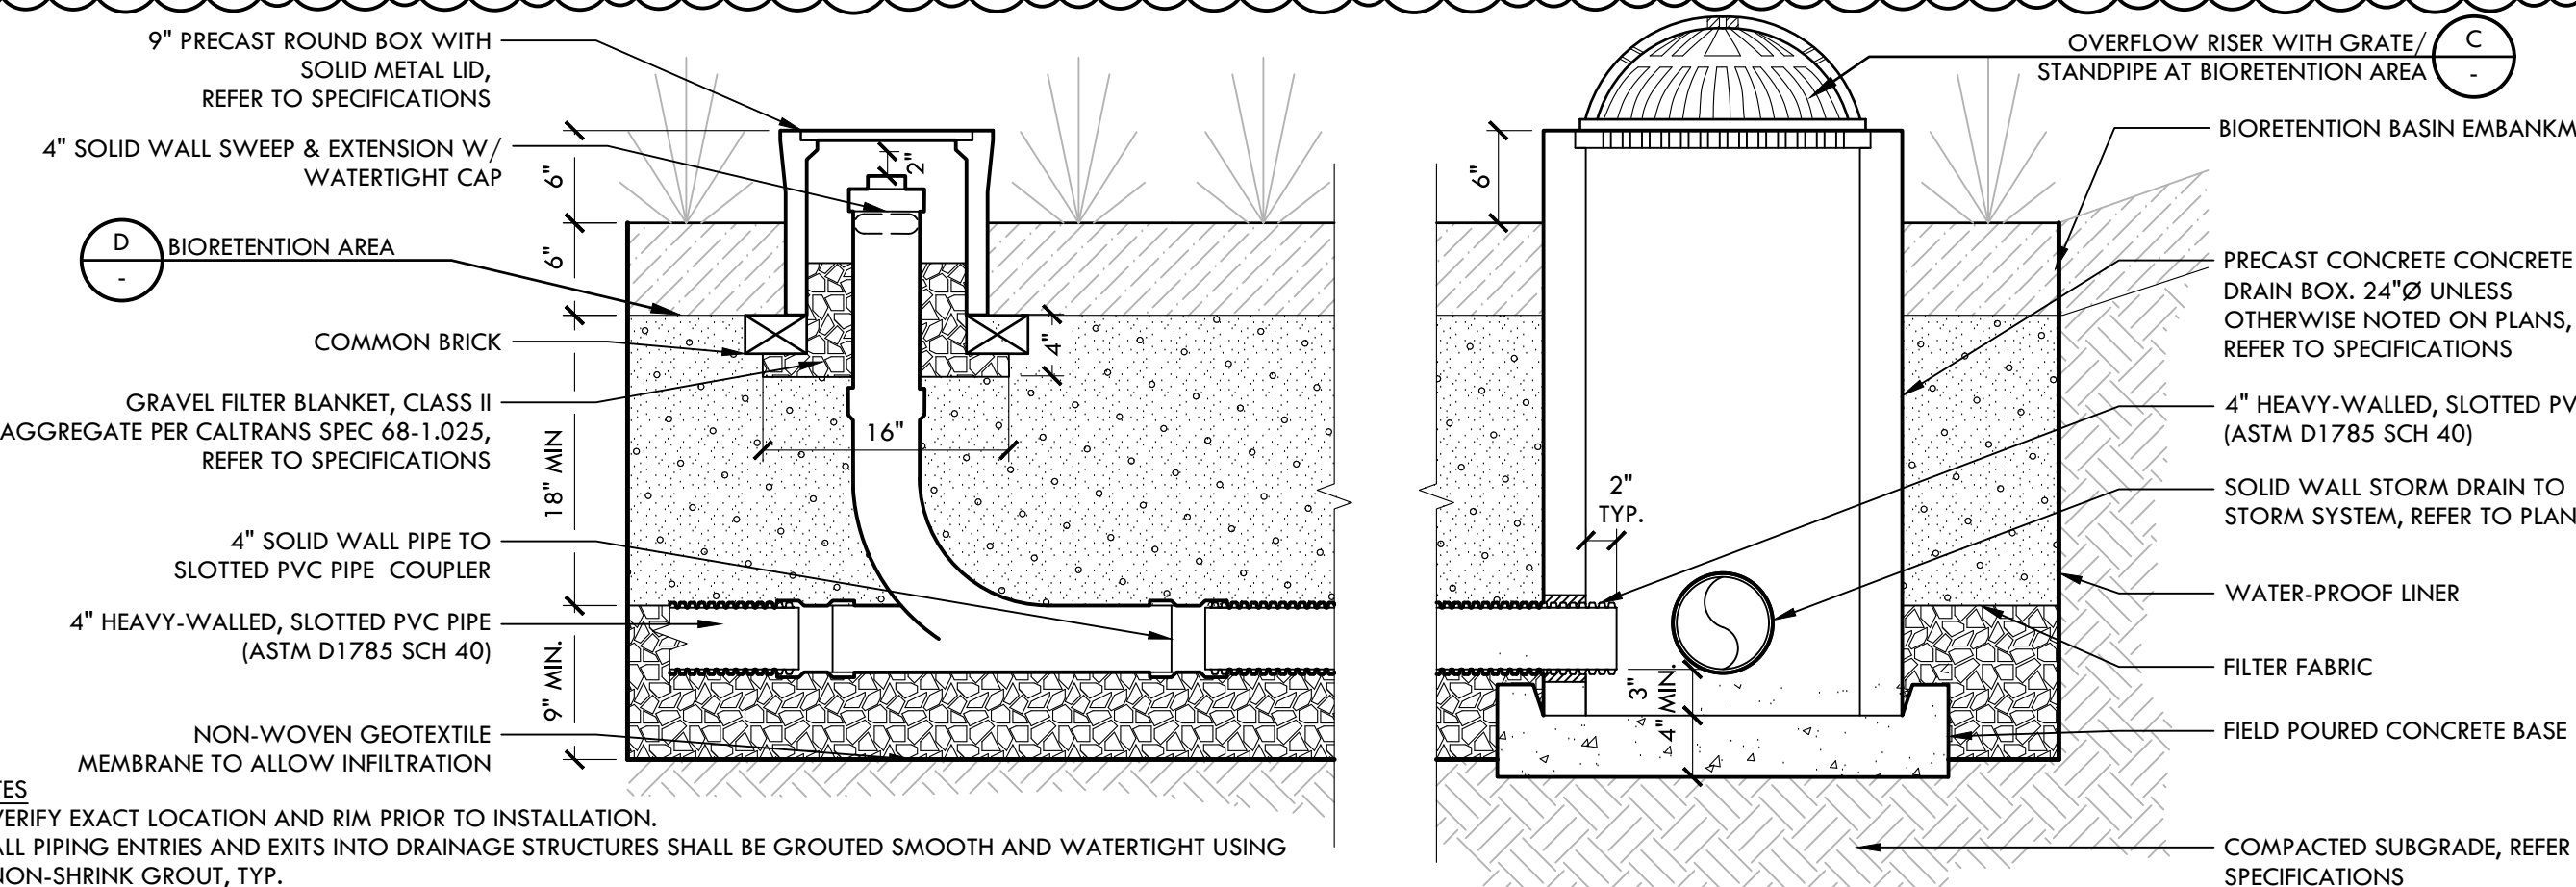
C OVERFLOW RISER WITH GRATE/ STANDPIPE

NTS

NOT USED

NOT USED

NOT USED



A INFILTRATION TRENCH AT BIORETENTION AREA

NTS



STAMP

CONSULTANT

KEYMAP

SHEET TITLE

DRAINAGE & UTILITIES DETAILS

PROJECT NAME

**HIRAM JOHNSON
HIGH SCHOOL
GOLF PRACTICE FACILITY,
VARSITY BASEBALL AND
SOFTBALL FIELDS**

PROJECT ADDRESS

**6879 14TH AVENUE
SACRAMENTO, CA 95820**

SUBMITTAL

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DATE ISSUED

09/16/2022

SCALE

AS NOTED

PROJ. NO.

2203200

SHEET NO.

D1.2

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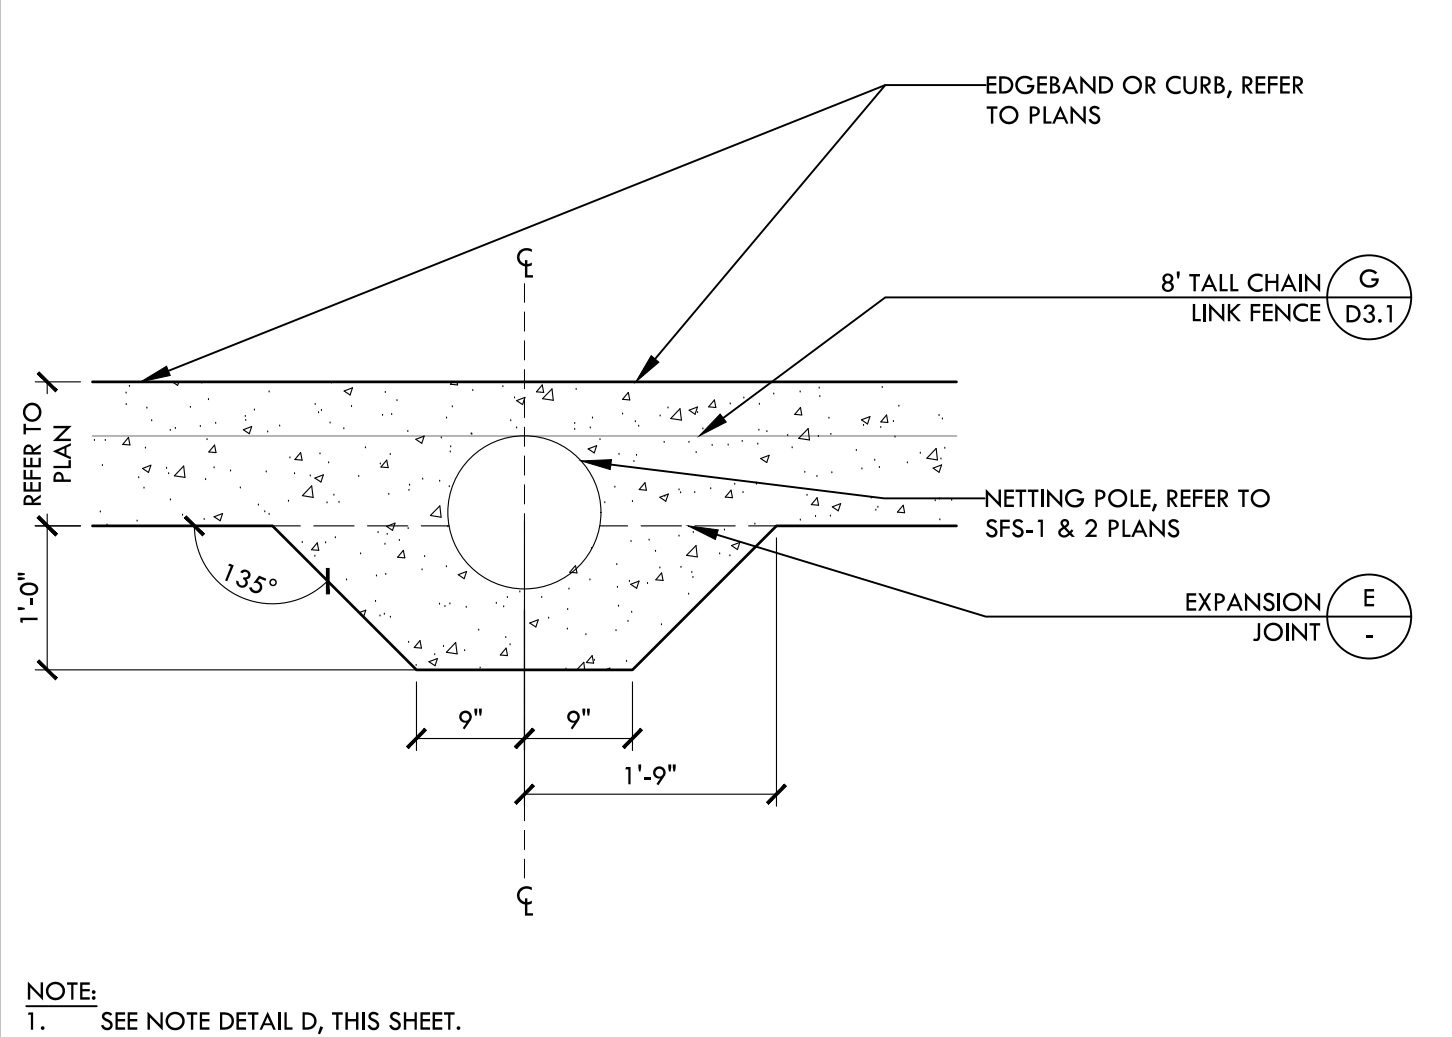


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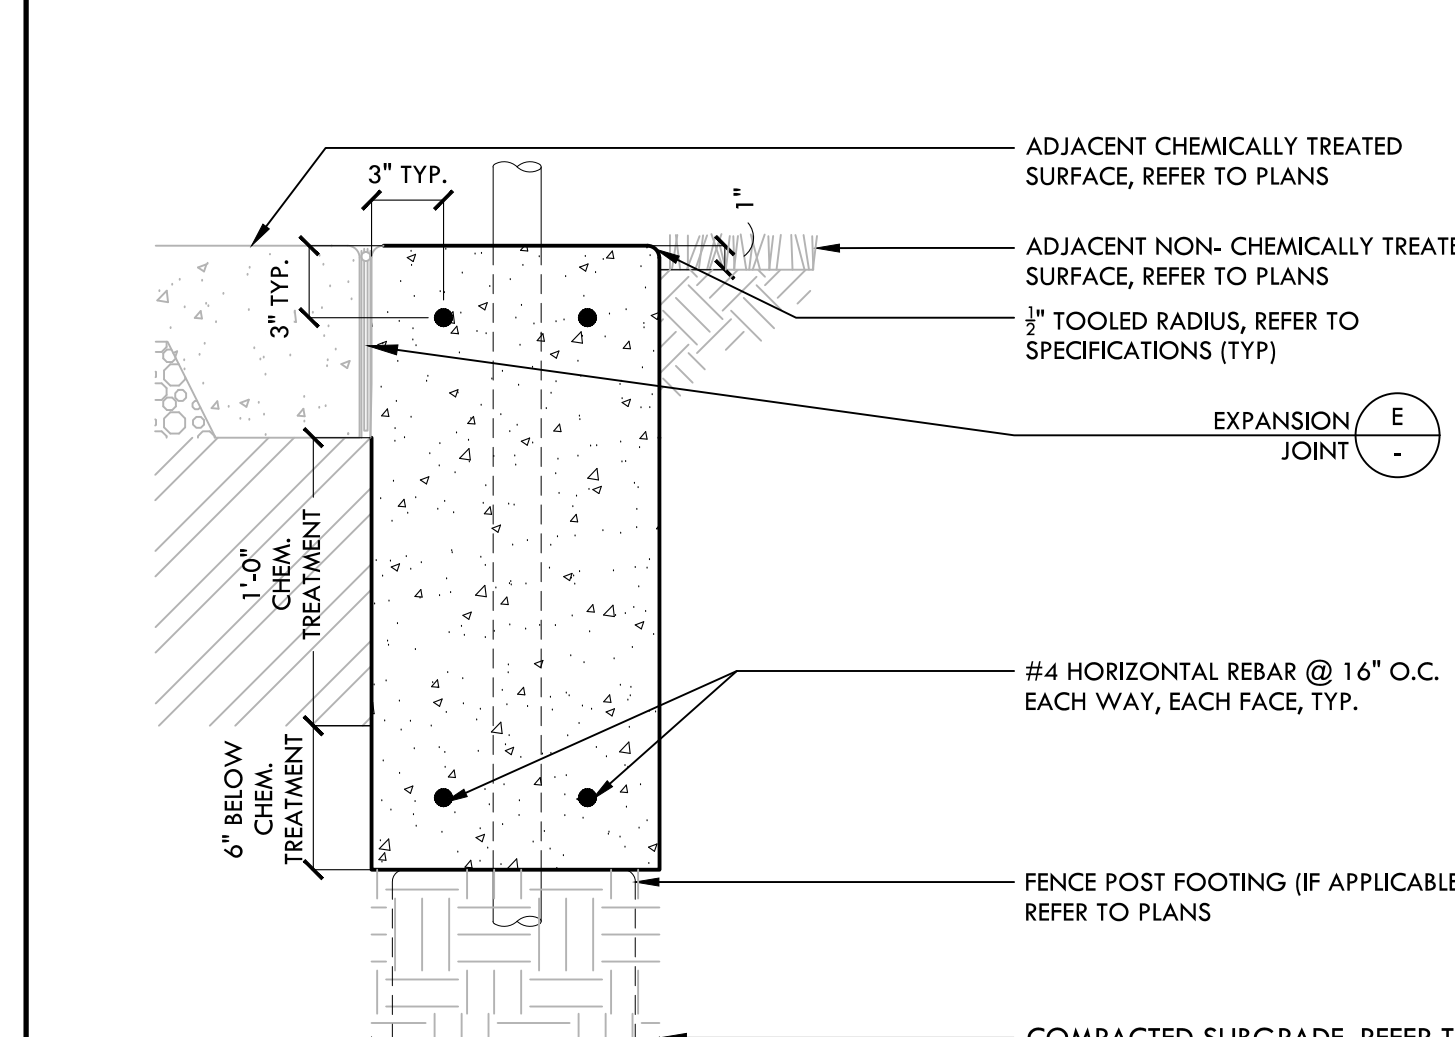
ADJACENT SURFACE, REFER TO PLANS
FENCE POST (IF APPLICABLE), REFER TO PLANS
TOOLED RADIUS, TYP., REFER TO SPECIFICATIONS
#4 HORIZONTAL REBAR AT 8" SPACING EACH FACE
CONCRETE CURB SHALL BE ONE POUR
ADJACENT SURFACE, REFER TO PLANS
#4 VERTICAL REBAR AT 16" O.C. SPACING WITH STANDARD HOOKS AT EACH END
FENCE FOOTING REFER TO PLANS

NOTE:
REFER TO EDGE BAND AND TALL CURB NOTES, DETAIL D, THIS SHEET FOR ADDITIONAL INFORMATION.

O 12" WIDE TALL CURB NTS



J CONCRETE COLLAR - NETTING POSTS NTS



D EDGE BAND AND TALL CURB NOTES NTS

NOTES PERTAIN TO ALL EDGE BAND AND CURB DETAILS:

- FOR EDGE BANDS AND CURBS WITH FENCING, INSTALL EXPANSION JOINTS AT ALL CORNERS, BEGINNINGS, AND ENDINGS OF RADI, AND AT ALL FENCE POSTS. INSTALL SCORE JOINTS AT 5' O.C. AND OR EVENLY SPACED AND CENTERED BETWEEN FENCE POSTS.
- FOR EDGE BANDS AND CURBS WITHOUT FENCING, INSTALL SCORE JOINTS AT 10' O.C. SPACING AND FIBER EXPANSION JOINTS EVERY 20' ON STRAIGHT RUNS. ON CURVED RUNS, FIBER EXPANSION JOINTS SHALL BE SPACED 10' O.C., WITH ALTERNATING SCORE JOINTS AT 5' O.C. SPACINGS.
- ALL EXPANSION JOINTS SHALL BE SEALED, PER SPECIFICATIONS.

NOTES PERTAIN TO ALL TALL CURB DETAILS:

- PROVIDE EXPANSION JOINTS AT 16' O.C. SPACING, CENTERED BETWEEN FENCE POSTS.
- PROVIDE EXPANSION JOINTS AT EACH LOCATION WHERE AN ELEVATION STEP OCCURS BETWEEN CHANGING CURB/EDGE BAND TYPES.
- AT EXPANSION JOINTS, PROVIDE A 24" LONG #4 DOWEL AT EACH CURB HORIZONTAL REBAR, CENTERED ON THE JOINT, AS PER DETAIL.
- EXPANSION JOINTS SHALL BE INSTALLED WITH A 3/4" CHAMFER BUILT INTO THE FORM WORK, IN ADDITION TO THE FIBER EXPANSION JOINT MATERIAL.
- PROVIDE A CONTROL JOINT AT EACH FENCE POST. THE VERTICAL JOINT SHALL BE A 3/4" CHAMFER BUILT INTO THE FORM WORK. THE HORIZONTAL JOINT, ALONG THE TOP OF CURB, SHALL BE A TOOLED SCORE JOINT, ALIGNED WITH AND MATCHING THE VERTICAL CHAMFER JOINT.
- ALL EXPANSION JOINTS SHALL BE SEALED PER SPECIFICATION.
- NO SCORE JOINTS ARE REQUIRED ON TALL CURBS, EXCEPT AS INDICATED AT EACH FENCE POST IN ITEM #5 ABOVE.

FINISHES
EDGE BANDS AND CURBS: MEDIUM BROOM
WALL AND TALL CURBS: MEDIUM SAND BLAST - TOP AND SIDES

VERDE DESIGN
LANDSCAPE ARCHITECTURE
CIVIL ENGINEERING
SPORT PLANNING & DESIGN

1843 Iron Point Rd. Suite 140
Folsom, CA 95630
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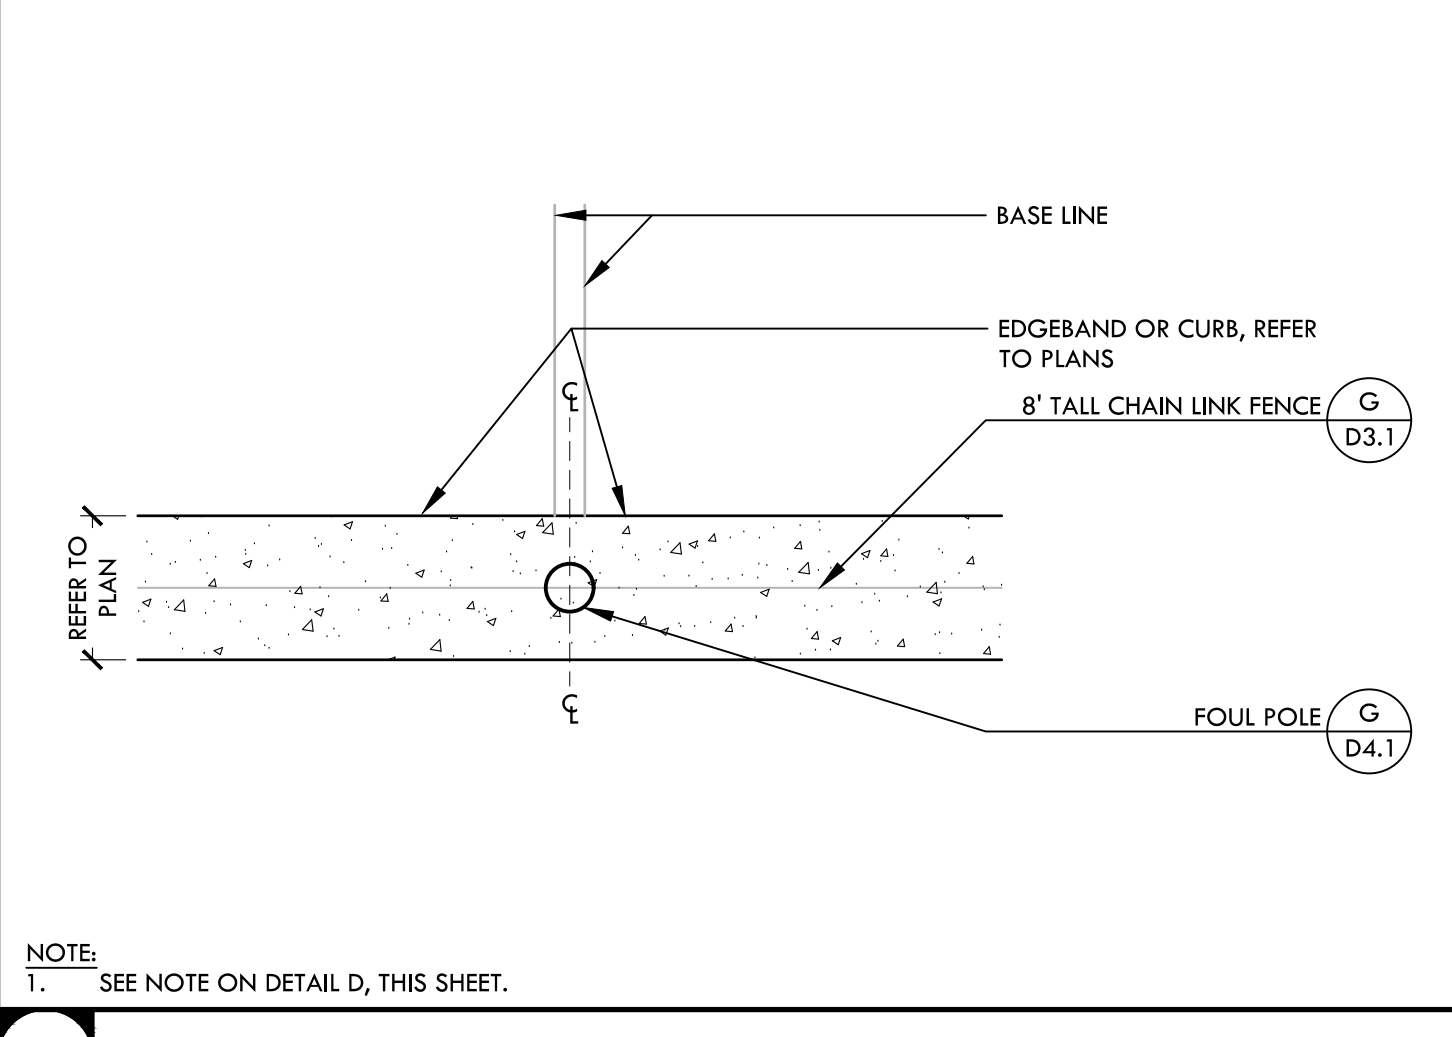
SECTION

ADJACENT NON-CHEMICALLY TREATED SURFACE, REFER TO PLANS
CHEMICALLY TREATED AND COMPACTED SUBGRADE, REFER TO SPECIFICATIONS
#4 HORIZONTAL REBAR @ 12" O.C., CONTINUOUS, TYP.
#4 VERTICAL REBAR @ 12" O.C., TYP.
180° HOOKS TOP AND BOTTOM (TYP.)
COMPACTED AGGREGATE BASE, REFER TO SPECIFICATIONS
COMPACTED SUBGRADE, REFER TO SPECIFICATIONS


EDGE BAND ADJACENT TO NON-CHEMICALLY TREATED SURFACES

NOTE:
REFER TO EDGE BAND AND CURB NOTES, ON DETAIL D, THIS SHEET, FOR ADDITIONAL INFORMATION


M 6" WIDE EDGE BAND NTS




I FOUL POLE ALIGNMENT NTS

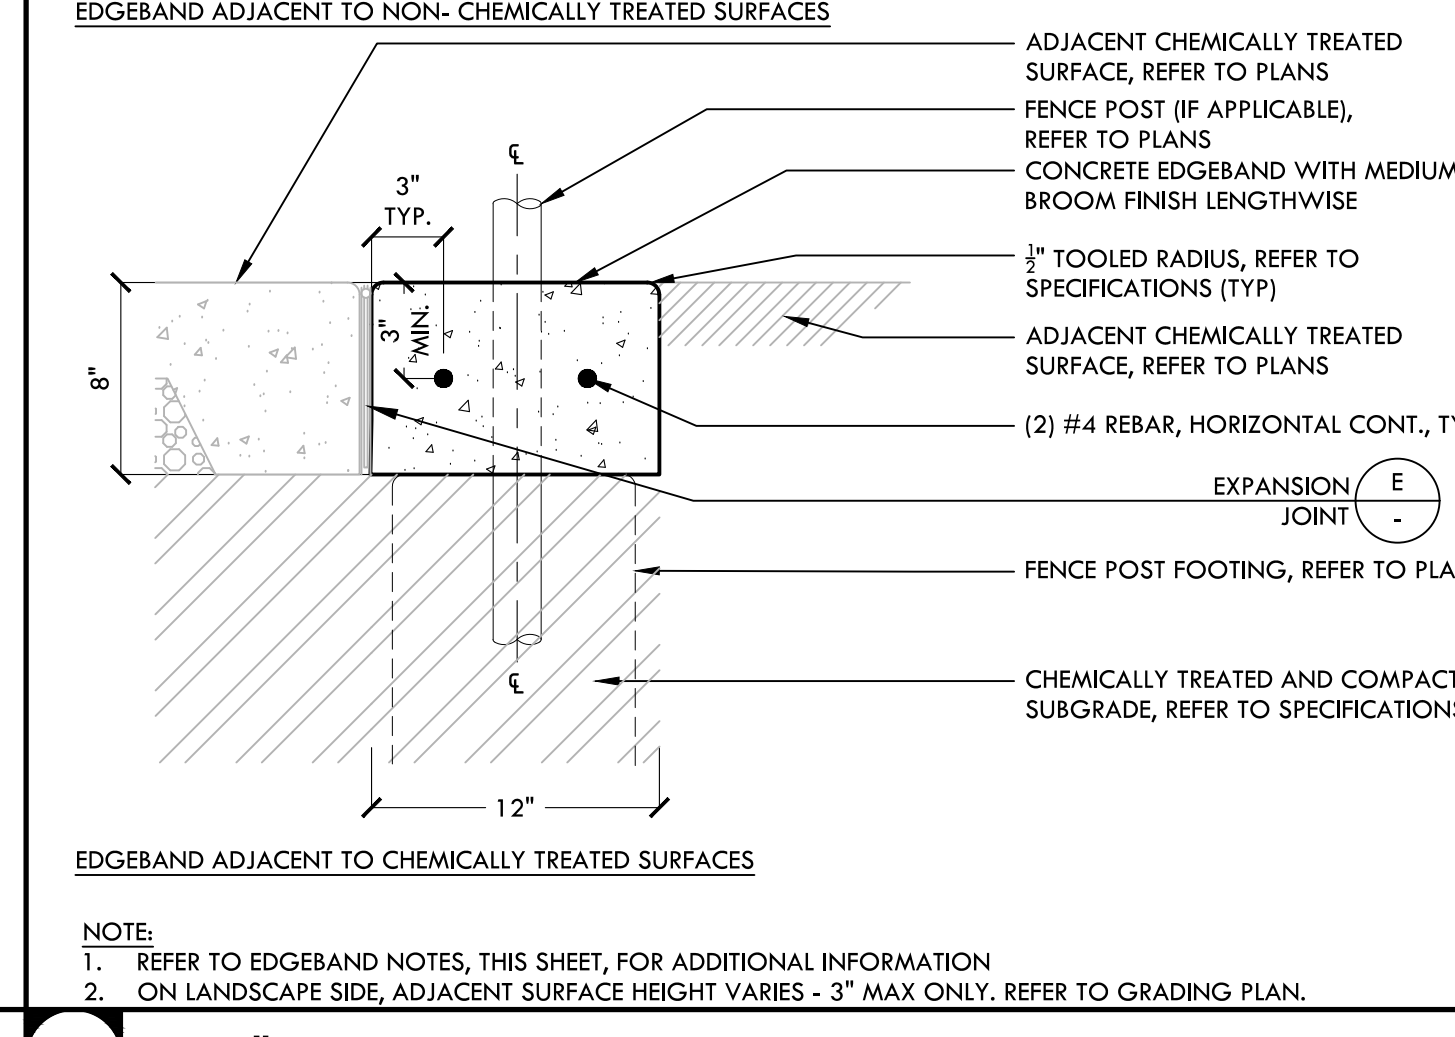

F 12" WIDE EDGE BAND NTS

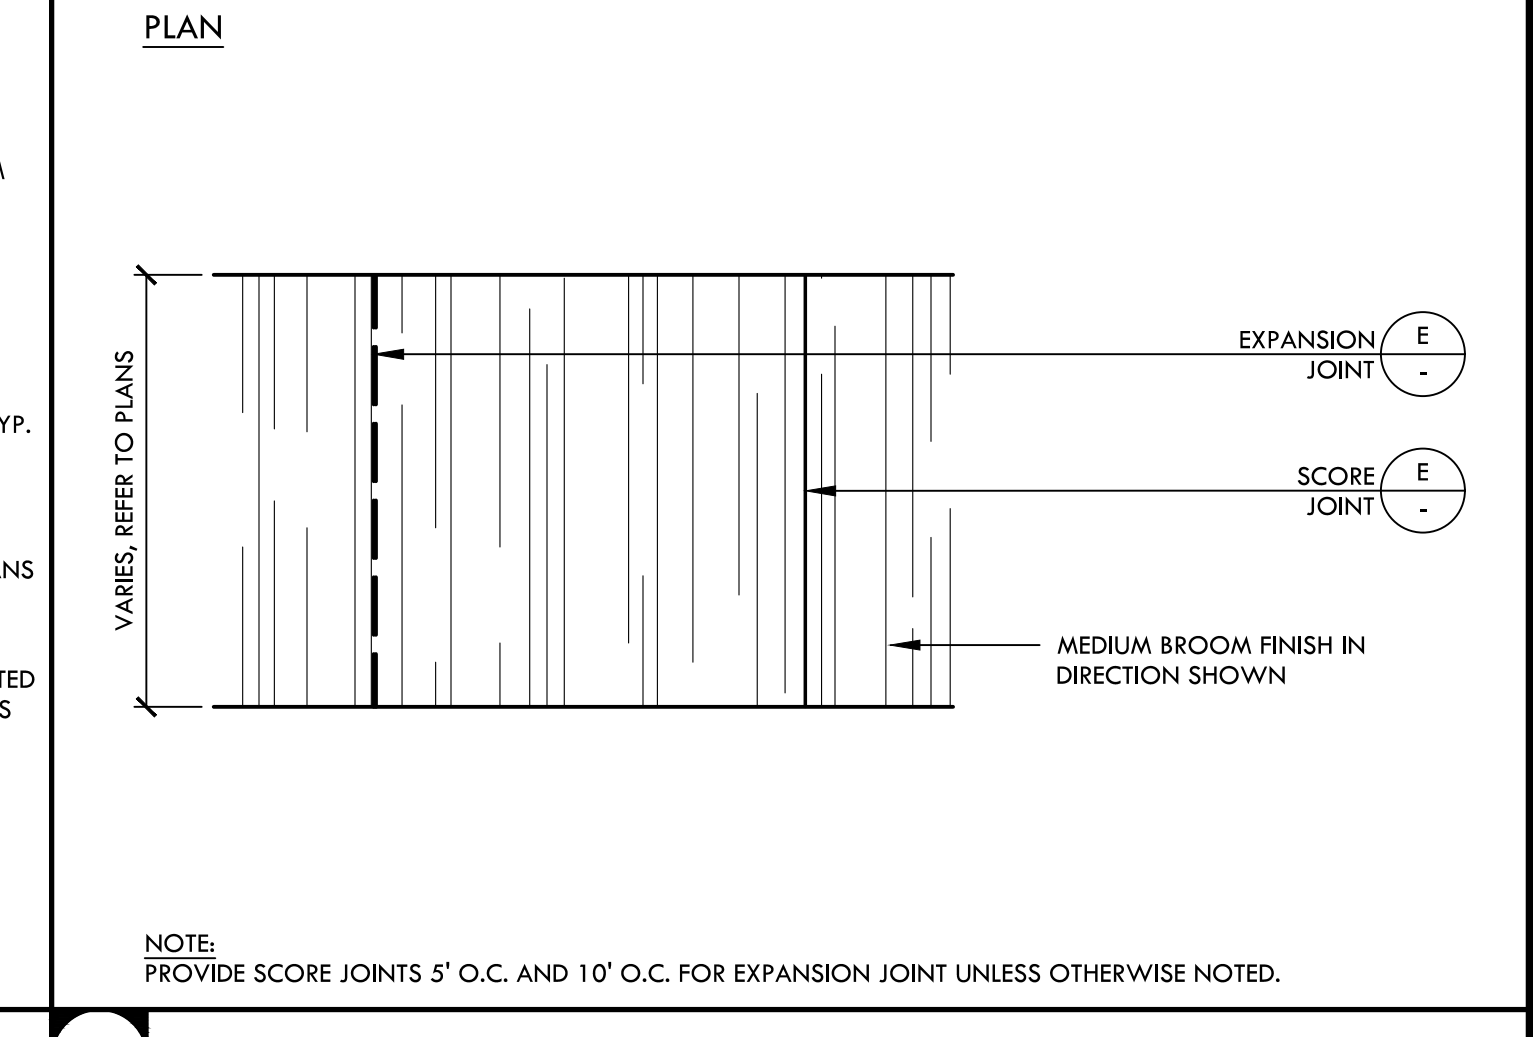

C CONCRETE PAVING FINISH NTS

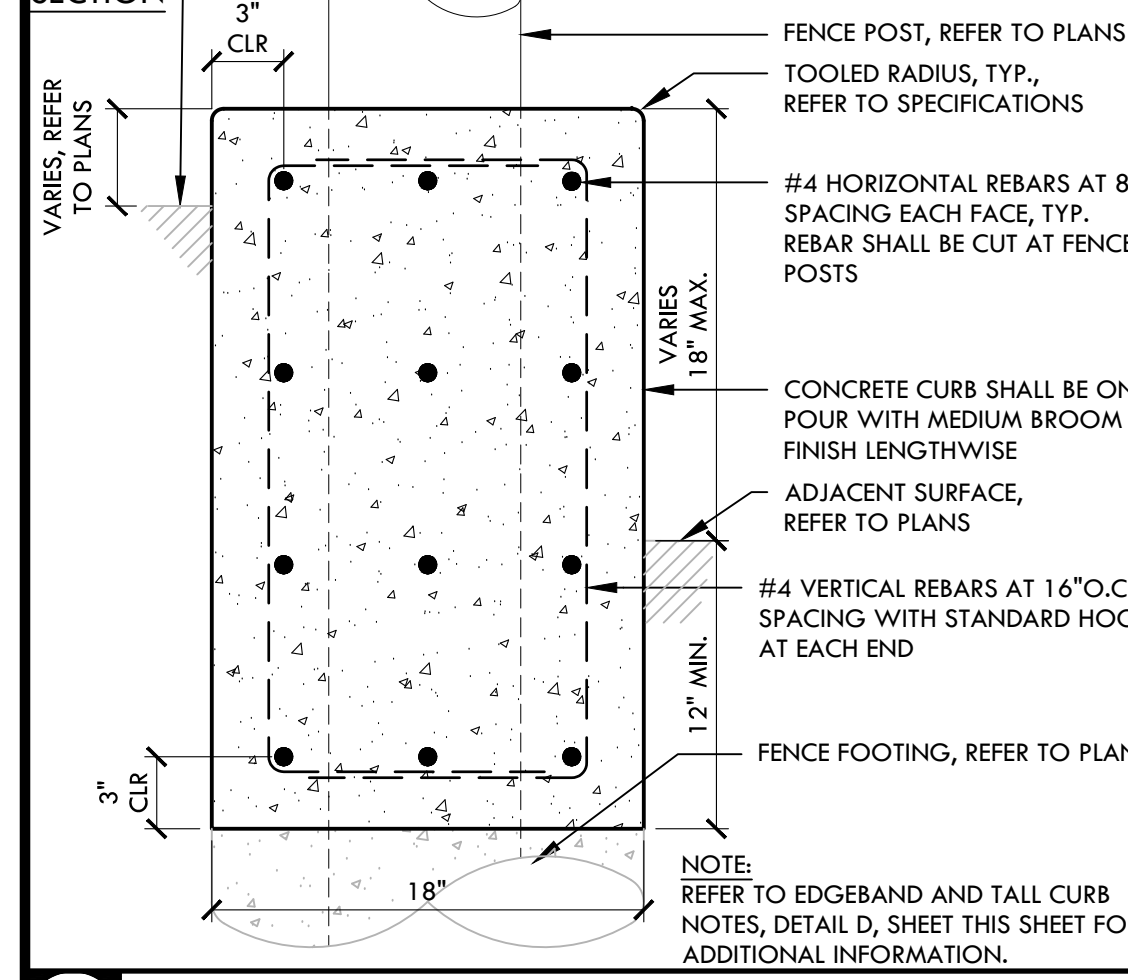


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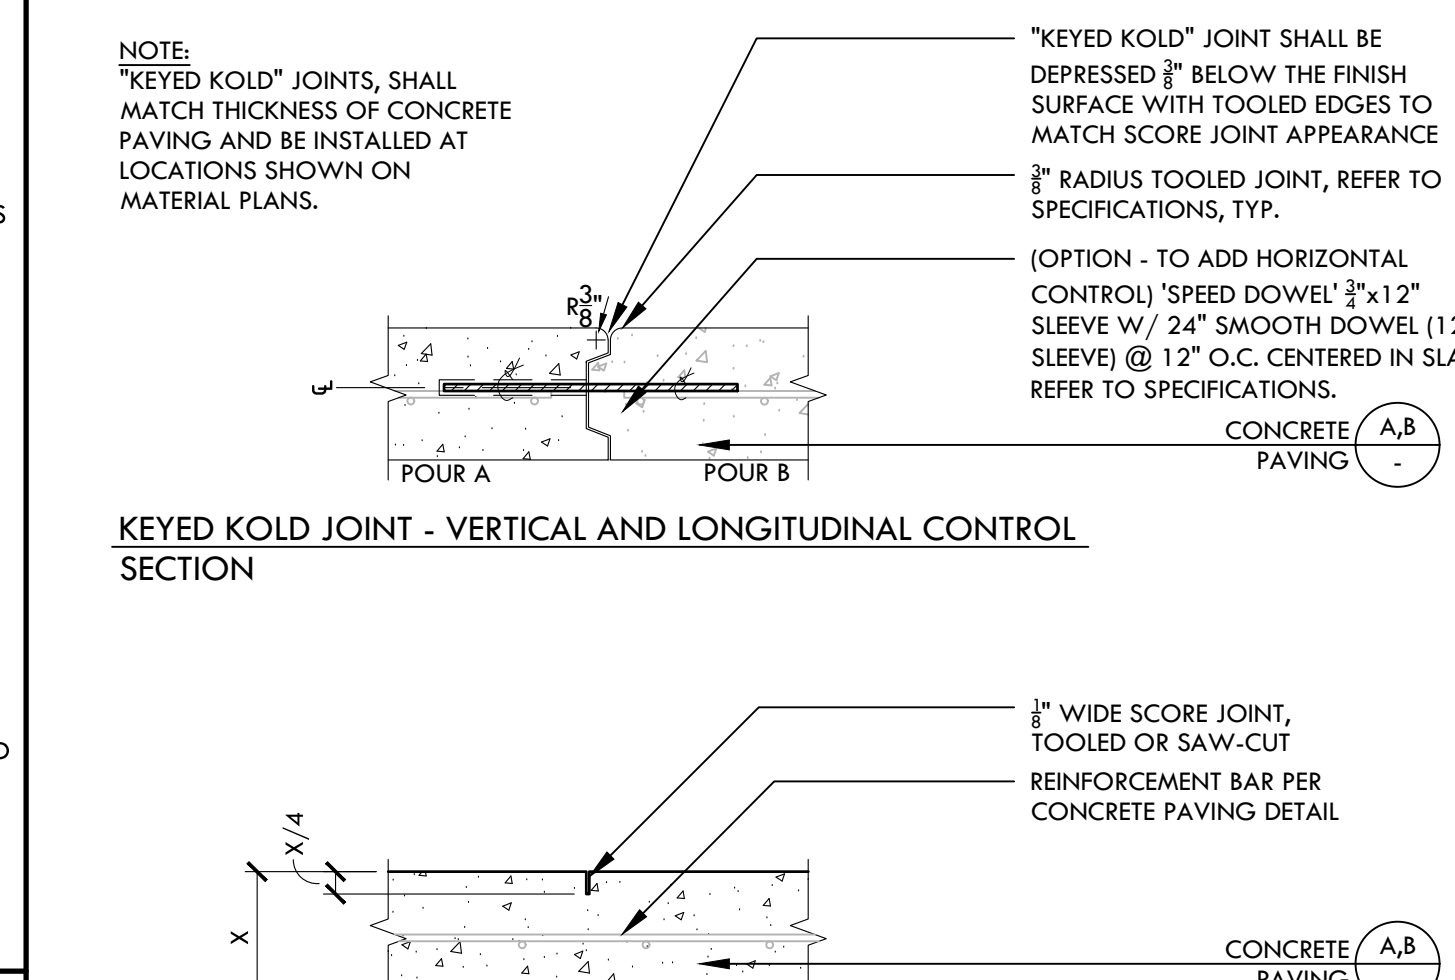
ADJACENT SURFACE, REFER TO PLANS
FENCE POST, REFER TO PLANS
TOOLED RADIUS, TYP., REFER TO SPECIFICATIONS
#4 HORIZONTAL REBAR AT 8" SPACING EACH FACE, TYP. REBAR SHALL BE CUT AT FENCE POSTS
CONCRETE CURB SHALL BE ONE POUR WITH MEDIUM BROOM FINISH LENGTHWISE
ADJACENT SURFACE, REFER TO PLANS
#4 VERTICAL REBAR AT 16" O.C. SPACING WITH STANDARD HOOKS AT EACH END
FENCE FOOTING, REFER TO PLANS

NOTE:
REFER TO EDGE BAND AND TALL CURB NOTES, DETAIL D, SHEET THIS SHEET FOR ADDITIONAL INFORMATION.


R 18" WIDE TALL CURB WITH FENCE NTS

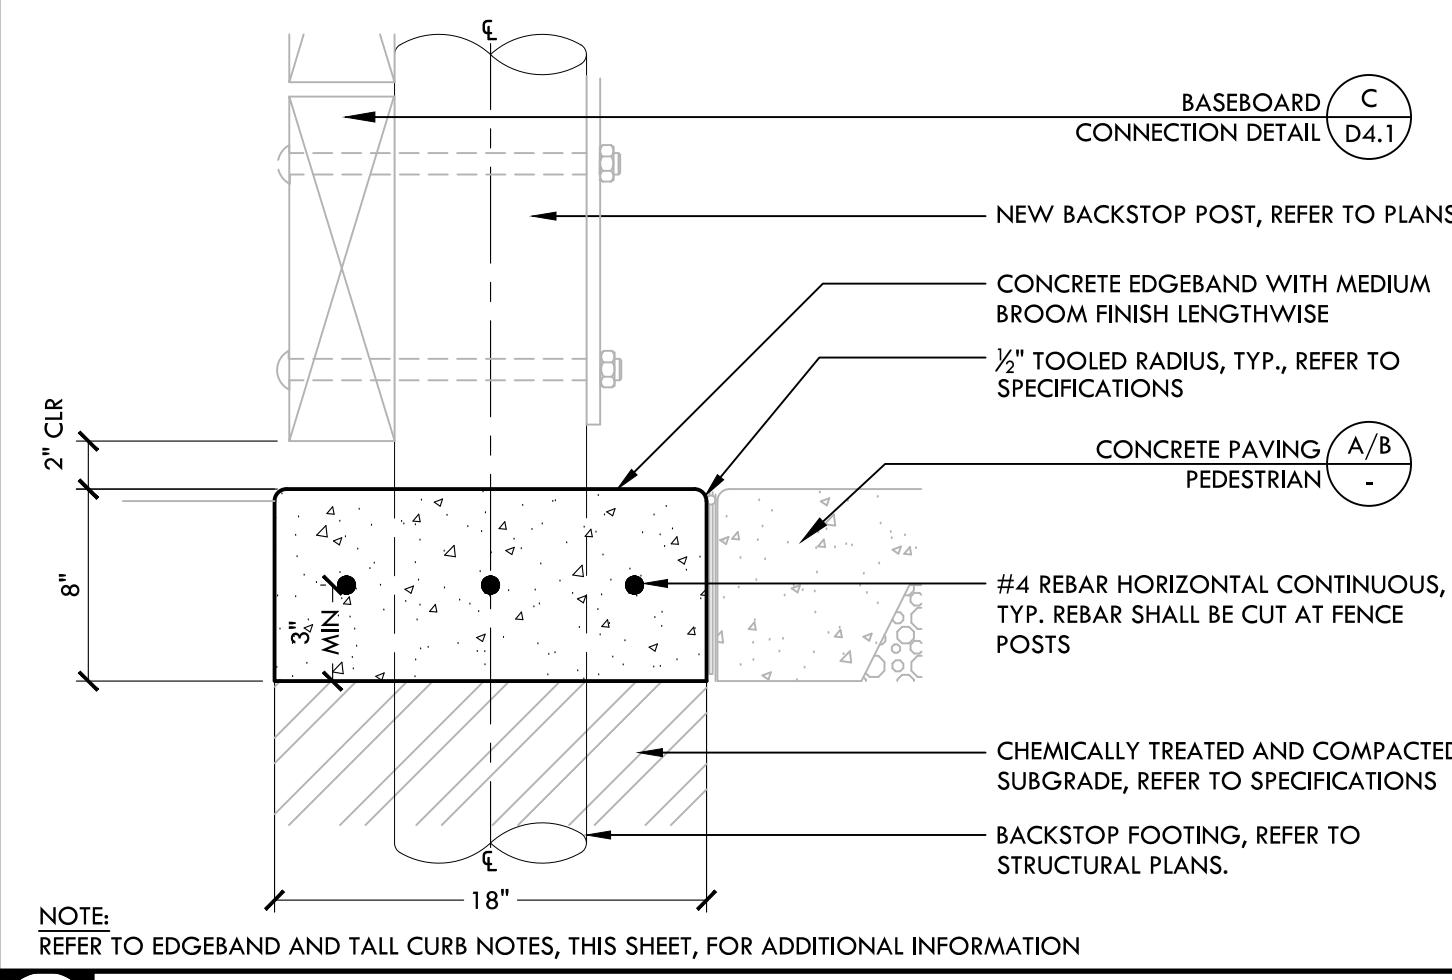



H 18" WIDE BACKSTOP EDGE BAND NTS




F KEYED KOLD JOINT - VERTICAL AND LONGITUDINAL CONTROL SECTION

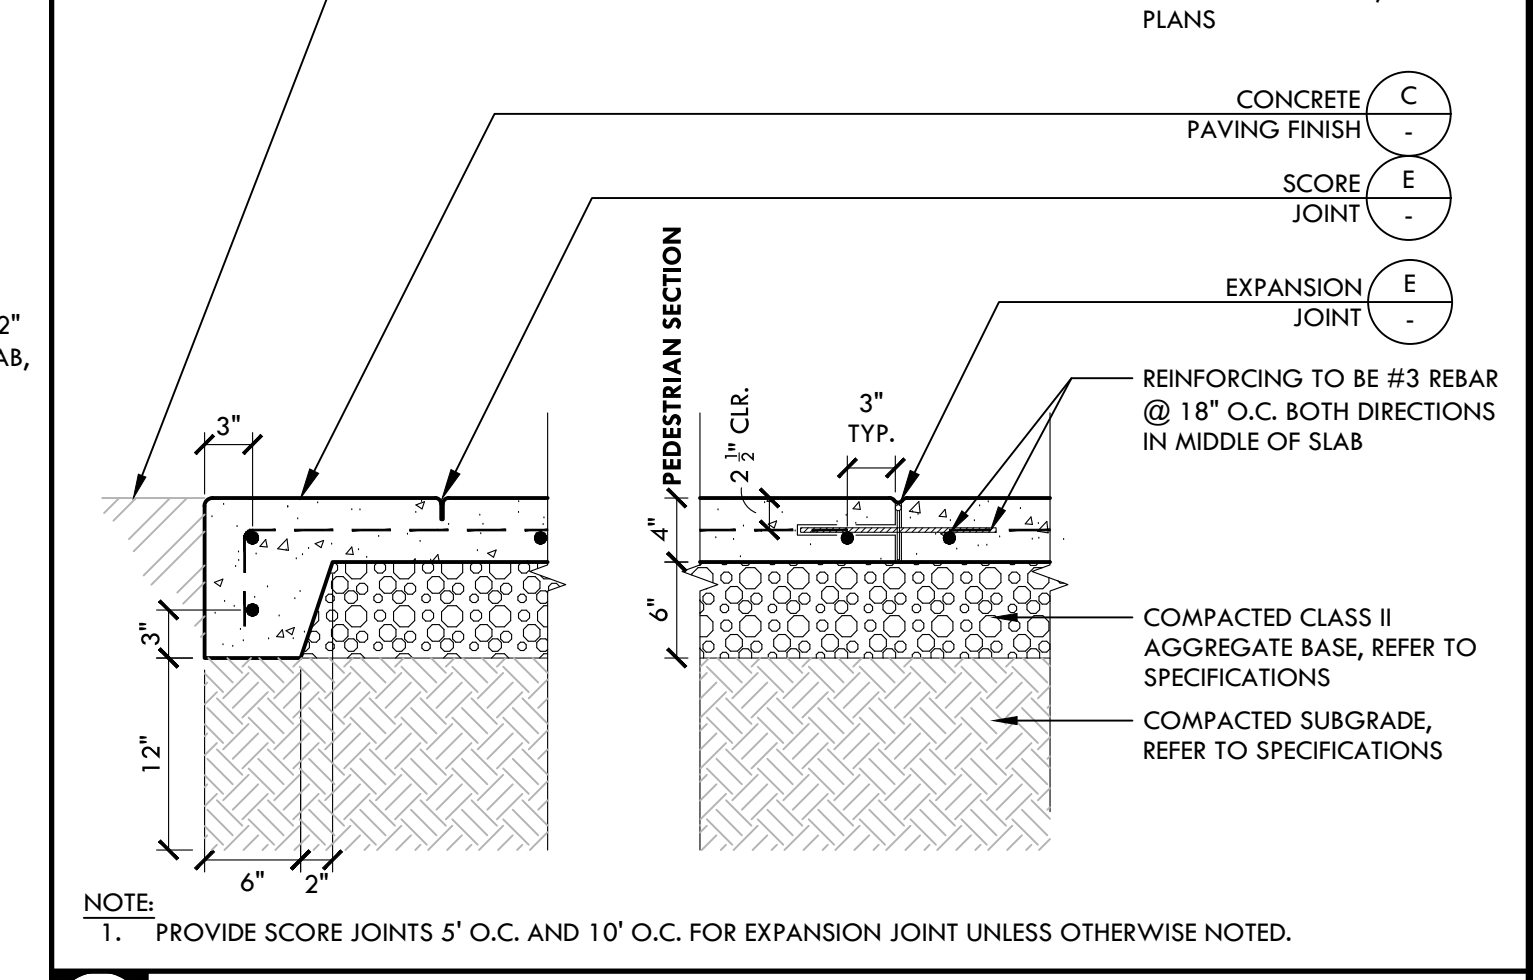


B CONCRETE PAVING - NON CHEMICALLY TREATED NTS

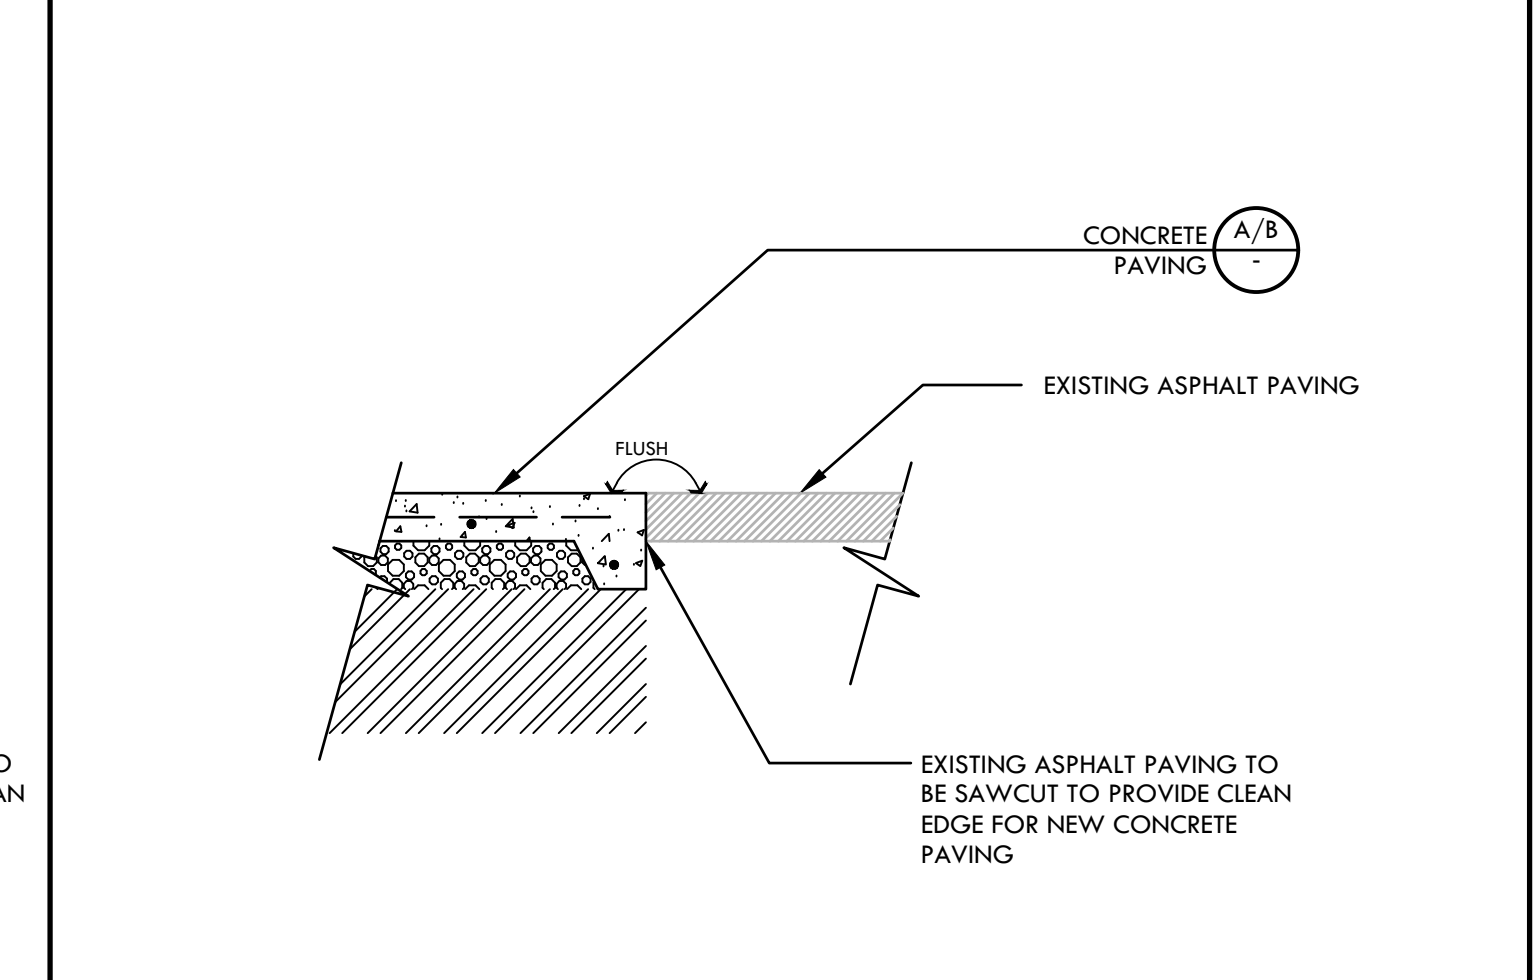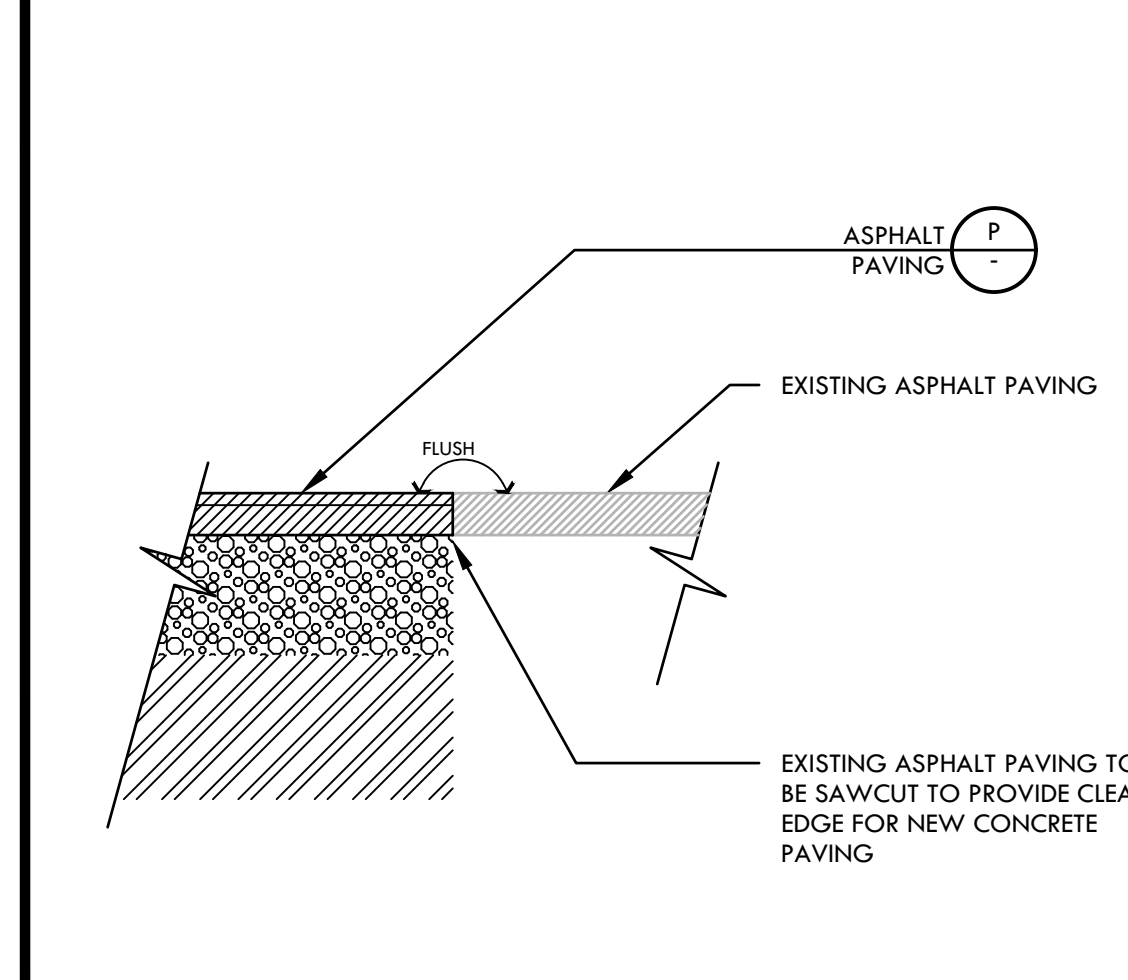


L PROPOSED CONCRETE/ EXISTING AC CONFORM NTS

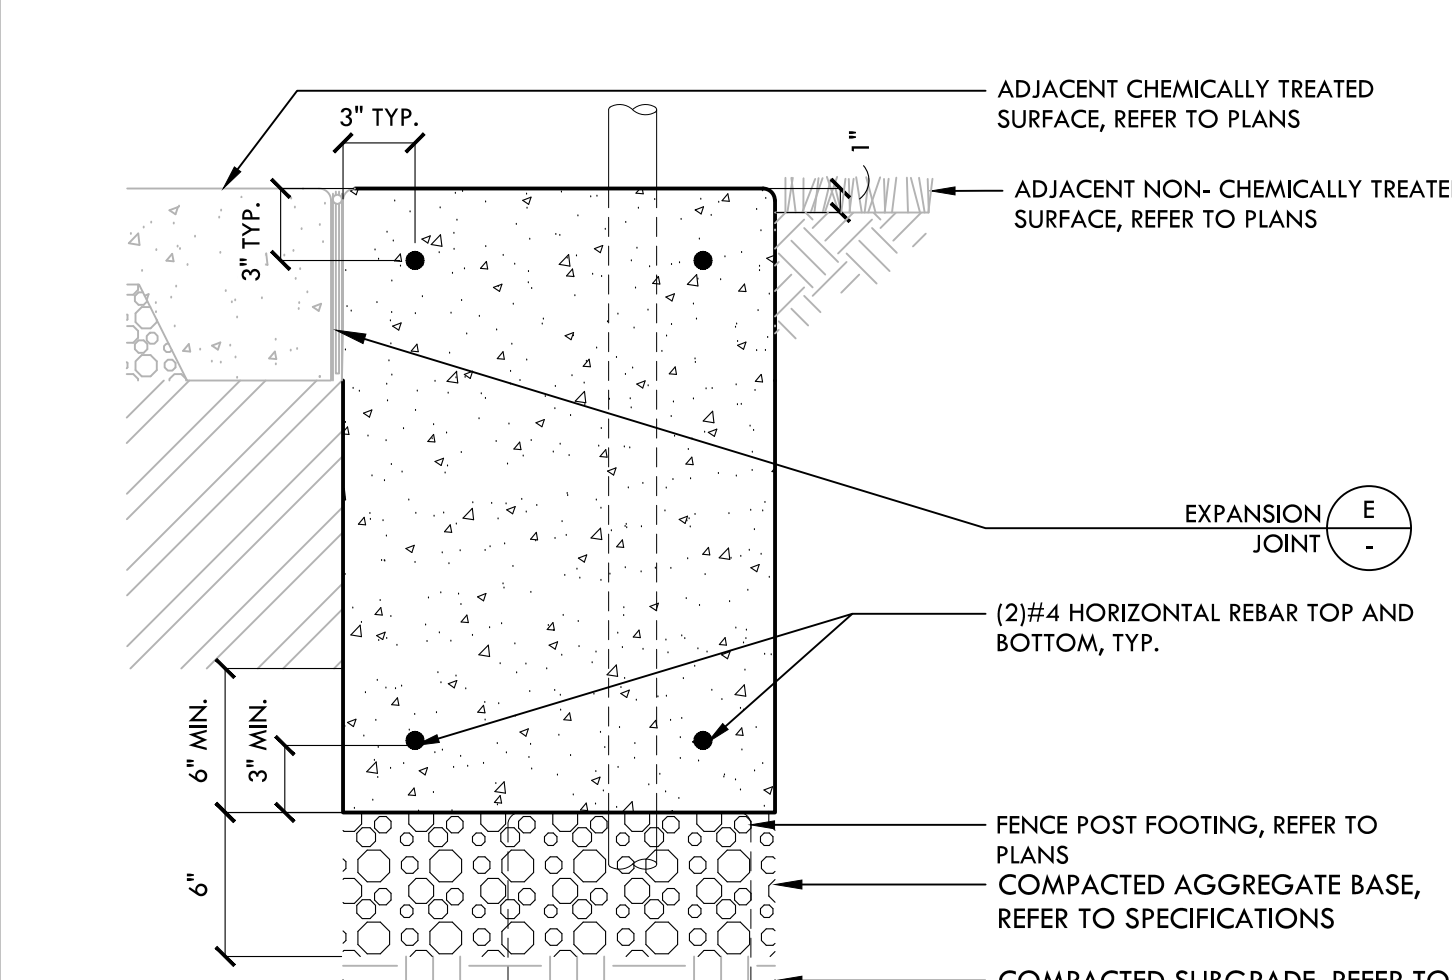



G 18" WIDE EDGE BAND WITH FENCE NTS

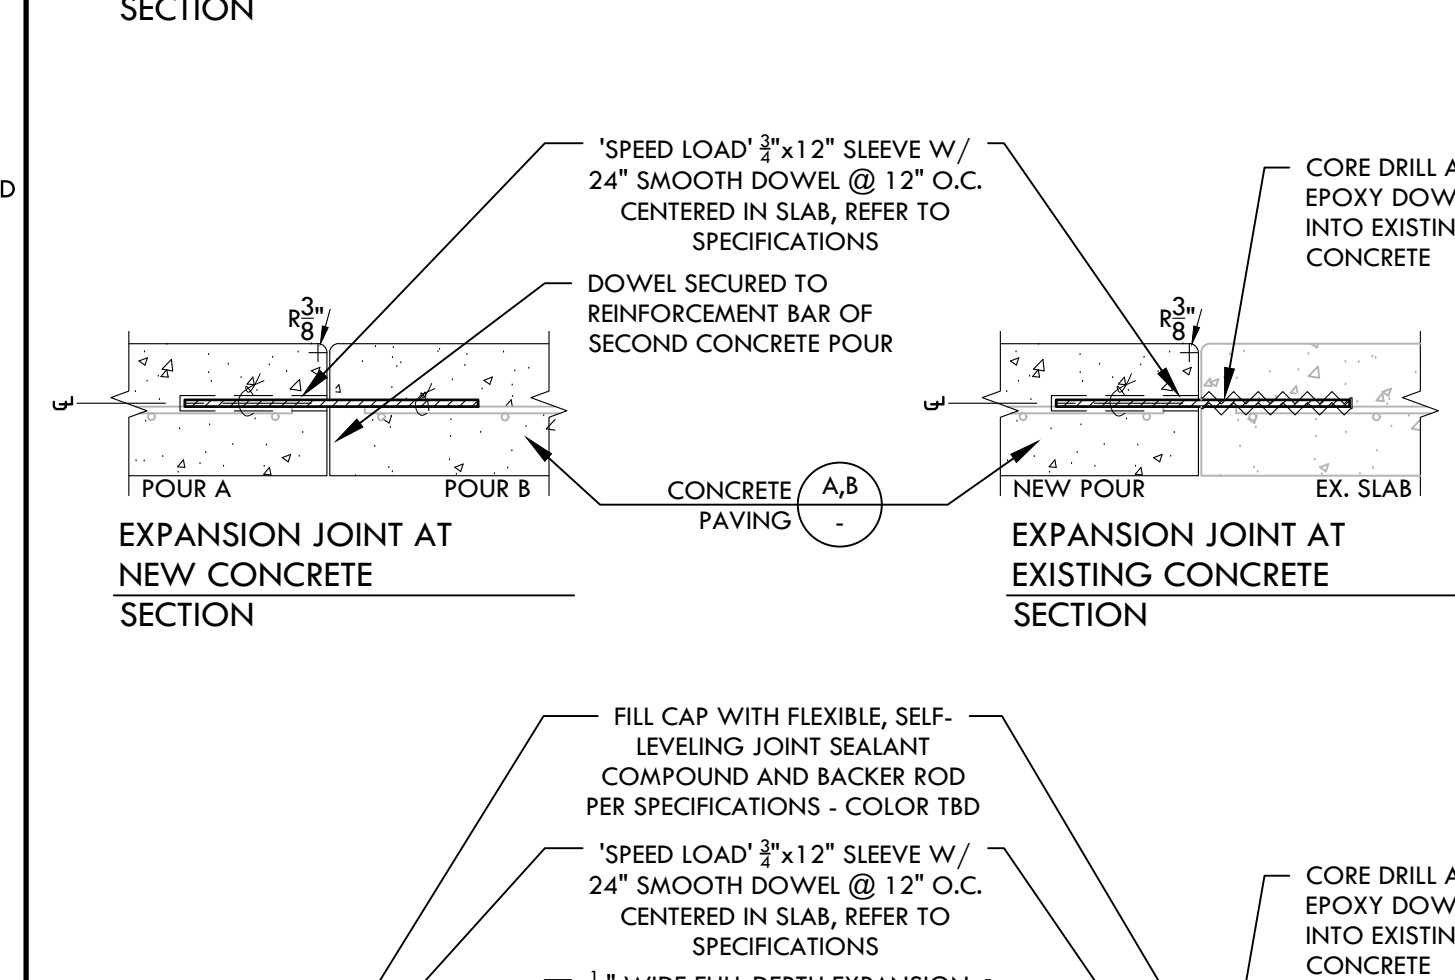


E CONCRETE JOINTS NTS

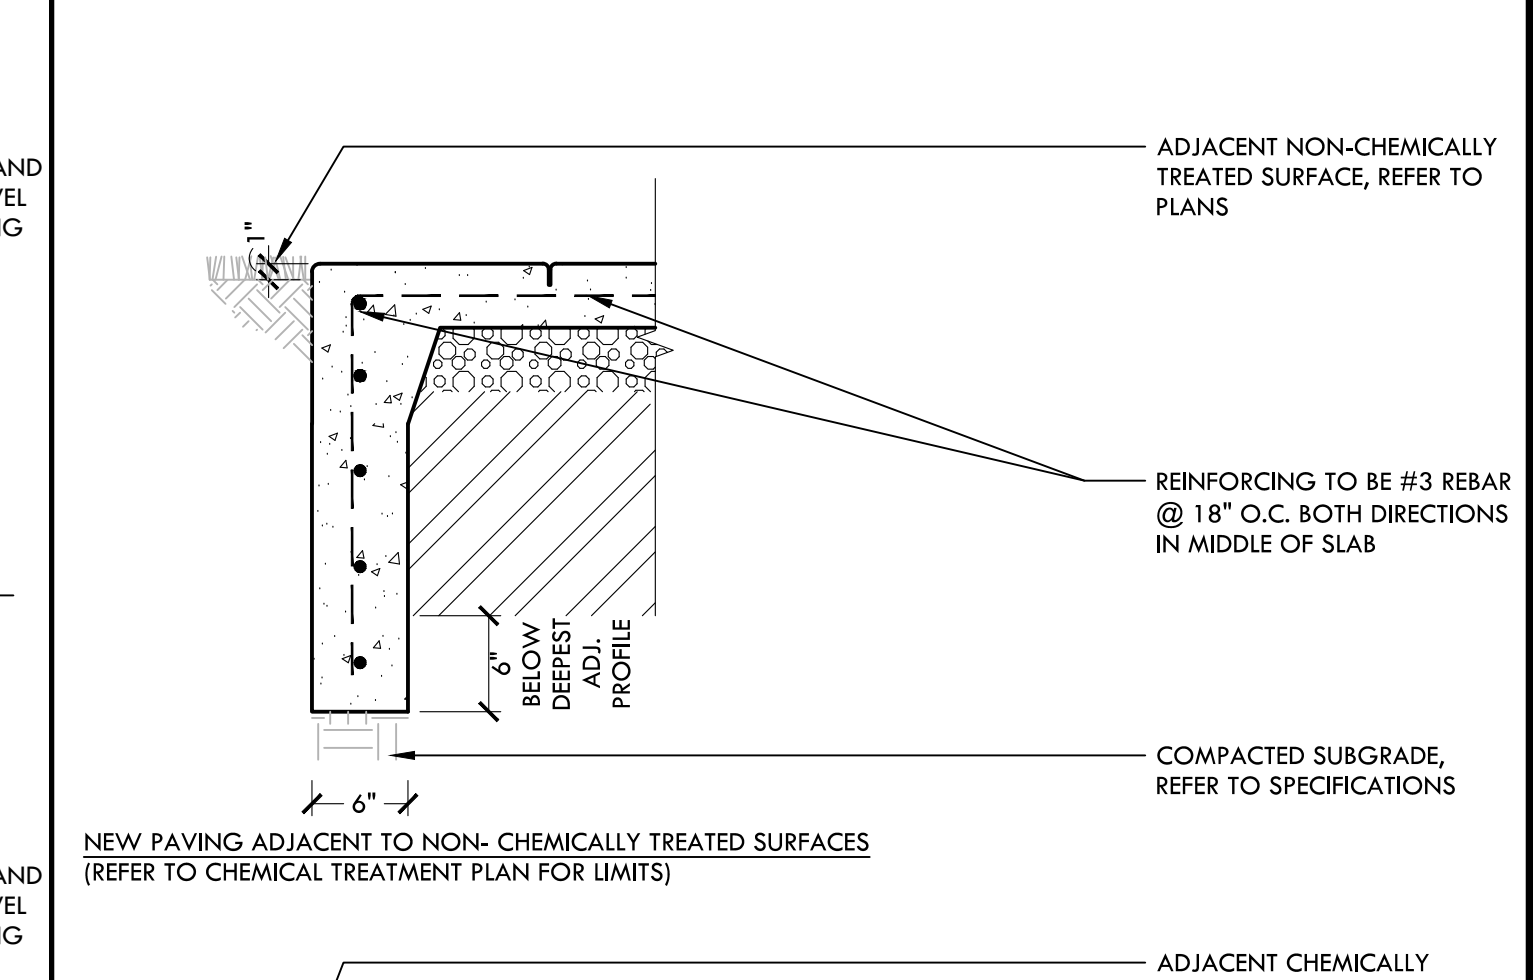


A CONCRETE PAVING - CHEMICALLY TREATED NTS

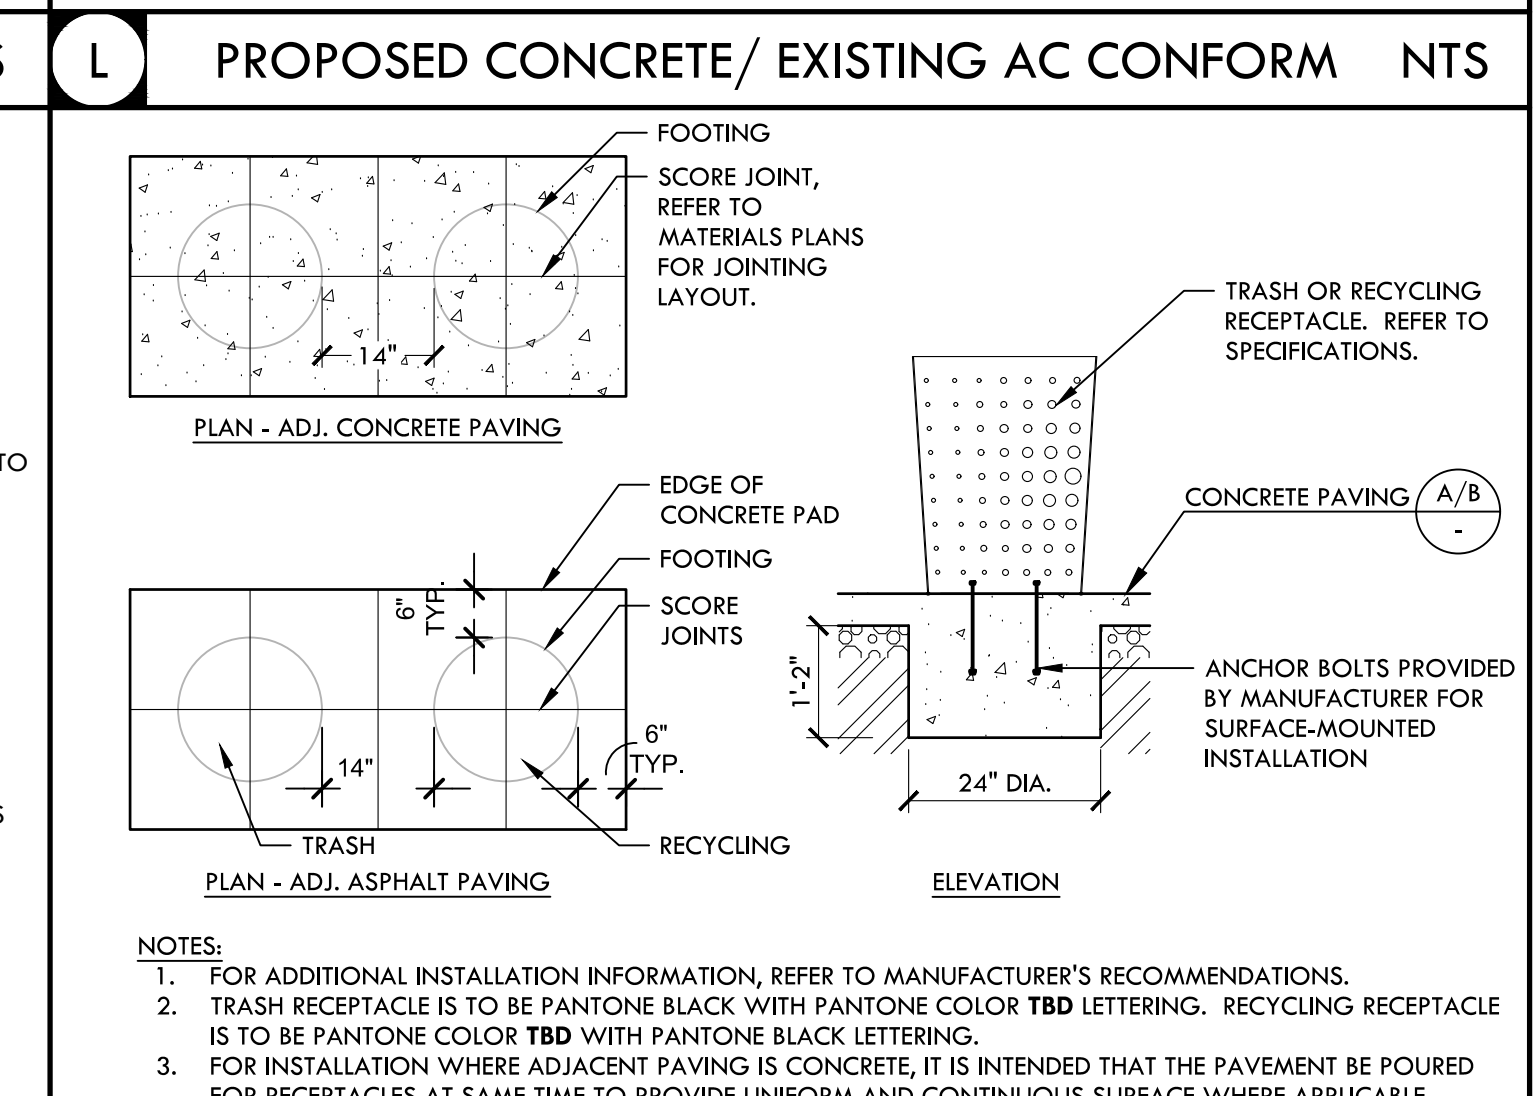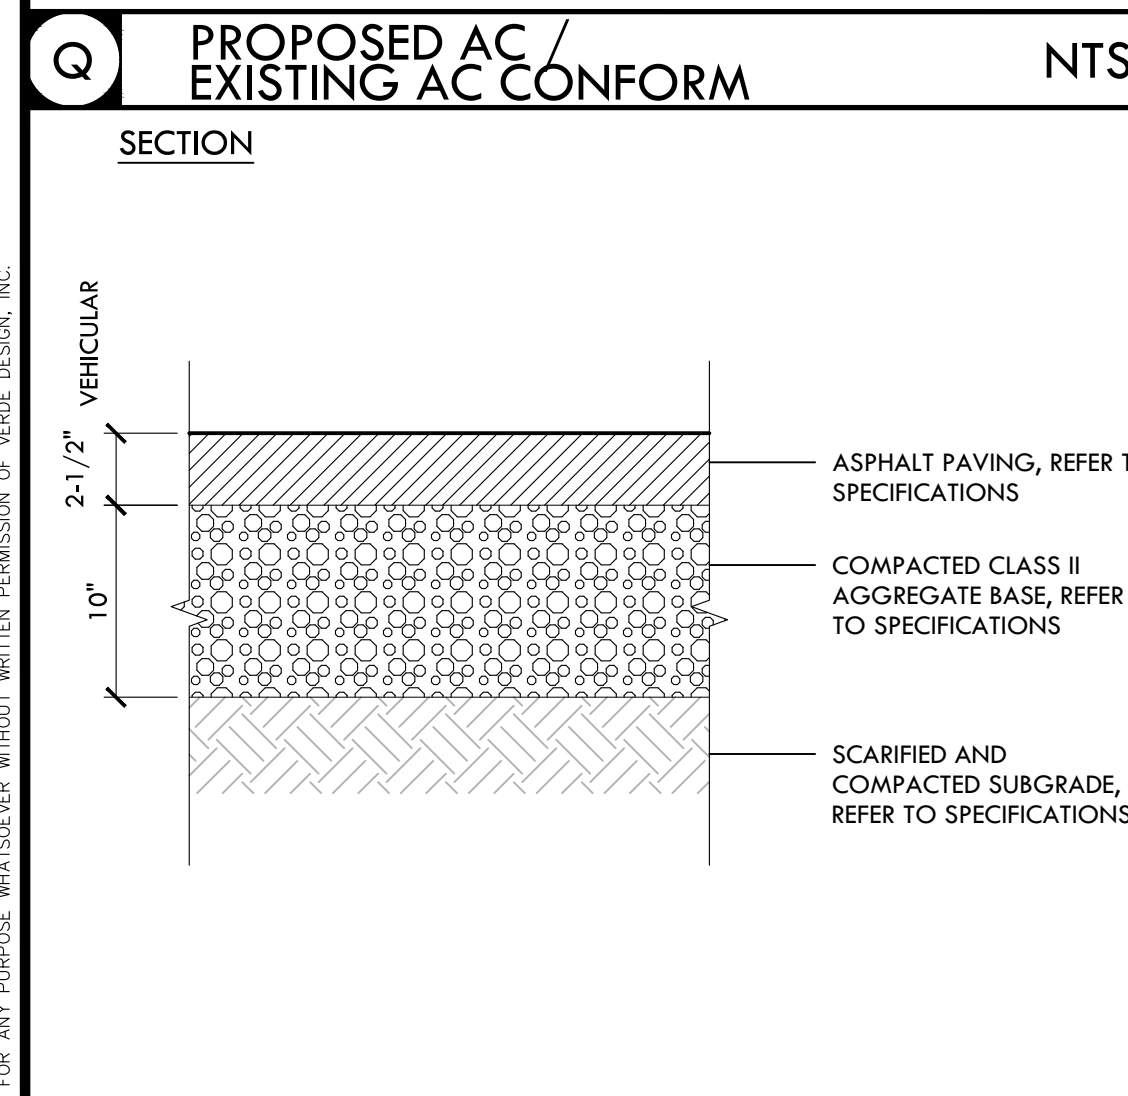


K TRASH AND RECYCLING RECEPTACLE PAD NTS

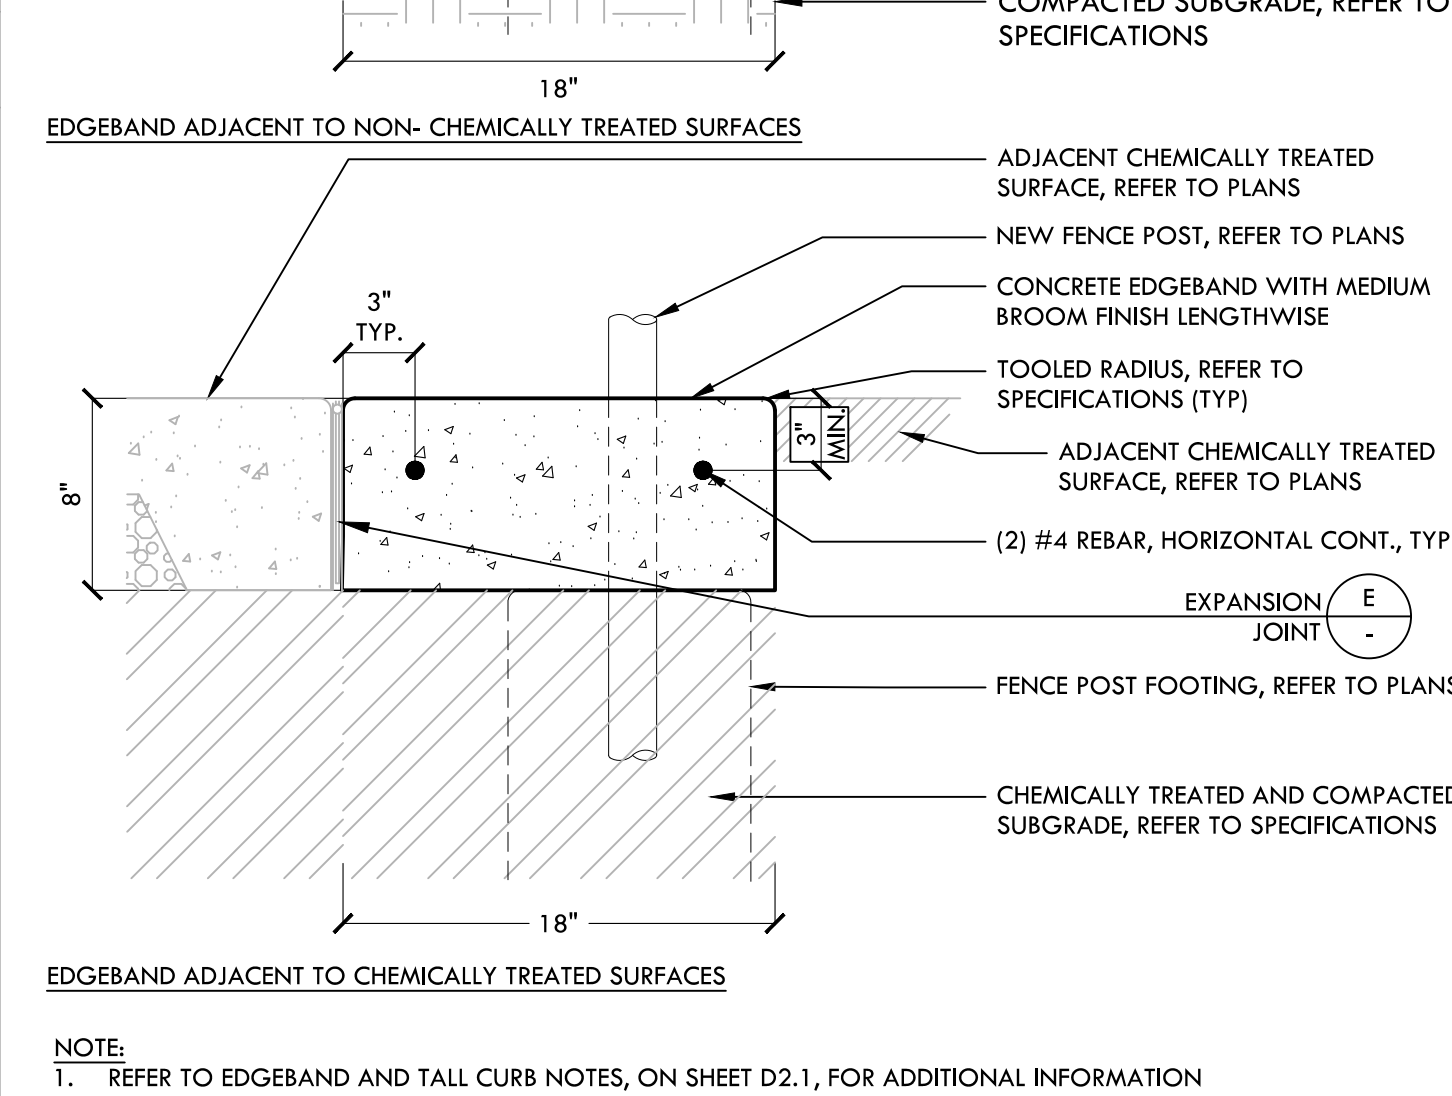

G CONSTRUCTION / EXPANSION JOINT PLAN

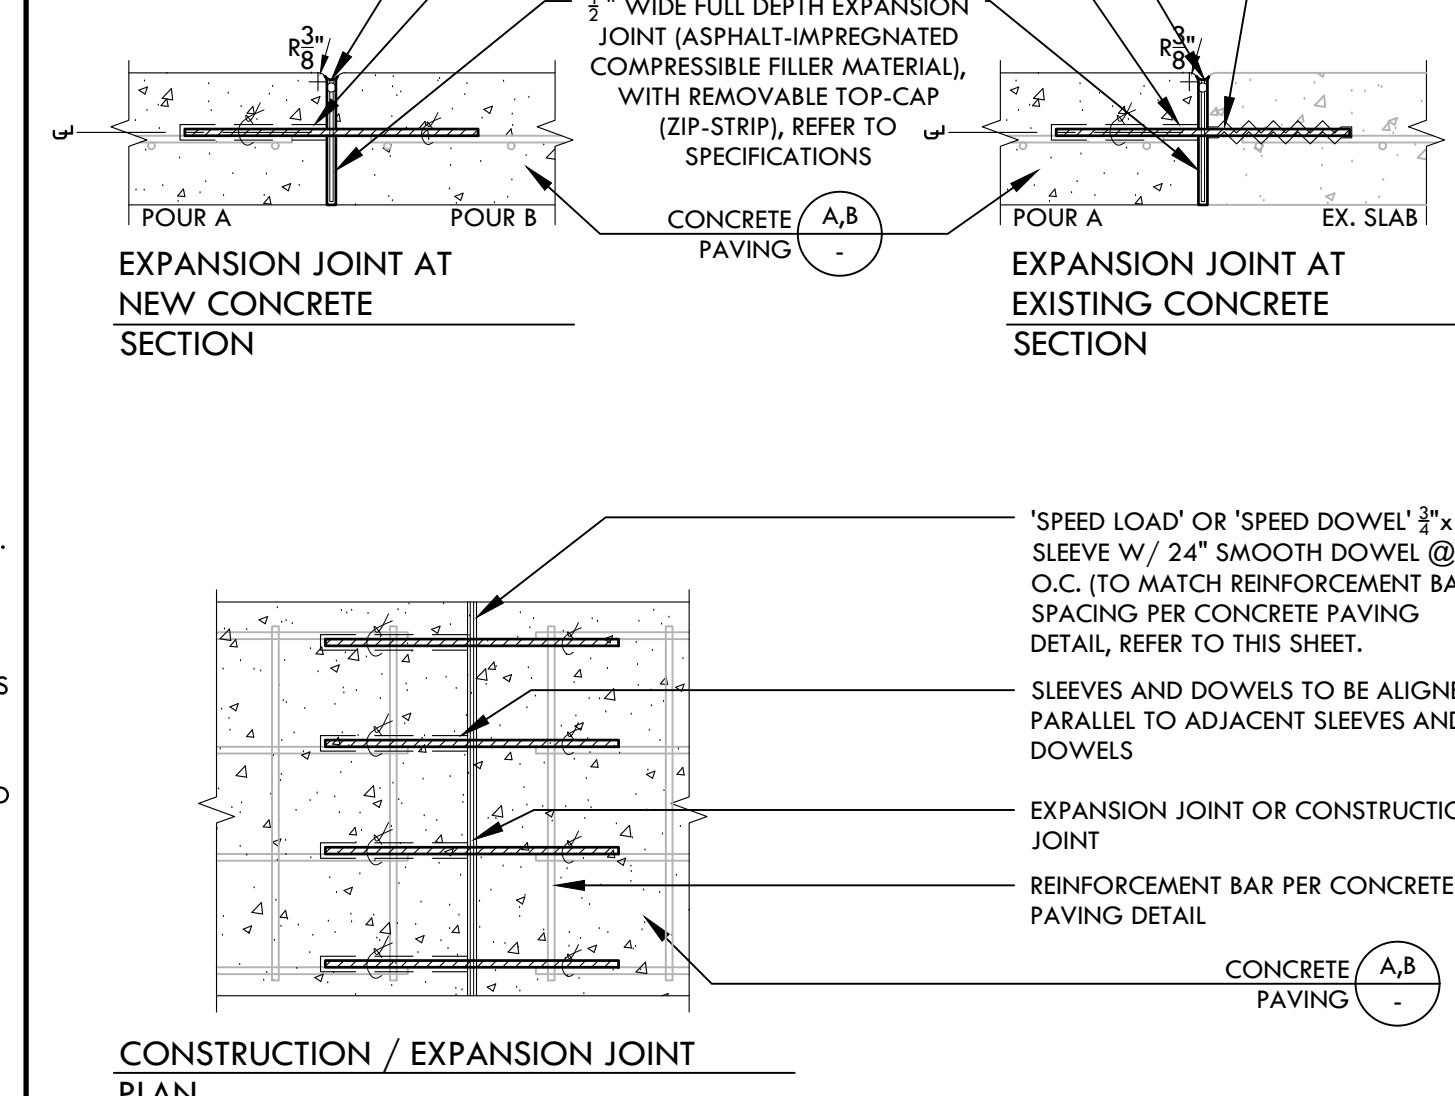

E CONCRETE JOINTS NTS

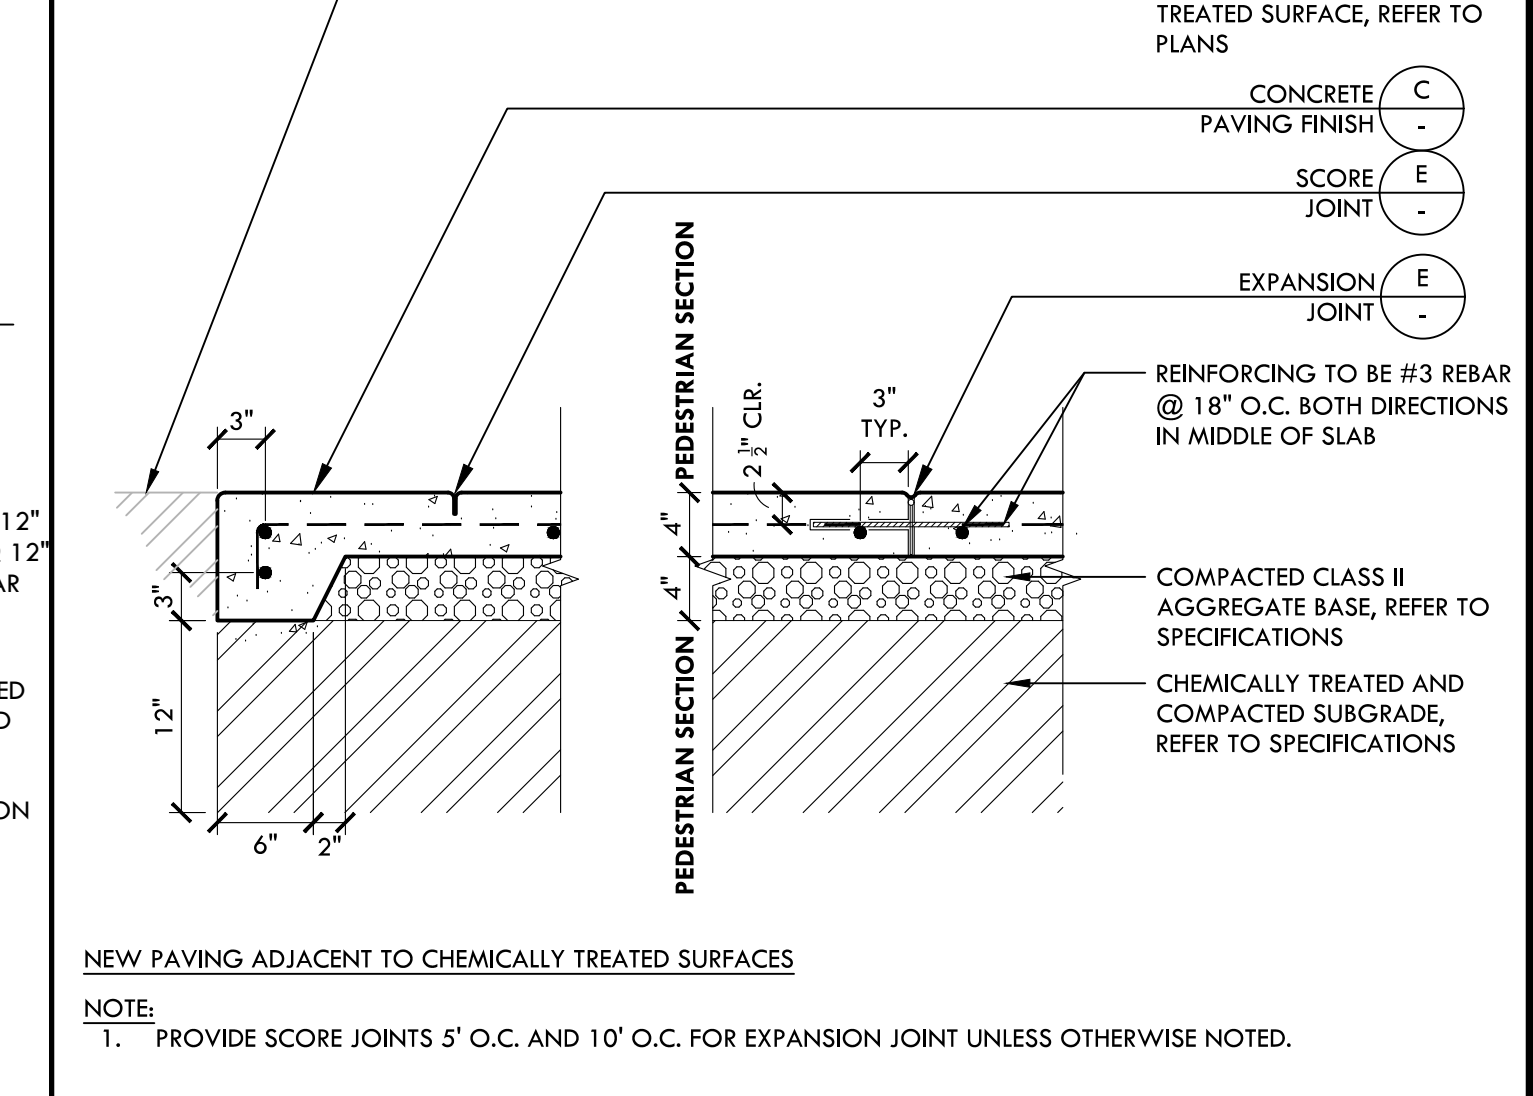

A CONCRETE PAVING - CHEMICALLY TREATED NTS

STAMP

CONSULTANT

KEYMAP

CONSTRUCTION DETAILS - HARDSCAPE

PROJECT NAME
HIRAM JOHNSON HIGH SCHOOL GOLF PRACTICE FACILITY, VARSITY BASEBALL AND SOFTBALL FIELDS

PROJECT ADDRESS
6879 14TH AVENUE SACRAMENTO, CA 95820

SUBMITTAL	DATE
DD 50% SUBMITTAL	04/15/22
100% DSA SUBMITTAL	05/27/22
DSA BACK CHECK	08/11/22
DSA ADDENDUM SUBMITTAL	09/16/22


NO.	REVISIONS	DATE
1	ADDENDUM	09/16/22

DRAWN BY: VDI
CHECKED BY: MB/CS

DATE ISSUED: 09/16/2022
SCALE: AS NOTED


PROJ. NO.: 2203200

SHEET NO.: **D2.1**

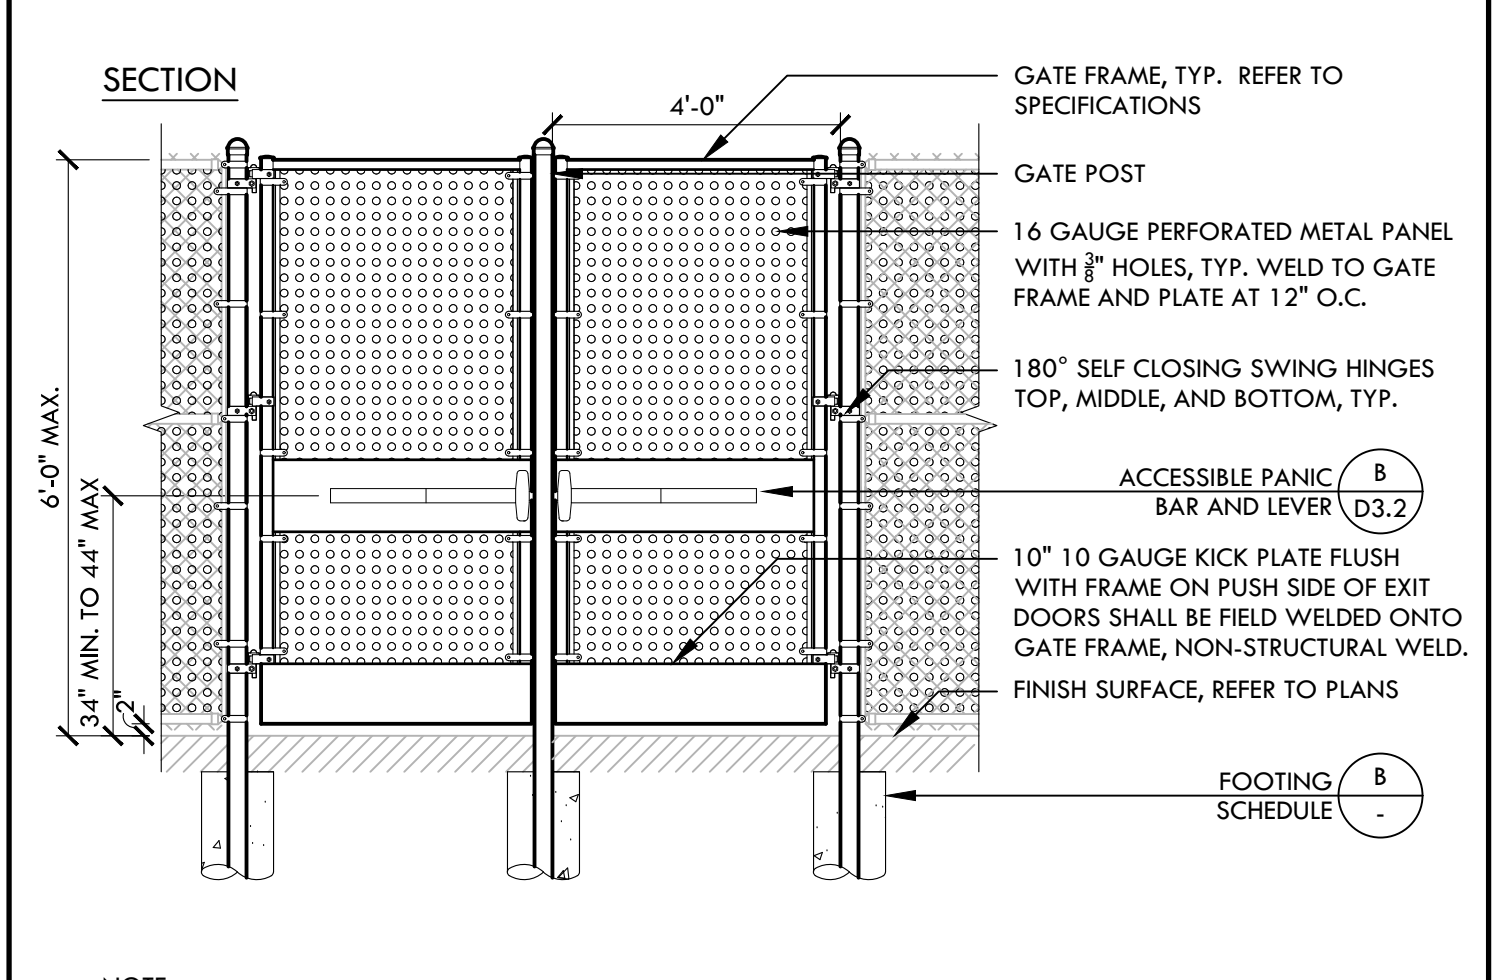


6' TALL X 4' DOUBLE SWING GATE WITH PANIC HARDWARE NTS


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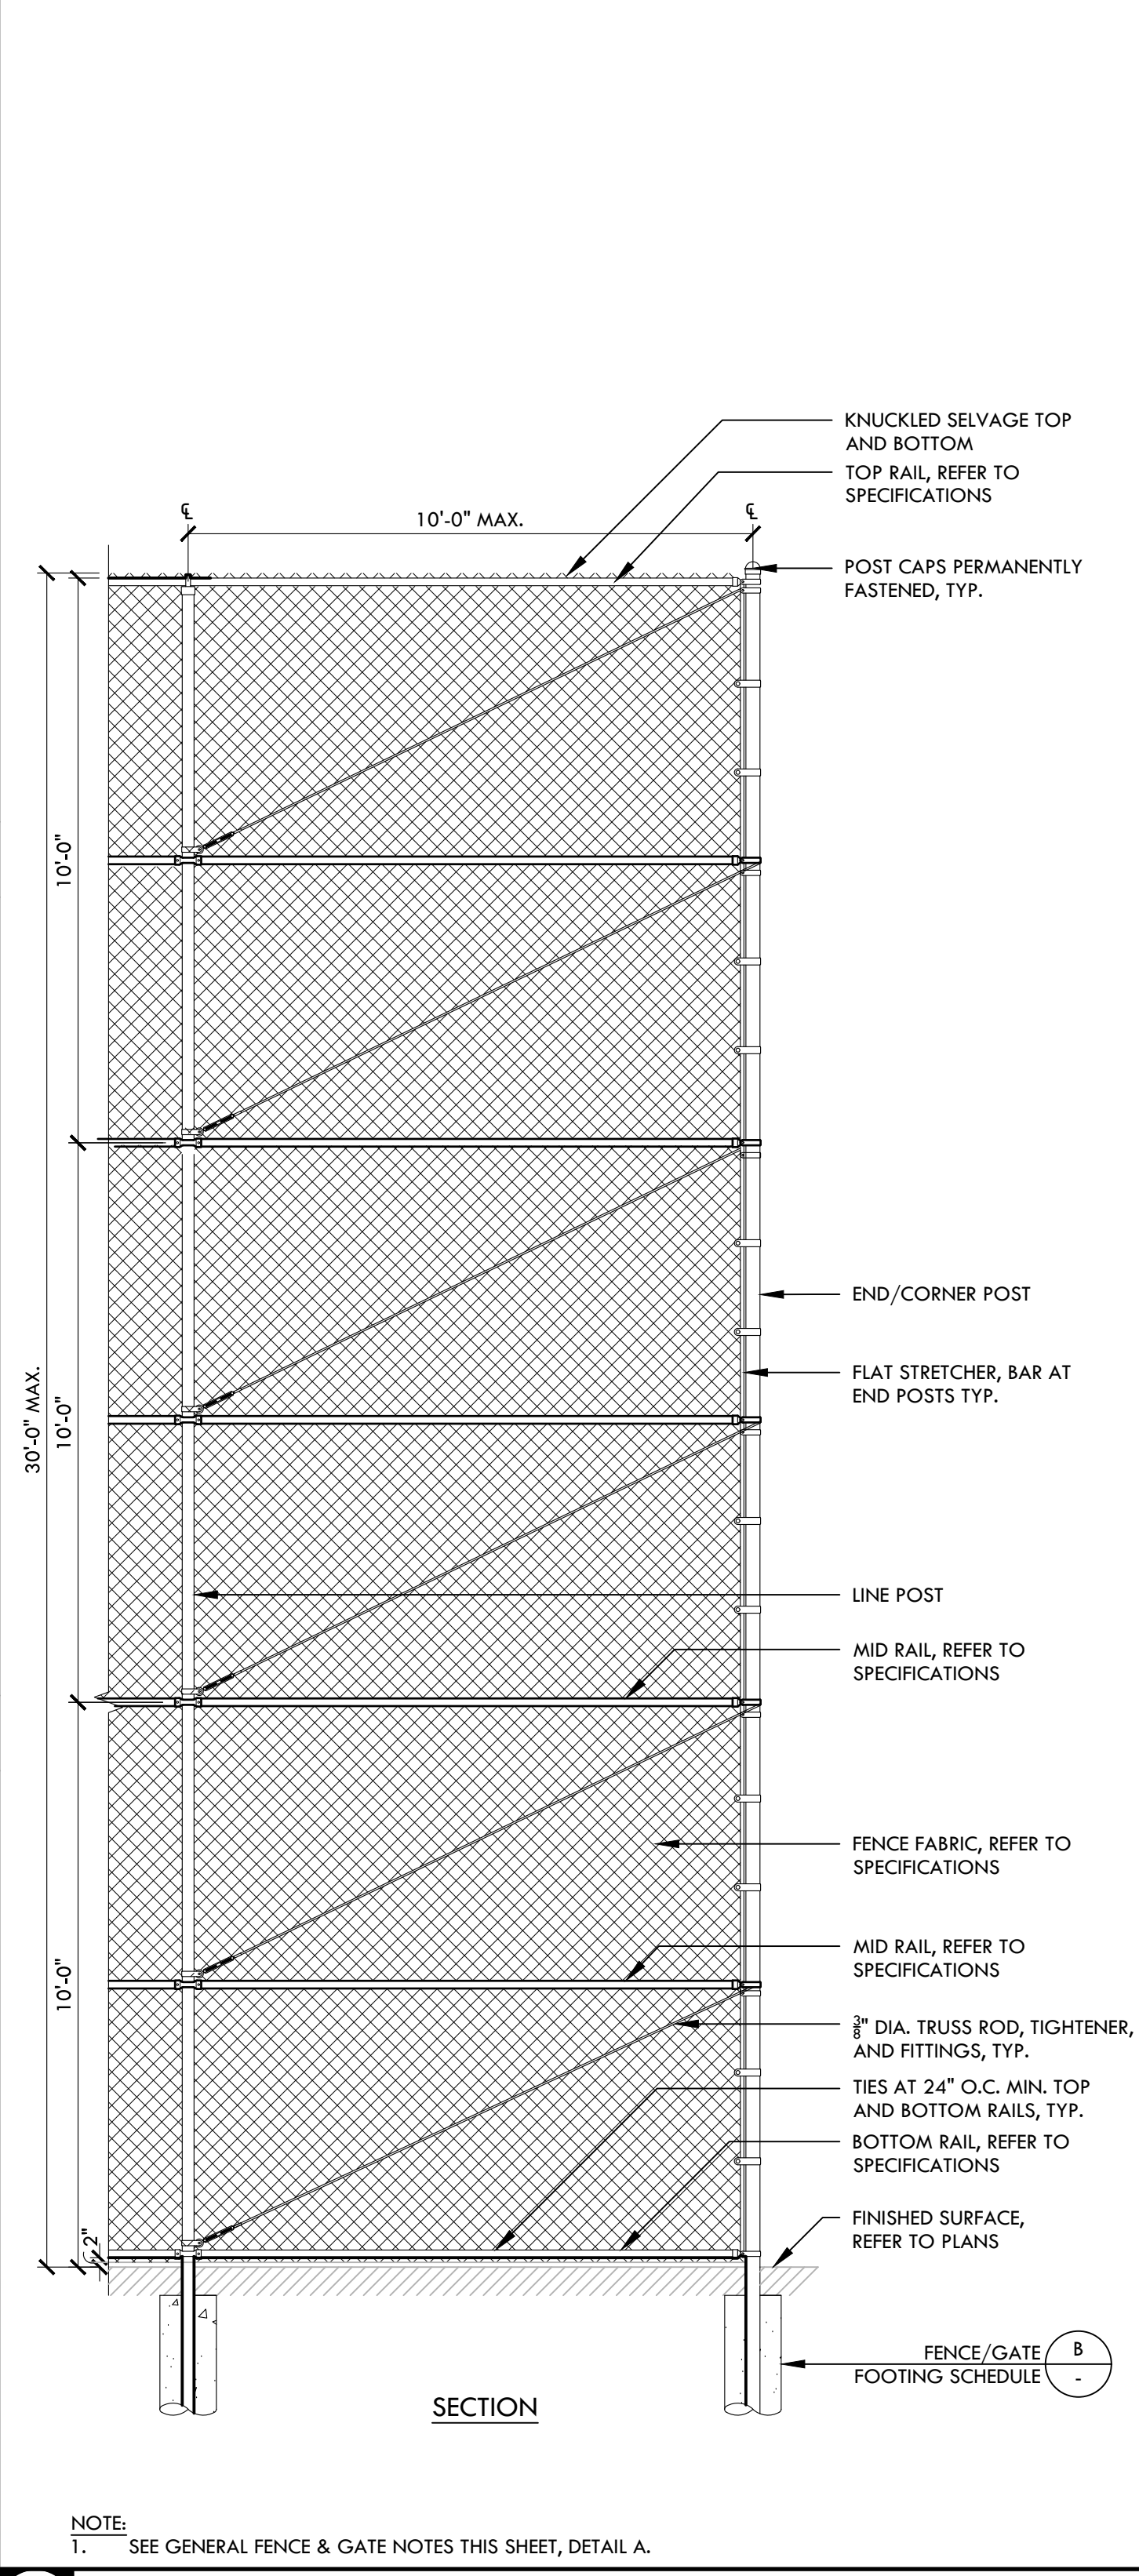
6' TALL x 4' SWING GATE - ACCESSIBLE NTS

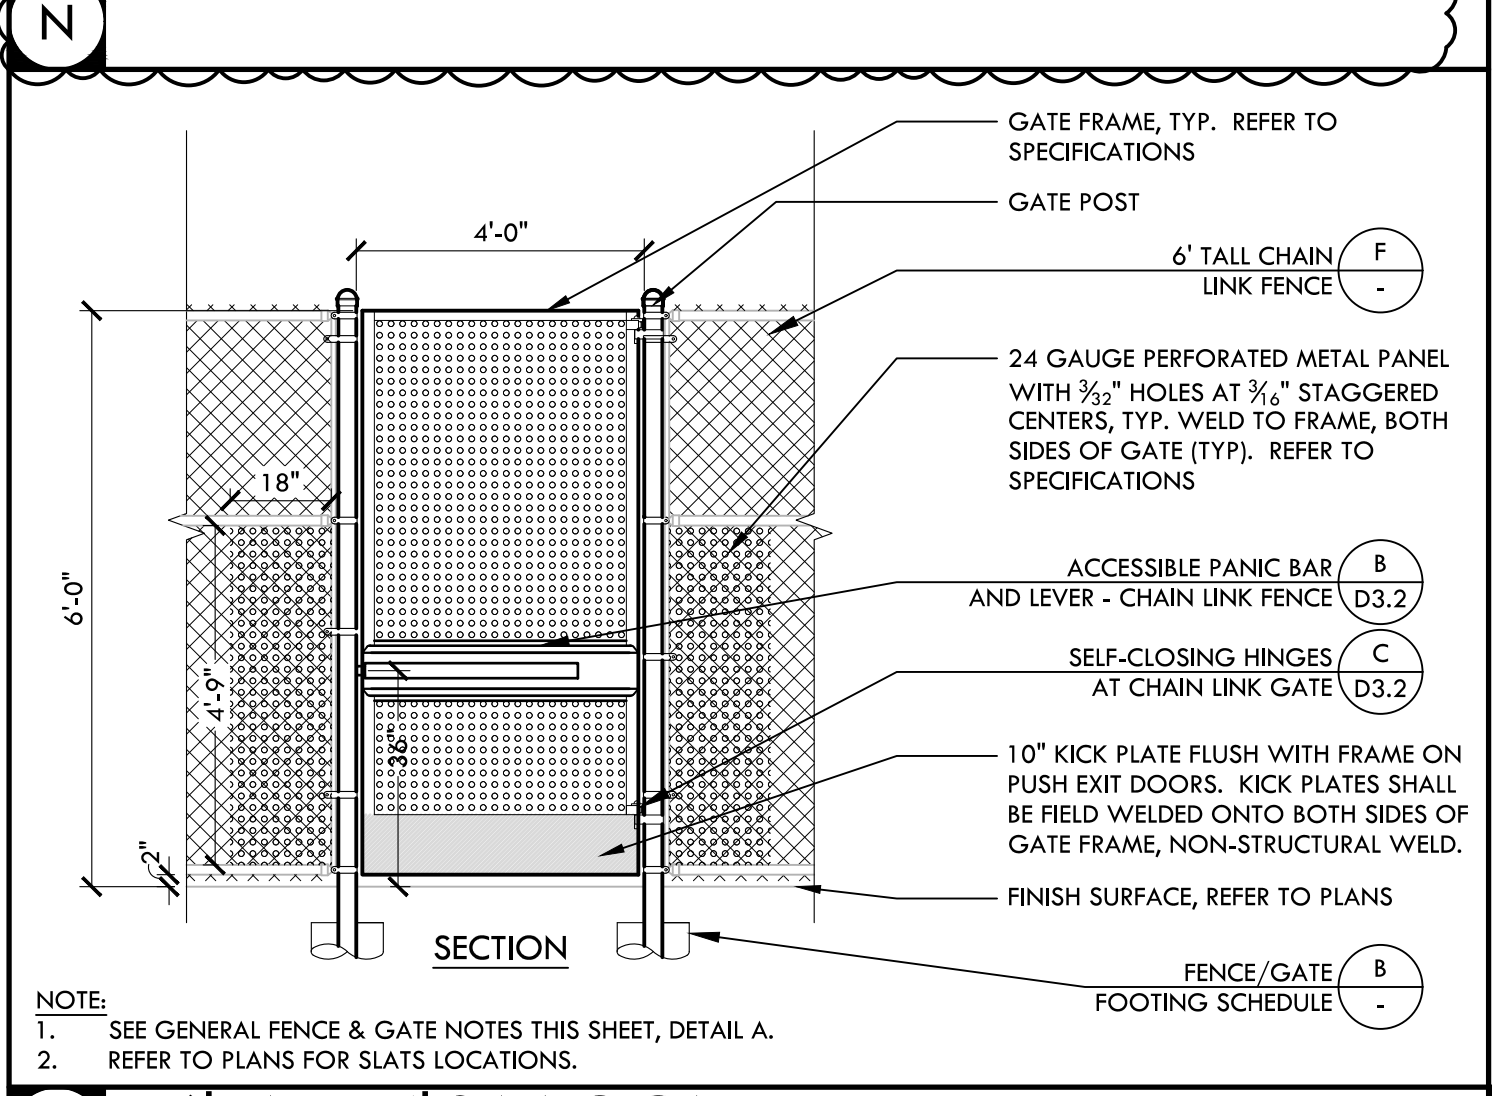


8' TALL x 4' WIDE CHAIN LINK SWING GATE WITH TRANSOM - ACCESSIBLE NTS

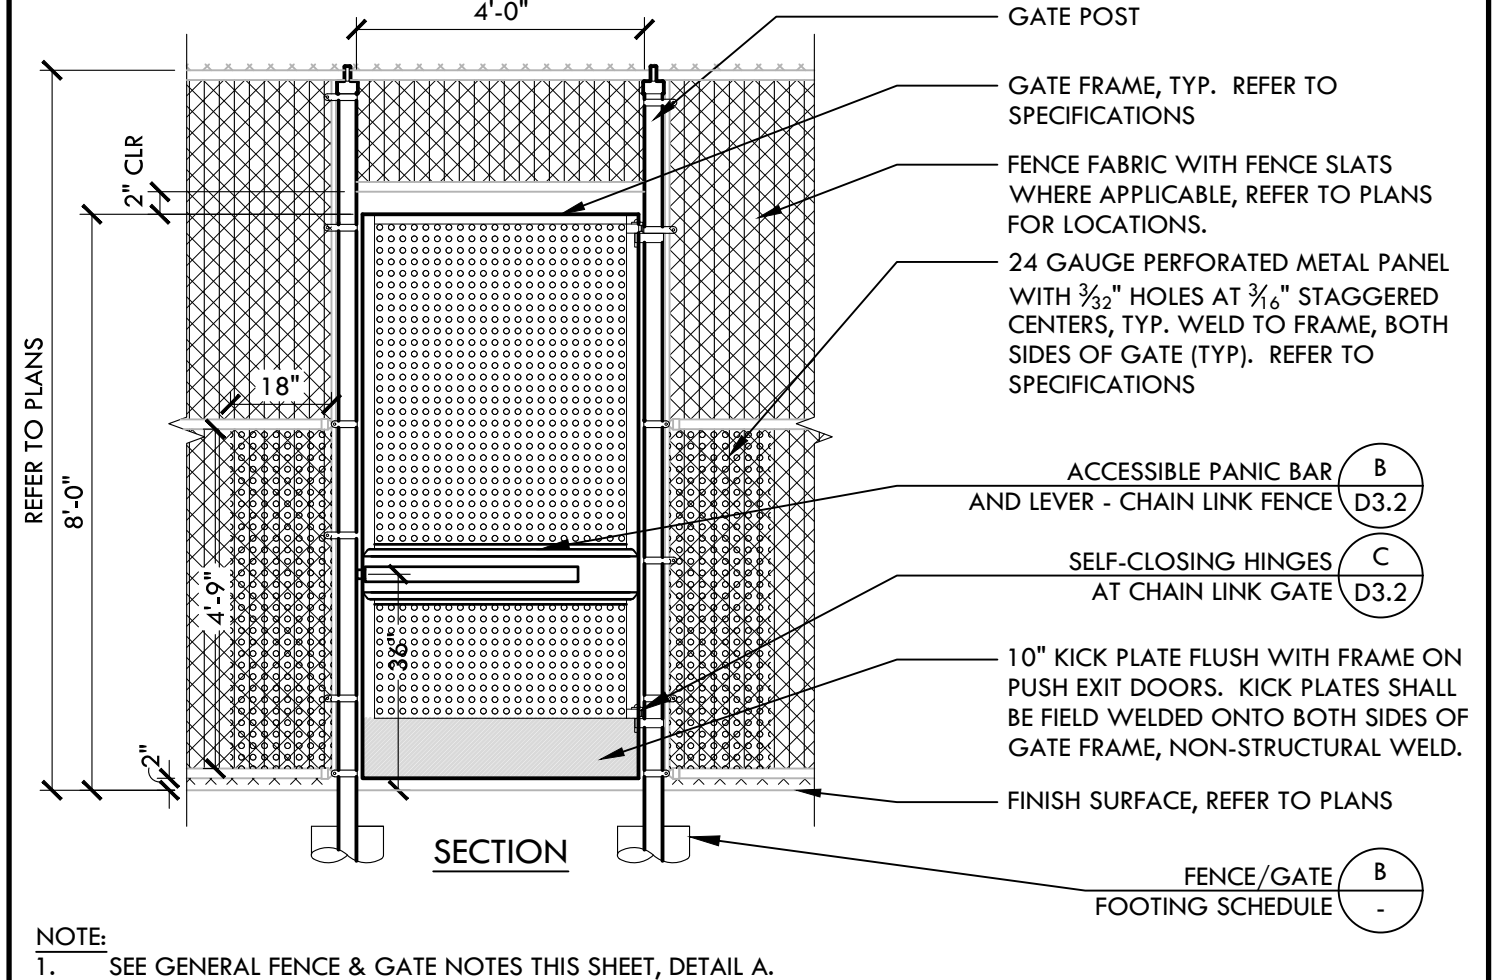


42\"/>

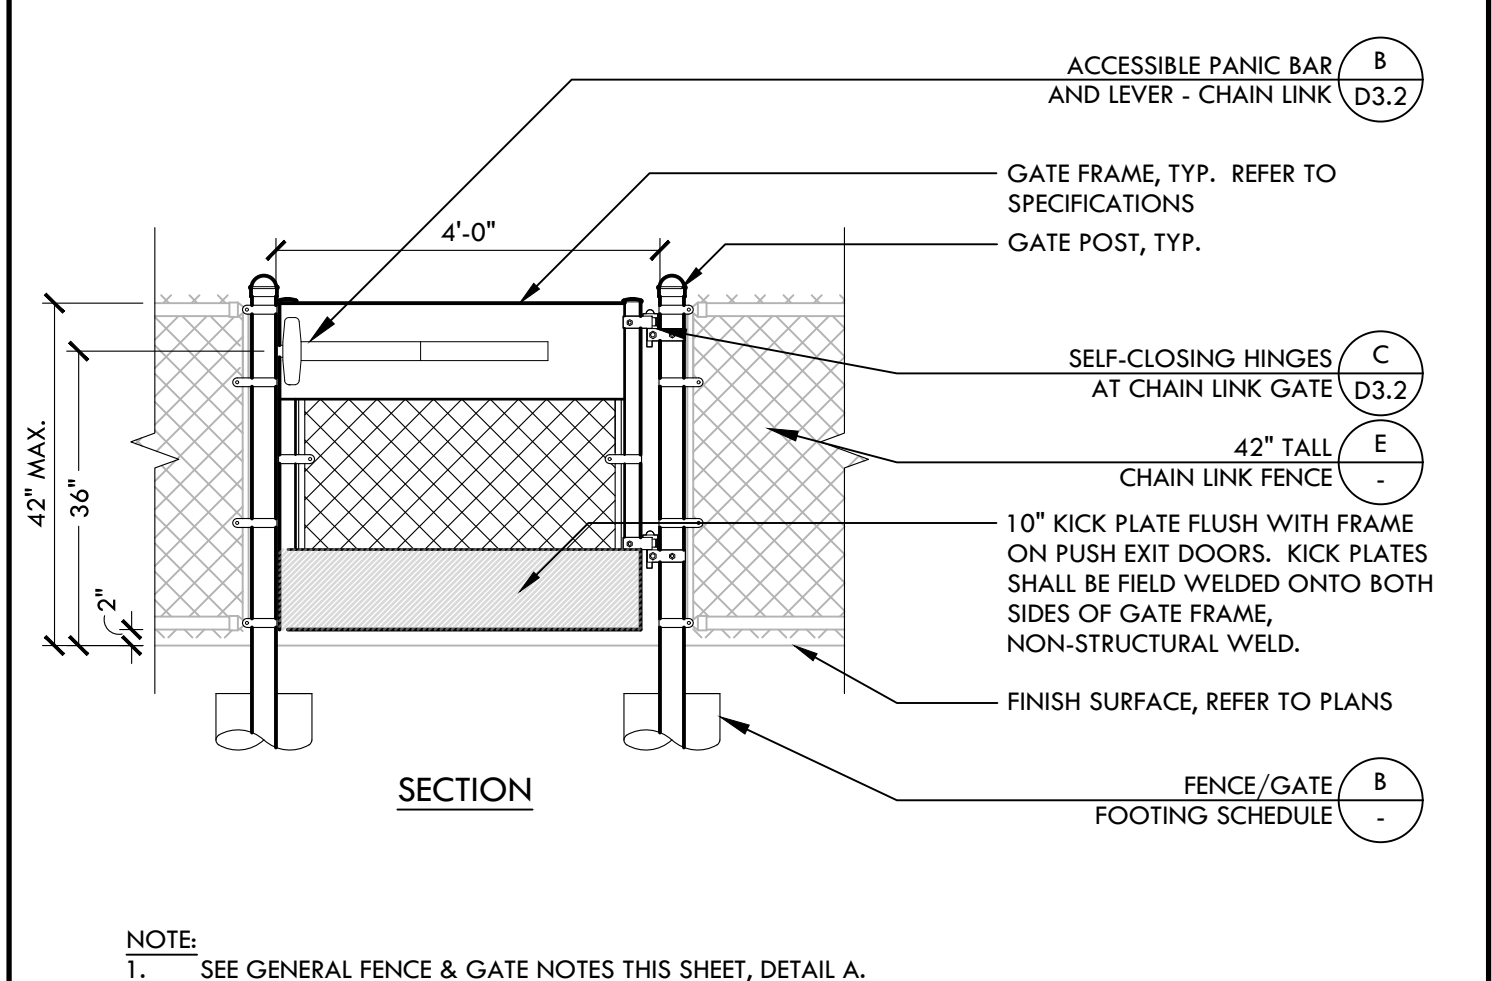

14' TALL CHAIN LINK FENCE NTS

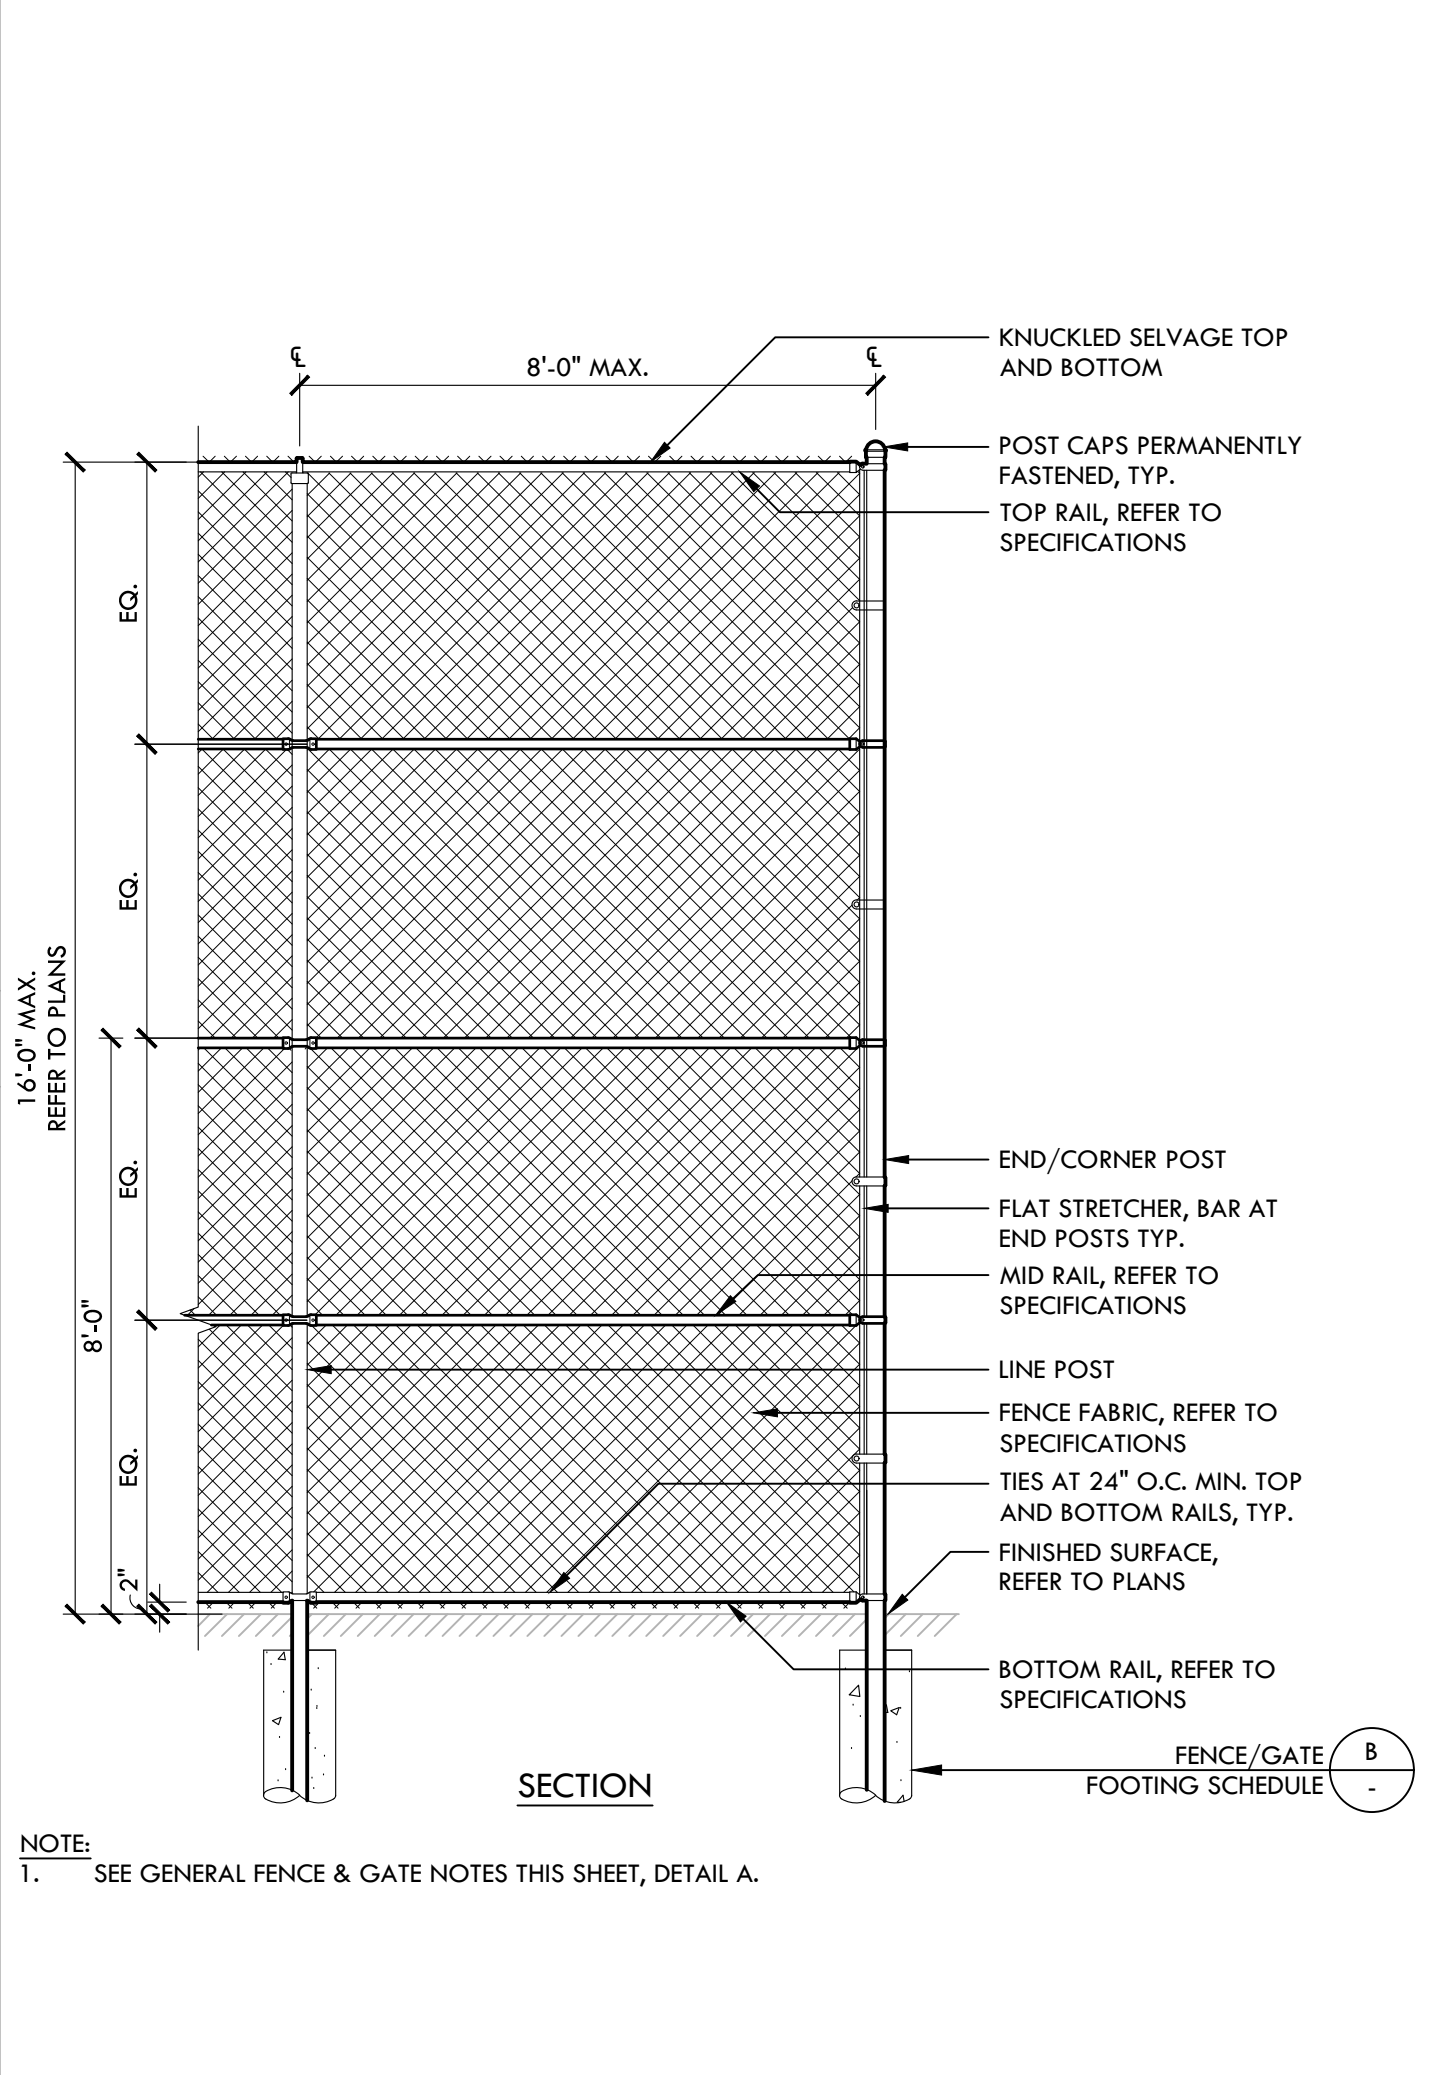


30' TALL CHAIN LINK BACKSTOP NTS

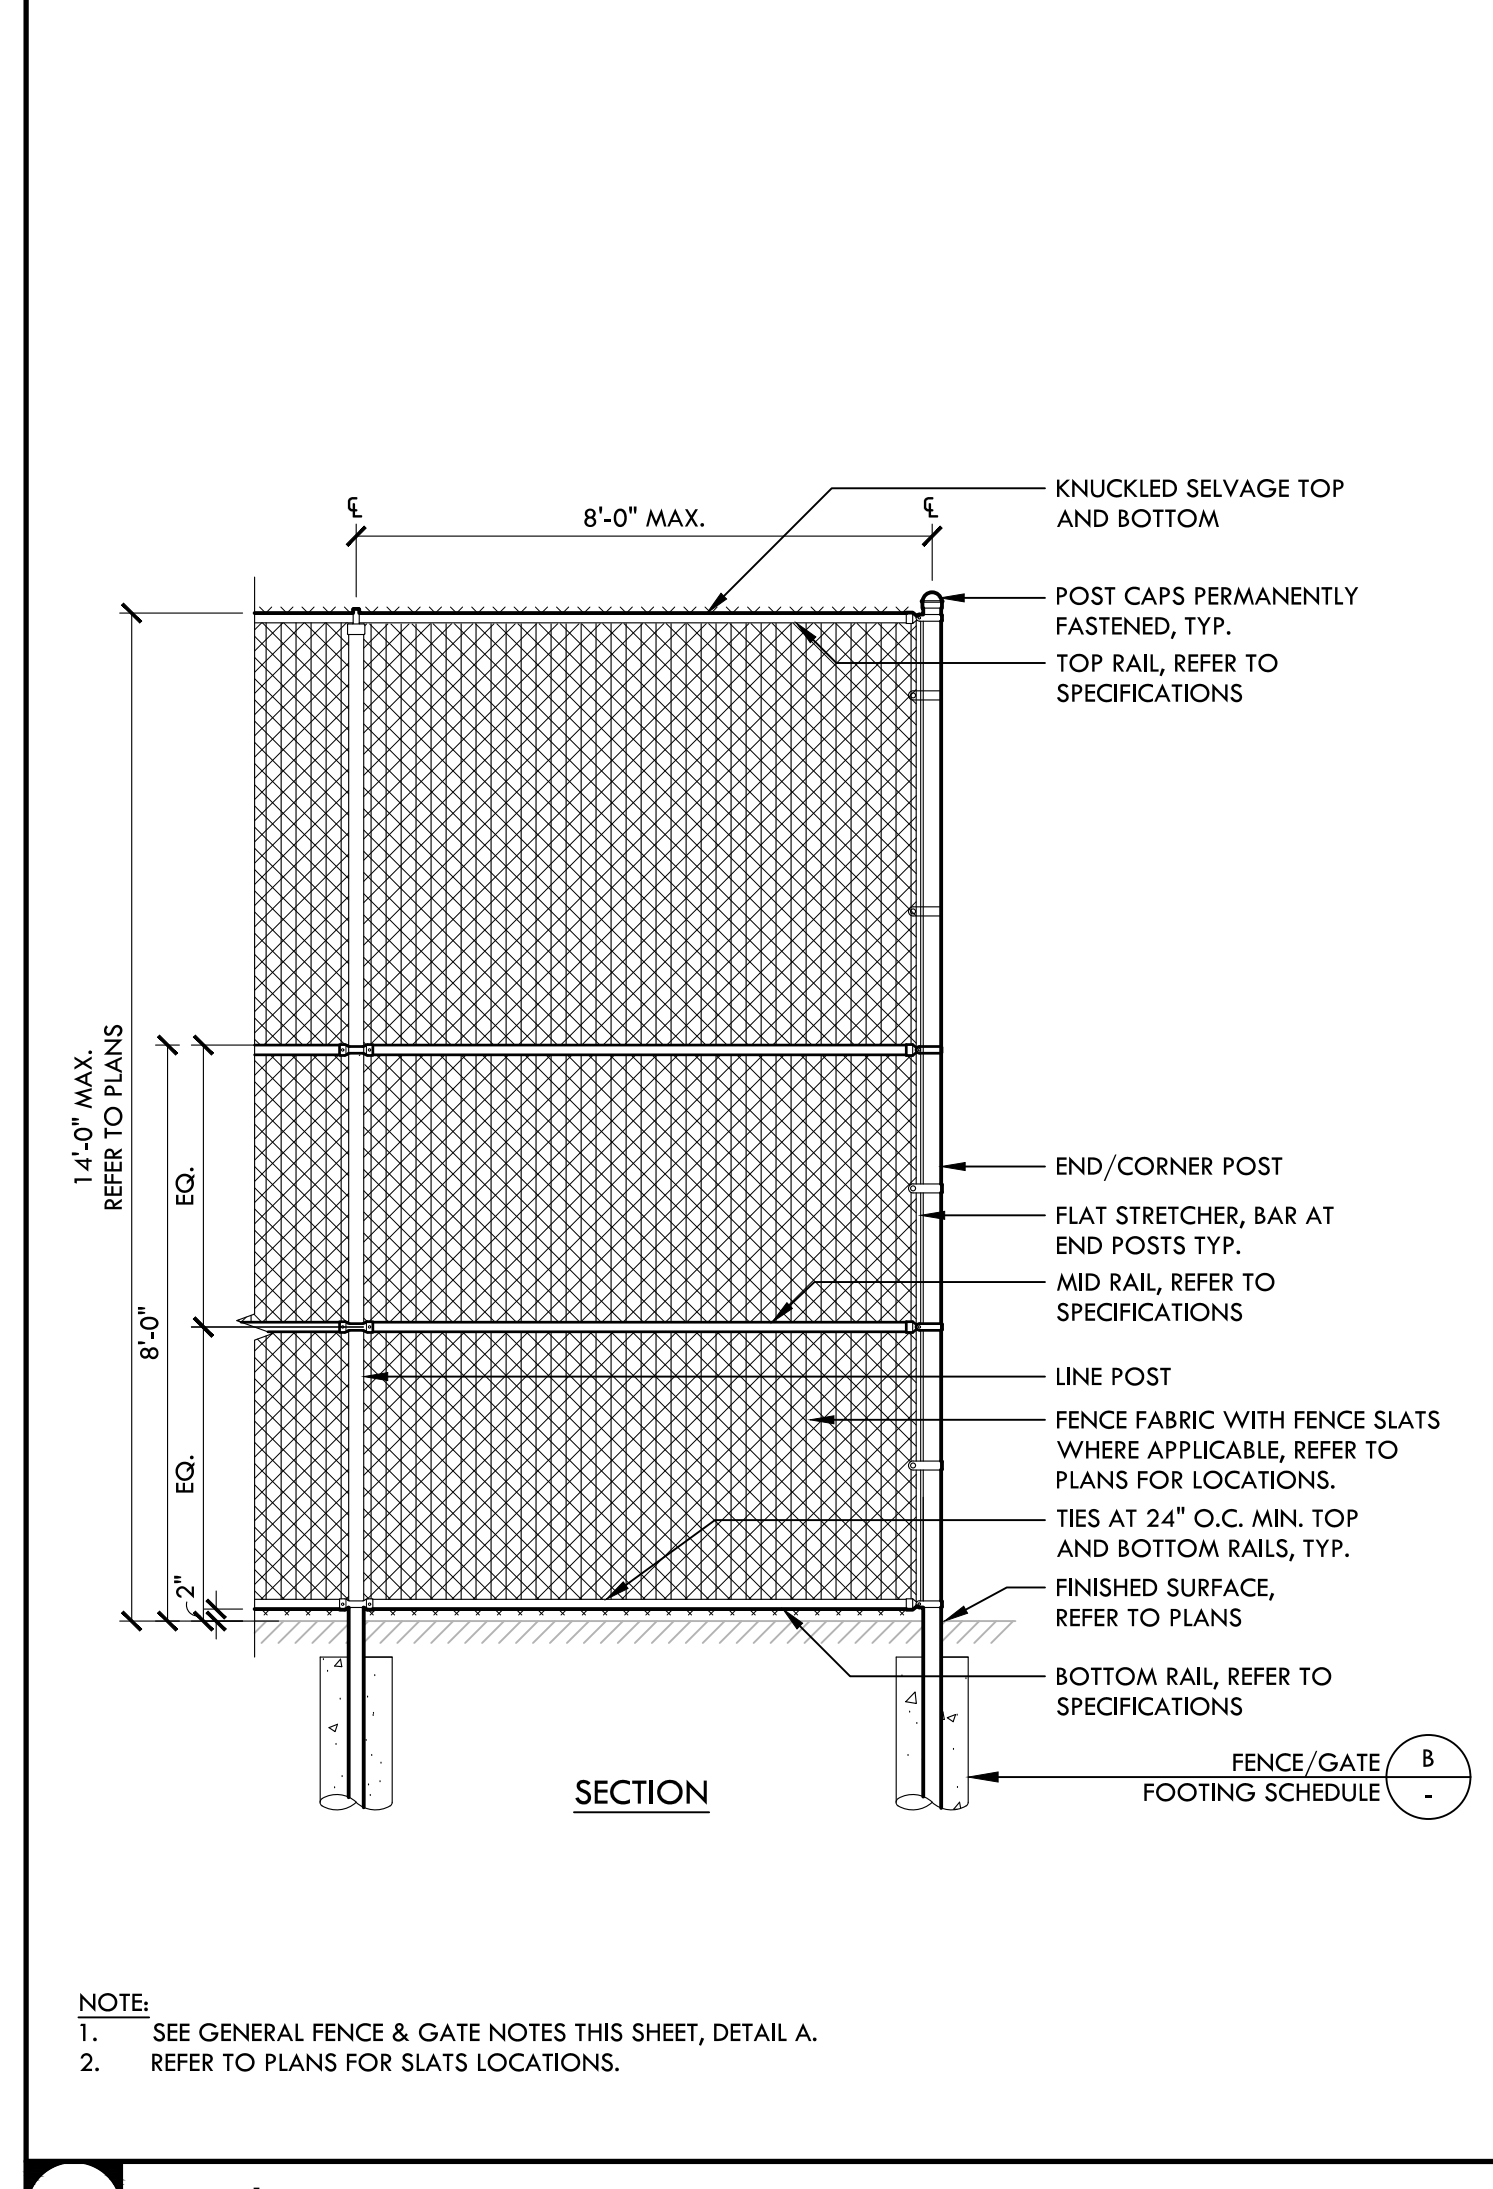


6' TALL CHAIN LINK FENCE NTS

NOT USED

42\"/>

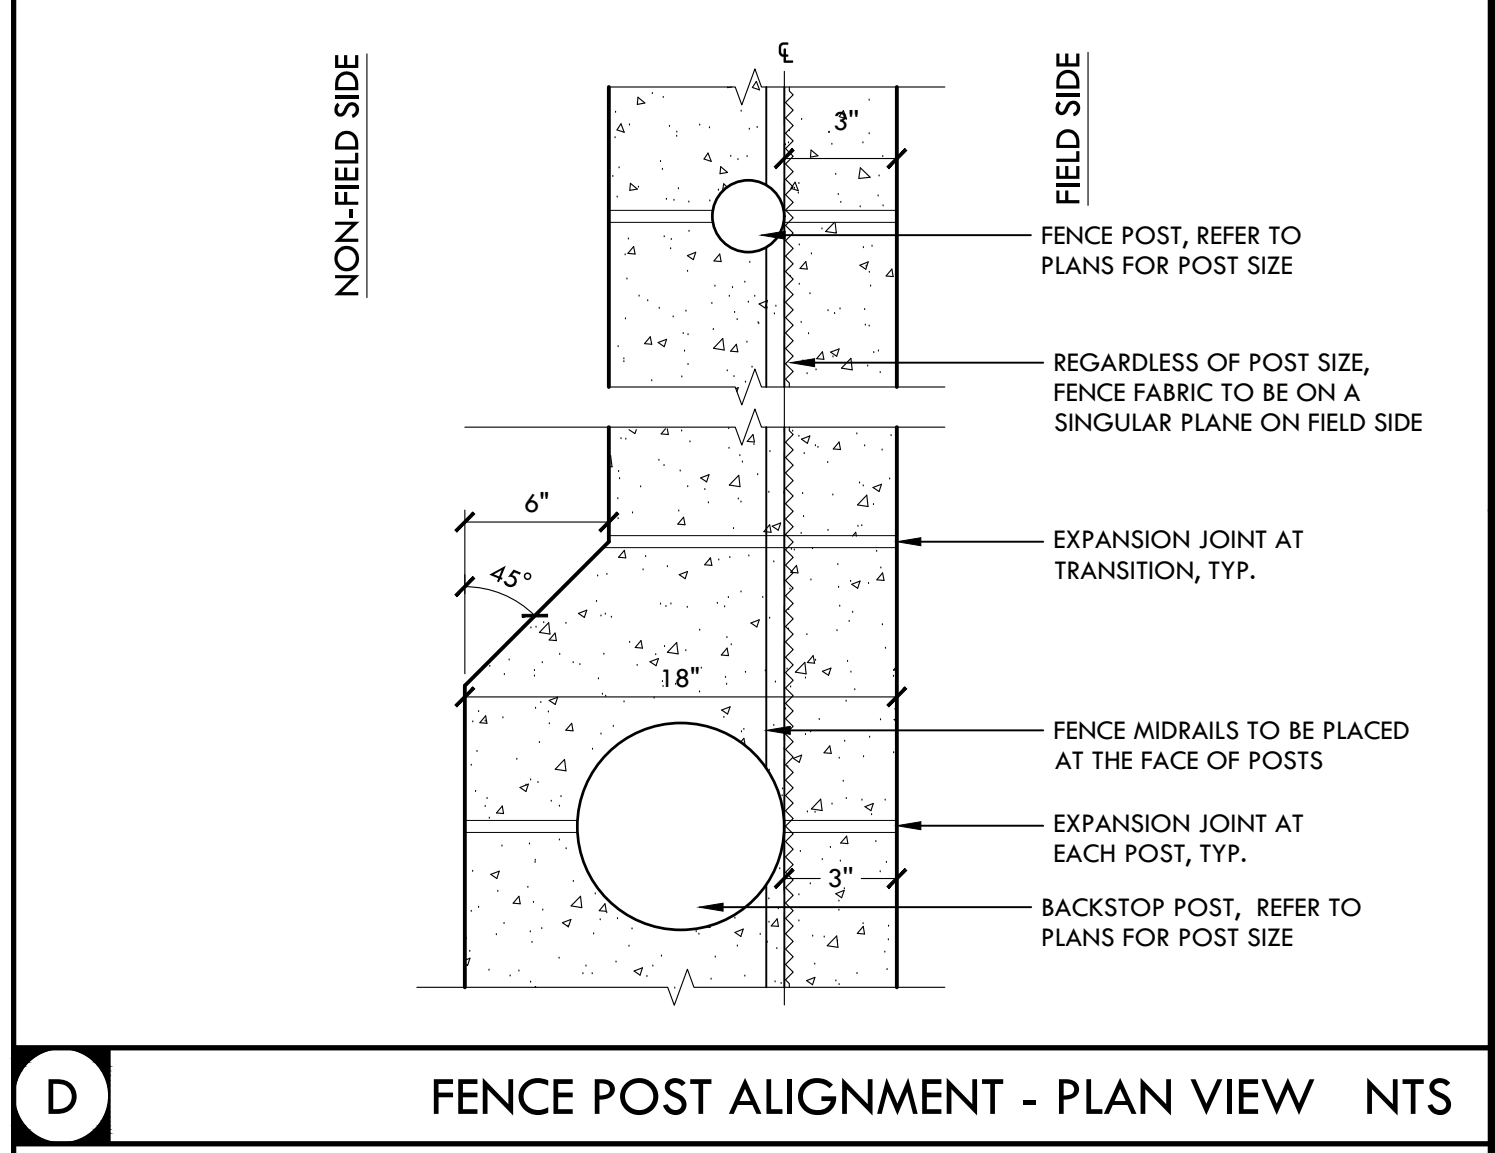

FENCE POST ALIGNMENT - PLAN VIEW NTS

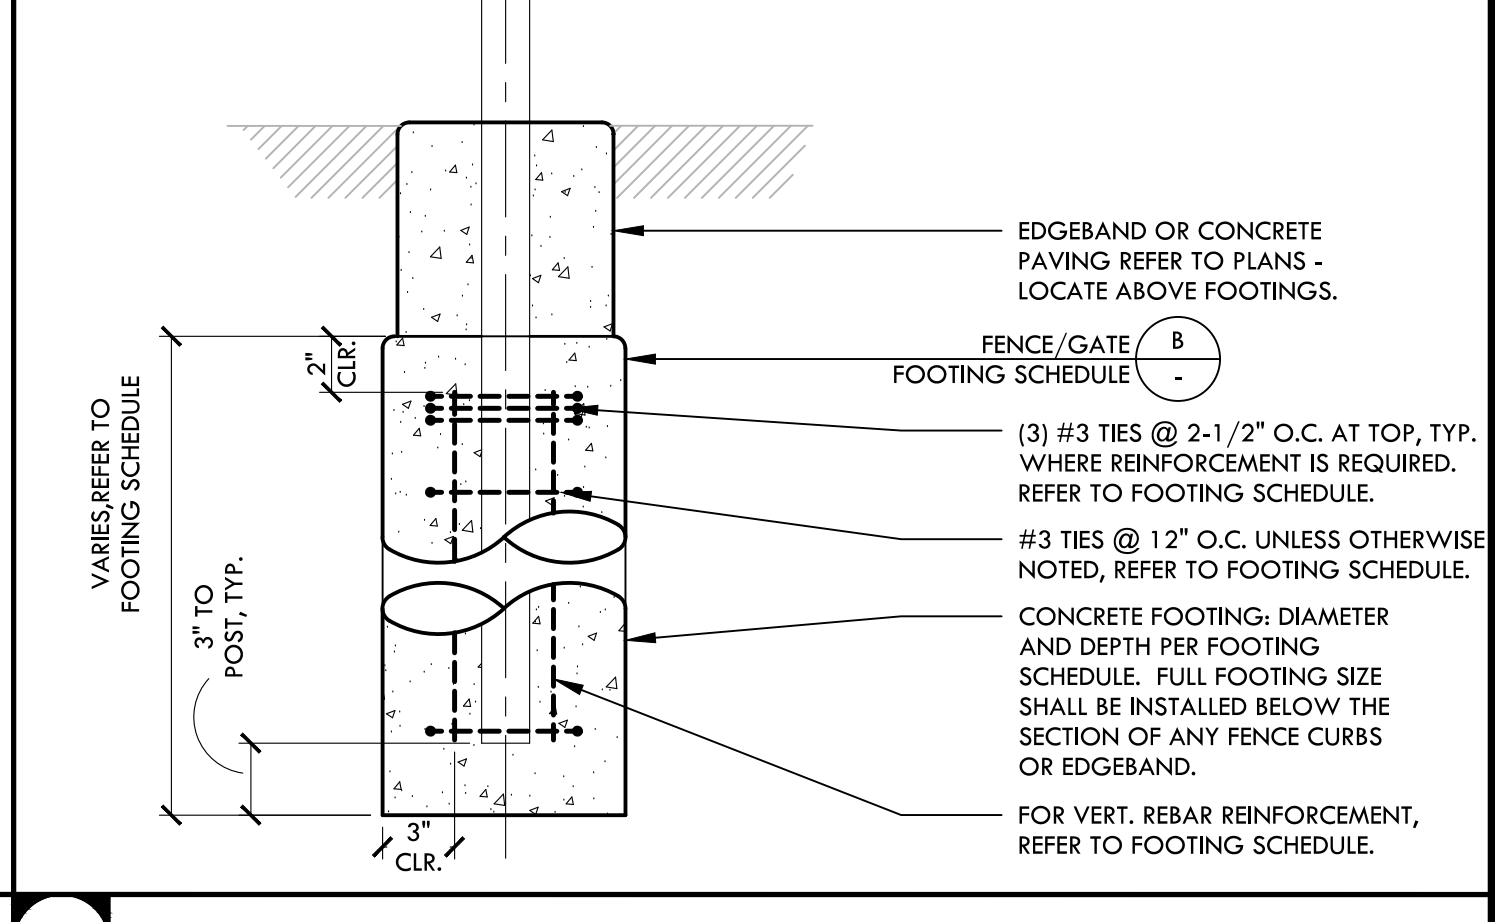

FENCE FOOTING PROFILE NTS

FENCE POST AND FOOTING SCHEDULE

DESCRIPTION	HEIGHT	LINE (STD. GALV. PIPE)	CORNER/END (STD. GALV. PIPE)	FOOTING	VERT. REBAR
CHAIN LINK FENCE	42"	1-1/2" DIA. STD.	2" DIA. STD.	12" DIA. X 3'-0" DEEP	-
CHAIN LINK FENCE	6'	2-1/2" DIA. STD.	3" DIA. STD.	12" DIA. X 3'-4" DEEP	-
CHAIN LINK FENCE WITH SLATS	6'	3" DIA. STD.	3-1/2" DIA. STD.	16" DIA. X 5'-6" DEEP	-
CHAIN LINK FENCE AT BATTING CAGE	14'	REFER TO STRUCTURAL DRAWINGS			
CHAIN LINK FENCE WITH SLATS AT BATTING CAGE	14'	REFER TO STRUCTURAL DRAWINGS			
CHAIN LINK FENCE AT DRIVING RANGE	16'	REFER TO STRUCTURAL DRAWINGS			
CHAIN LINK BACKSTOP	30'	REFER TO STRUCTURAL DRAWINGS			
NETTING (24'-0" TALL NETTING OVER 8' TALL CHAIN LINK FENCE OR DUGOUT)	30'	REFER TO STRUCTURAL DRAWINGS			

FENCE POST AND FOOTING SCHEDULE

GATE POST FOOTING SCHEDULE

DESCRIPTION	SIZE (H x L)	POSTS (STD. GALV. PIPE)	FOOTING	VERT. REBAR
CHAIN LINK SWING GATE - ACCESSIBLE	42"x4'	2" DIA. STD.	12" DIA. X 3'-0" DEEP	-
CHAIN LINK DOUBLE SWING GATE	6' x 8'	3" DIA. STD.	12" DIA. X 3'-6" DEEP	-
CHAIN LINK DOUBLE SWING GATE WITH SLATS	6' x 8'	3.5" DIA. STD.	12" DIA. X 5'-4" DEEP	-
CHAIN LINK DOUBLE SWING GATE WITH SLATS	6' x 12'	3.5" DIA. STD.	16" DIA. X 5'-6" DEEP	-
CHAIN LINK SWING GATE - ACCESSIBLE WITH TRANSOM AND SLATS	8' x 4'	4" DIA. STD.	16" DIA. X 5'-6" DEEP	-
CHAIN LINK DOUBLE SWING GATE - MIXED LEAF WITH TRANSOM	8' x 10'	3" DIA. STD.	16" DIA. X 3'-6" DEEP	-

GATE POST FOOTING SCHEDULE

- NOTES PERTAIN TO ALL GATE AND FENCE DETAILS:**
- POSTS LISTED FOR GATES SHOULD BE END POST SIZE MIN. TYP.
 - REFER TO PLANS & DETAILS FOR POST LOCATION AND TOP OF POST FOOTING.
 - REFER TO FENCE FOOTING DETAIL, DETAIL C, THIS SHEET.
 - GATE POSTS SHALL BE END POST SIZE MIN. TYP.
 - THE PIPE SIZES INDICATED ARE NPS FOR ; STANDARD PIPE SCHEDULE 40.
- FENCE FABRIC ON PERIMETER FENCING IS TO BE ON FIELD SIDE. ALL FENCING TO BE BLACK VINYL.
 - BOTTOM RAIL TO BE 2" FROM FINISH GRADE, FENCE FABRIC BOTTOM EDGE TO BE 1" FROM FINISH GRADE.
 - SUBMIT SHOP DRAWINGS FOR ACCEPTANCE BY OWNER'S REPRESENTATIVE PRIOR TO INSTALLATION.
 - GATES IN ACCESSIBLE PATH OF TRAVEL MUST MEET ENTRY AND EXIT DOOR REQUIREMENTS FOR ACCESSIBILITY PER 2019 CALIFORNIA BUILDING CODE (118-404).
 - FOR PEDESTRIAN GATE, PROVIDE LOCKING DEVICE TO SECURE GATE IN OPEN POSITION WITH NEW SIGN THAT READS, "GATE SHALL REMAIN OPEN DURING HOURS OF OPERATION."
 - ALL PEDESTRIAN SWING GATES SHALL HAVE A KICK PLATE ATTACHMENT.
 - REFER TO PLANS FOR EDGEBOARD TYPE UNLESS OTHERWISE NOTED.
 - REFER TO PLANS AND DETAILS FOR FENCING WITH CURBS AND CHANGE IN ELEVATIONS.
 - CANE STOP TO GO DOWN 4" INTO CONCRETE IN CLOSED POSITION AND OPEN POSITION.
 - TACK WELD HINGES TO POSTS AT GATES.
 - DOUBLE SWING GATES THAT ARE IN LINE WITH FENCING, GATE POSTS SHALL BE OFFSET FROM THE FENCE TO ALLOW SWING GATES TO OPEN A FULL 180° BACK AGAINST THE FENCE PER PLAN LAYOUT.
 - THE PIPE SIZES INDICATED ARE NPS FOR ; STANDARD PIPE SCHEDULE 40.
 - ALL FENCE POSTS SET IN CONCRETE SHALL BE COATED WITH ONE COAT OF BITUMINOUS PAINT.
 - ALL DROP CABLES TO HAVE A MECHANISM TO HOLD IN UP POSITION WHEN GATE IS OPEN AND/OR SWINGING. LOCATIONS FOR DROP BAR IN CLOSED AND OPEN POSITIONS TO BE PROVIDED.

FENCE AND GATES NOTES NTS

VERDE DESIGN
LANDSCAPE ARCHITECTURE
CIVIL ENGINEERING
SPORT PLANNING & DESIGN
1843 Iron Point Rd, Suite 140
Folsom, CA 95630
Tel: 916.415.6554
Fax: 916.415.6525
www.VerdeDesign.com

REGISTERED LANDSCAPE ARCHITECT
STATE OF CALIFORNIA
EXPIRATION DATE: JULY 2023

CONSULTANT

SHEET TITLE

FENCING DETAILS

PROJECT NAME

**HIRAM JOHNSON
HIGH SCHOOL
GOLF PRACTICE FACILITY,
VARSITY BASEBALL AND
SOFTBALL FIELDS**

PROJECT ADDRESS

**6879 14TH AVENUE
SACRAMENTO, CA 95820**

SUBMITTAL	DATE
DD 50% SUBMITTAL	04/15/22
100% DSA SUBMITTAL	05/27/22
DSA BACK CHECK	08/11/22
DSA ADDENDUM SUBMITTAL	09/16/22


NO.	REVISIONS	DATE
1	ADDENDUM	09/16/22

DRAWN BY: VDI
CHECKED BY: MB/CS
DATE ISSUED: 09/16/2022
SCALE: AS NOTED
PROJ. NO.: 2203200
SHEET NO.: **D3.1**

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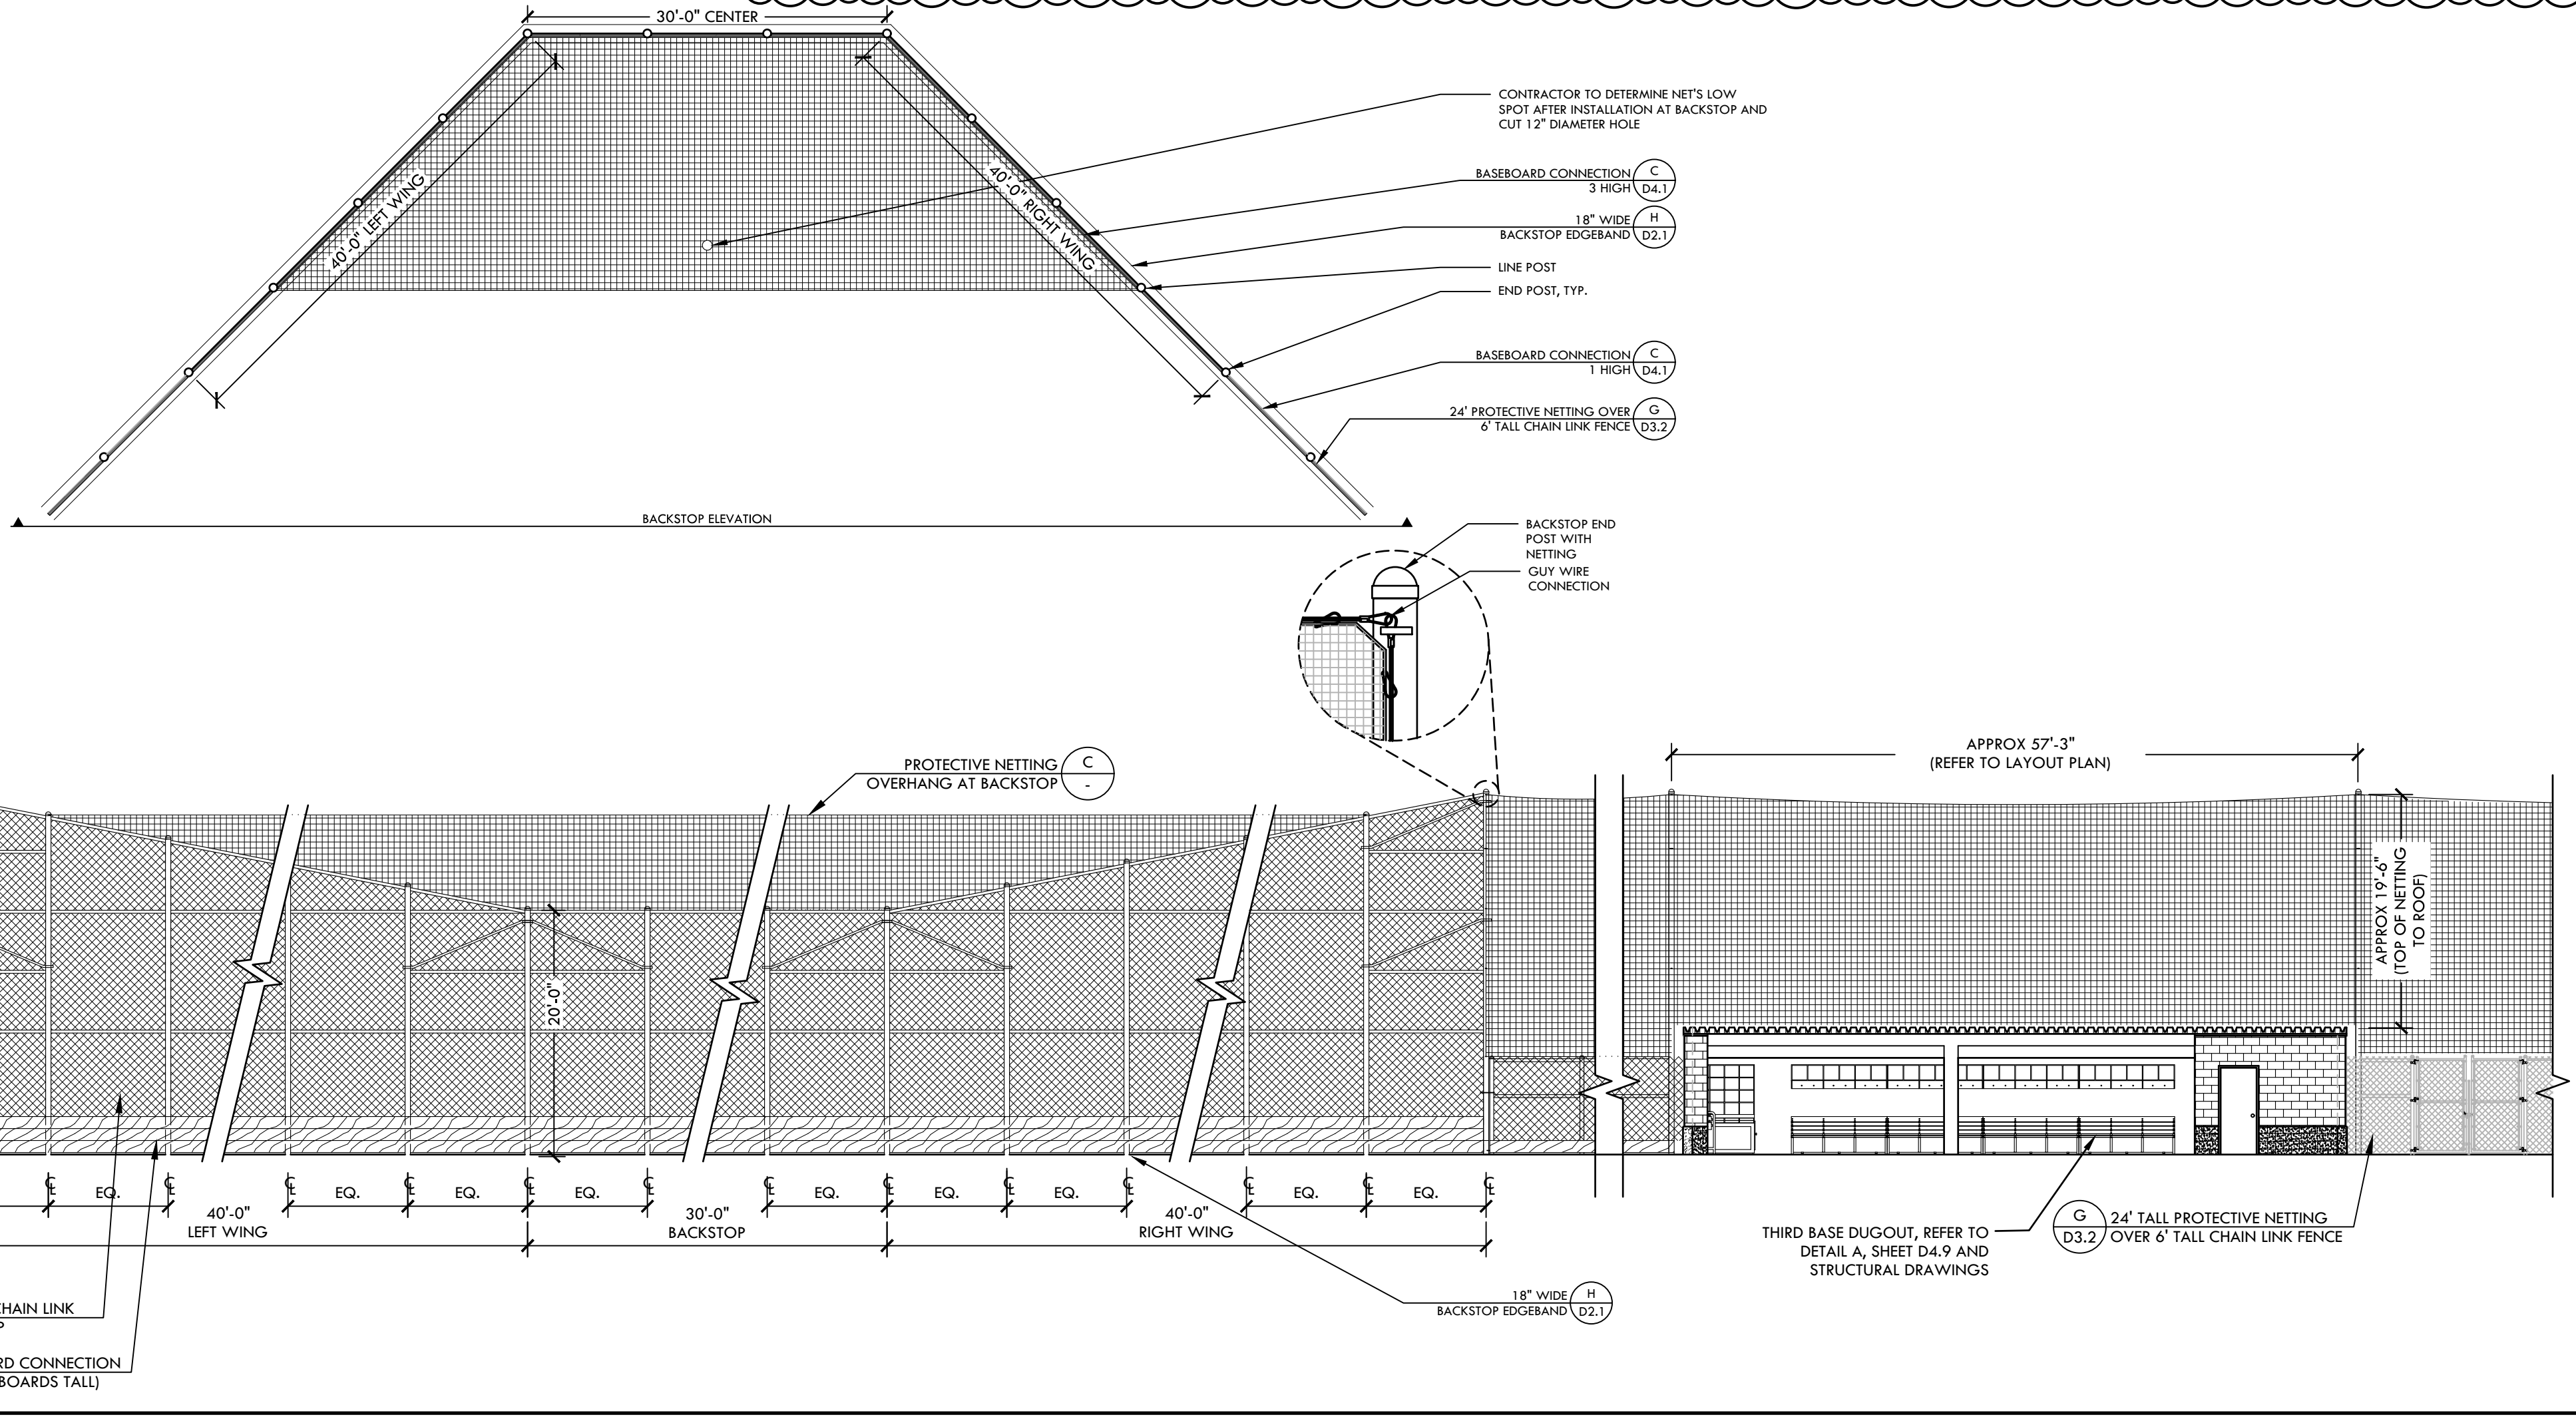
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PLAN - SOFTBALL / BASEBALL BACKSTOP




- NOTES:
- CONTRACTOR TO FIELD VERIFY ALL DIMENSIONS.
 - EYE BOLT TO BE INSTALLED AT BOTH END POSTS WITH ATTACHED GUY WIRE CONNECTION.
 - NETS TO BE FINISHED IN THE FIELD. CONTRACTOR TO PULL TIGHT AND CUT/BOUND IN THE FIELD ALONG THE TOP OF THE BACKSTOP. NETTING SECURED EITHER WITH ZIP TIES OR LASHINGS, AND THEN CUT THE EXCESS OFF, LEAVING A FINISHED SEAM AT THE TOP OF THE BACKSTOP.


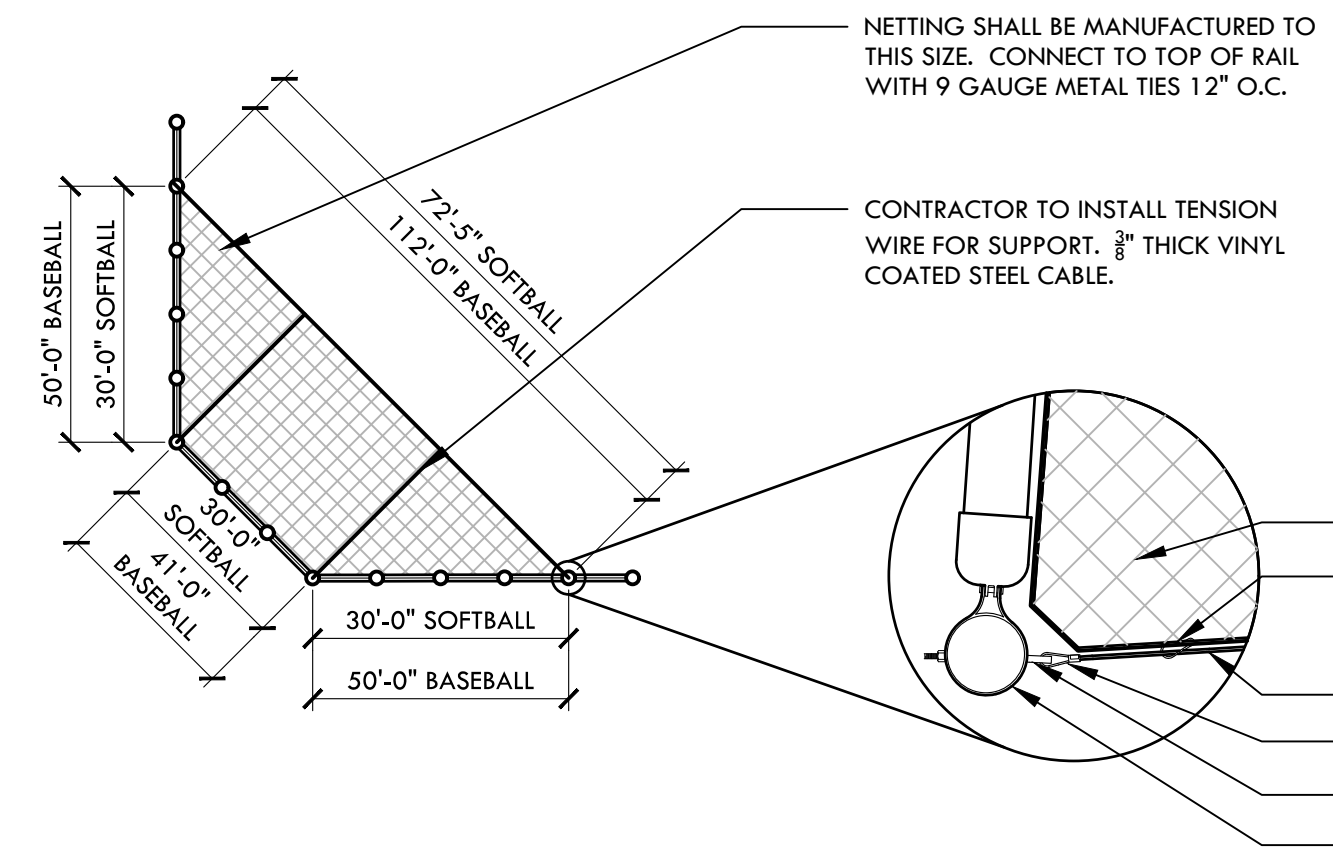
PROTECTIVE NETTING OVERHANG AT BACKSTOP (OPTIONAL)



SOFTBALL BACKSTOP ELEVATION

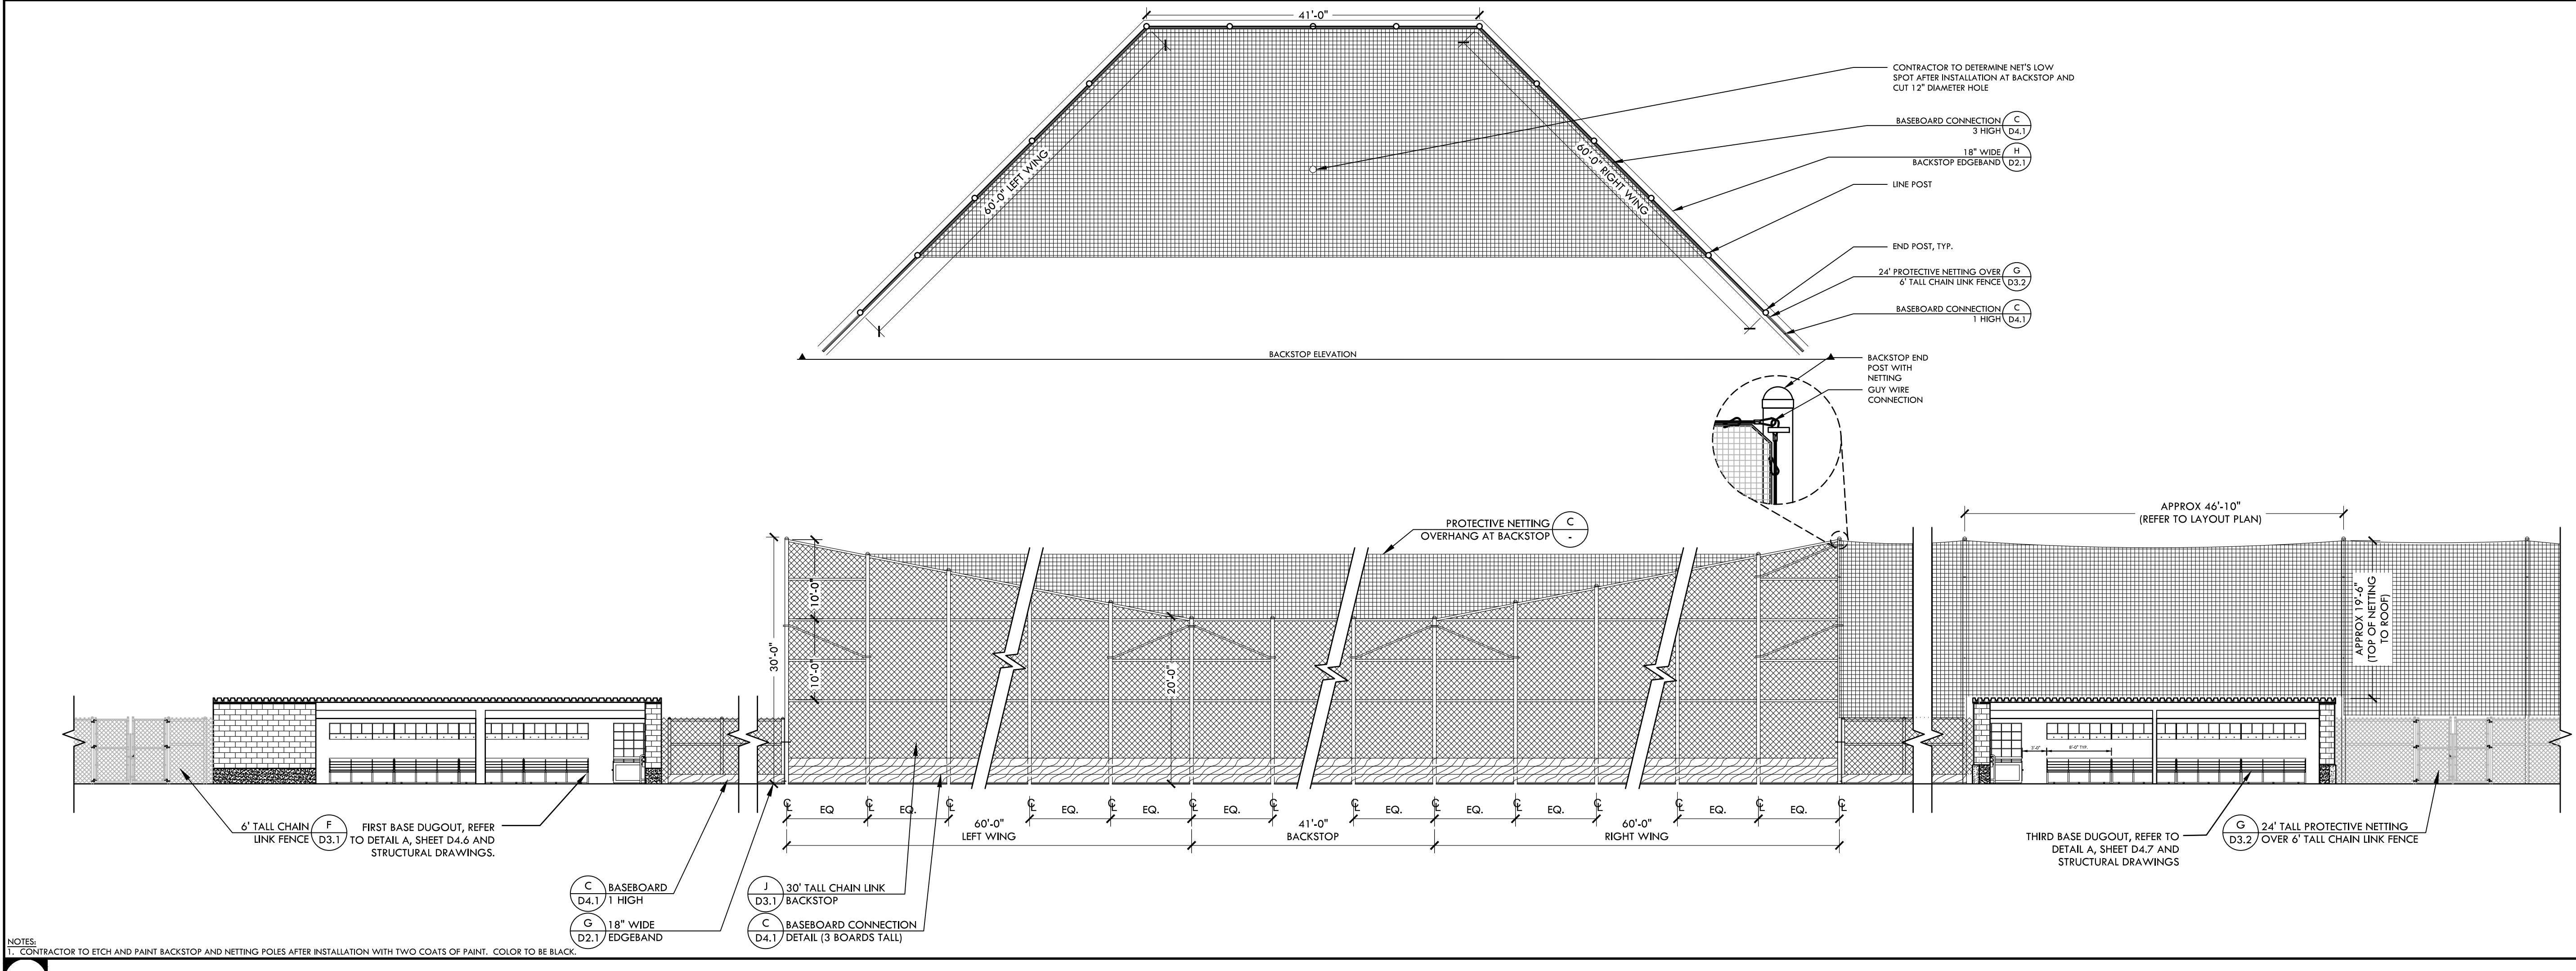

BASEBALL BACKSTOP ELEVATION

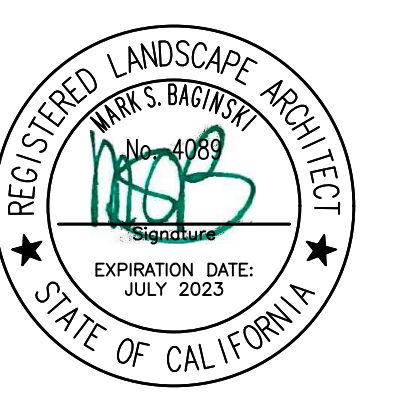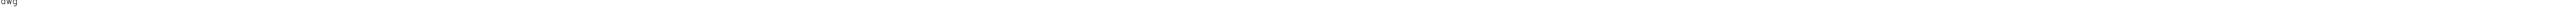

STAMP

CONSULTANT

KEYMAP

SHEET TITLE

PROJECT NAME

PROJECT ADDRESS

SUBMITTAL	DATE
DD 50% SUBMITTAL	04/15/22
100% DSA SUBMITTAL	05/27/22
DSA BACK CHECK	08/11/22
DSA ADDENDUM SUBMITTAL	09/16/22

NO.	REVISIONS	DATE
1	ADDENDUM	09/16/22




DRAWN BY: VDI CHECKED BY: MB/CS

DATE ISSUED: 09/16/2022 SCALE: AS NOTED

PROJ. NO.: 2203200

SHEET NO.: D3.3

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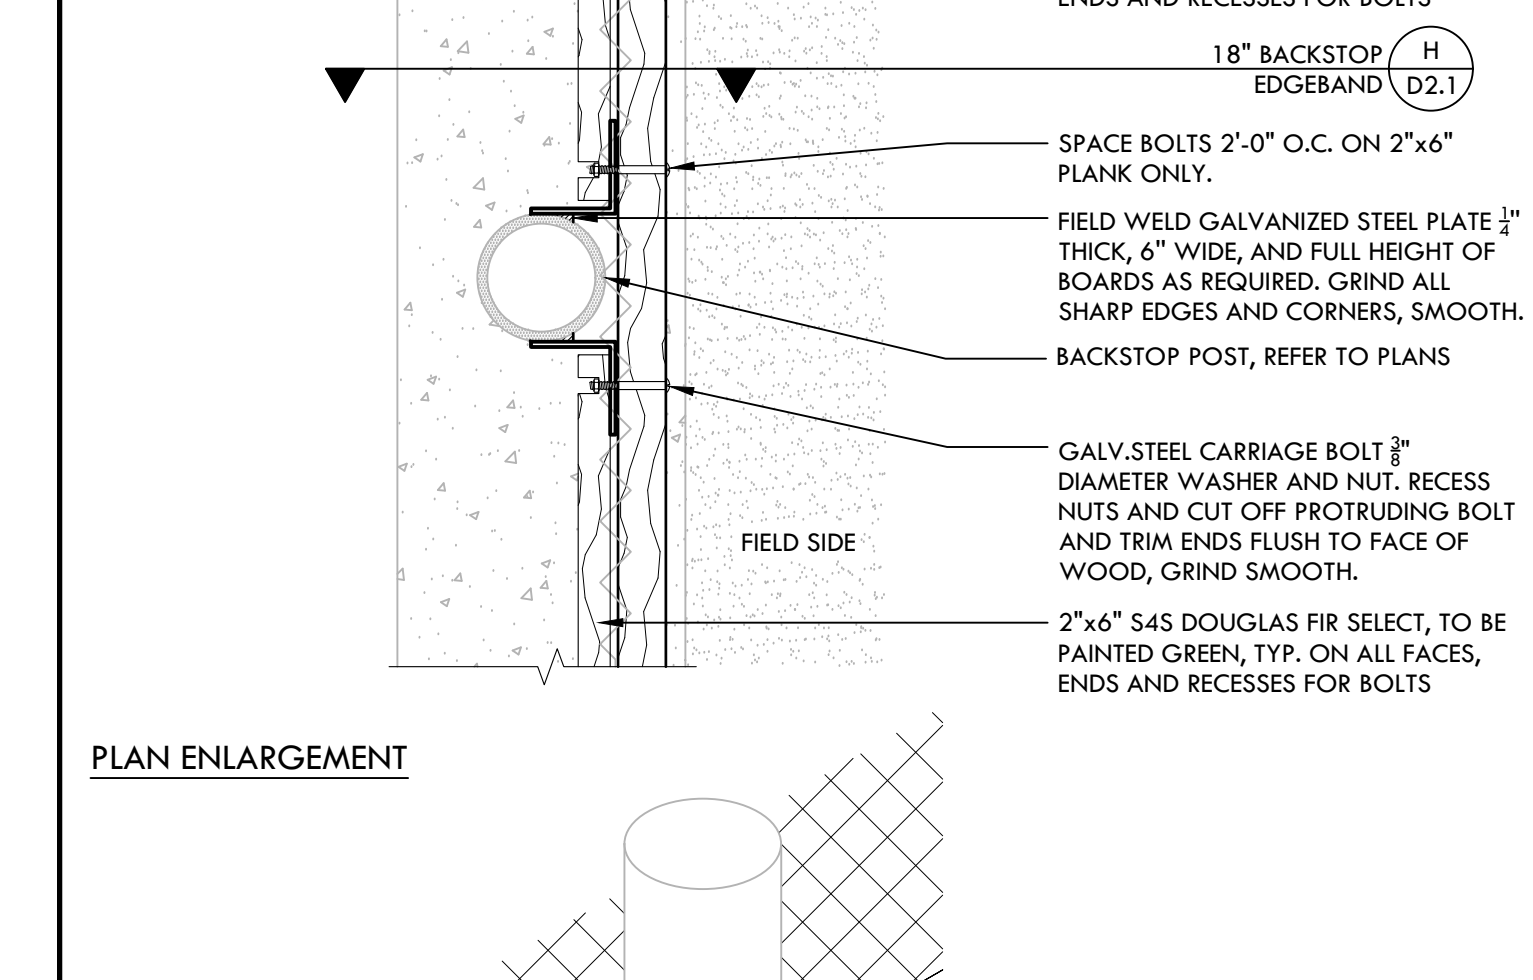
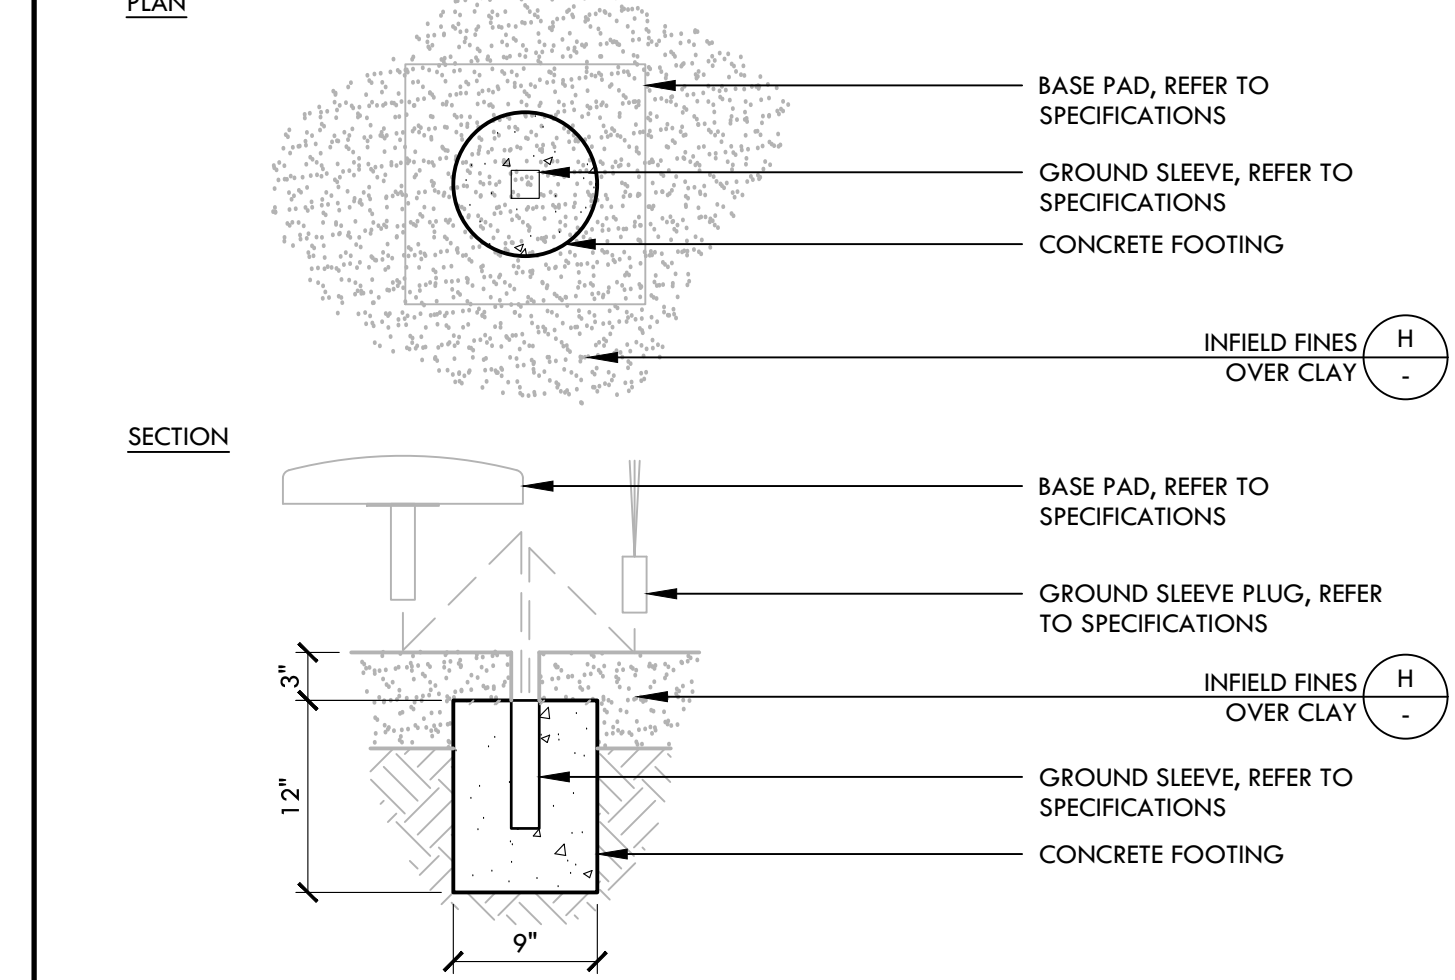
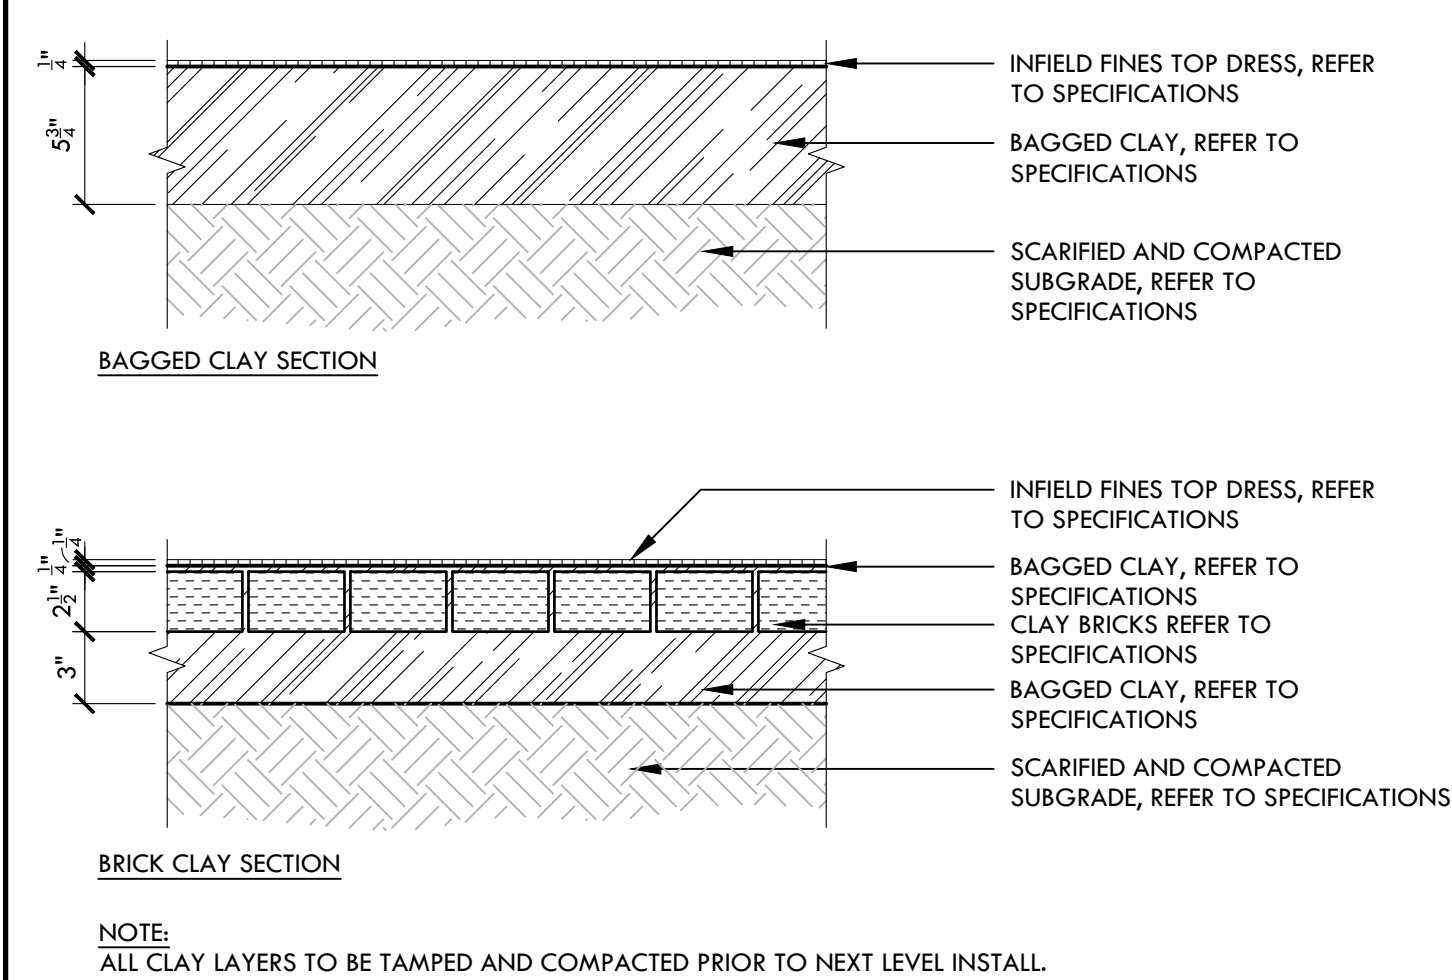
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1 WARNING TRACK FINES NTS

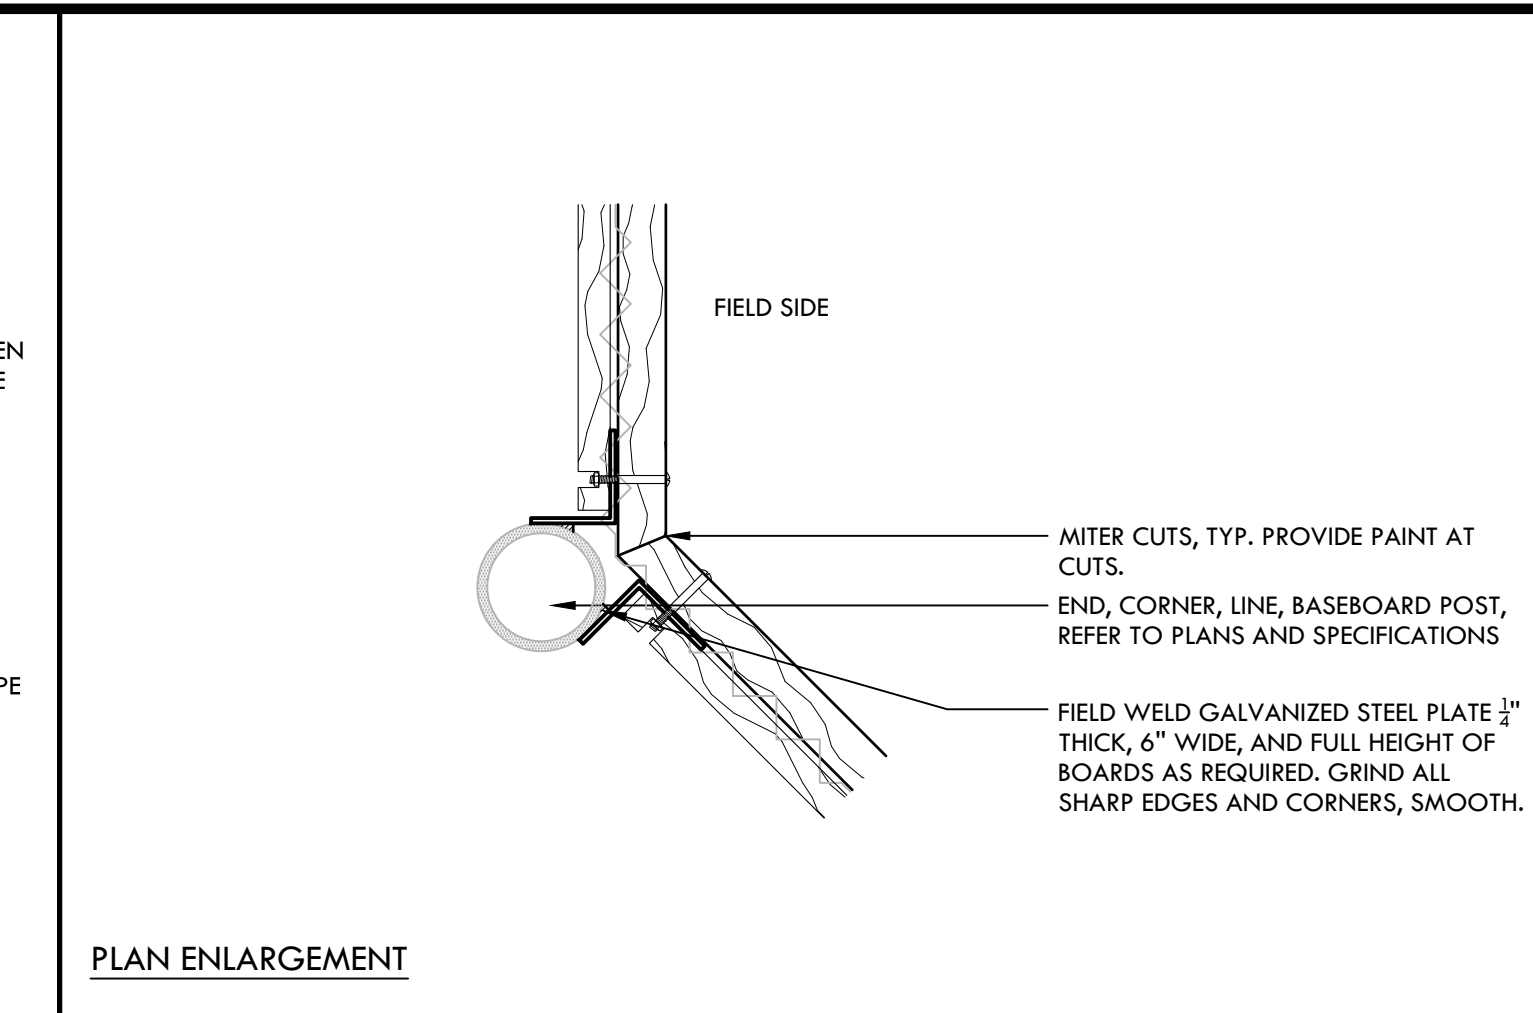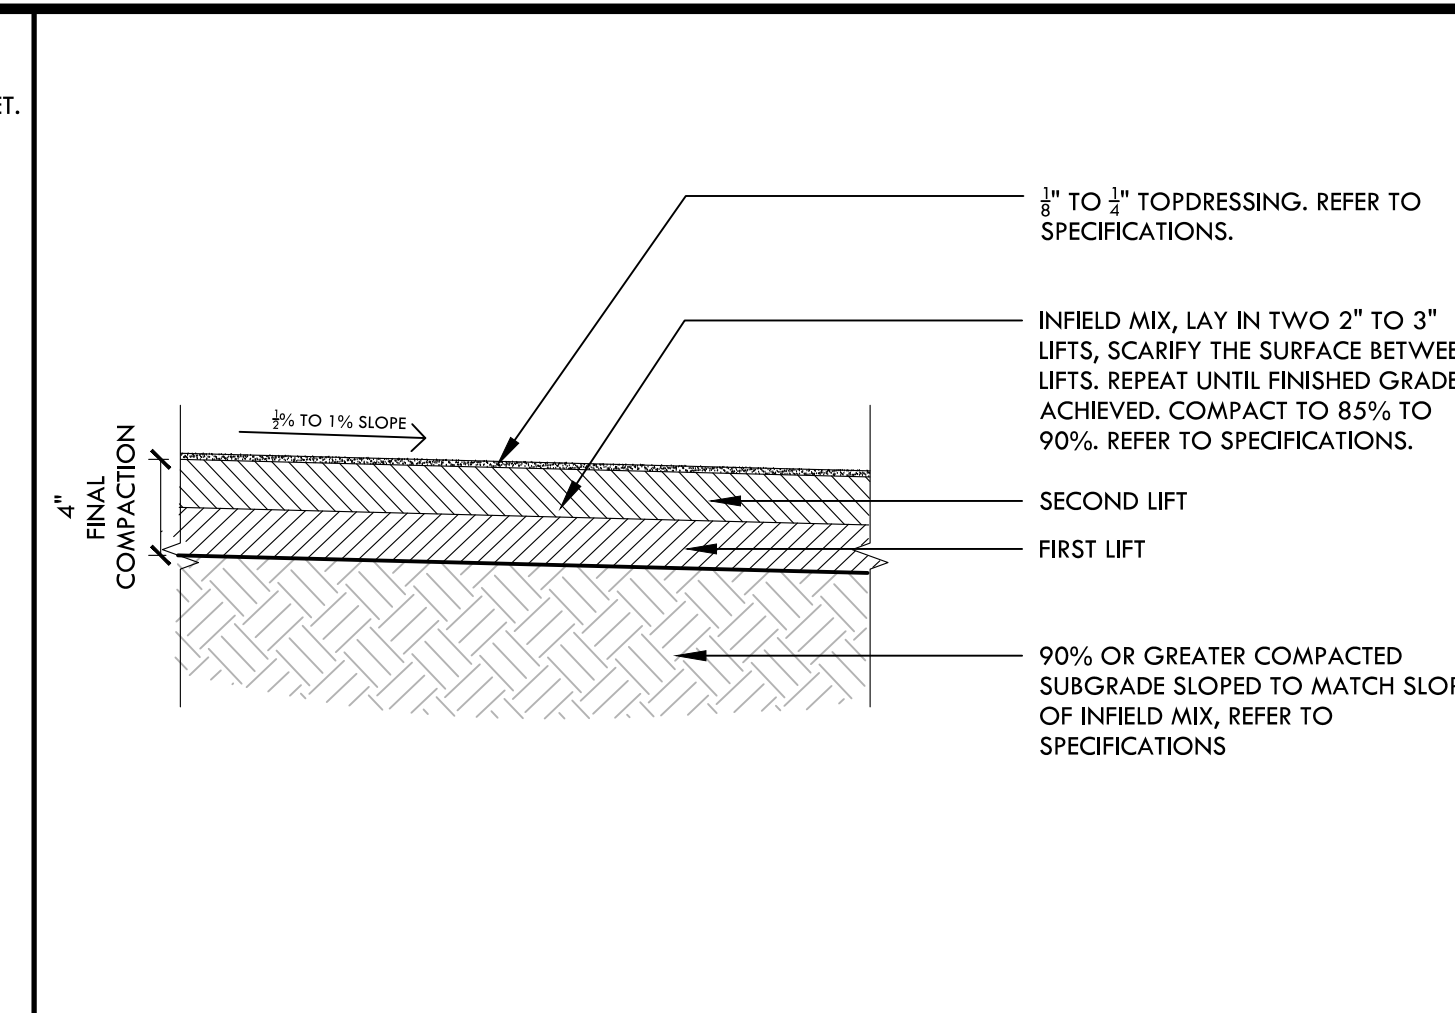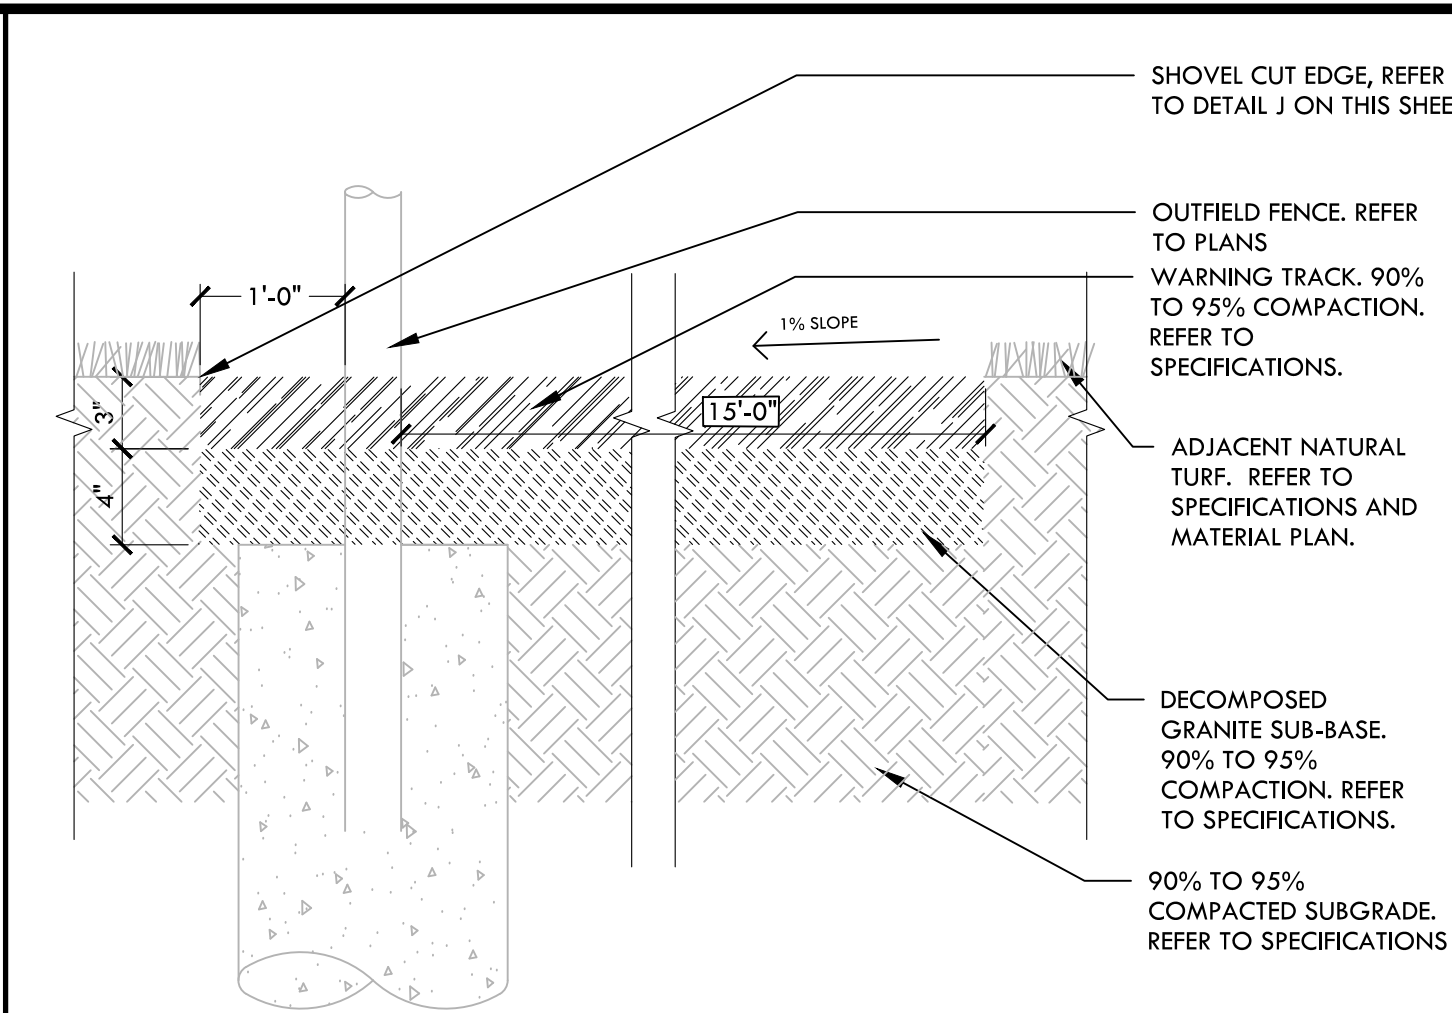F INFIELD FINES NTS

C PLAN ENLARGEMENT NTS

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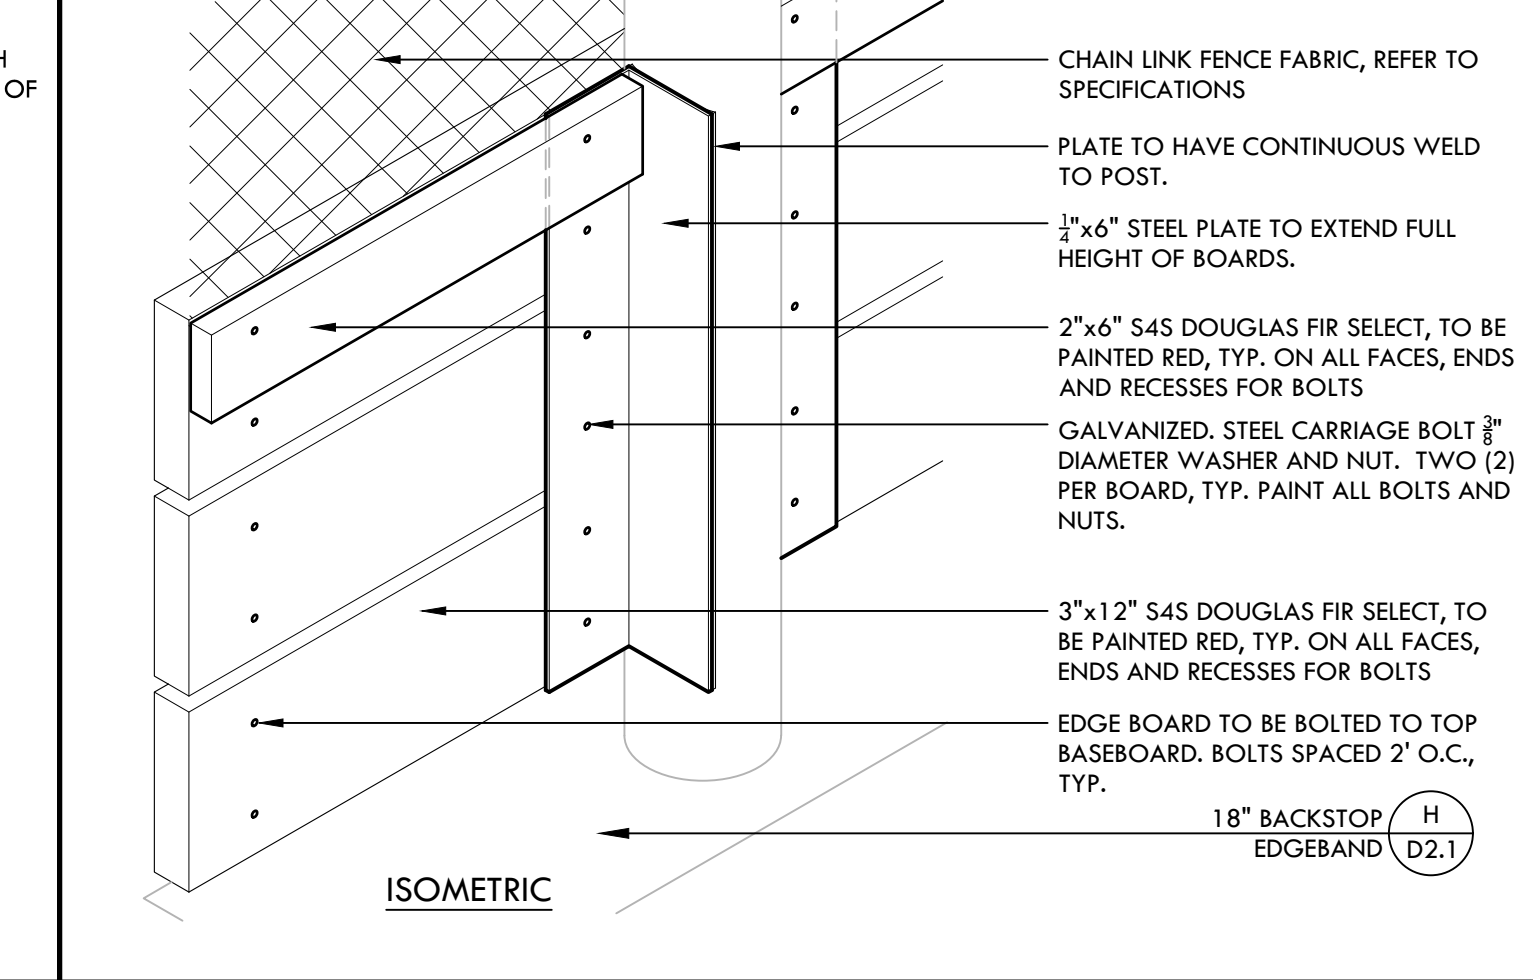
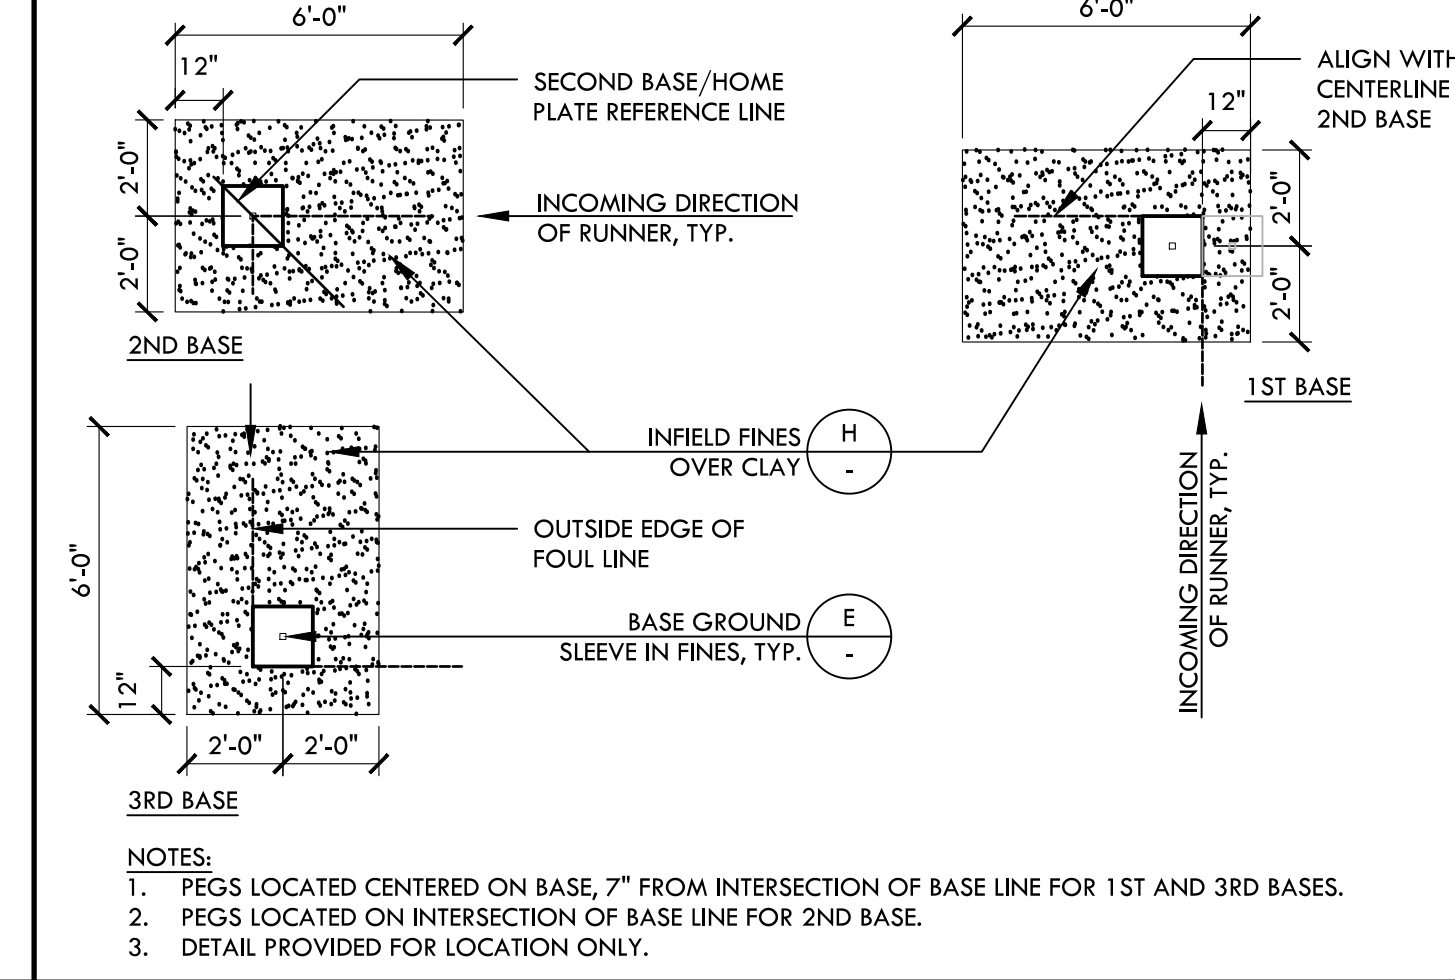
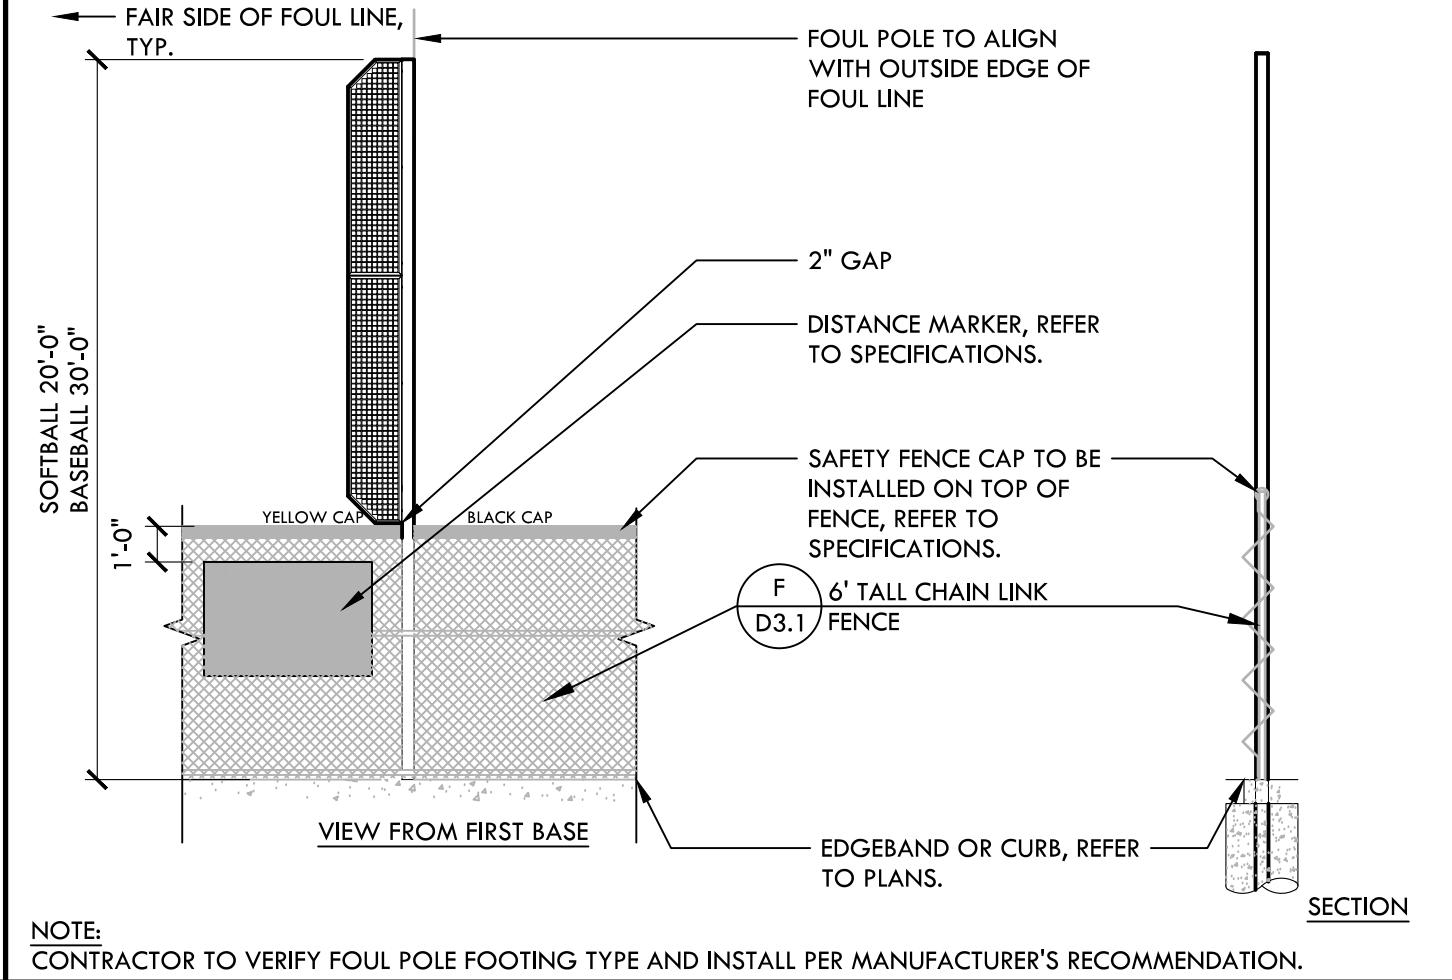
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H INFIELD FINES OVER CLAY NTS

E BASE GROUND SLEEVE IN FINES NTS

C ISOMETRIC NTS

NOT USED




K

G FOUL POLE NTS

D BASE PAD LOCATION NTS

C BASE BOARD CONNECTION DETAIL NTS

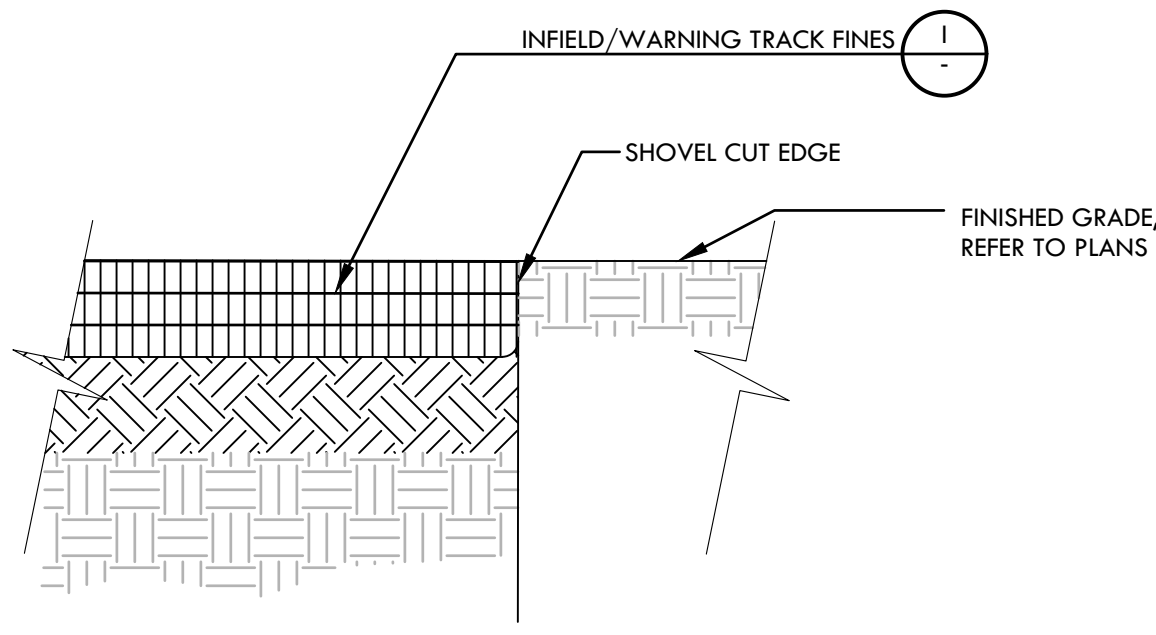

NOTE: FINES TO EXTEND 1'-0" BEYOND FENCE (WHERE APPLICABLE) AND TERMINATE W/ SHOVEL CUT EDGE.

J

B SHOVEL CUT EDGE NTS

NOT USED

A

NOT USED

VERDE DESIGN LANDSCAPE ARCHITECTURE CIVIL ENGINEERING SPORT PLANNING & DESIGN 1843 Iron Point Rd, Suite 140 Folsom, CA 95630

REGISTERED LANDSCAPE ARCHITECT STATE OF CALIFORNIA EXPIRATION DATE: JULY 2023

CONSULTANT

KEYMAP

CONSTRUCTION DETAILS - BALL FIELDS

HIRAM JOHNSON HIGH SCHOOL GOLF PRACTICE FACILITY, VARSITY BASEBALL AND SOFTBALL FIELDS

6879 14TH AVENUE SACRAMENTO, CA 95820

Table with columns: SUBMITTAL, DATE. Rows: DD 50% SUBMITTAL (04/15/22), 100% DSA SUBMITTAL (05/27/22), DSA BACK CHECK (08/11/22), DSA ADDENDUM SUBMITTAL (09/16/22)

Table with columns: NO., REVISIONS, DATE. Rows: ADDENDUM (09/16/22)


DRAWN BY: VDI CHECKED BY: MB/CS DATE ISSUED: 09/16/2022 SCALE: AS NOTED

PROJ. NO. 2203200 SHEET NO. D4.1

VERTICAL SCALE: 1"=10'-0" HORIZONTAL SCALE: 1"=10'-0" DATE: 09/15/22 PLOTTED BY: station27

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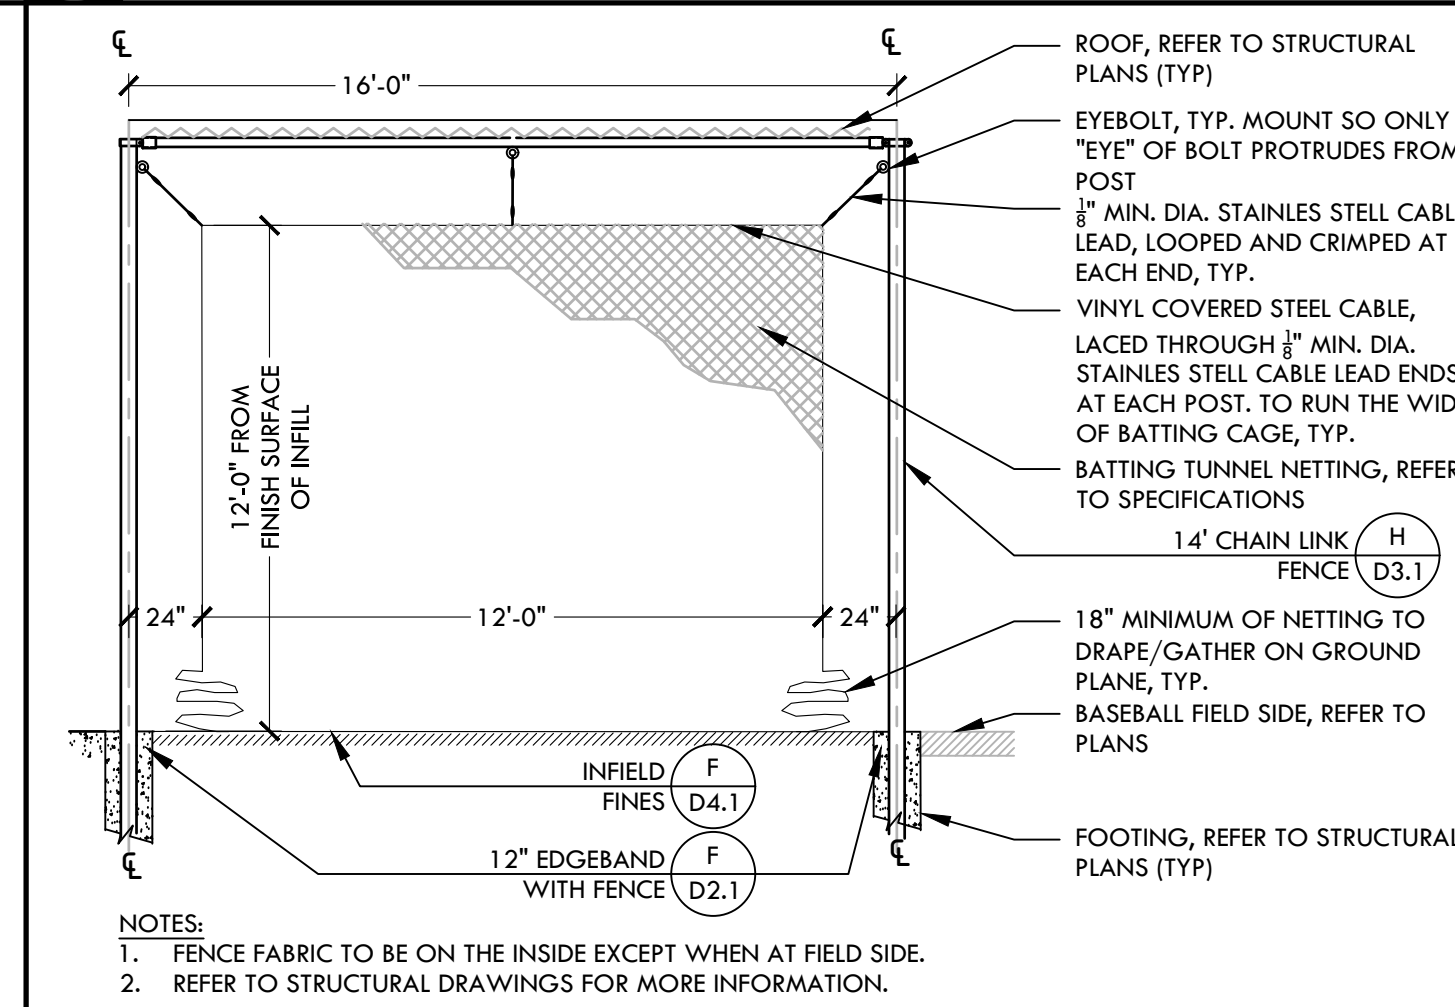


E BASEBALL BATTING CAGE - PLAN

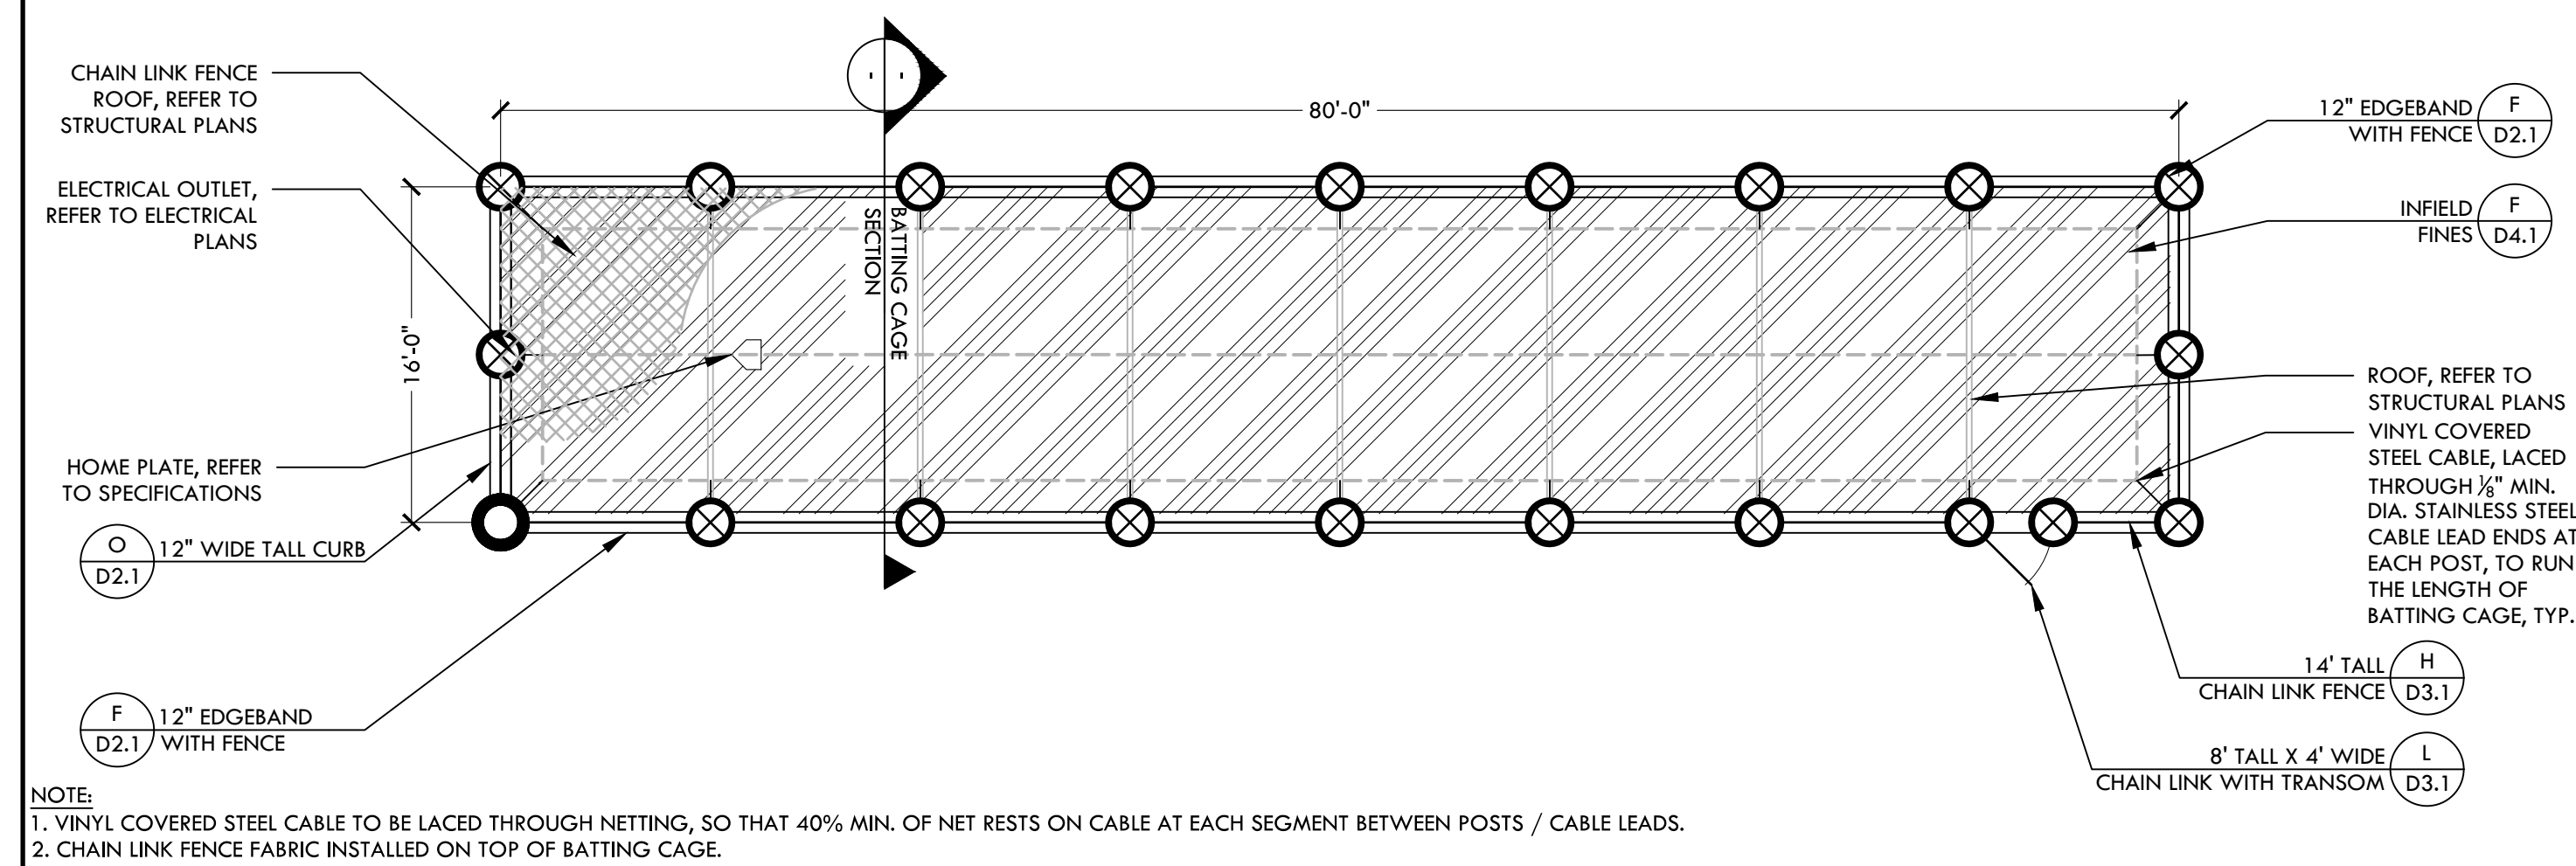NTS

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NOT USED




D BATTING CAGE - SECTION

NTS

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NOT USED

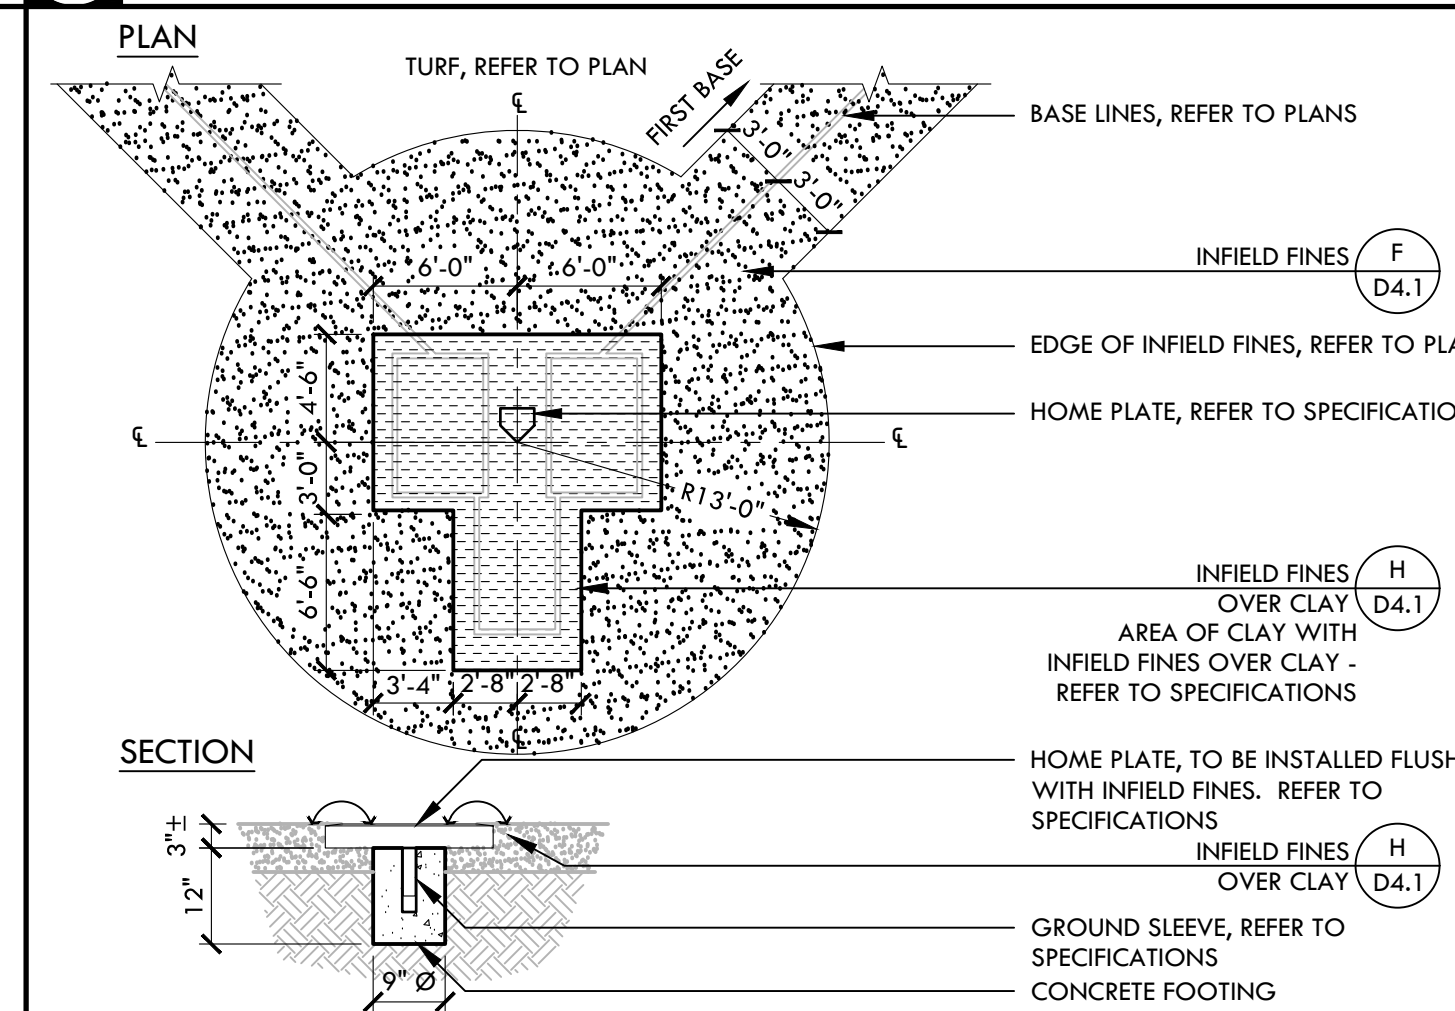


C HOME PLATE - BASEBALL

NTS

NOT USED

NOT USED

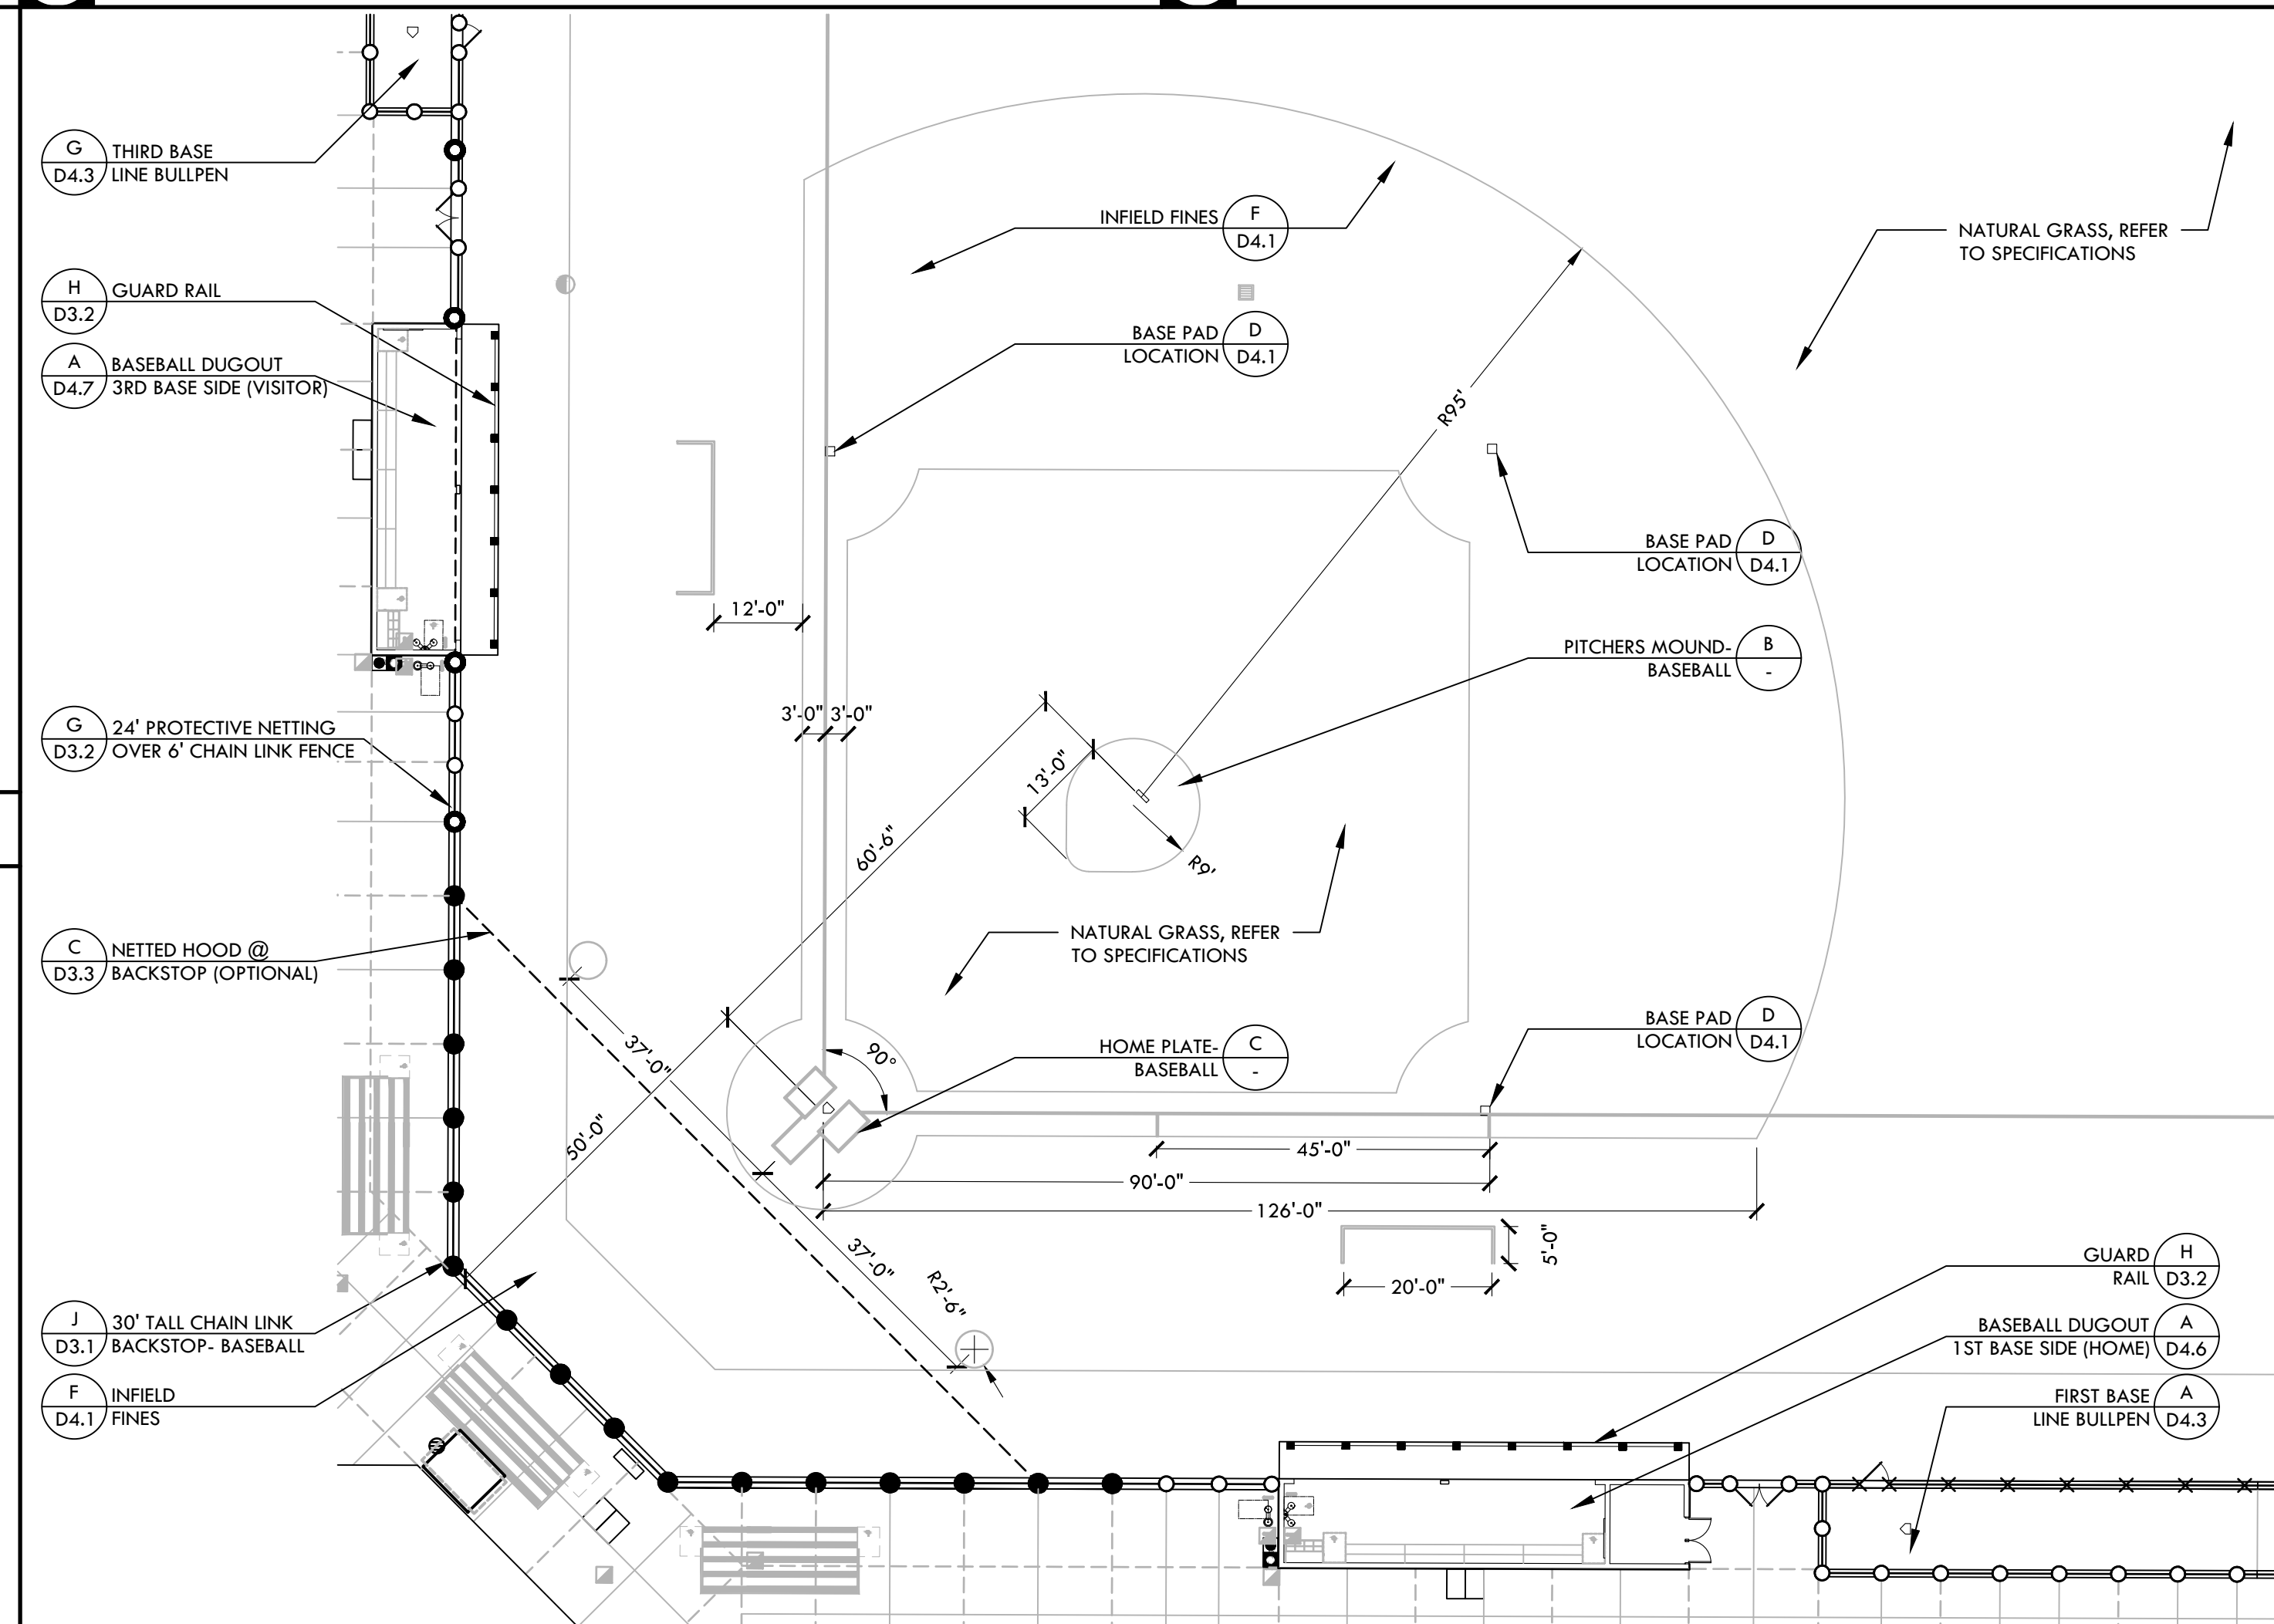


A BASEBALL INFIELD

NTS

NOT USED

NOT USED

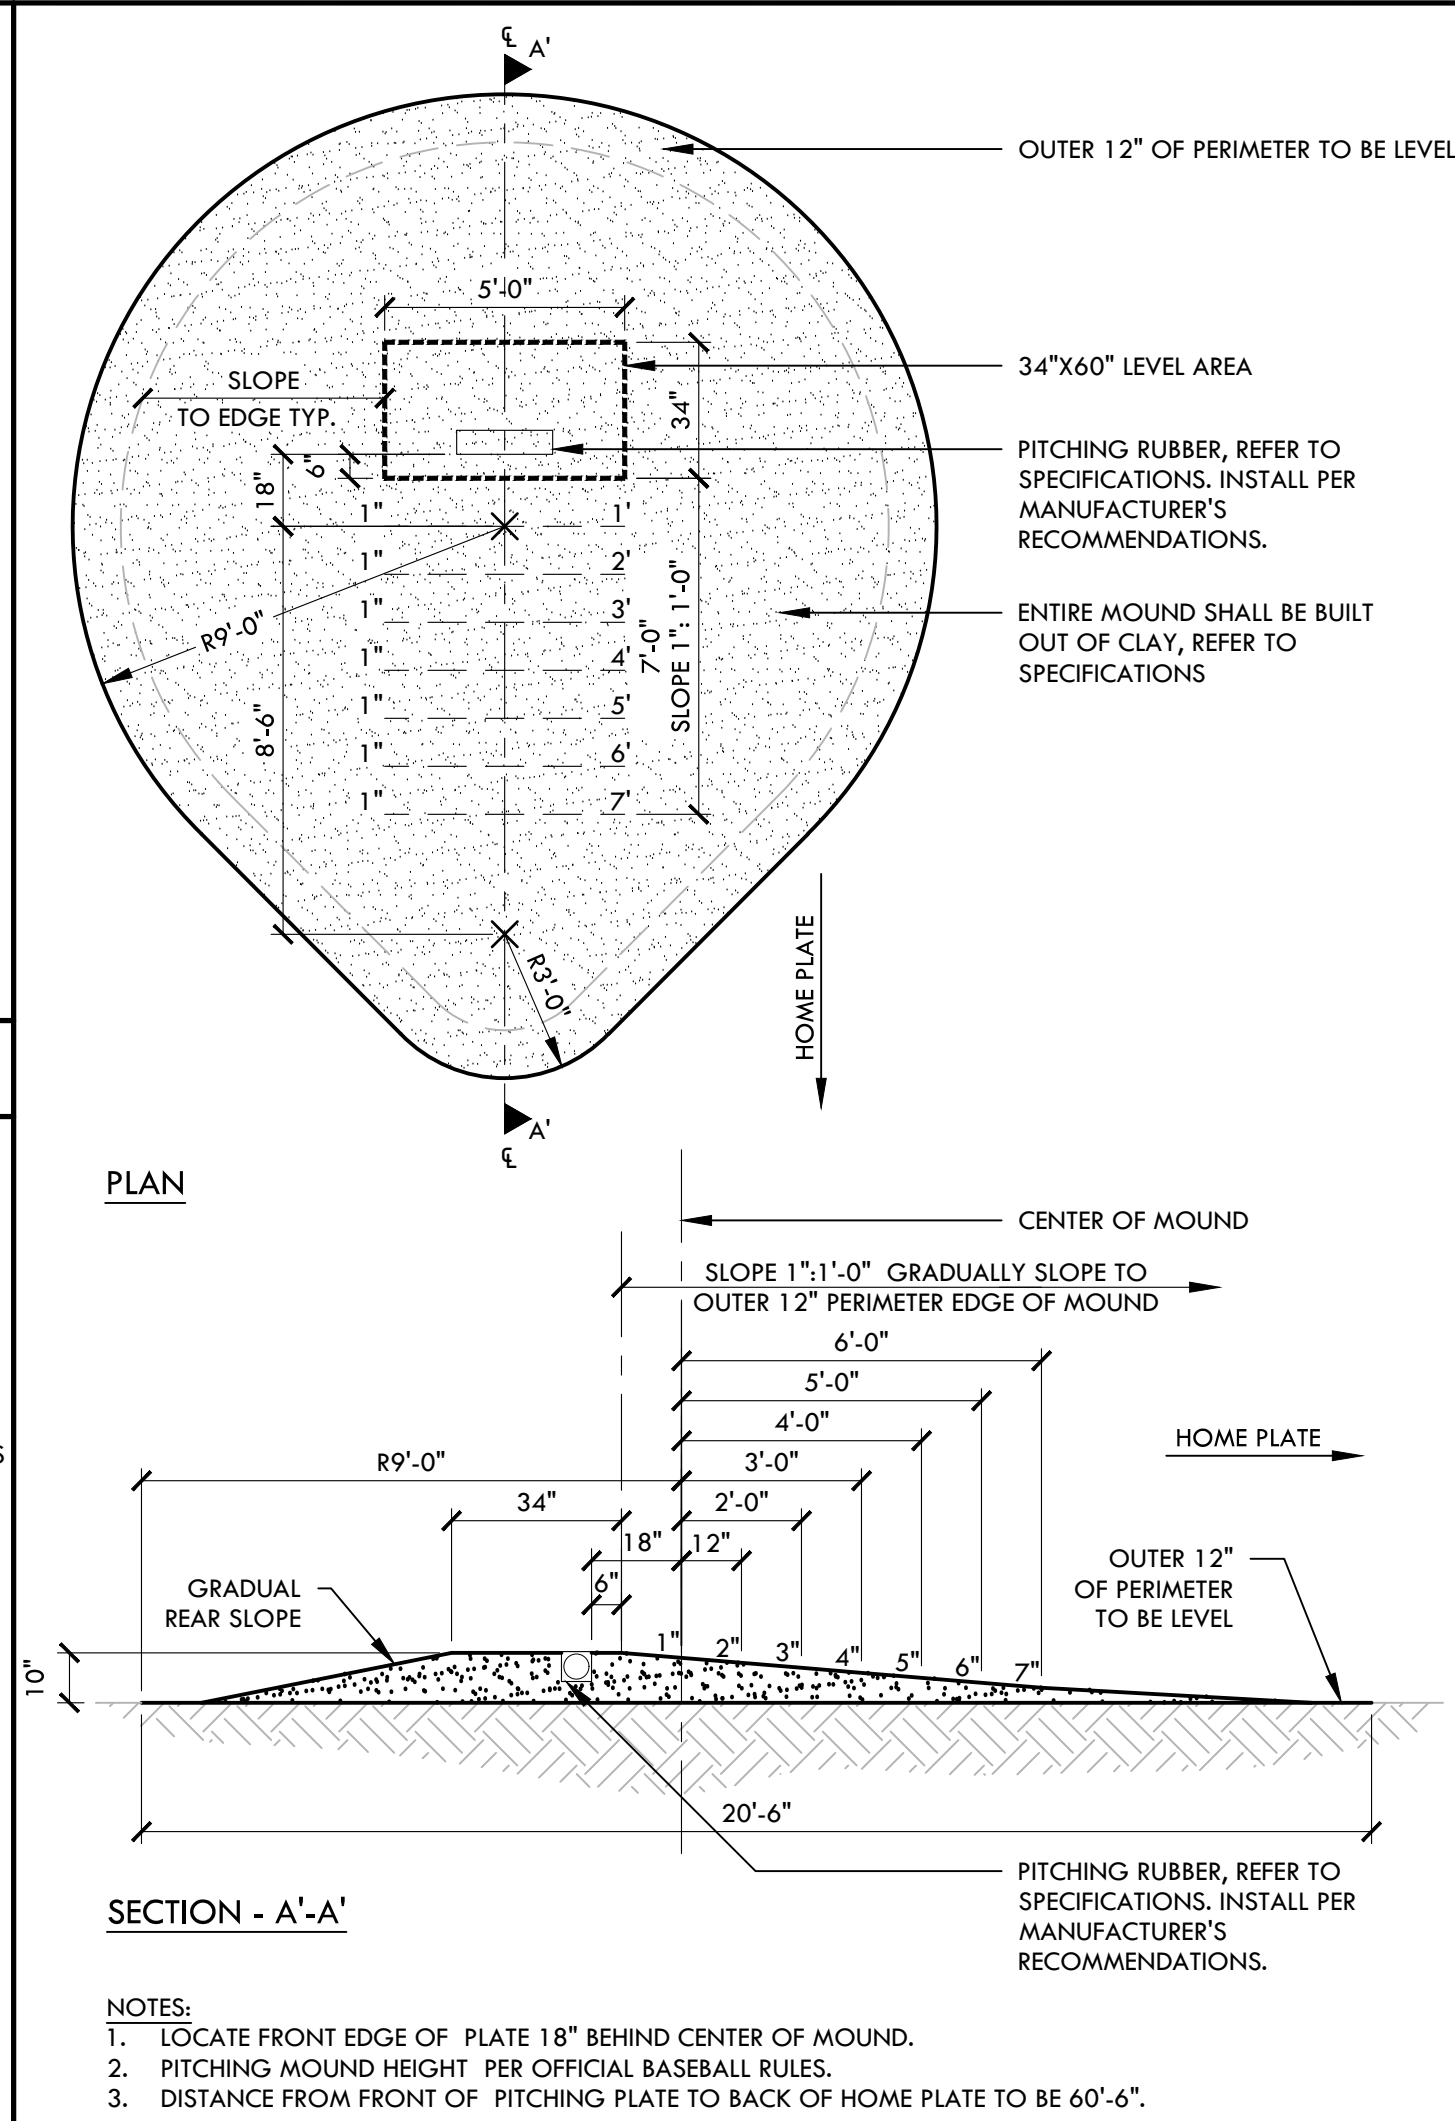

B PITCHERS MOUND - BASEBALL

NTS



CONSULTANT

KEYMAP

SHEET TITLE

CONSTRUCTION DETAILS - BASEBALL

PROJECT NAME

HIRAM JOHNSON HIGH SCHOOL GOLF PRACTICE FACILITY, VARSITY BASEBALL AND SOFTBALL FIELDS

PROJECT ADDRESS

6879 14TH AVENUE SACRAMENTO, CA 95820

SUBMITTAL

DATE

DD 50% SUBMITTAL 04/15/22

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DSA BACK CHECK 08/11/22

DSA ADDENDUM SUBMITTAL 09/16/22

NO. REVISIONS DATE

ADDENDUM 09/16/22

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SCALE AS NOTED

PROJ. NO. 2203200

SHEET NO. D4.2





CONSTRUCTION DETAIL - BASEBALL

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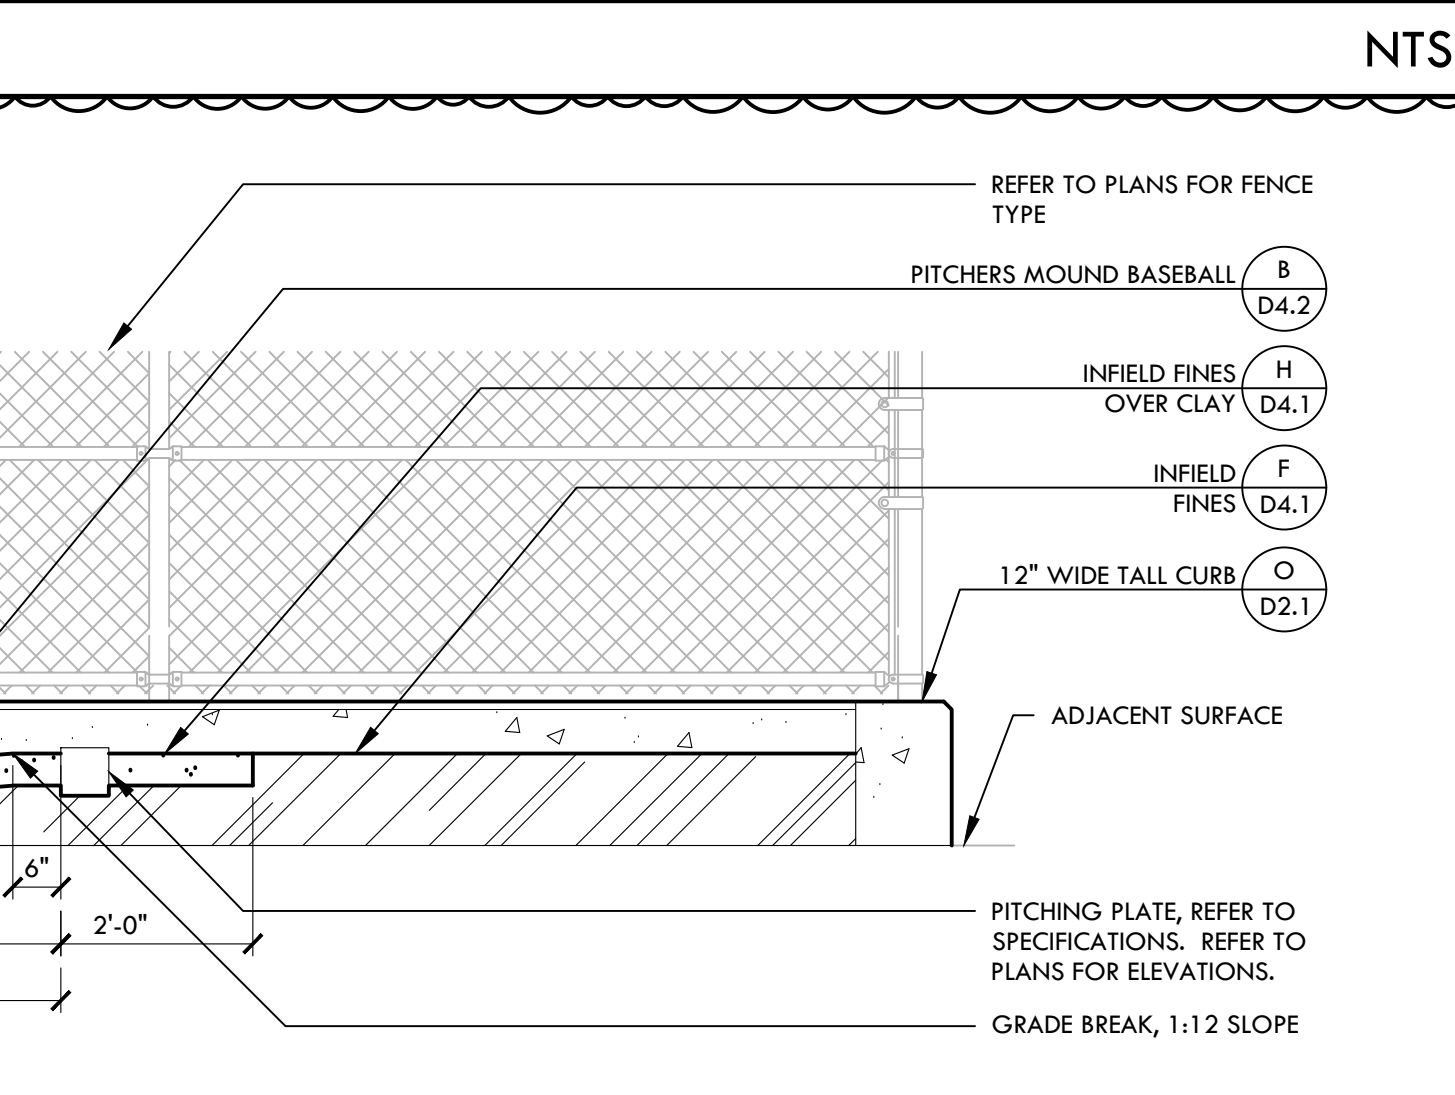
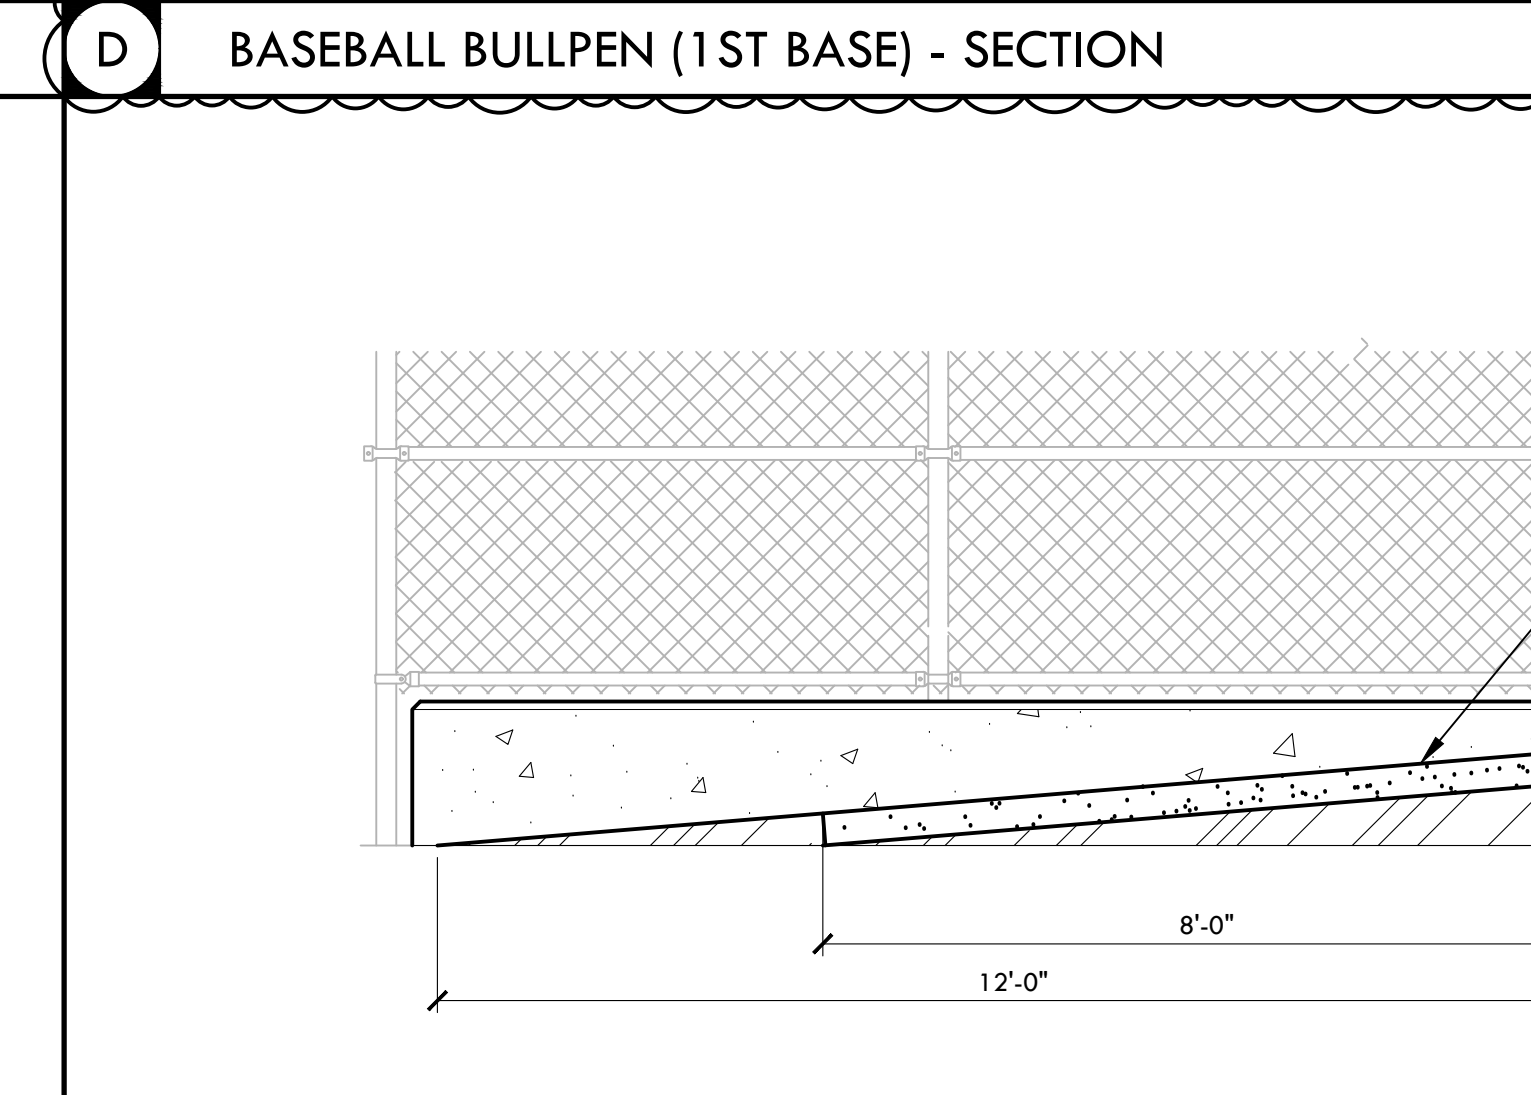
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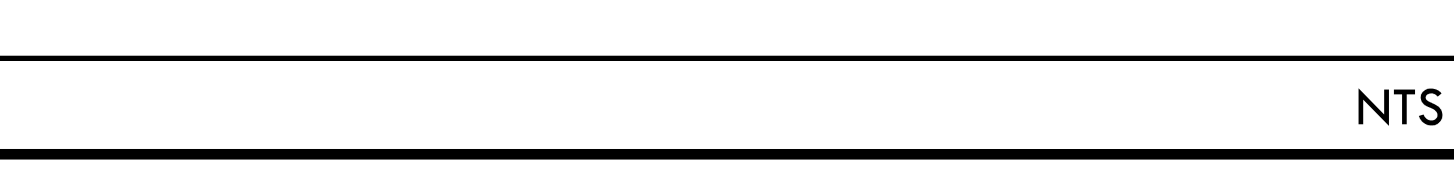
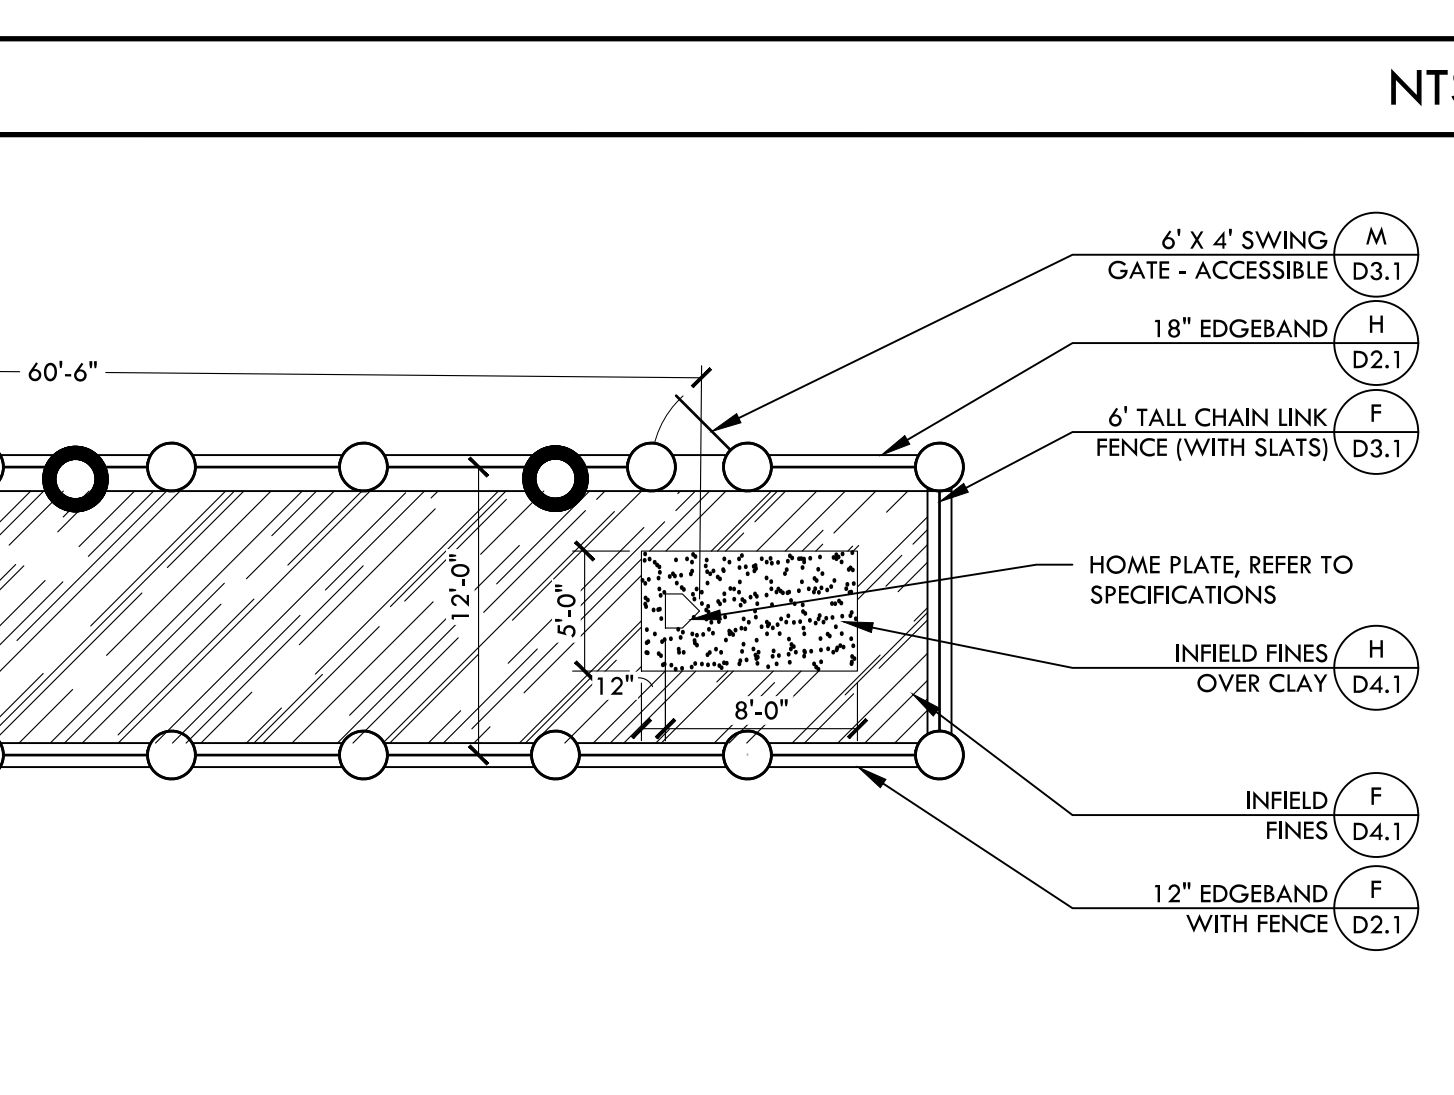
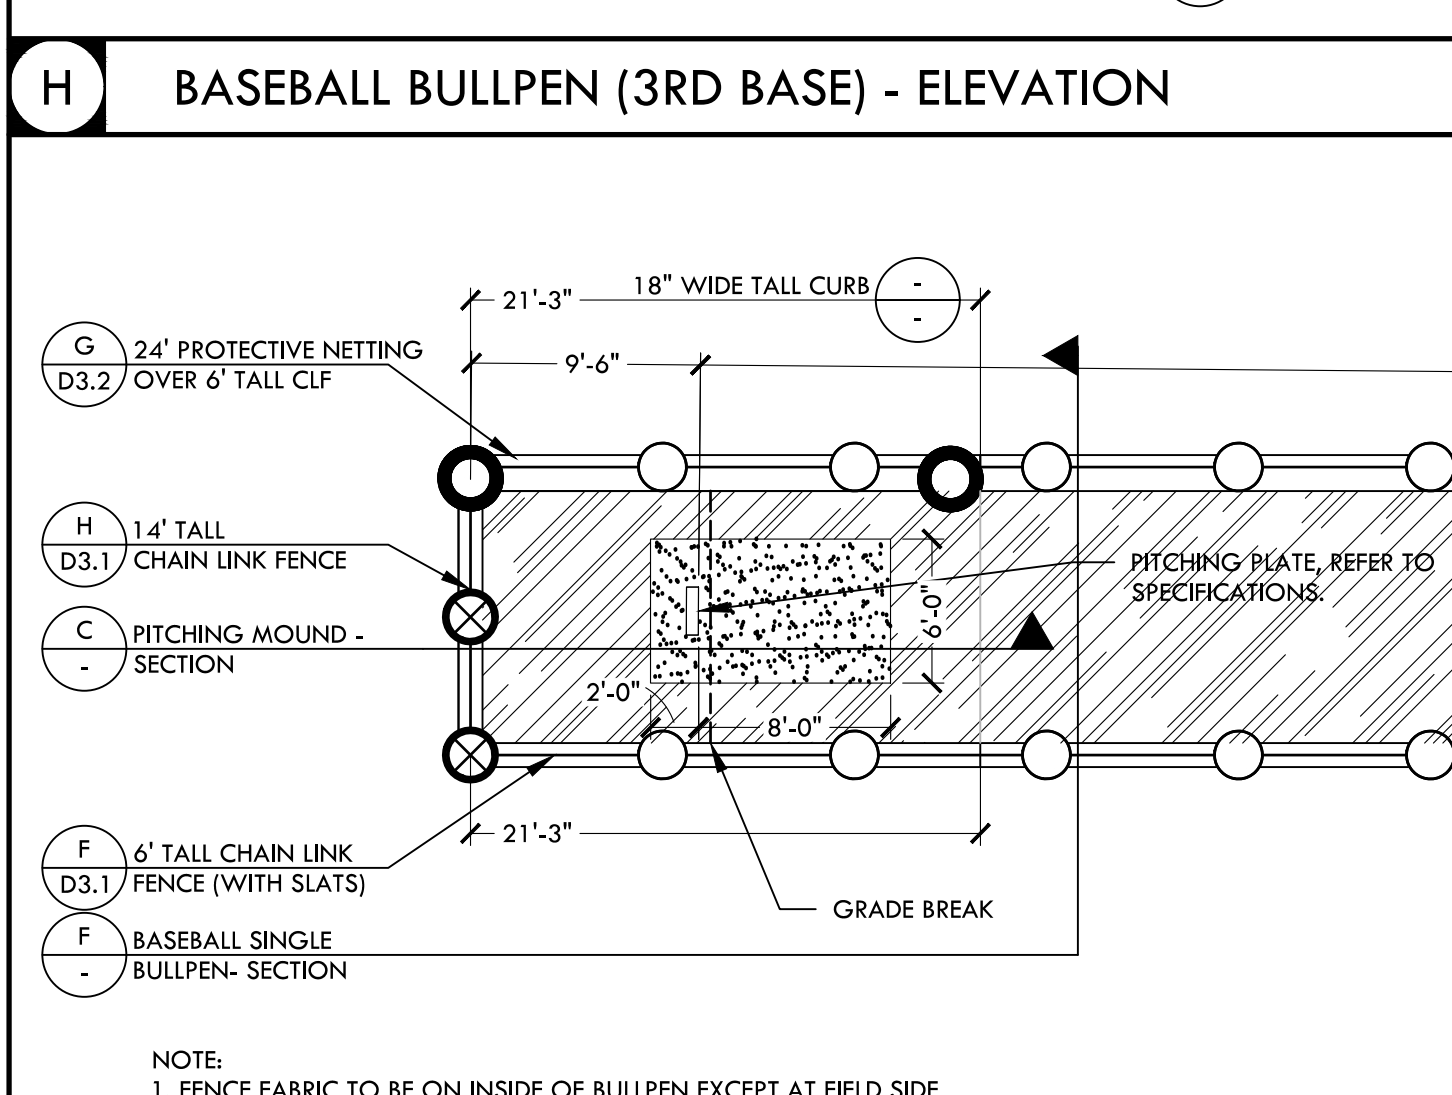
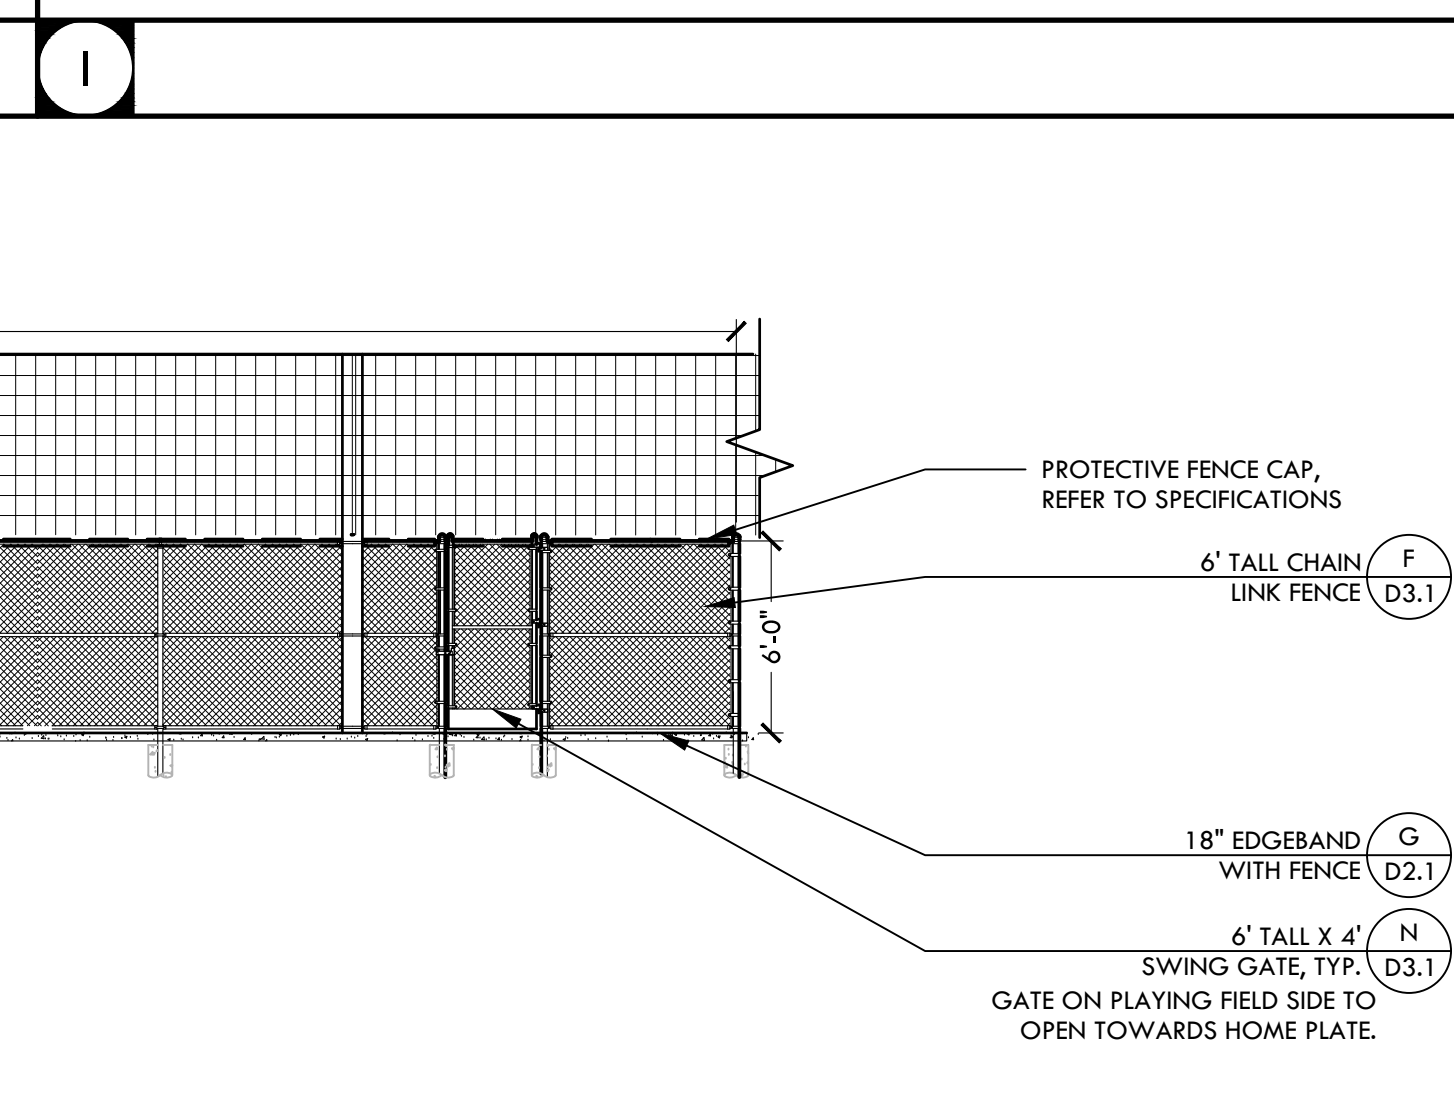
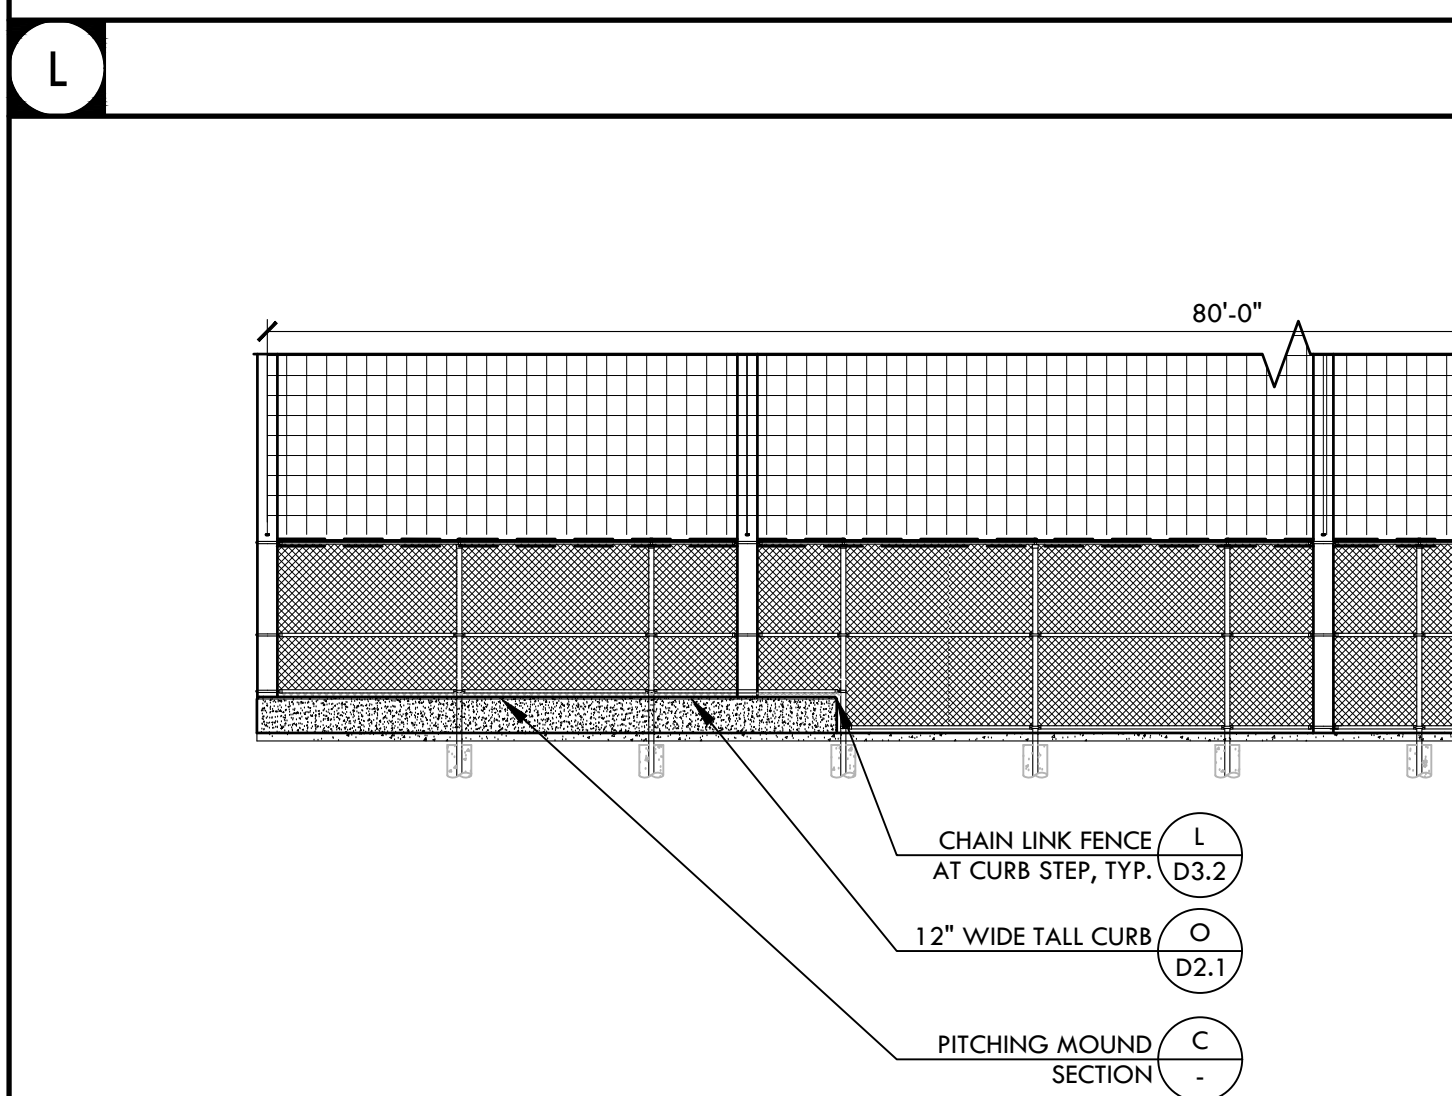
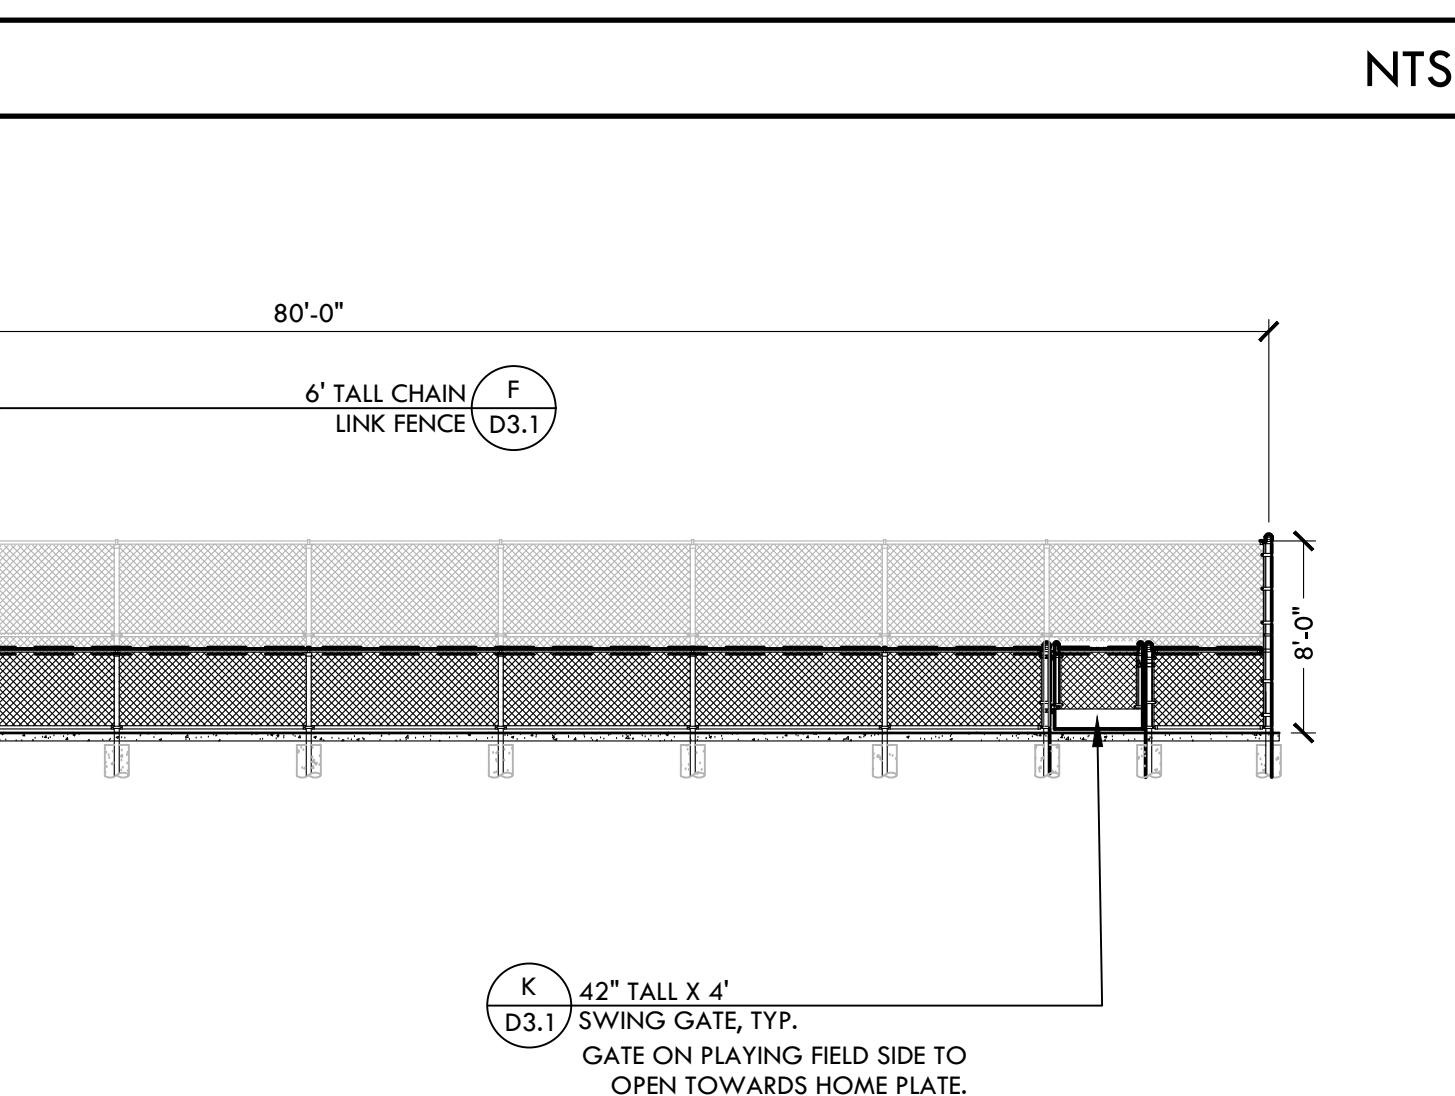
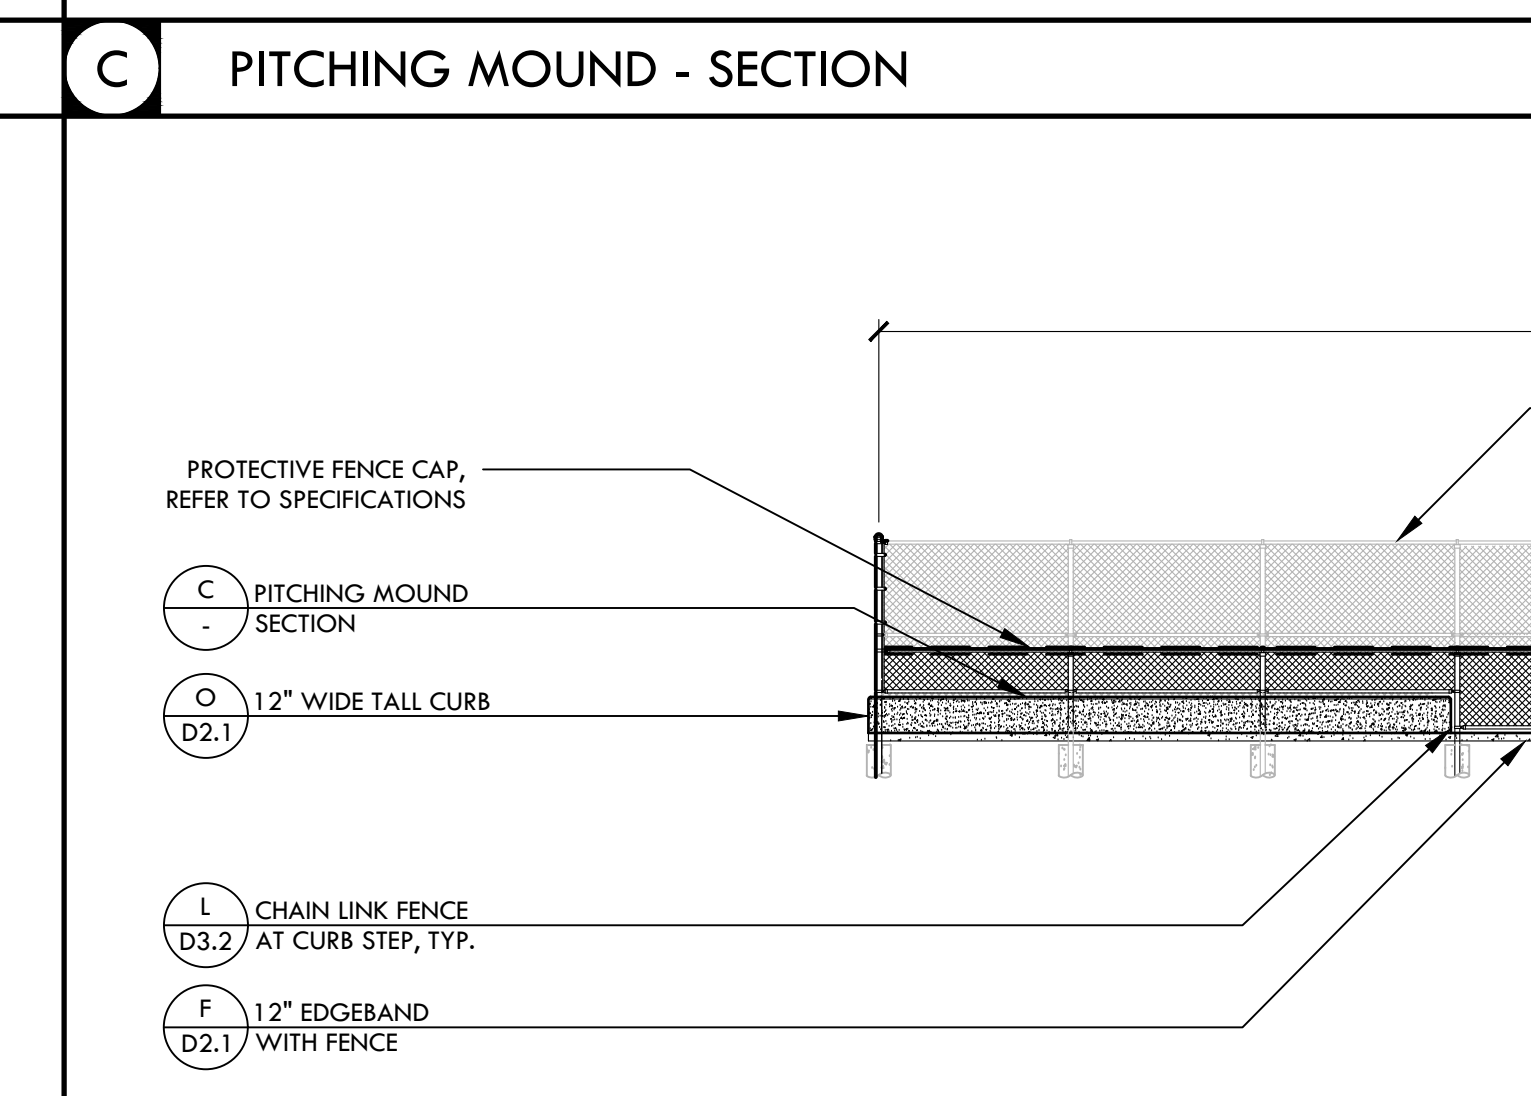
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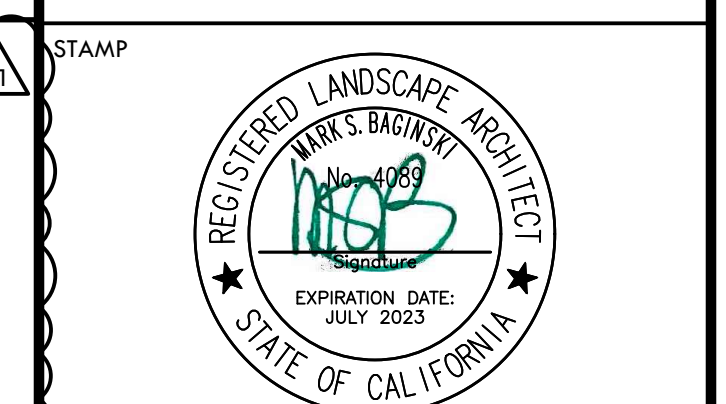
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STAMP
 CONSULTANT
 KEYMAP

SHEET TITLE
**CONSTRUCTION DETAILS -
 BASEBALL AND SOFTBALL**

PROJECT NAME
**HIRAM JOHNSON
 HIGH SCHOOL
 GOLF PRACTICE FACILITY,
 VARSITY BASEBALL AND
 SOFTBALL FIELDS**

PROJECT ADDRESS
**6879 14TH AVENUE
 SACRAMENTO, CA 95820**

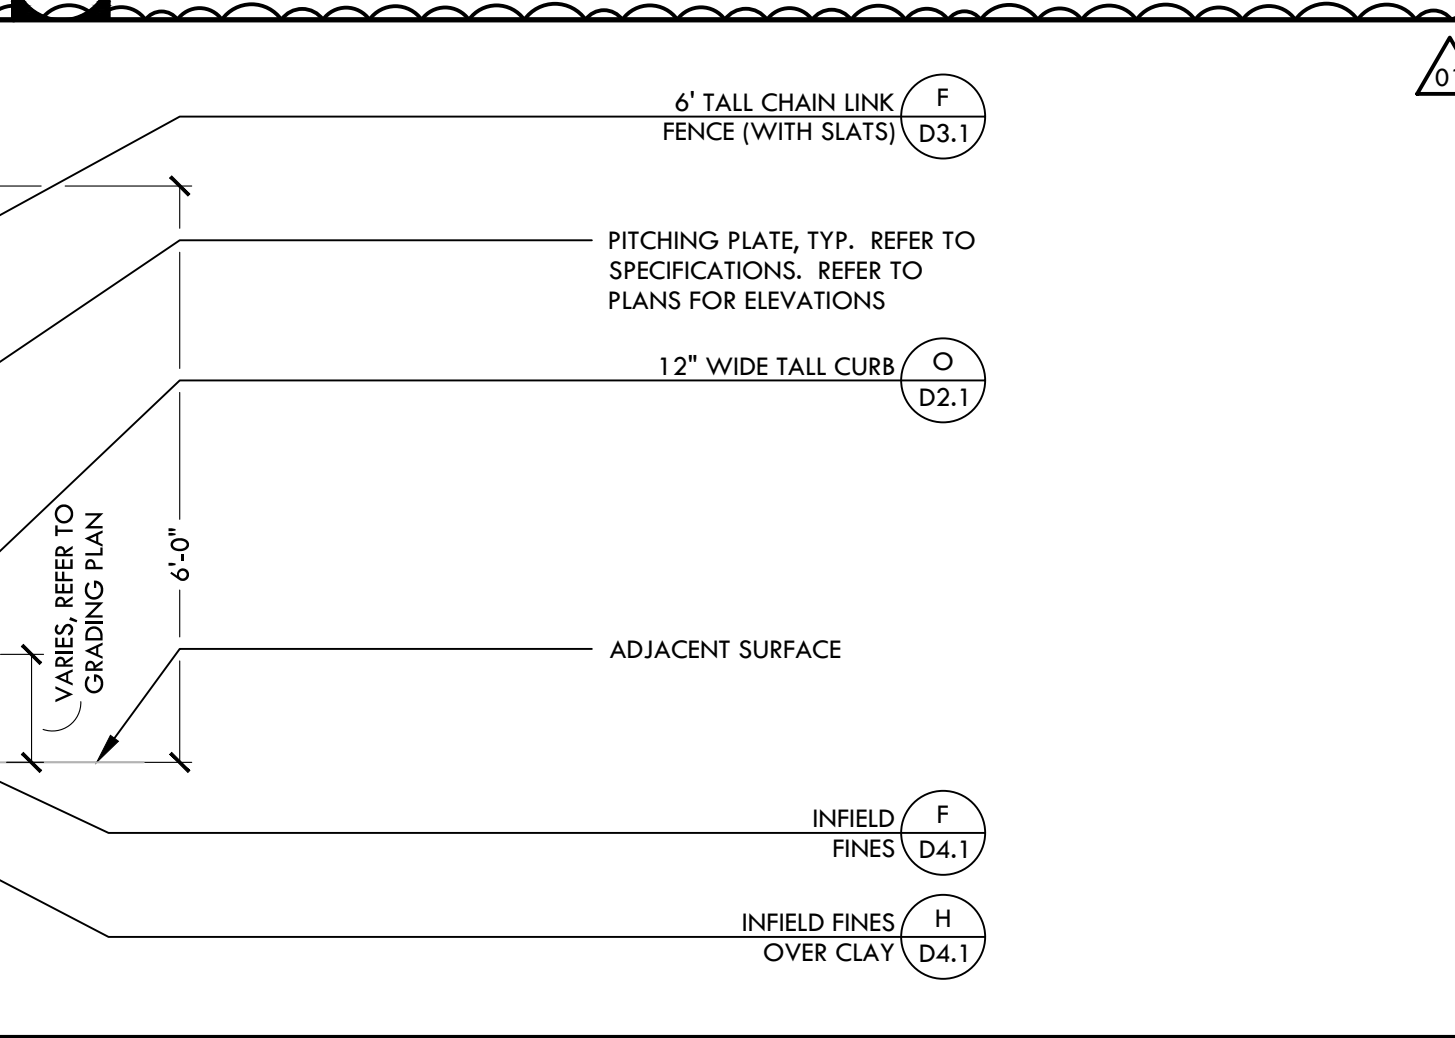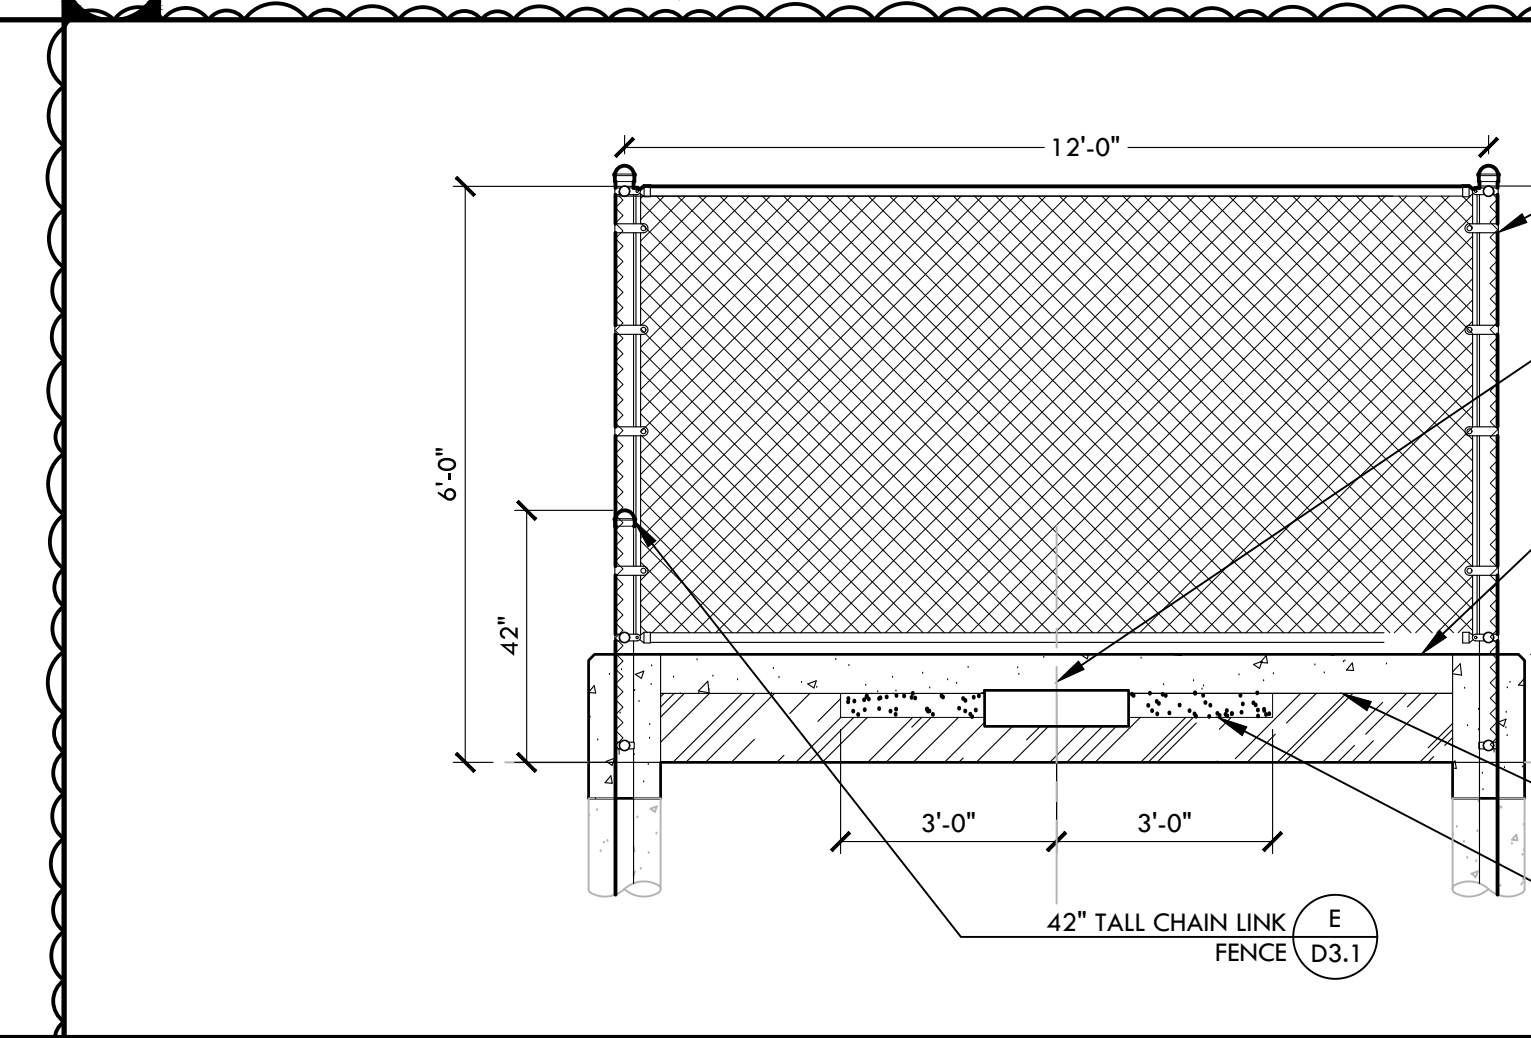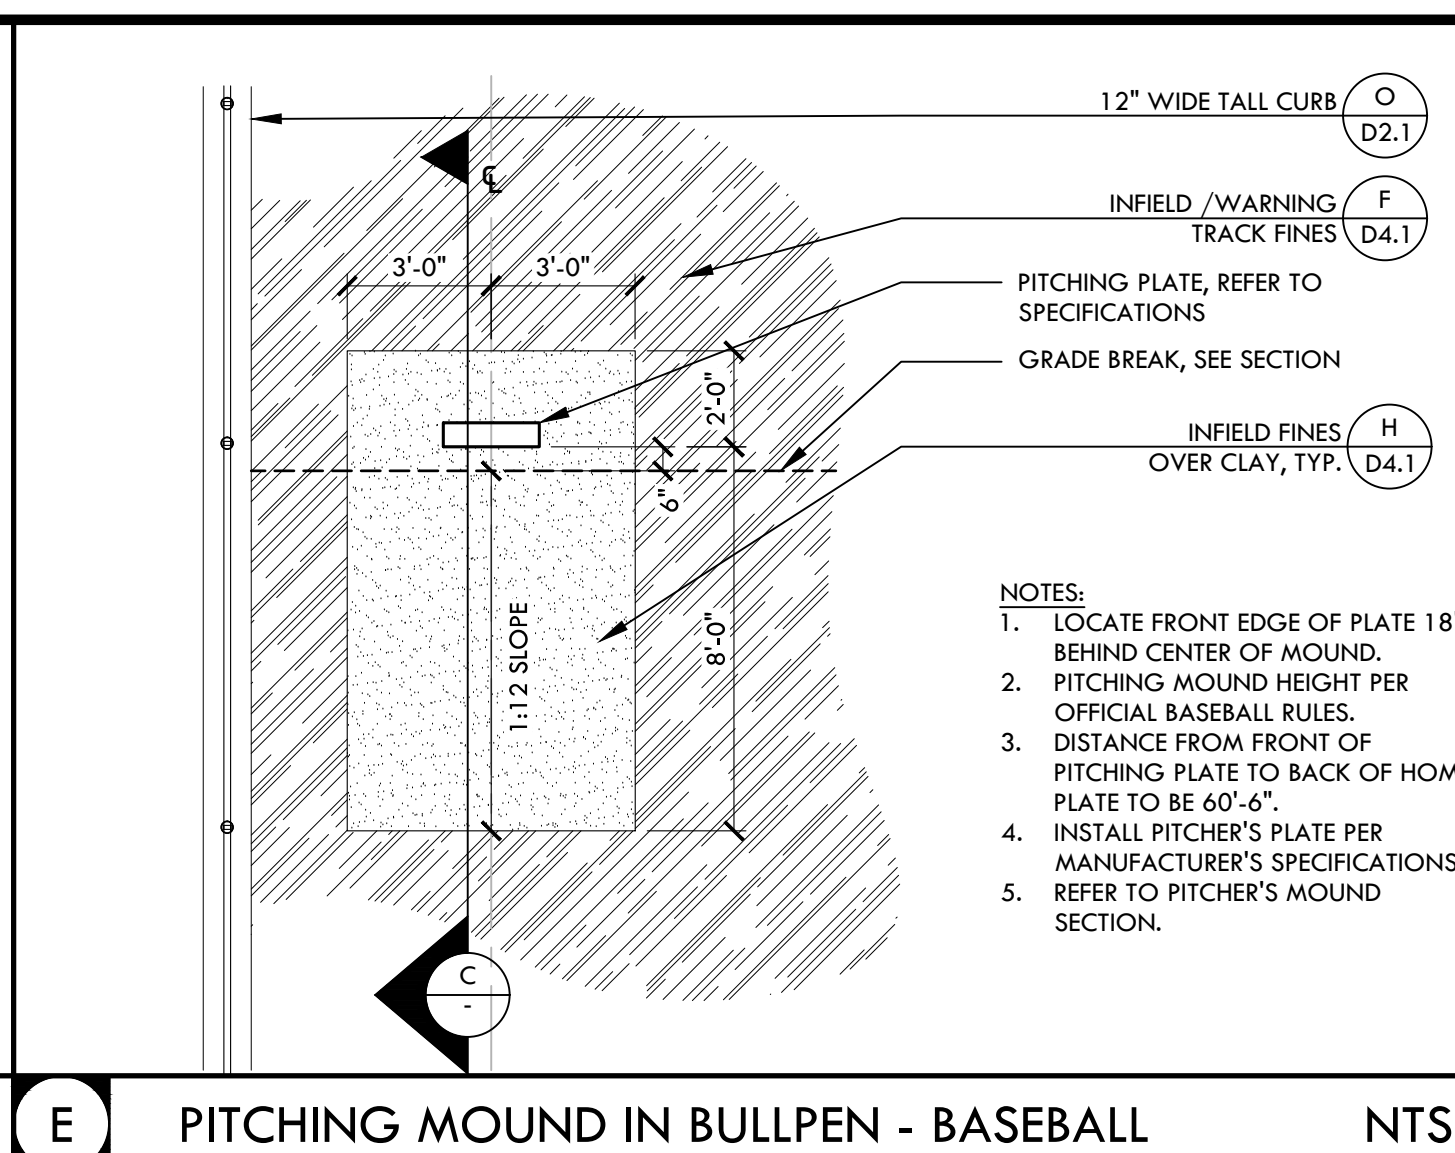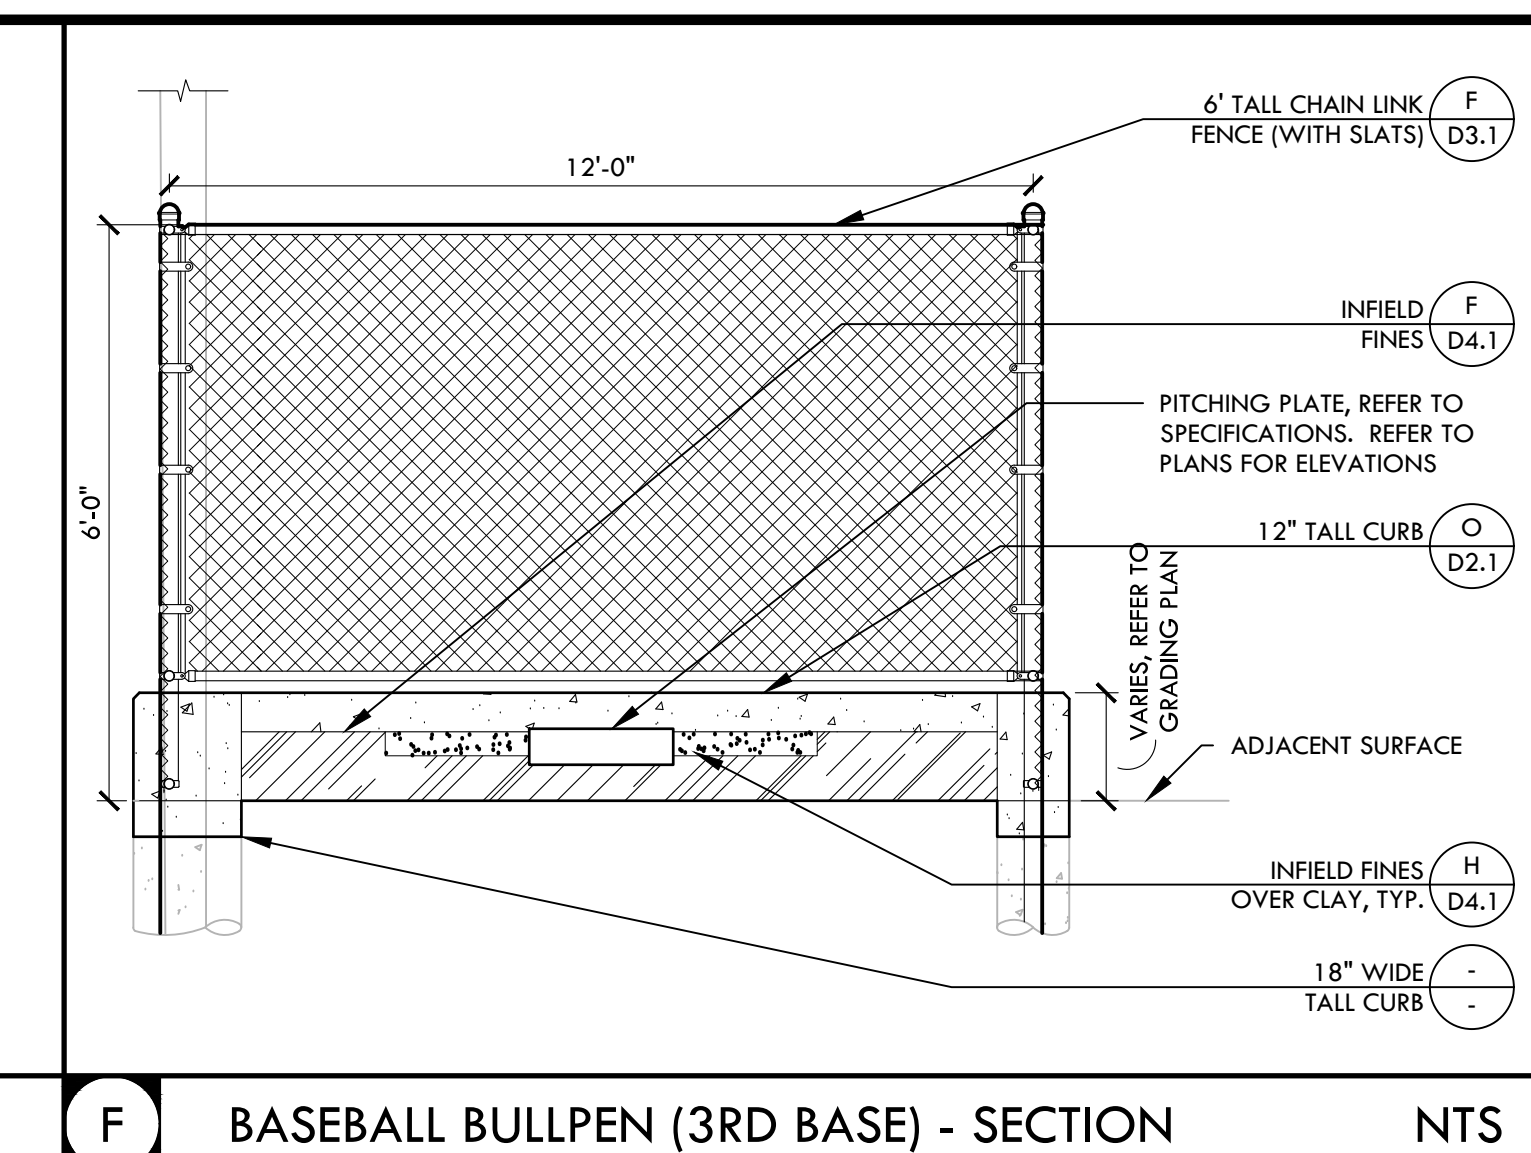SUBMITTAL	DATE
DD 50% SUBMITTAL	04/15/22
100% DSA SUBMITTAL	05/27/22
DSA BACK CHECK	08/11/22
DSA ADDENDUM SUBMITTAL	09/16/22

NO.	REVISIONS	DATE
1	ADDENDUM	09/16/22


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DATE ISSUED	09/16/2022	SCALE	AS NOTED
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SHEET NO.
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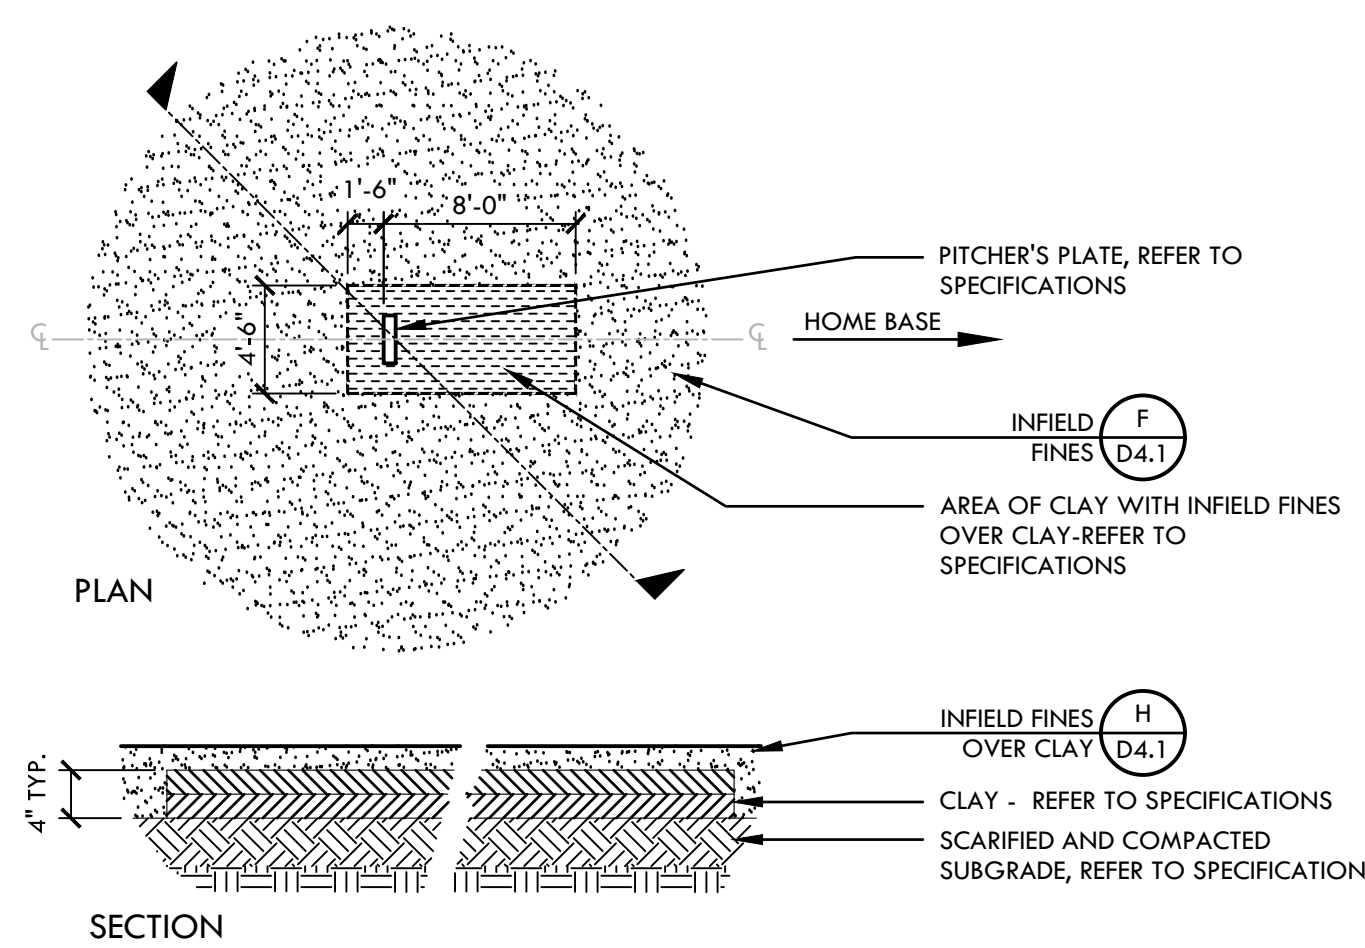
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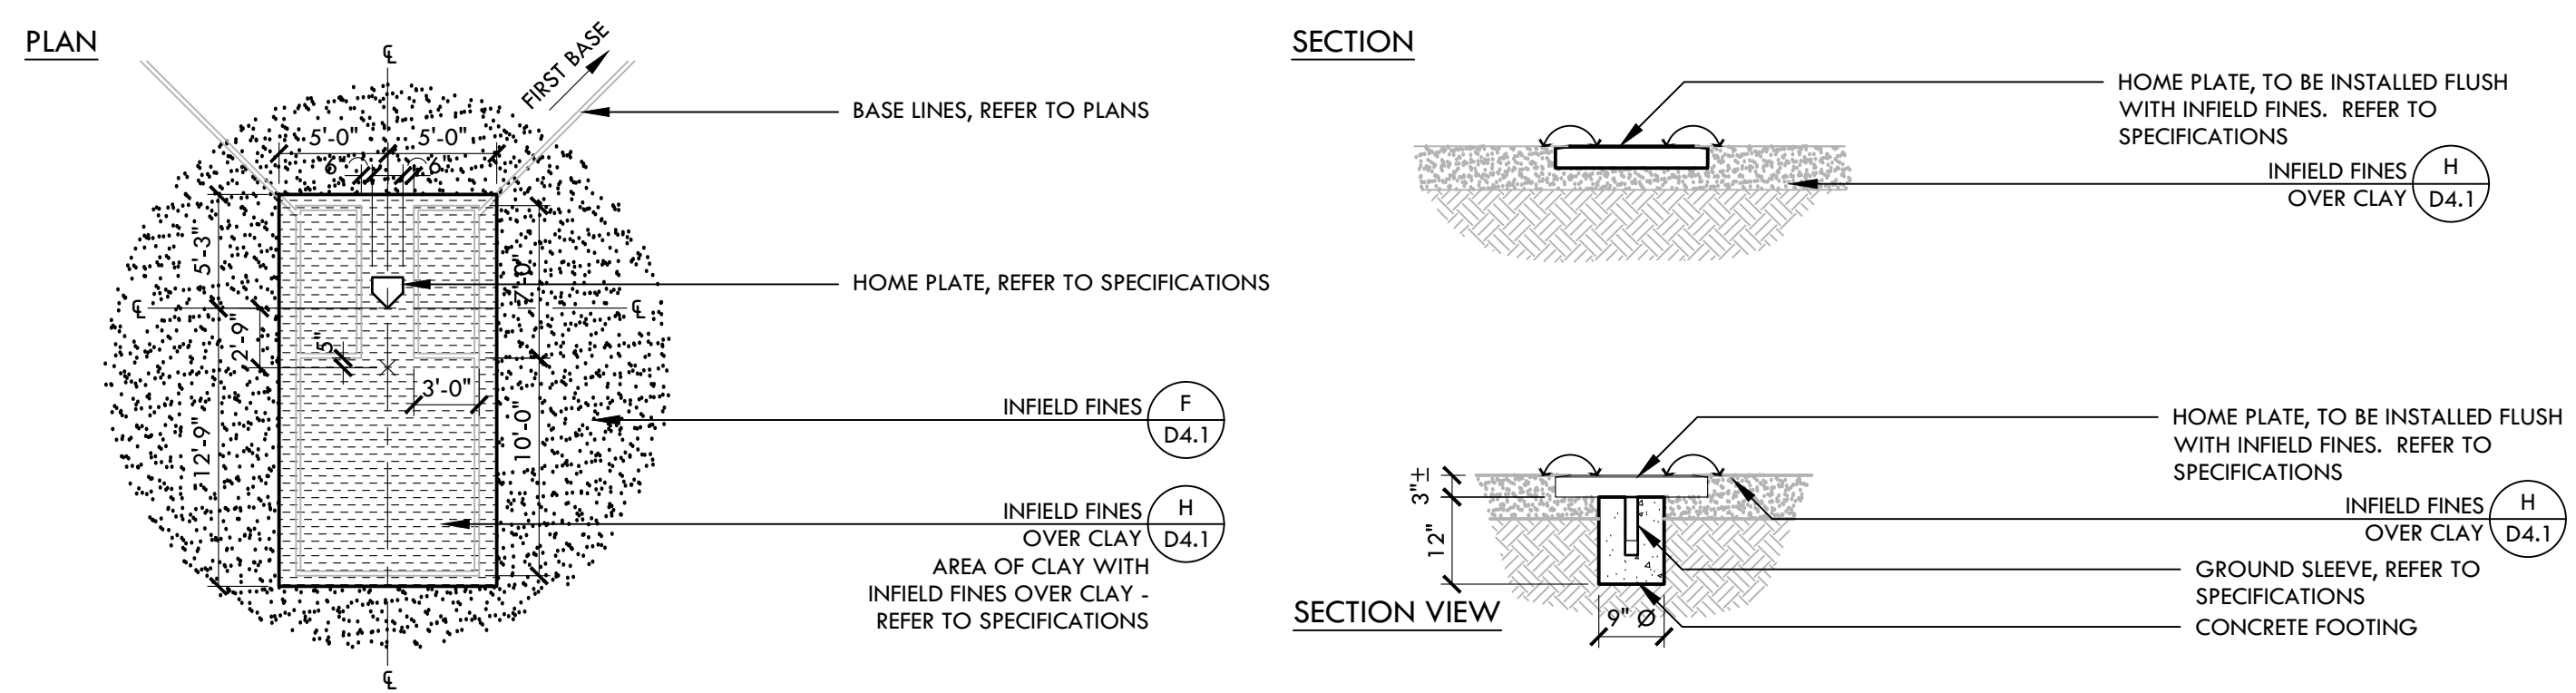


C PITCHERS AREA - SOFTBALL

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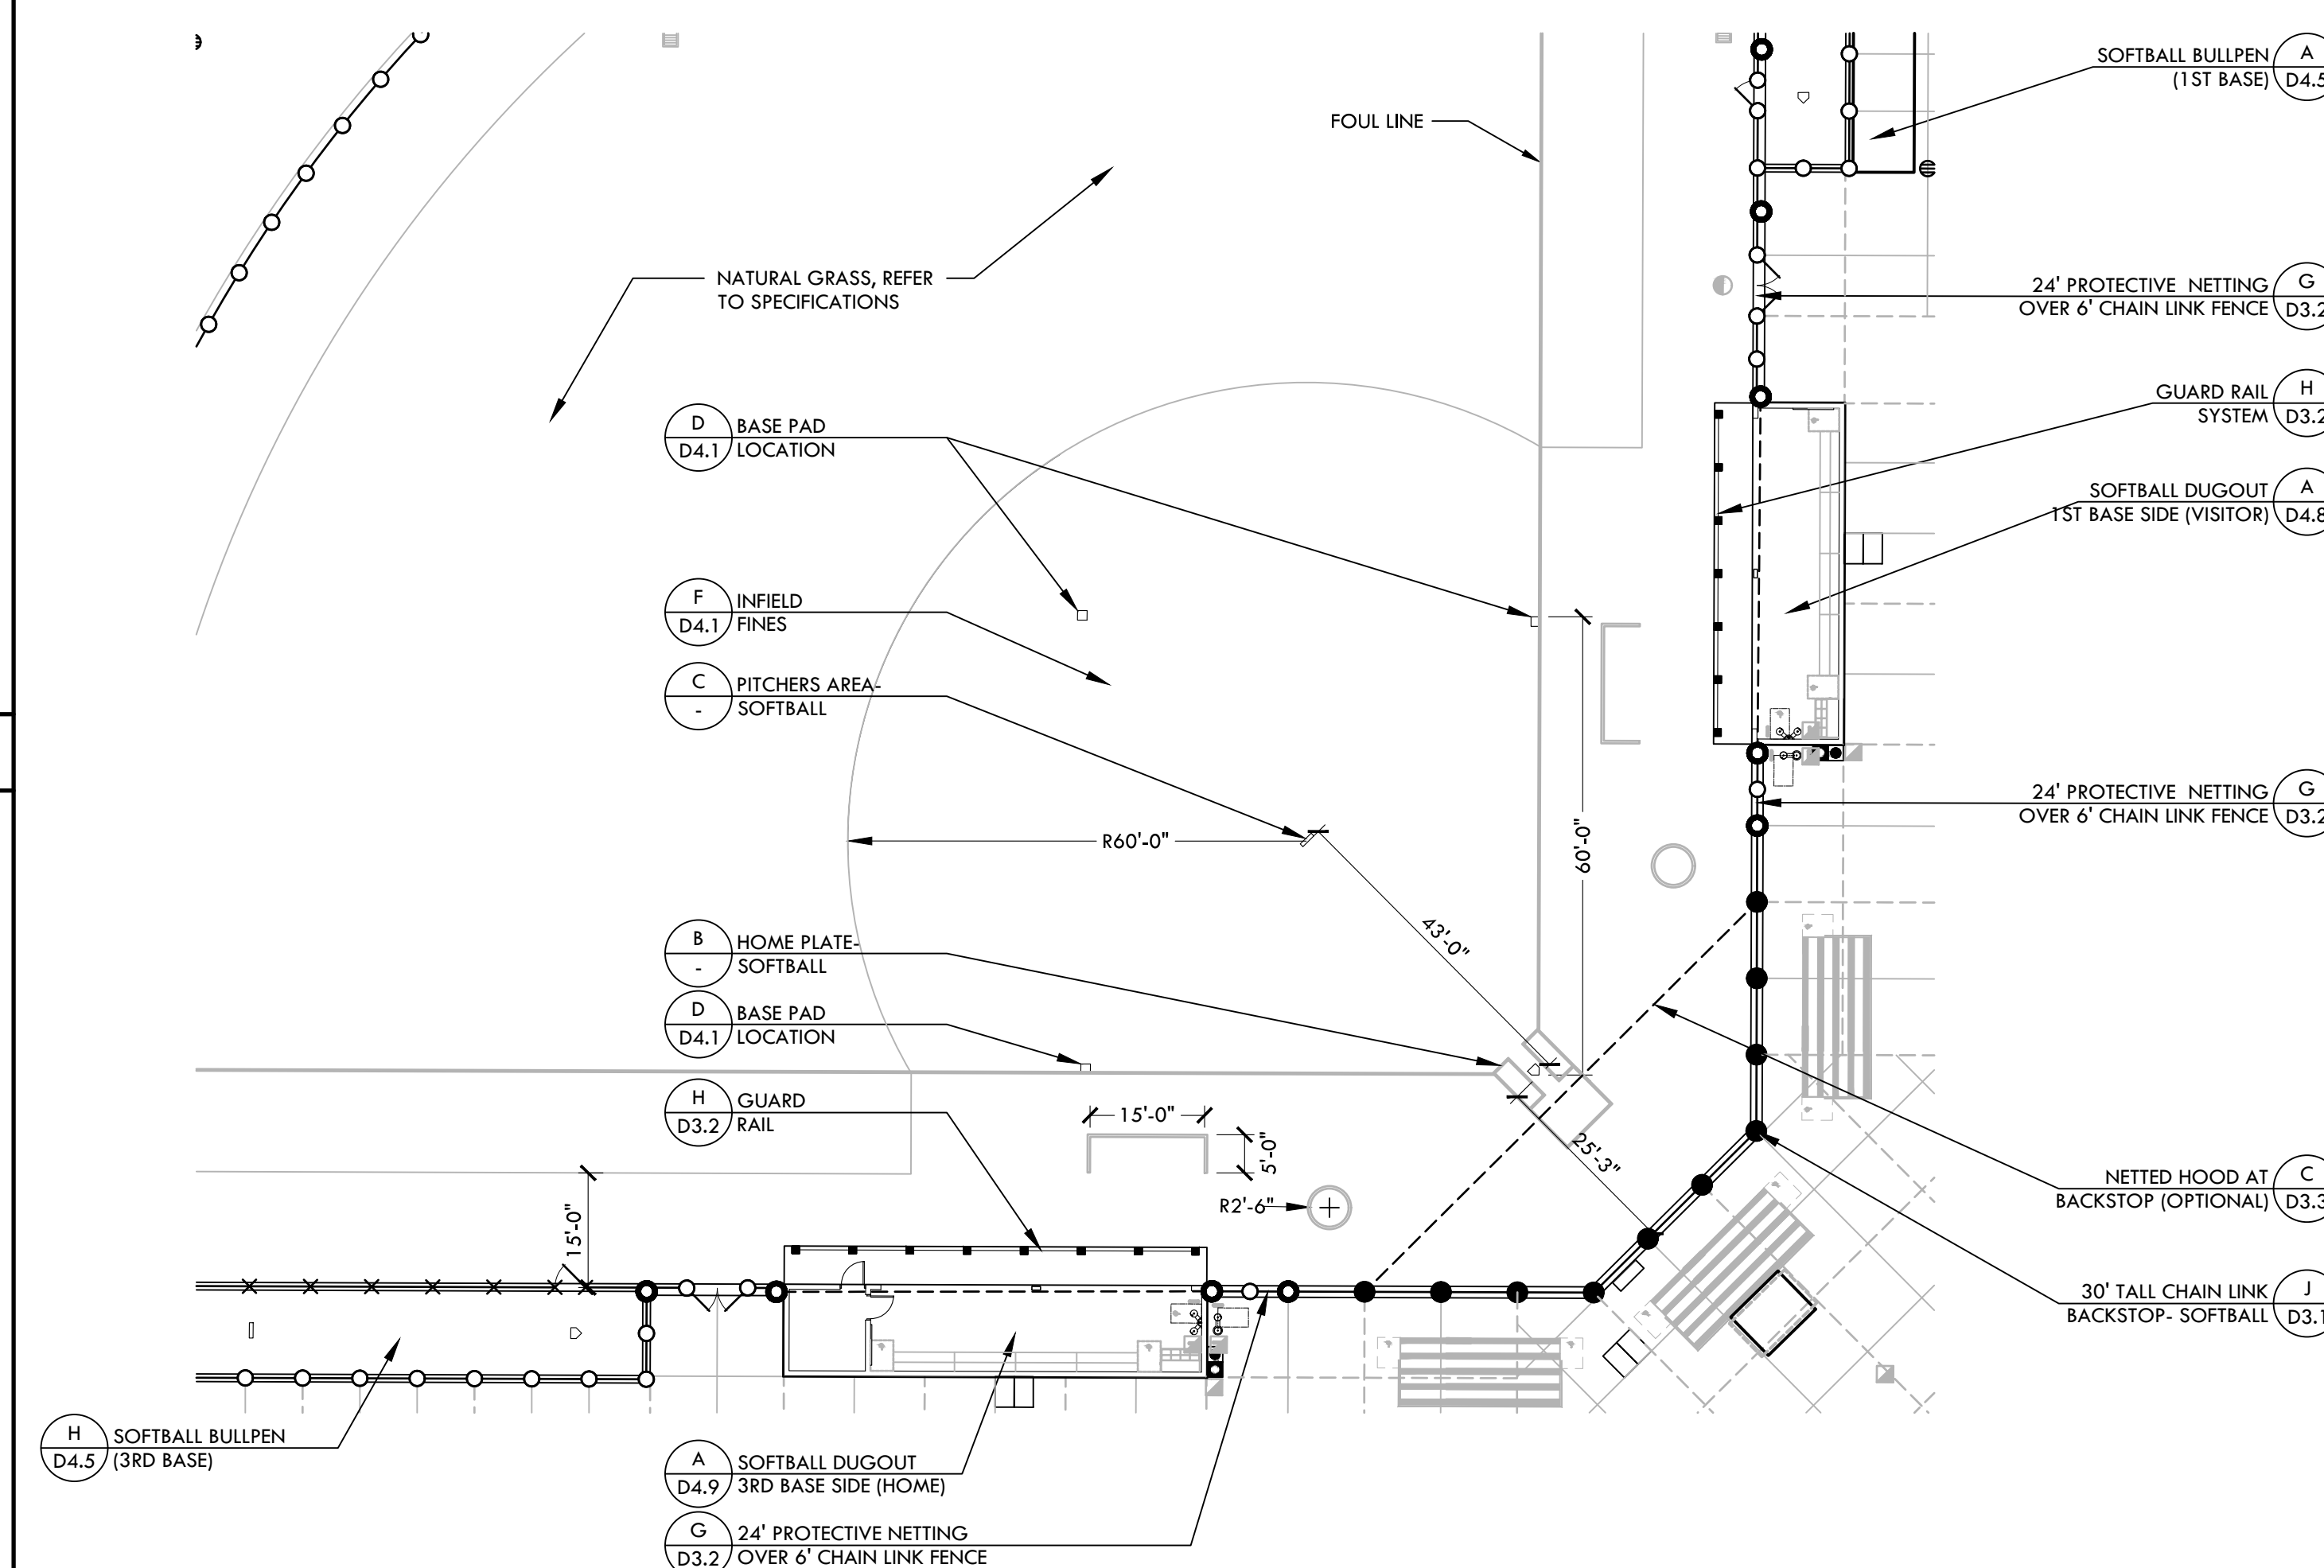


B HOME PLATE - SOFTBALL

NTS

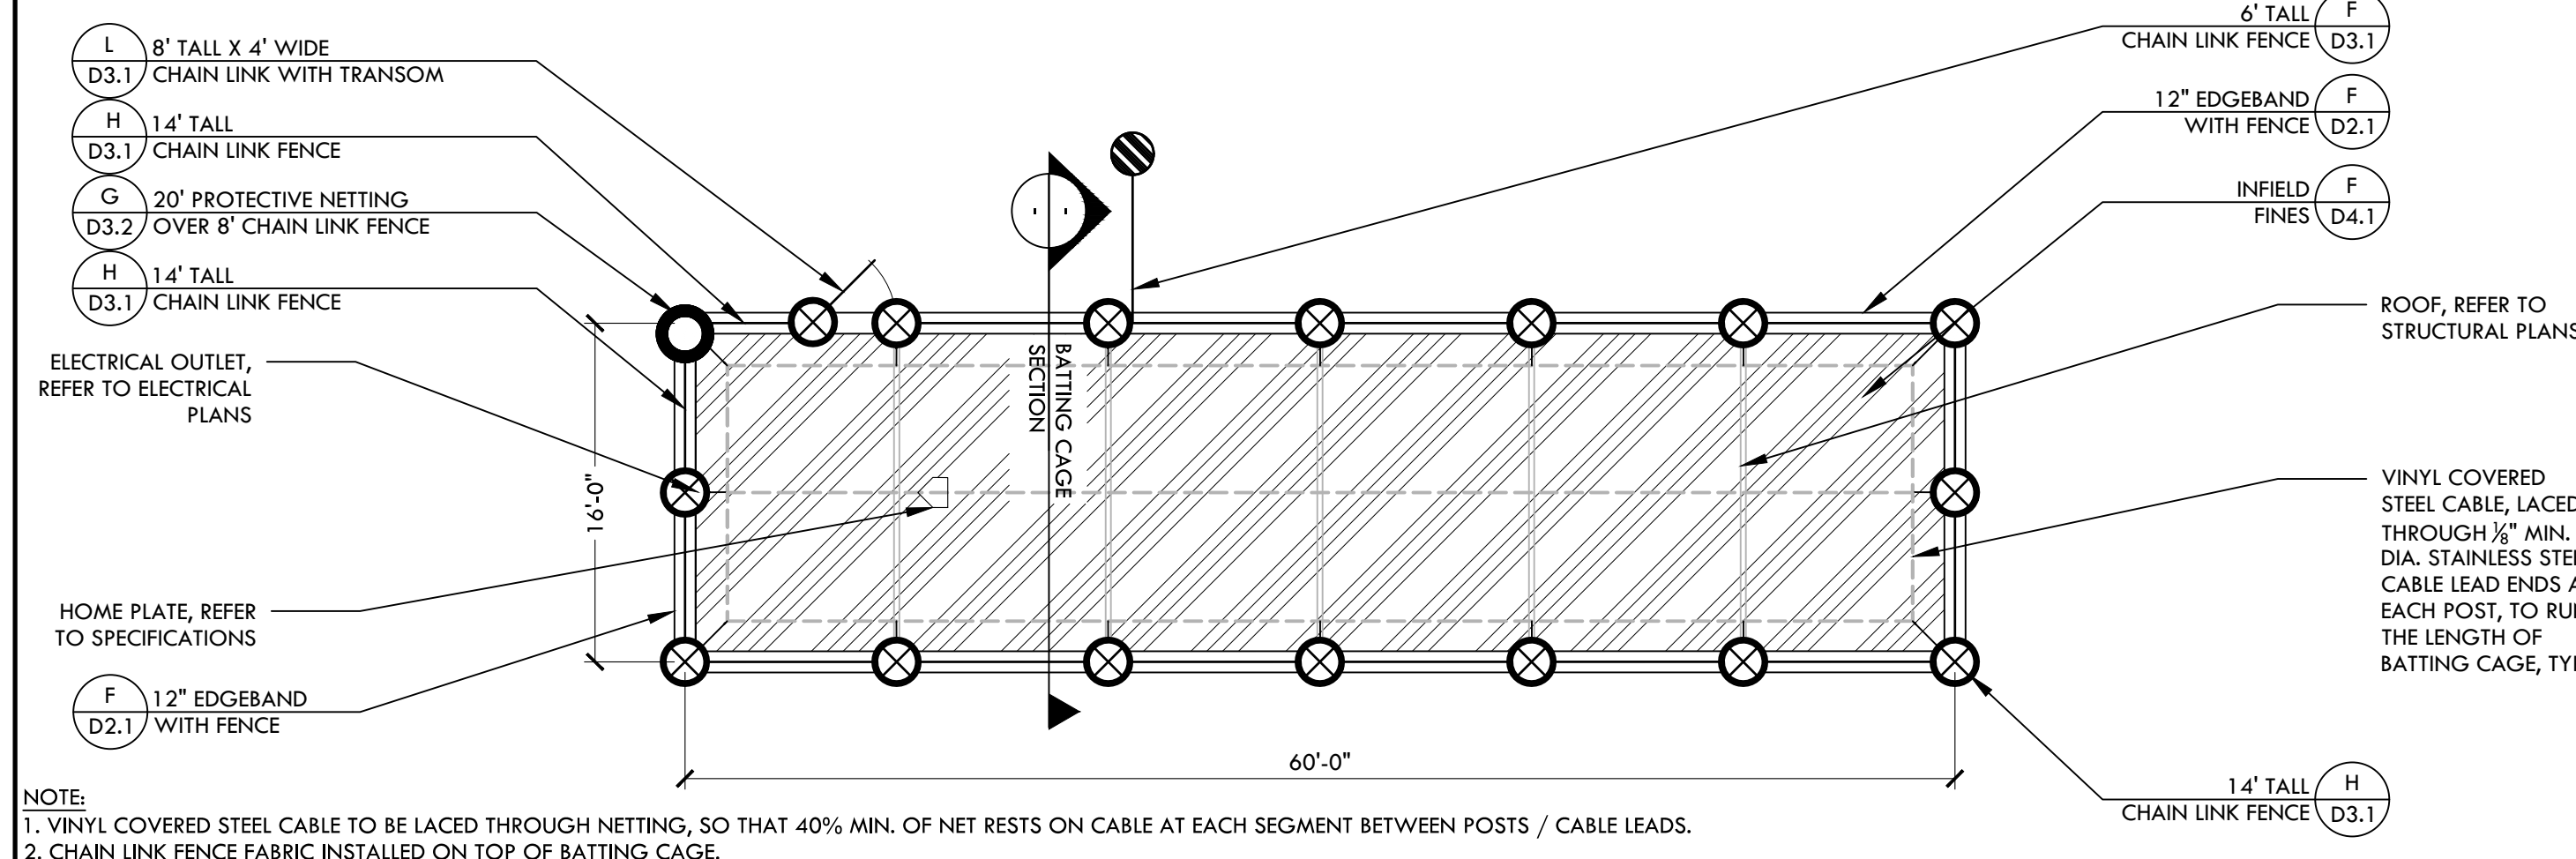NOT USED

NOT USED



A SOFTBALL INFIELD

NTS



STAMP

CONSULTANT

KEYMAP

SHEET TITLE

CONSTRUCTION DETAILS - SOFTBALL

PROJECT NAME
**HIRAM JOHNSON
 HIGH SCHOOL
 GOLF PRACTICE FACILITY,
 VARSITY BASEBALL AND
 SOFTBALL FIELDS**

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**6879 14TH AVENUE
 SACRAMENTO, CA 95820**

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1	ADDENDUM	09/16/22

DRAWN BY	CHECKED BY
VDI	MB/CS
DATE ISSUED	SCALE
09/16/2022	AS NOTED

PROJ. NO. 2203200
 SHEET NO. **D4.4**

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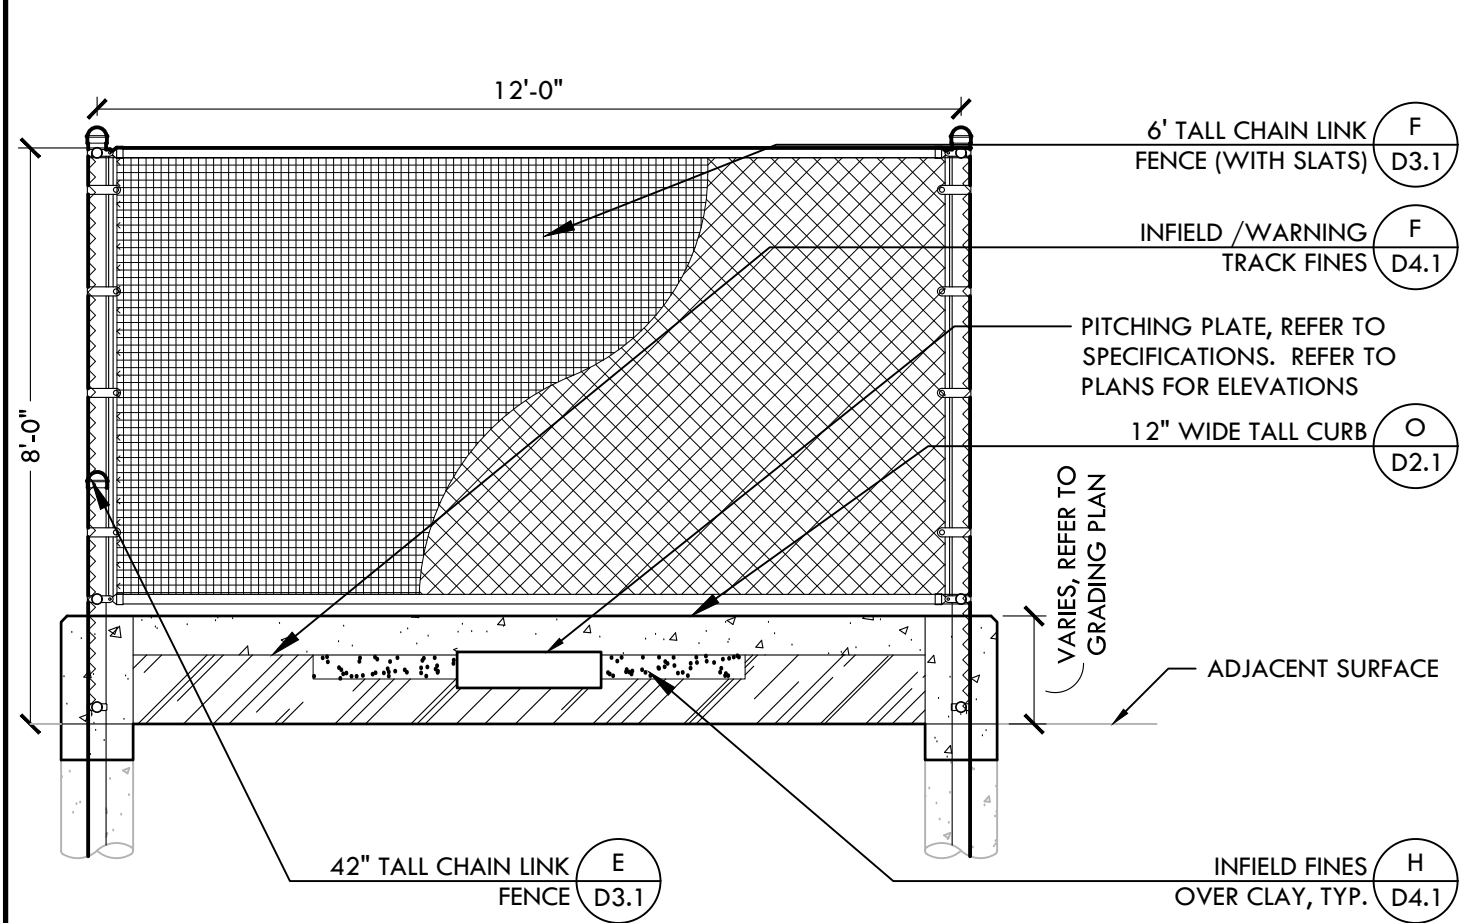
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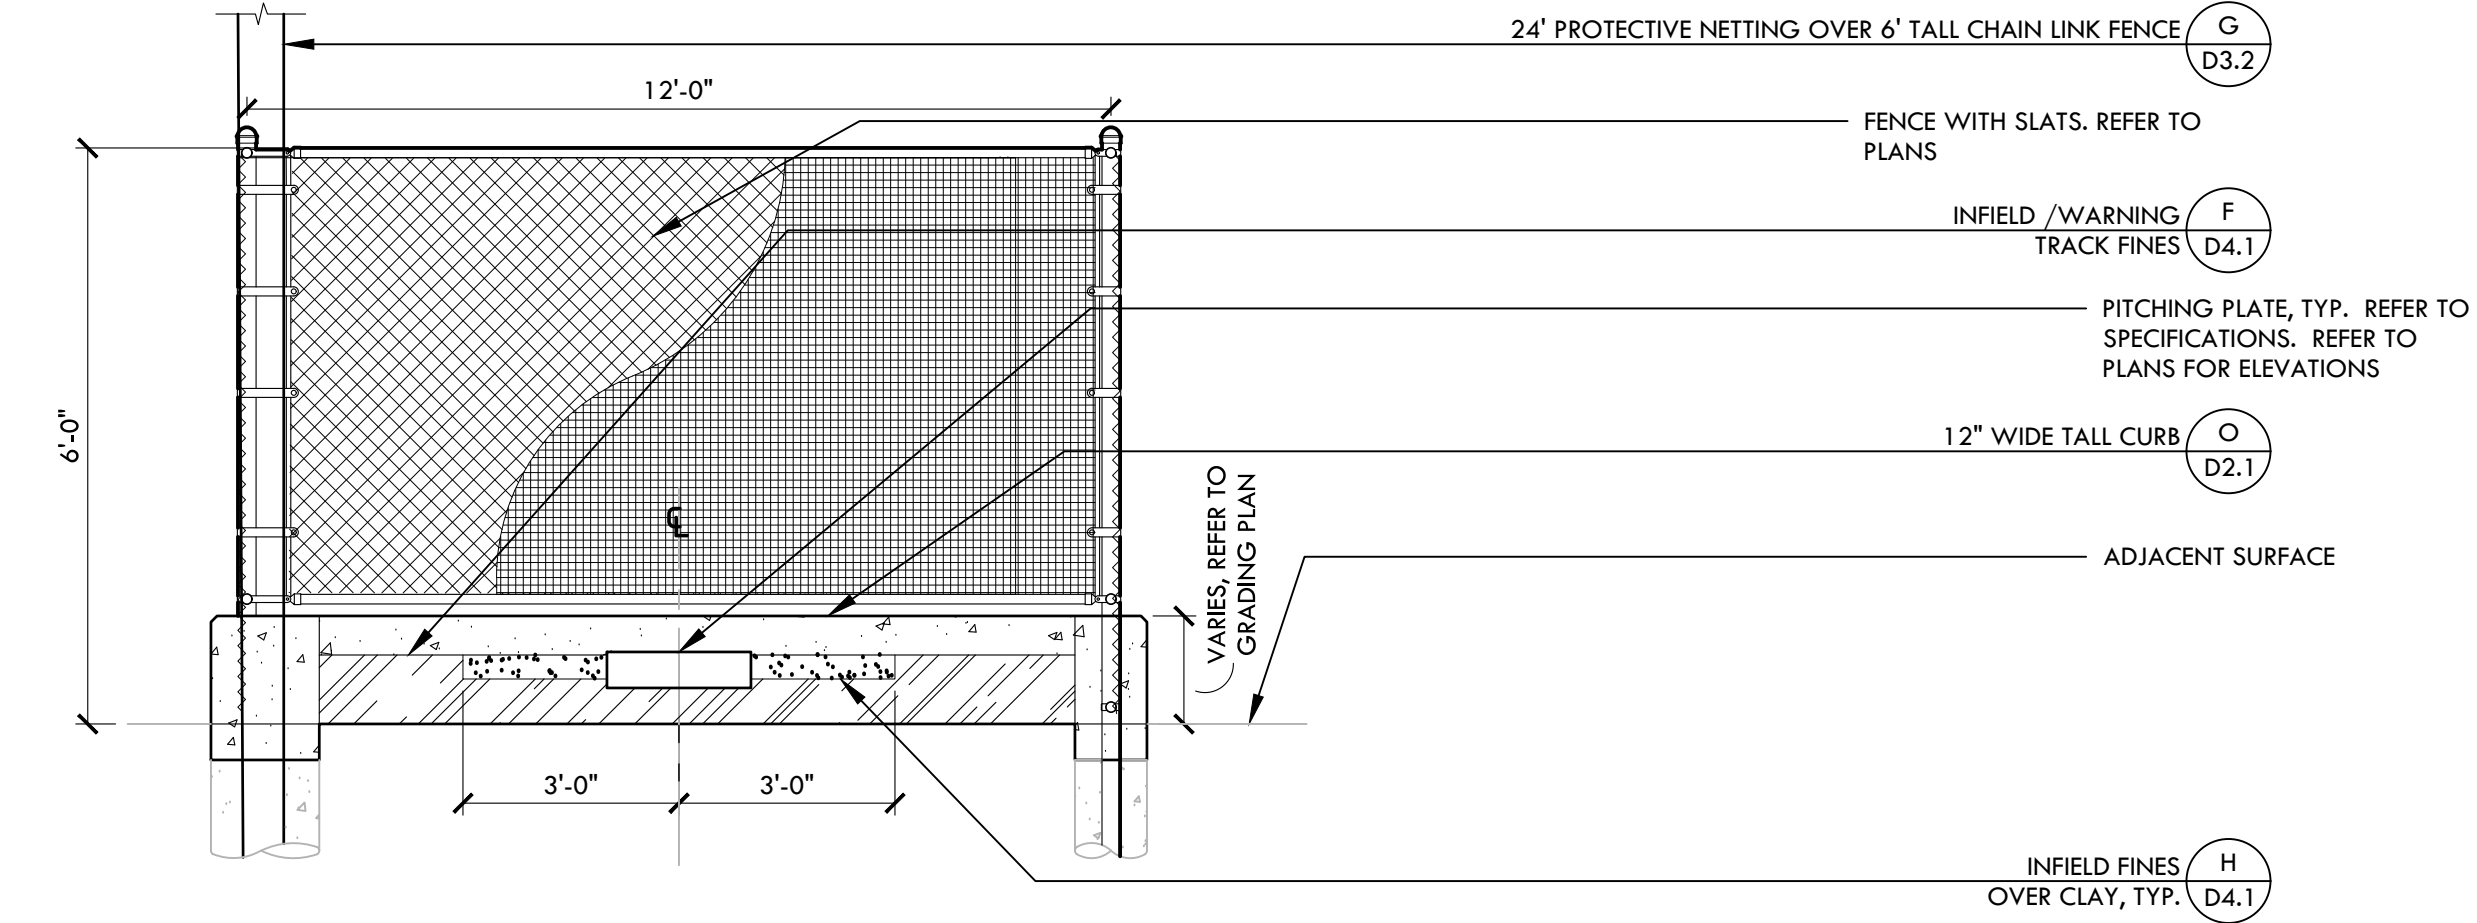
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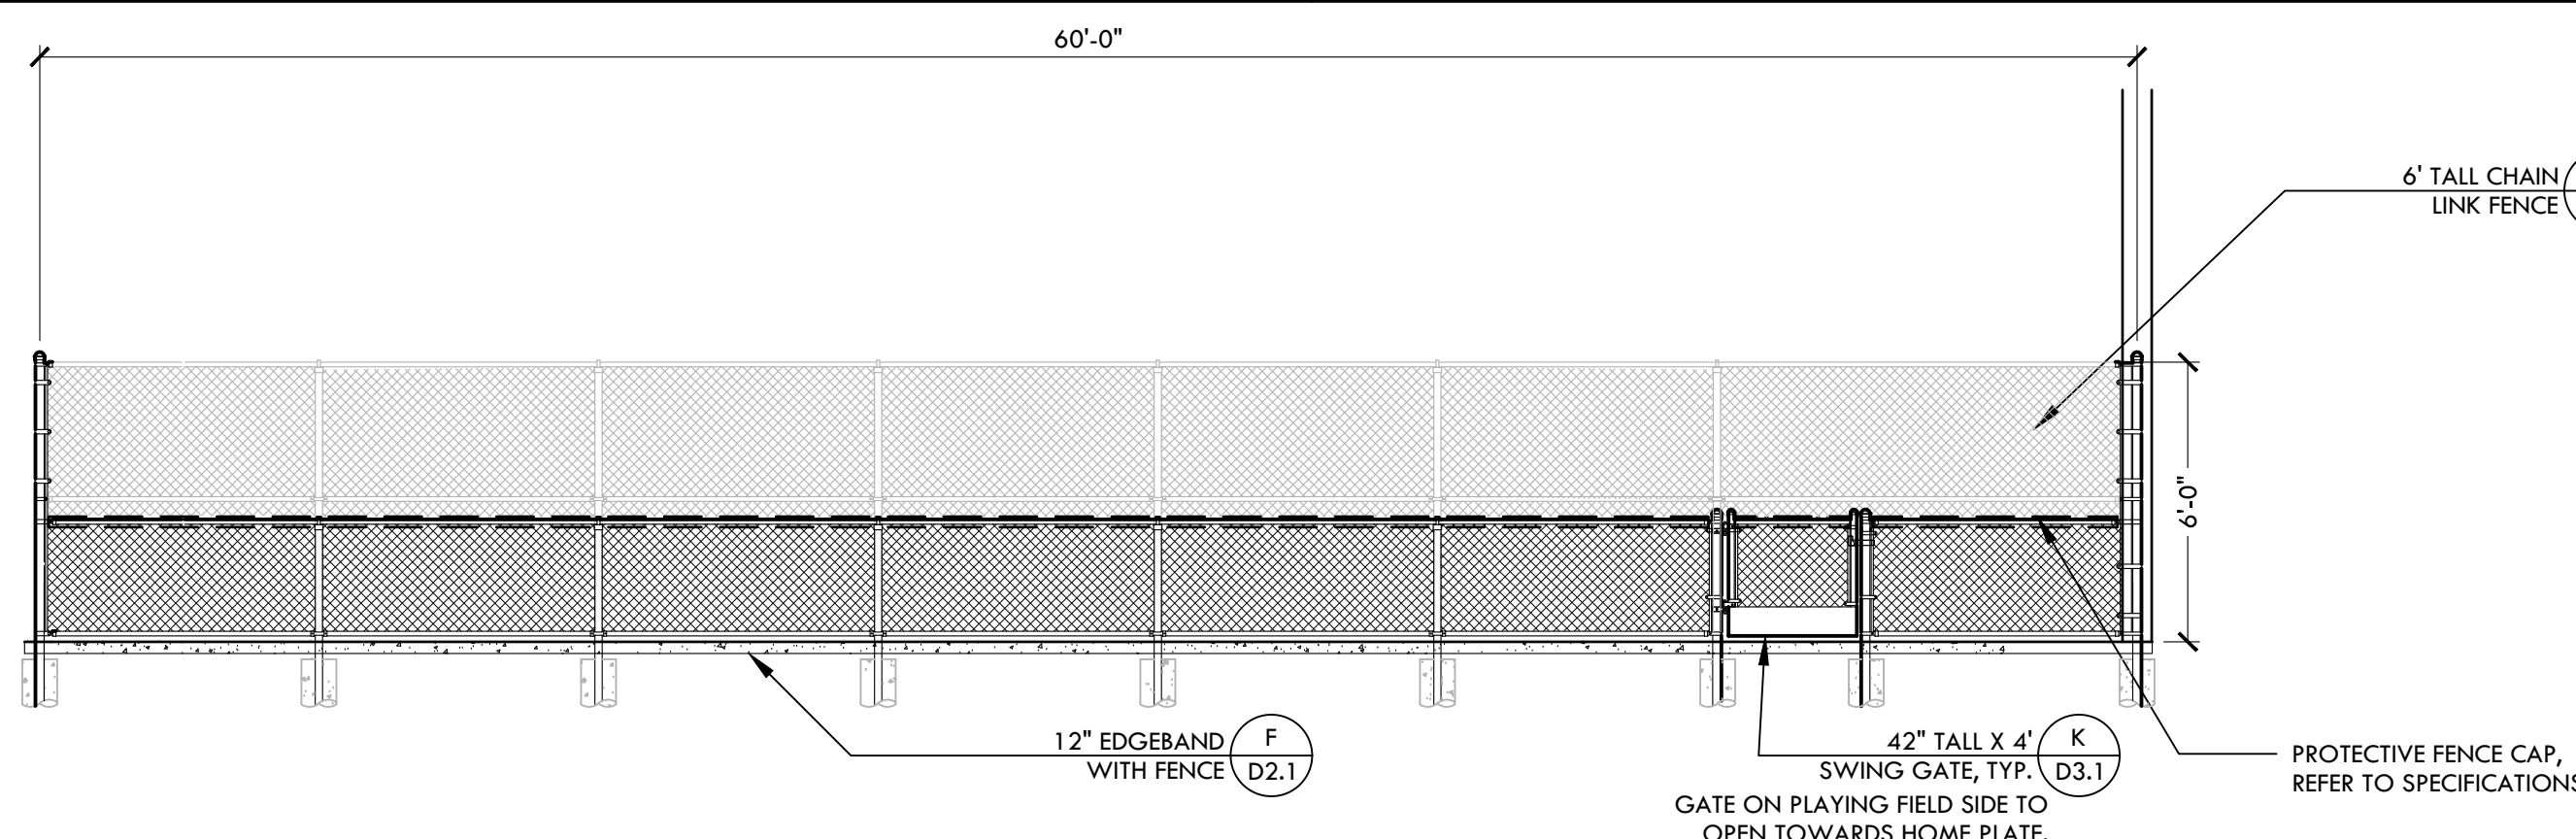
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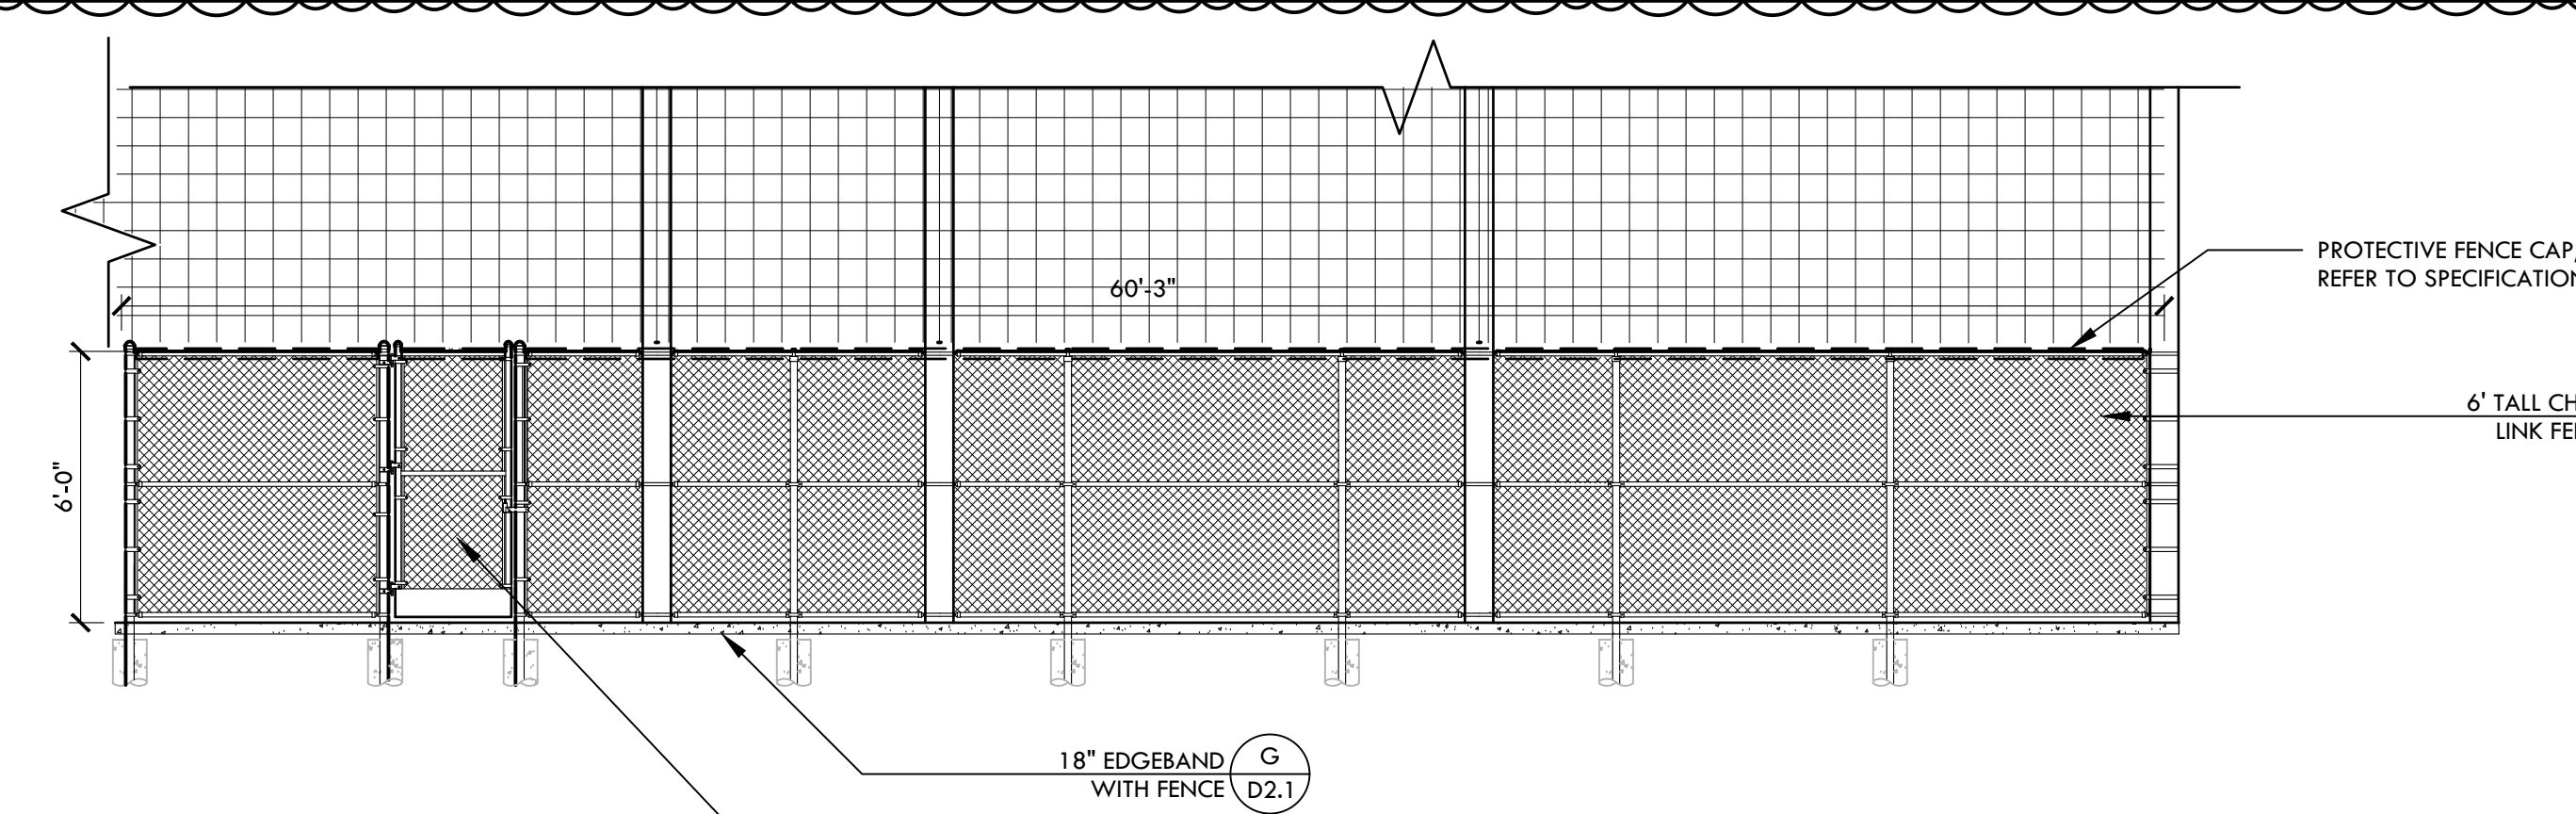
C SOFTBALL BULLPEN (1ST BASE) - SECTION

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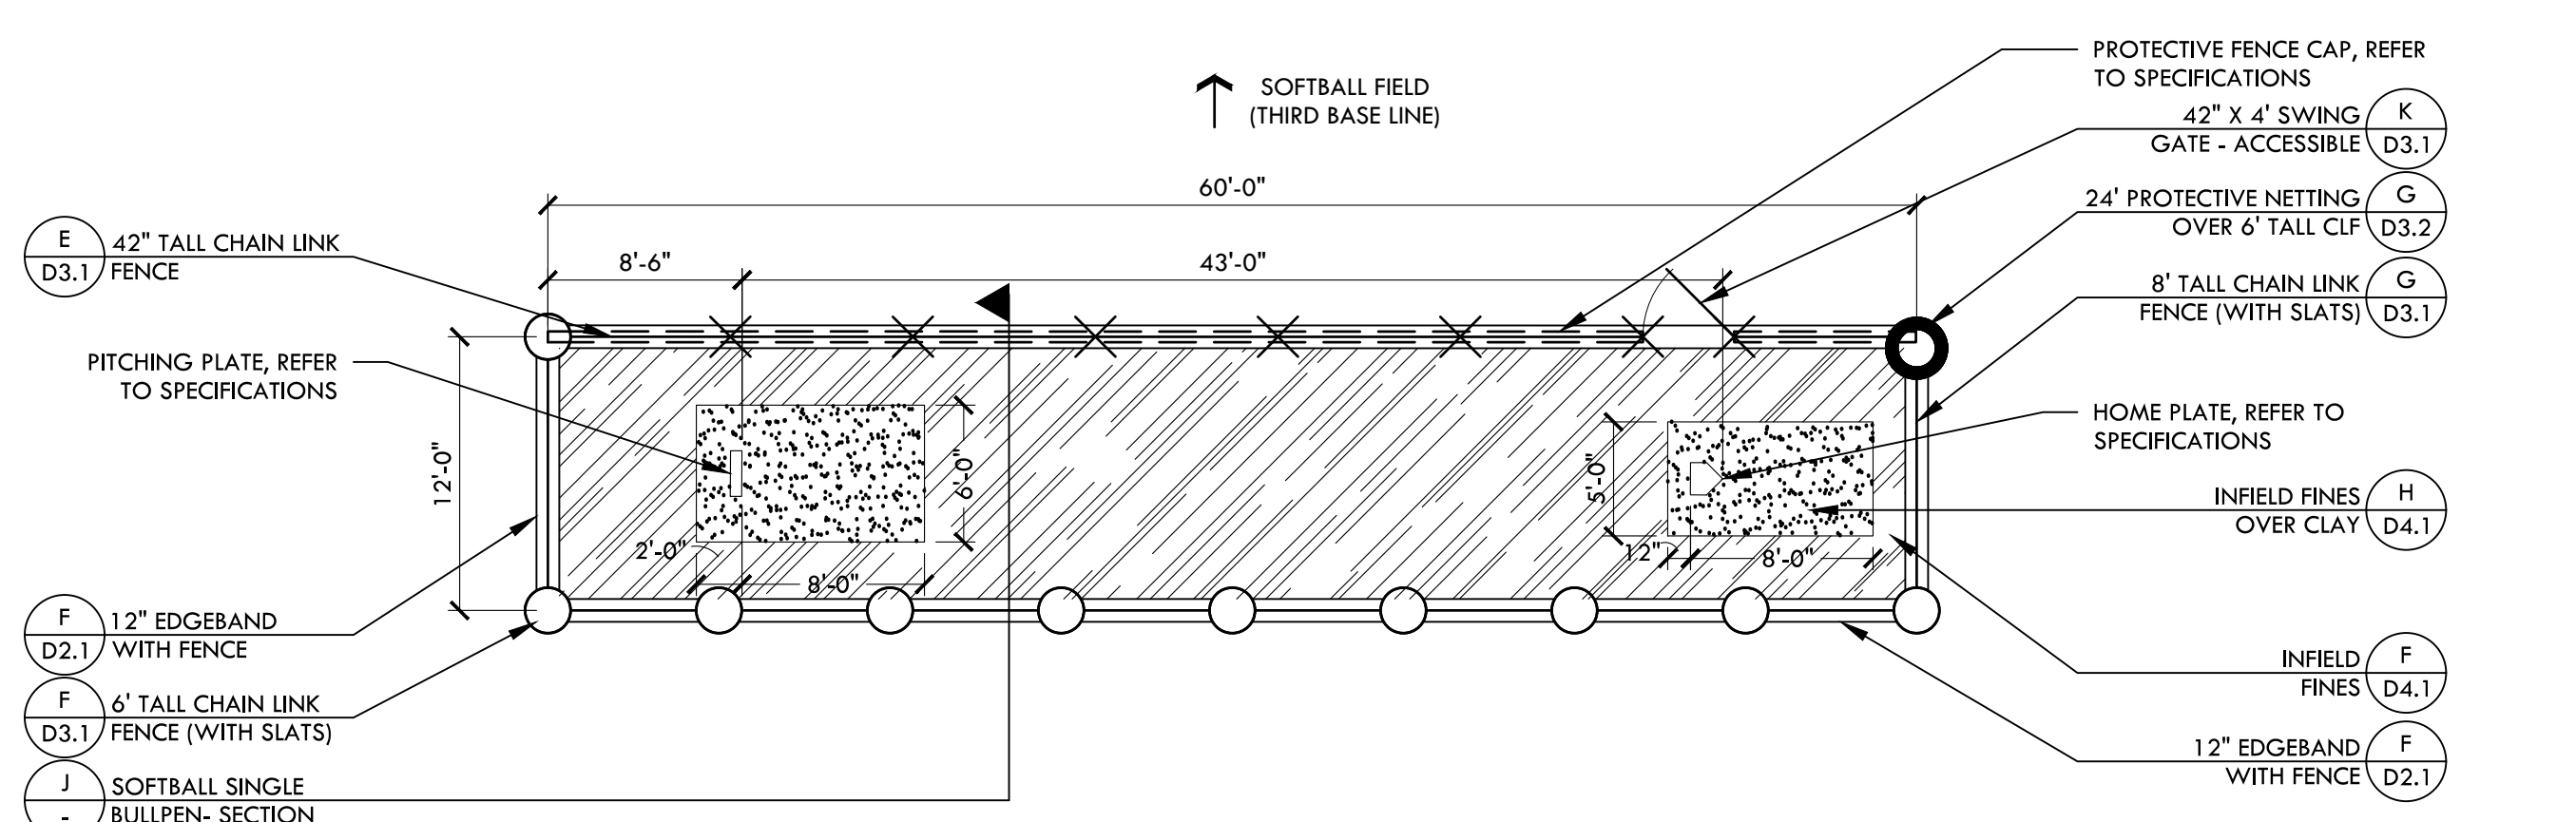
I SOFTBALL BULLPEN (3RD BASE) - ELEVATION

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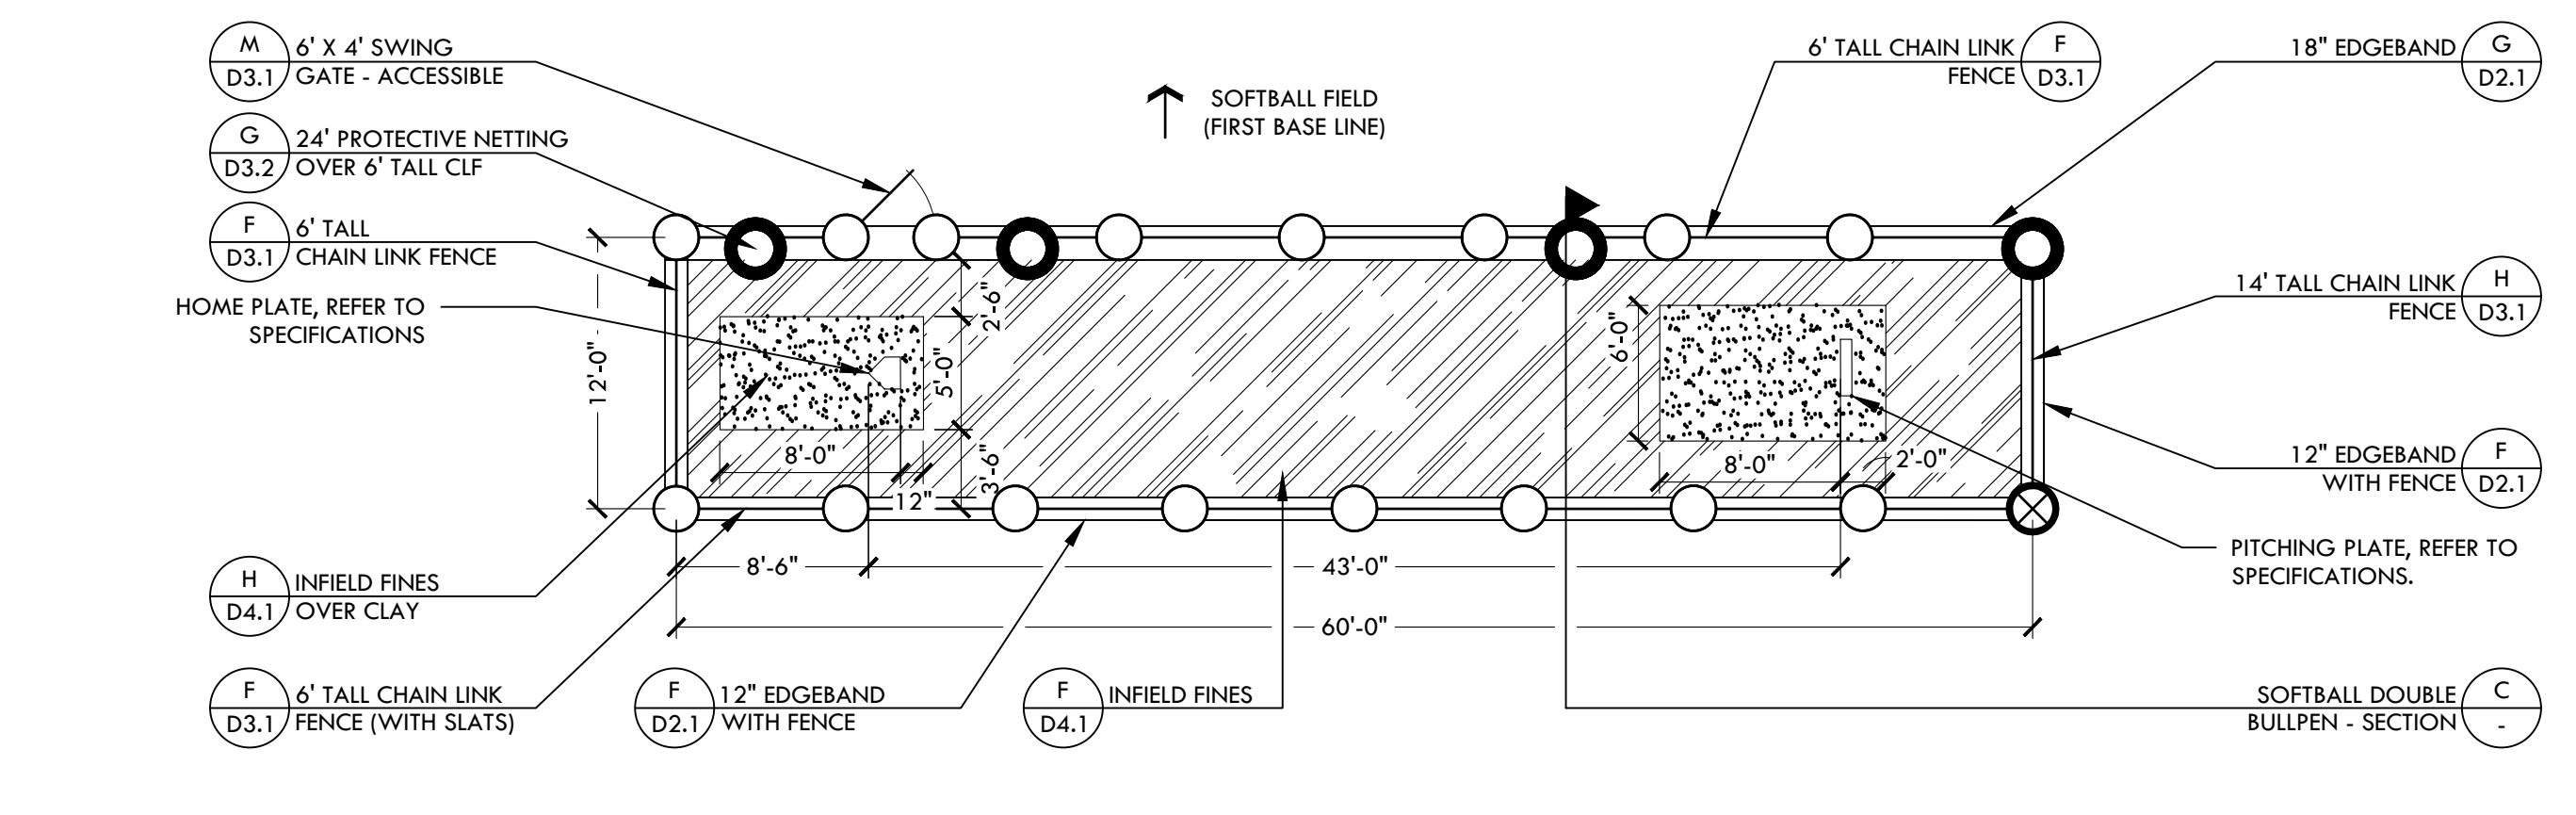
B SOFTBALL BULLPEN (1ST BASE) - ELEVATION

NTS




H SOFTBALL BULLPEN (3RD BASE) - PLAN

NTS



A SOFTBALL BULLPEN (1ST BASE) - PLAN

NTS

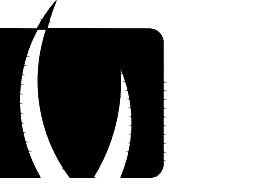

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CONSULTANT

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CONSTRUCTION DETAILS - SOFTBALL

PROJECT NAME

HIRAM JOHNSON
 HIGH SCHOOL
 GOLF PRACTICE FACILITY,
 VARSITY BASEBALL AND
 SOFTBALL FIELDS

PROJECT ADDRESS

6879 14TH AVENUE
 SACRAMENTO, CA 95820

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DSA ADDENDUM SUBMITTAL	09/16/22

NO. REVISIONS

DATE

ADDENDUM

09/16/22

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DATE ISSUED

09/16/2022

SCALE

AS NOTED

PROJ. NO.

2203200

SHEET NO.

D4.5

CONSTRUCTION DETAIL - SOFTBALL

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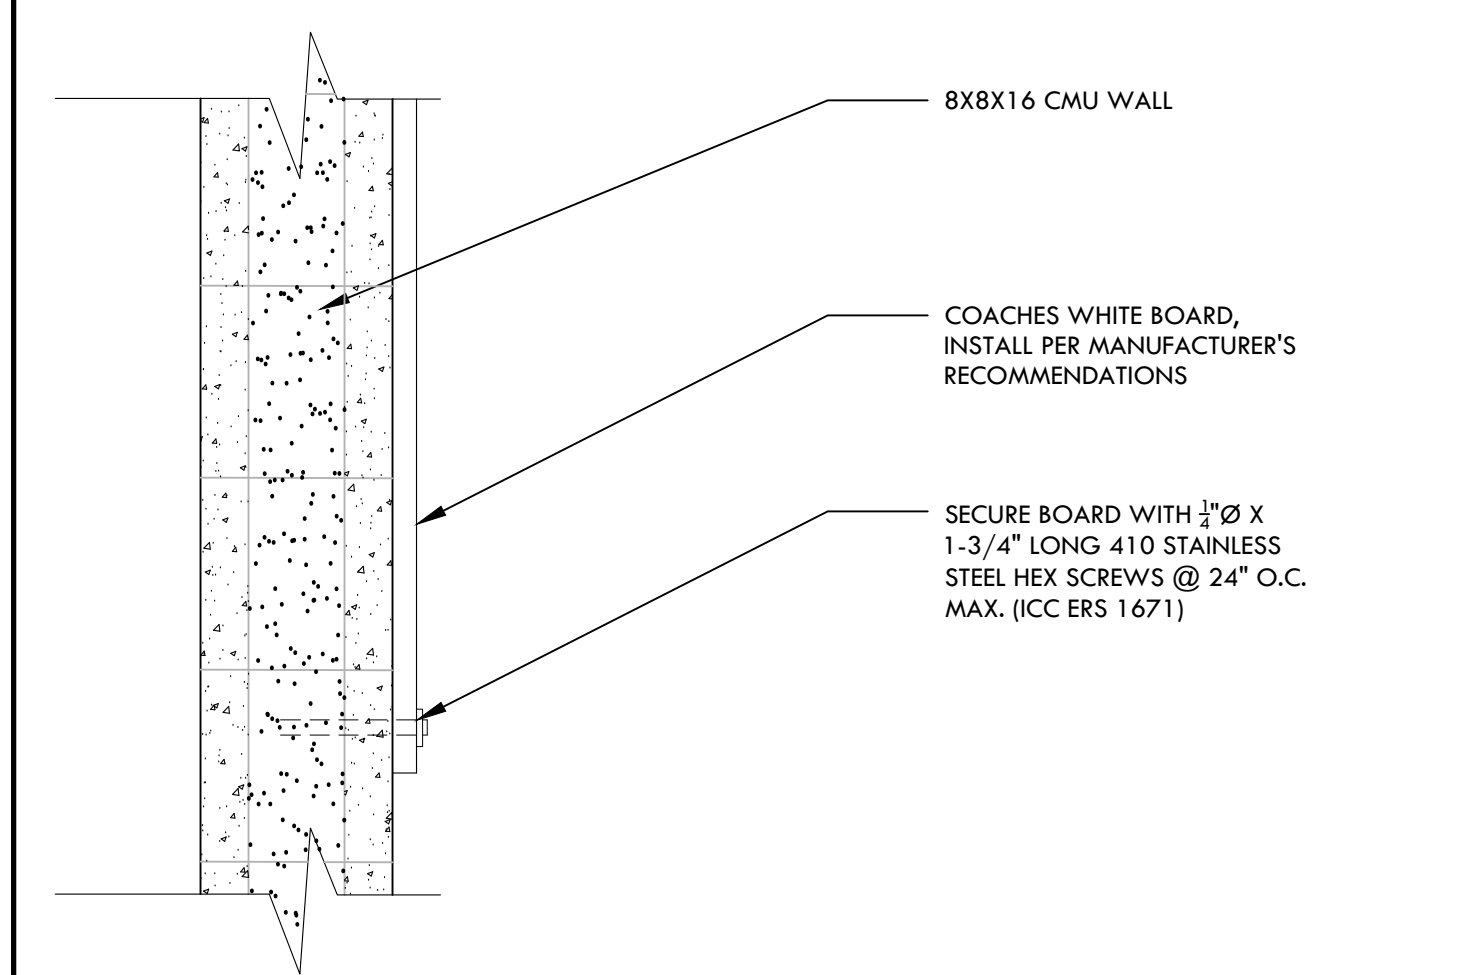
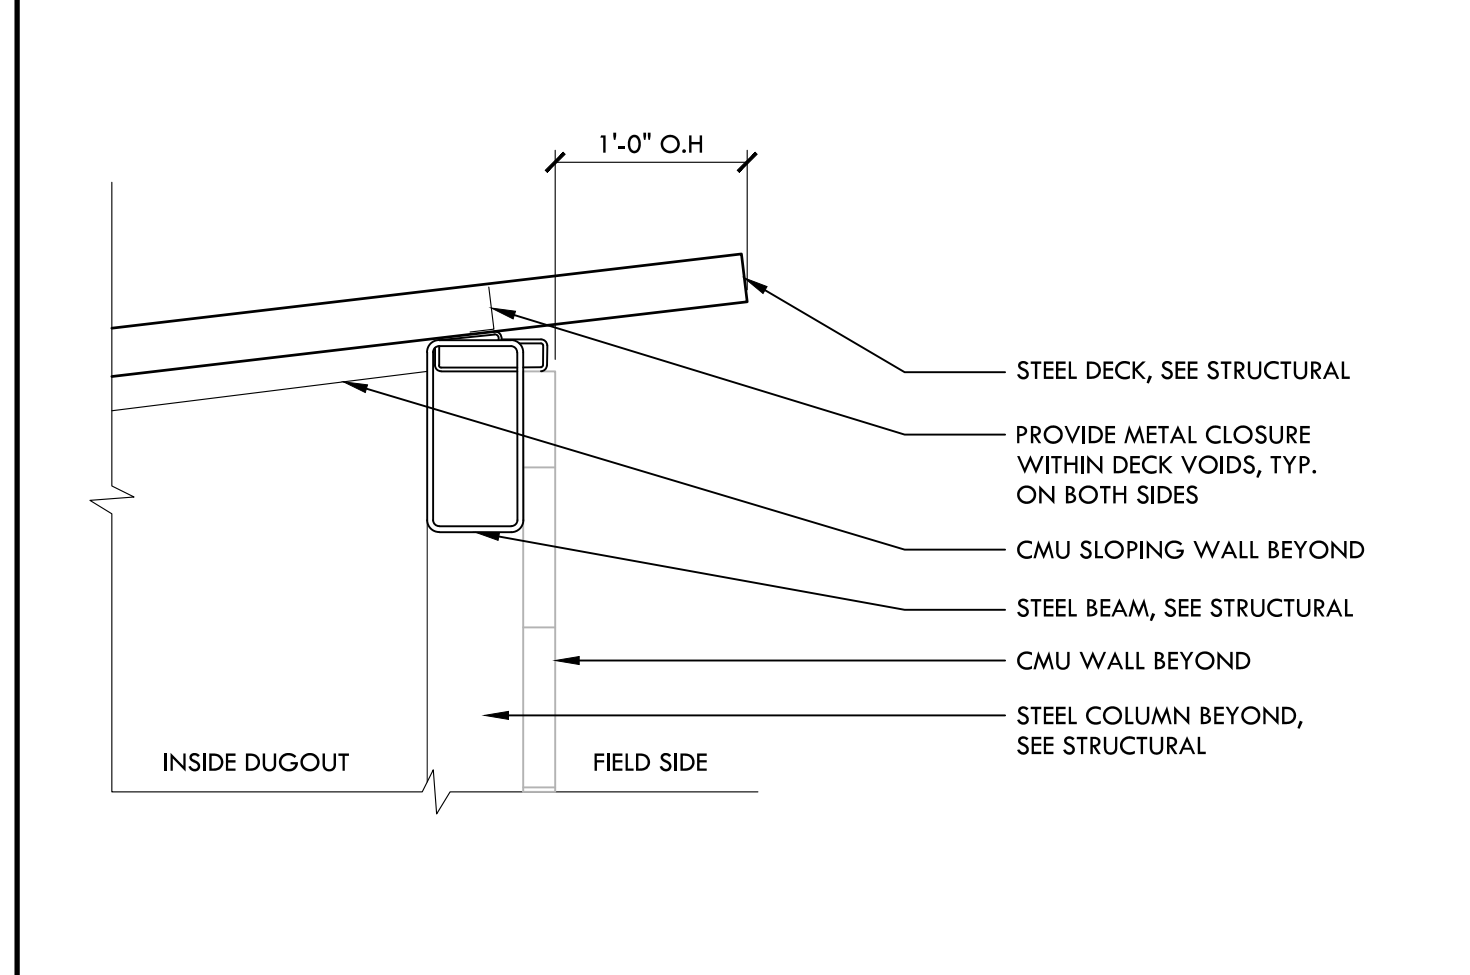
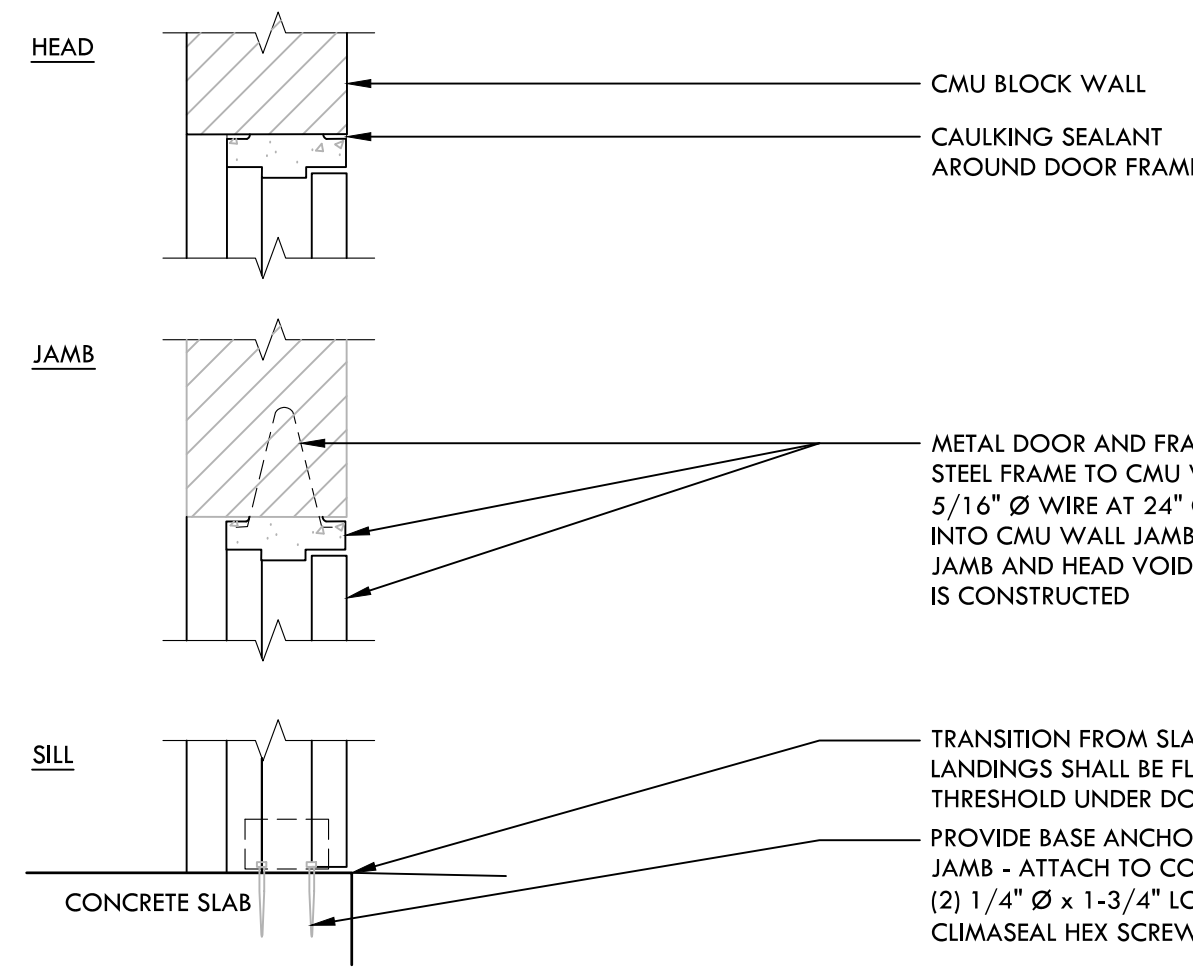
DOOR AND FRAME SCHEDULE						
DOOR NO.	WIDTH	HEIGHT	THICK.	MATERIAL	MATERIAL	RATING
A	DBL 3'-0"	7'-0"	1-3/4"	MTL.	STEEL	NONE
B	3'-0"	7'-0"	1-3/4"	MTL.	STEEL	NONE

NOTES:

- CONTRACTOR SHALL VERIFY ALL DOOR SIZES AND ROUGH OPENINGS IN FIELD PRIOR TO ORDERING.
- VERIFY ALL DOORS, FRAMES AND HARDWARE WITH OWNER.
- DOOR HARDWARE AT ALL EXIT DOOR SHALL ALLOW DOORS TO BE OPENED FROM THE INSIDE WITHOUT A KEY, SPECIAL KNOWLEDGE, OR EFFORT PER CBC 1019.2.1.
- MAXIMUM DOOR OPENING EFFORTS SHALL BE 5 LBS AT EXTERIOR DOORS
- ALL DOORS SHALL BE EQUIPPED WITH SINGLE EFFORT, NON-GRASP HARDWARE (I.E LEVER) CENTERED BETWEEN 30" AND 44" ABOVE THE FLOOR.
- ALL DOORS SHALL HAVE A 10" HIGH MINIMUM FLAT SURFACE AT THE DOOR BOTTOM TO BE USED AS A KICKPLATE, NO GLAZING.
- DOORS SHALL HAVE KEVED OPERATED LOCKING DEVICES ONLY ACTIVE FROM THE EXTERIOR.
- ALL DOORS SHALL BE PROVIDED WITH FLOOR MOUNTED DOME STOPS LOCATED NEAR WALL FOR DOOR TO OPEN 175°.

HARDWARE DOOR 'A'
 LOCKET SET: STOREROOM LOCK, SCHLAGE NDR49FD, RHODES
 CYLINDER: SCHLAGE 20-765 PRIMUS
 HINGES: HAGER 881199 STAINLESS, 2 PAIRS
 CLOSER: NORTON PR7400DA
 STOP: TRIMCO #1260W
 LOCKGUARD: BLP 107-630
 FLUSH BOLTS: IVES 262

HARDWARE DOOR 'B'
 LOCKET SET: STOREROOM LOCK, SCHLAGE NDR49FD, RHODES
 CYLINDER: SCHLAGE 20-765 PRIMUS
 HINGES: HAGER 881199 STAINLESS, 2 PAIRS
 CLOSER: NORTON PR7400DA
 STOP: TRIMCO #1260W
 LOCKGUARD: BLP 107-630
 FLUSH BOLTS: IVES 262
 ASTRAGAL: PEMKO 305CN







I DOOR FRAME AND SCHEDULE NTS

G DOOR HEAD AND THRESHOLD NTS

E EAVE DETAIL NTS

C WHITE BOARD FASTENING NTS

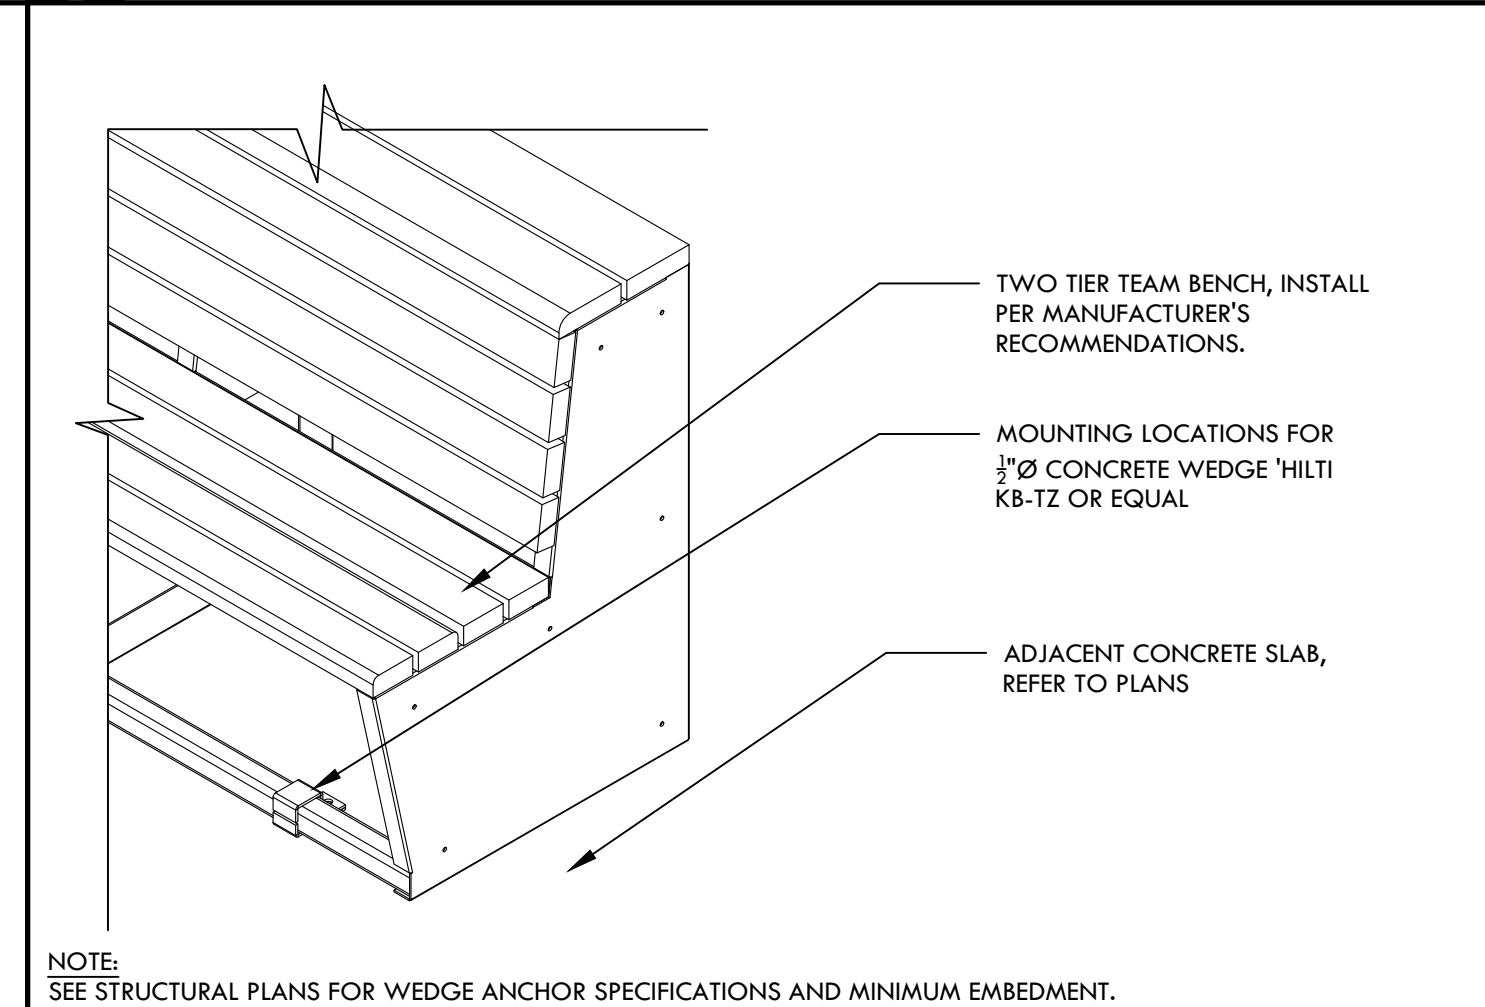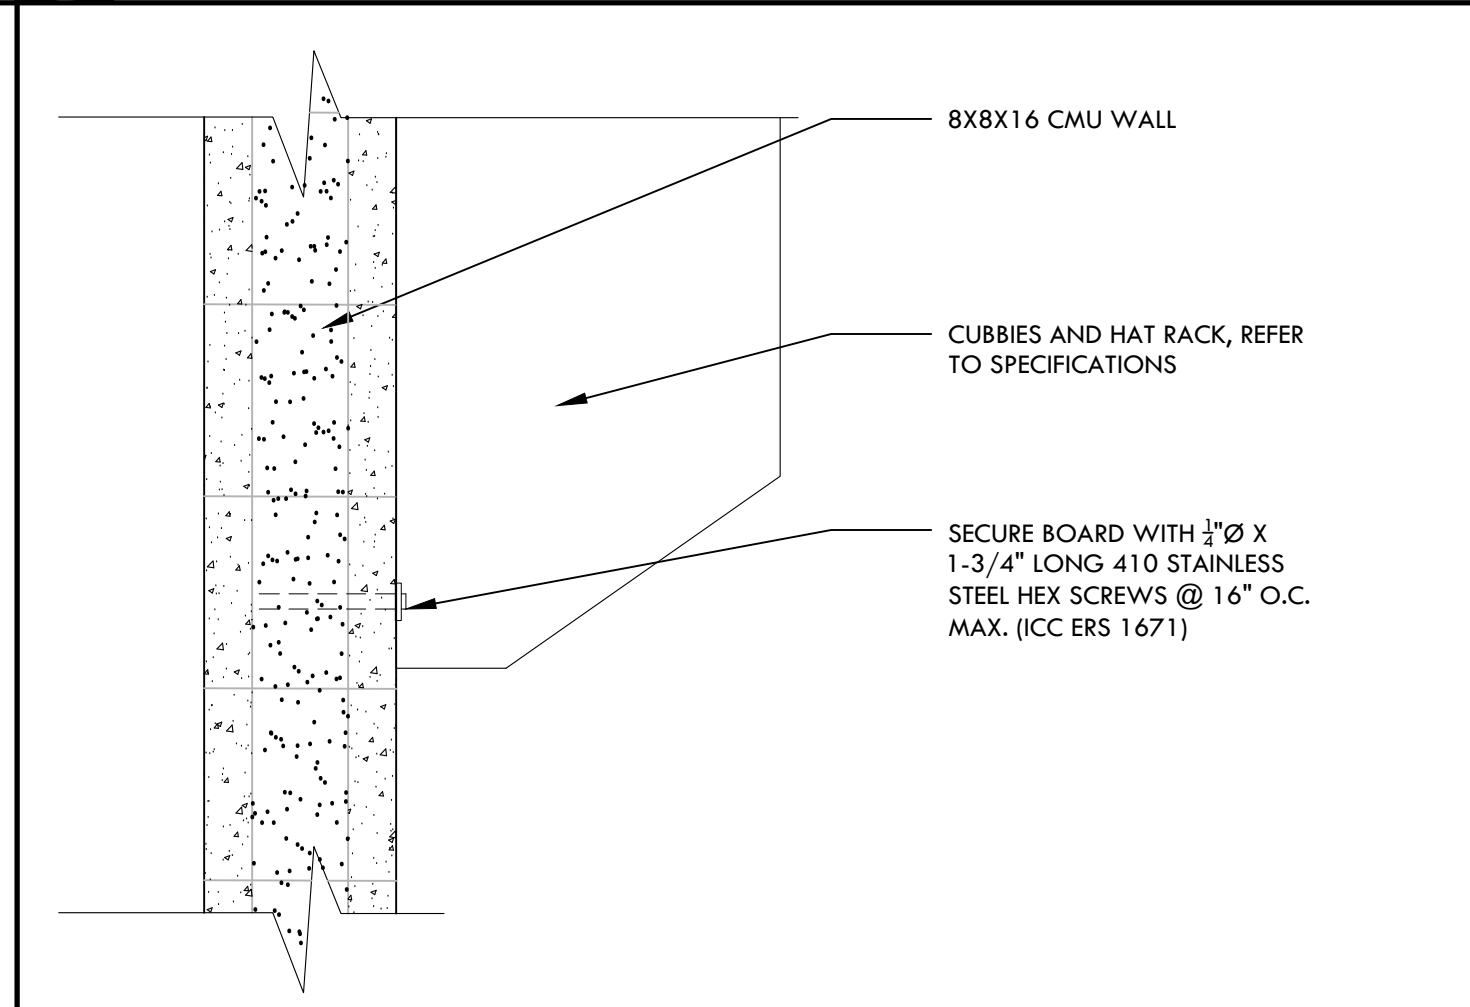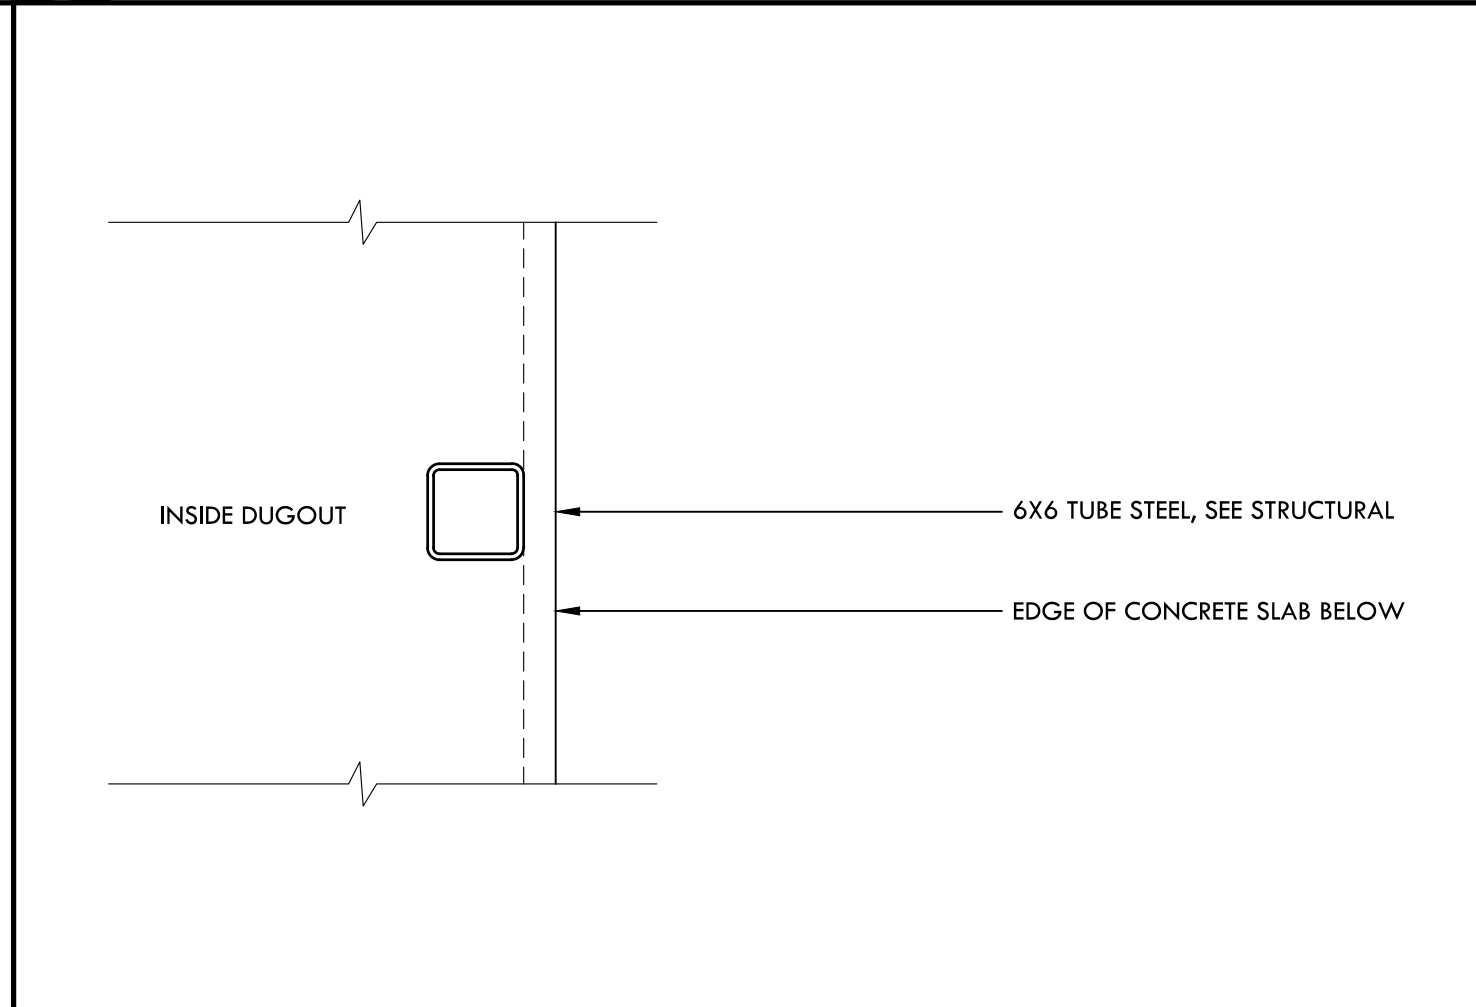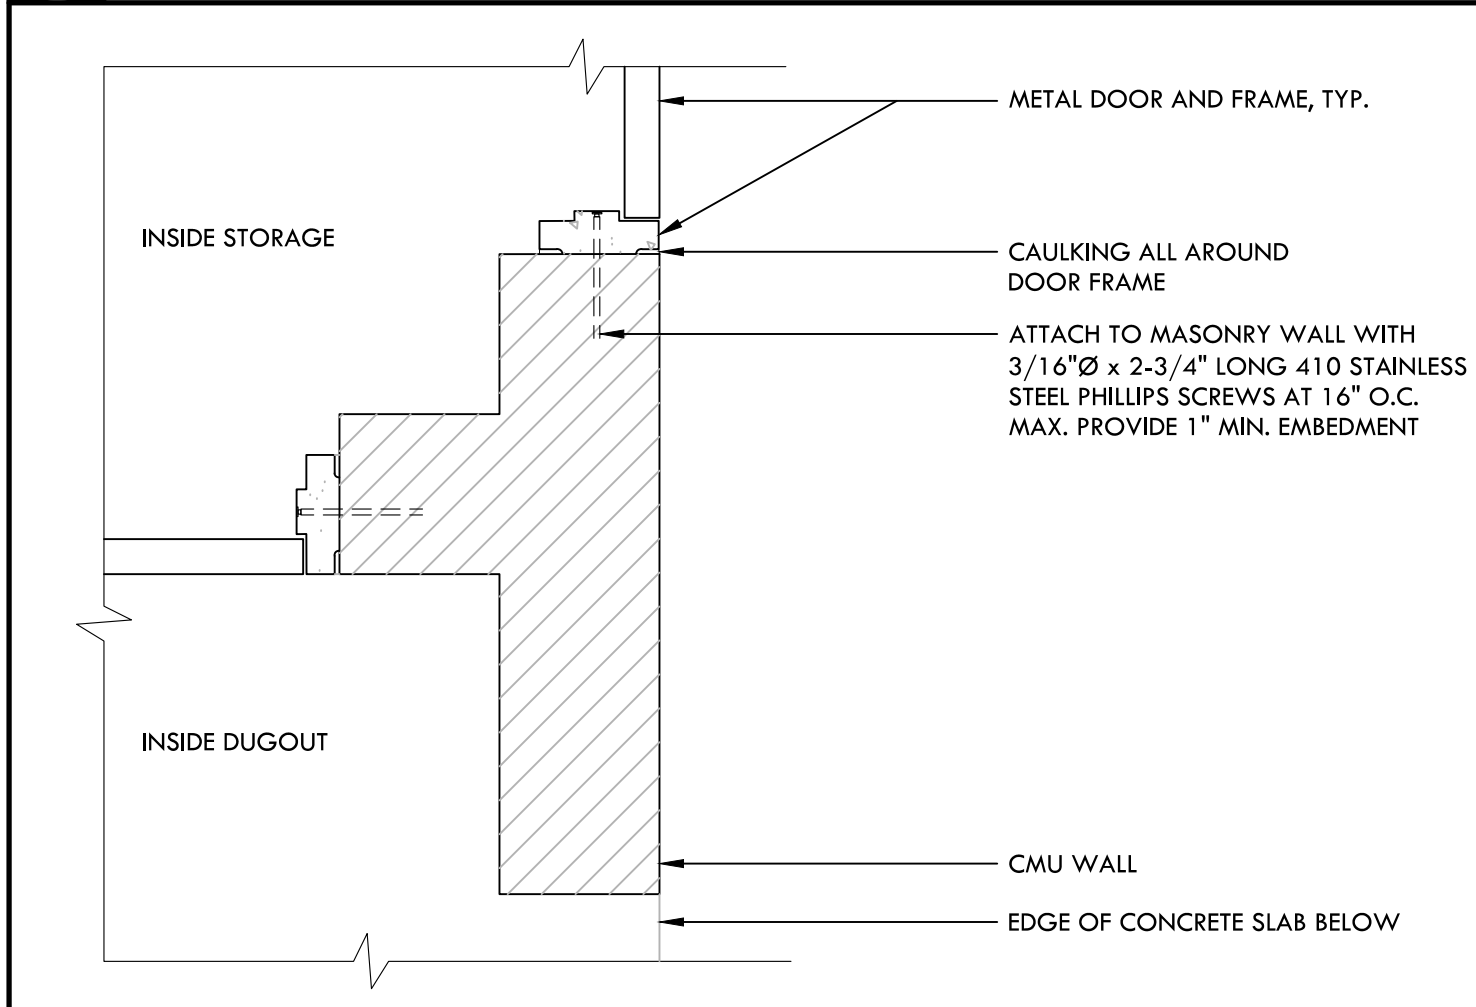


H MAN DOOR JAMB DETAIL NTS

F MID COLUMN SUPPORT NTS

D CUBBIE FASTENING NTS

B TWO TIER BENCH NTS

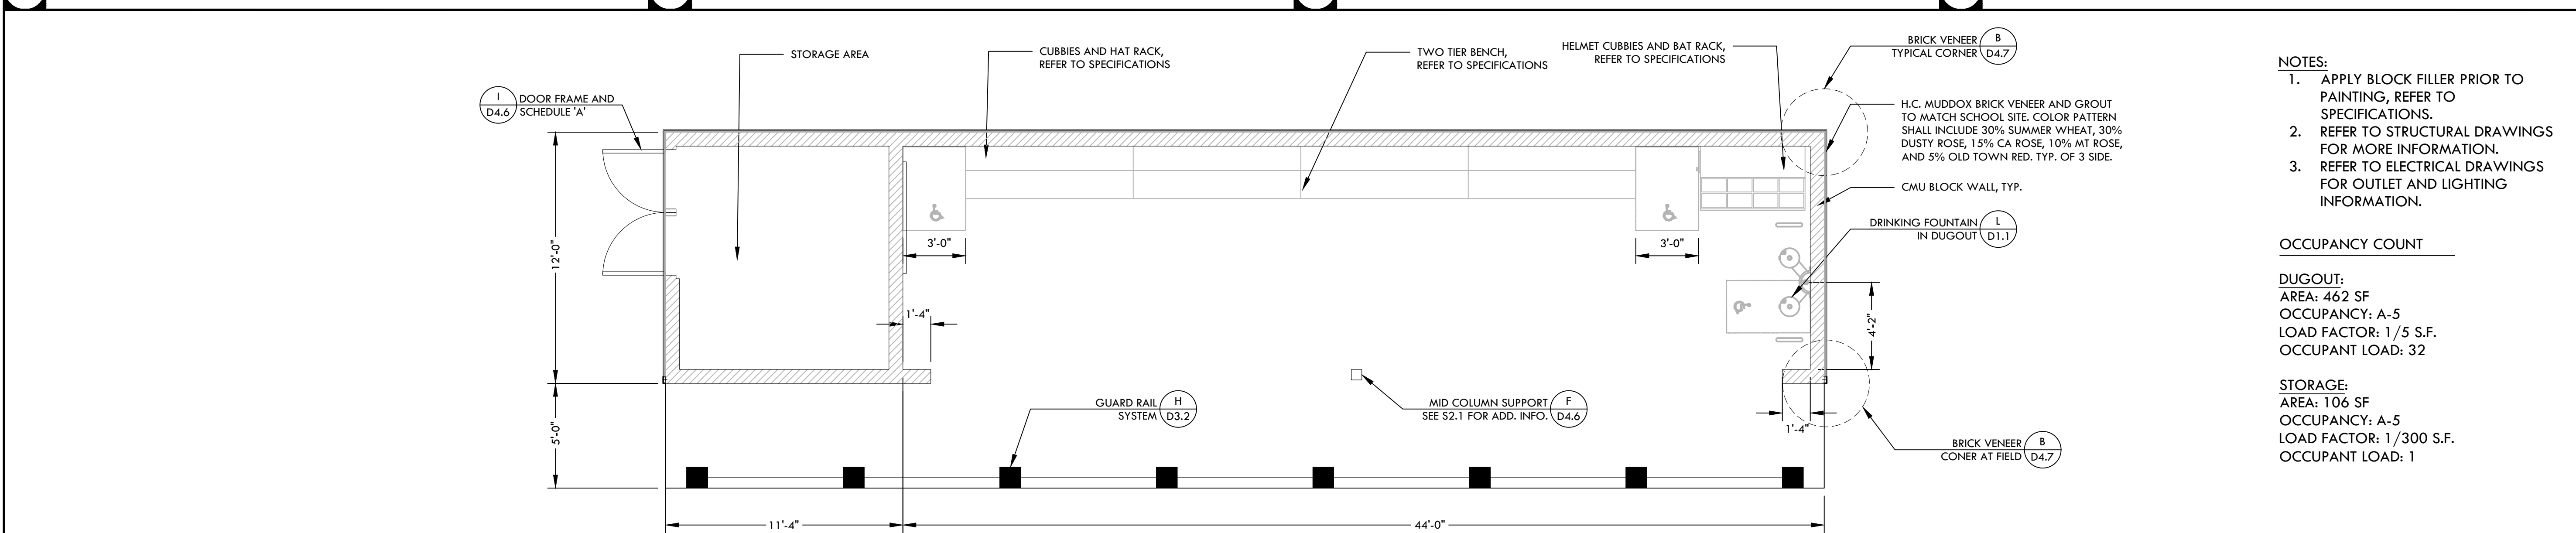







NOTES:

- APPLY BLOCK FILLER PRIOR TO PAINTING, REFER TO SPECIFICATIONS.
- REFER TO STRUCTURAL DRAWINGS FOR MORE INFORMATION.
- REFER TO ELECTRICAL DRAWINGS FOR OUTLET AND LIGHTING INFORMATION.

OCCUPANCY COUNT

DUGOUT:
 AREA: 462 SF
 OCCUPANCY: A-5
 LOAD FACTOR: 1/5 S.F.
 OCCUPANT LOAD: 32

STORAGE:
 AREA: 106 SF
 OCCUPANCY: A-5
 LOAD FACTOR: 1/300 S.F.
 OCCUPANT LOAD: 1

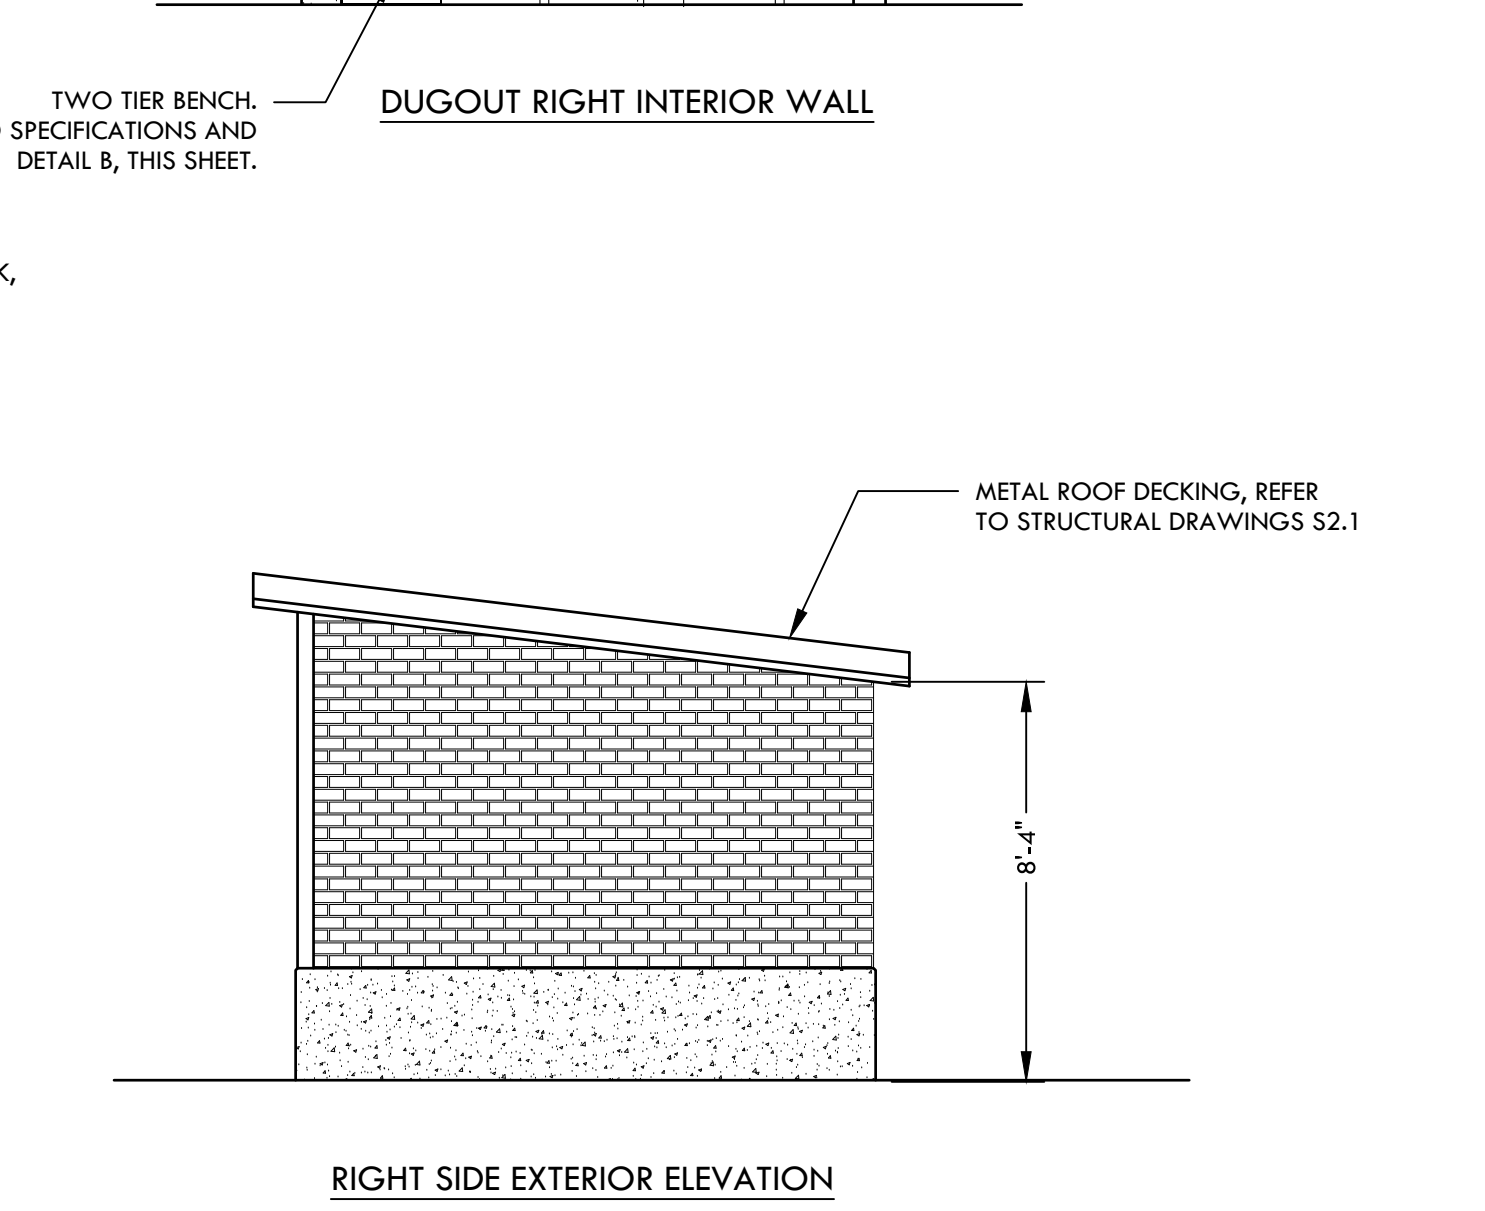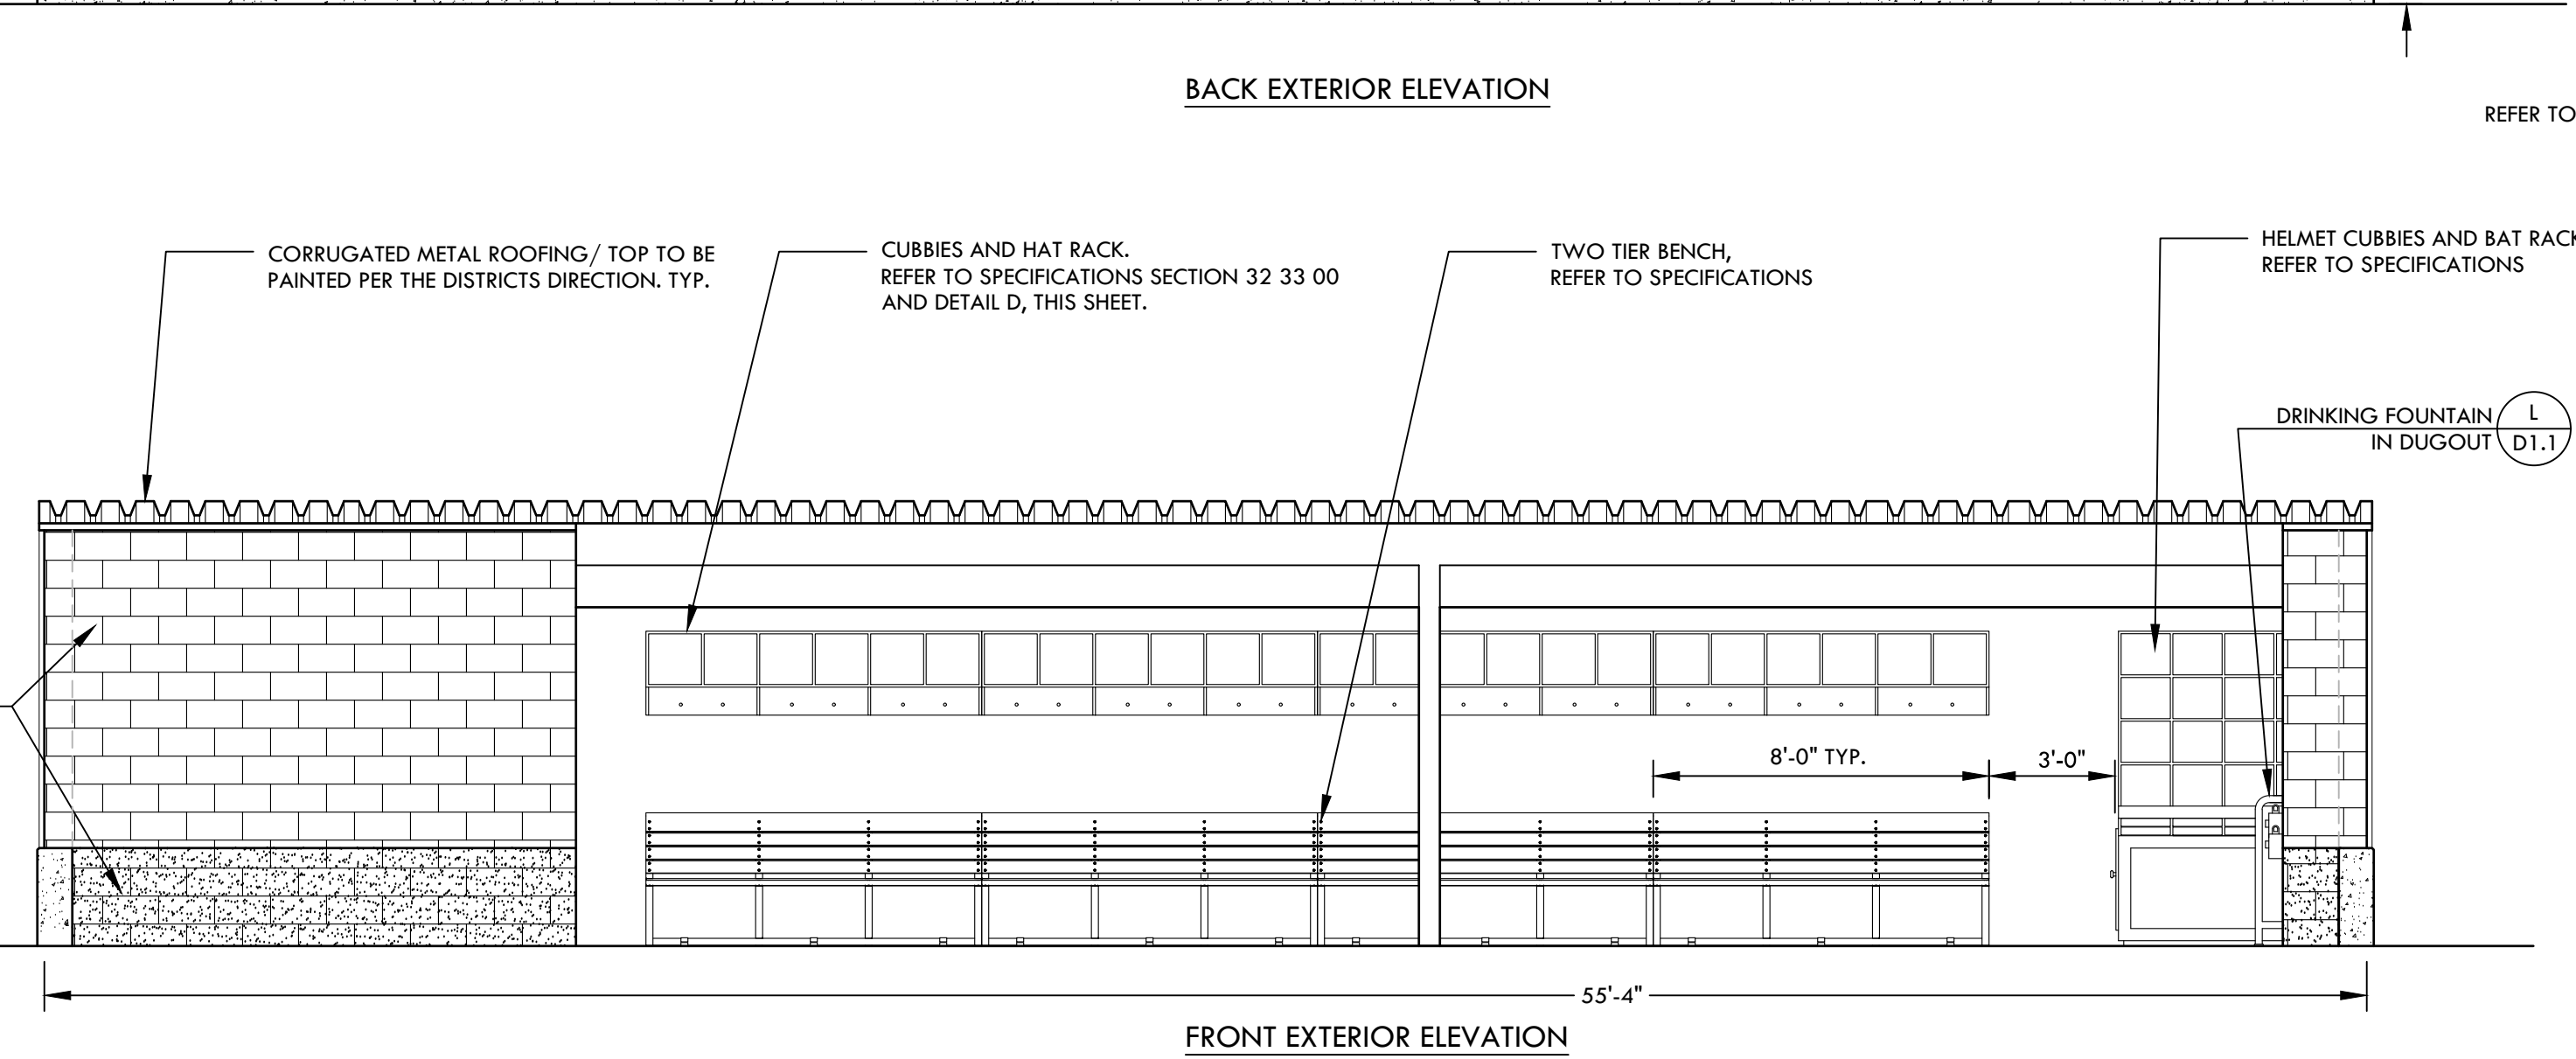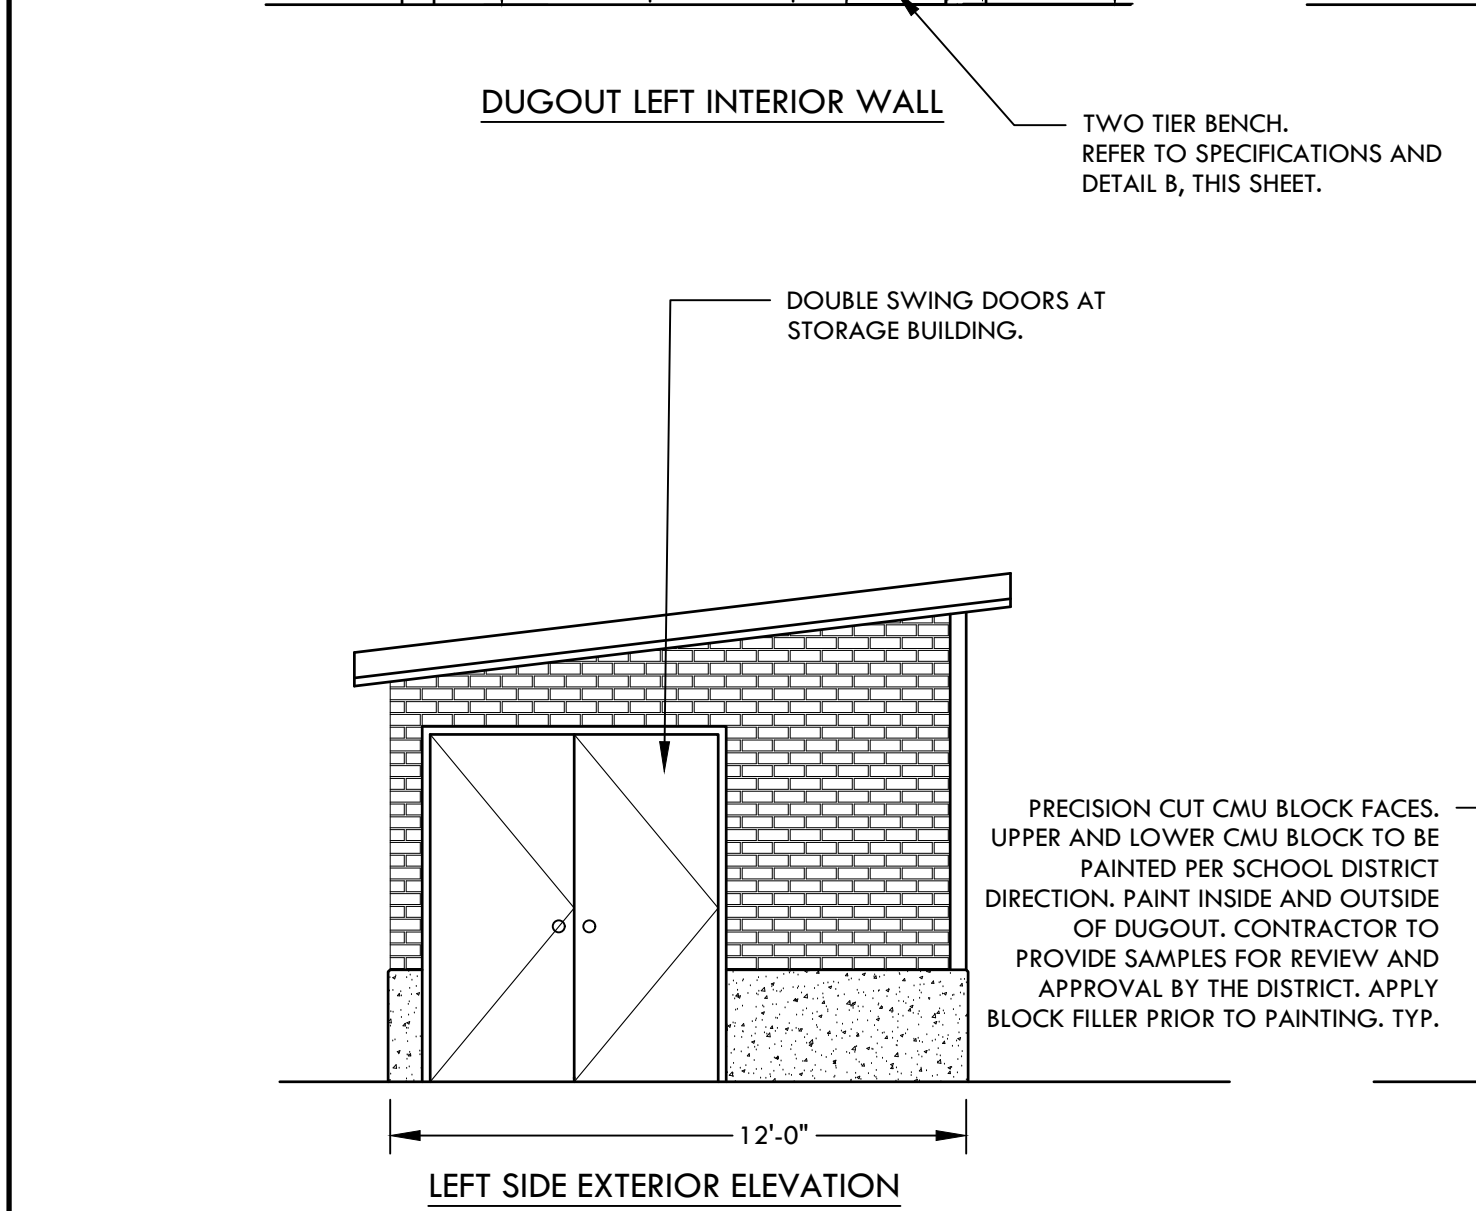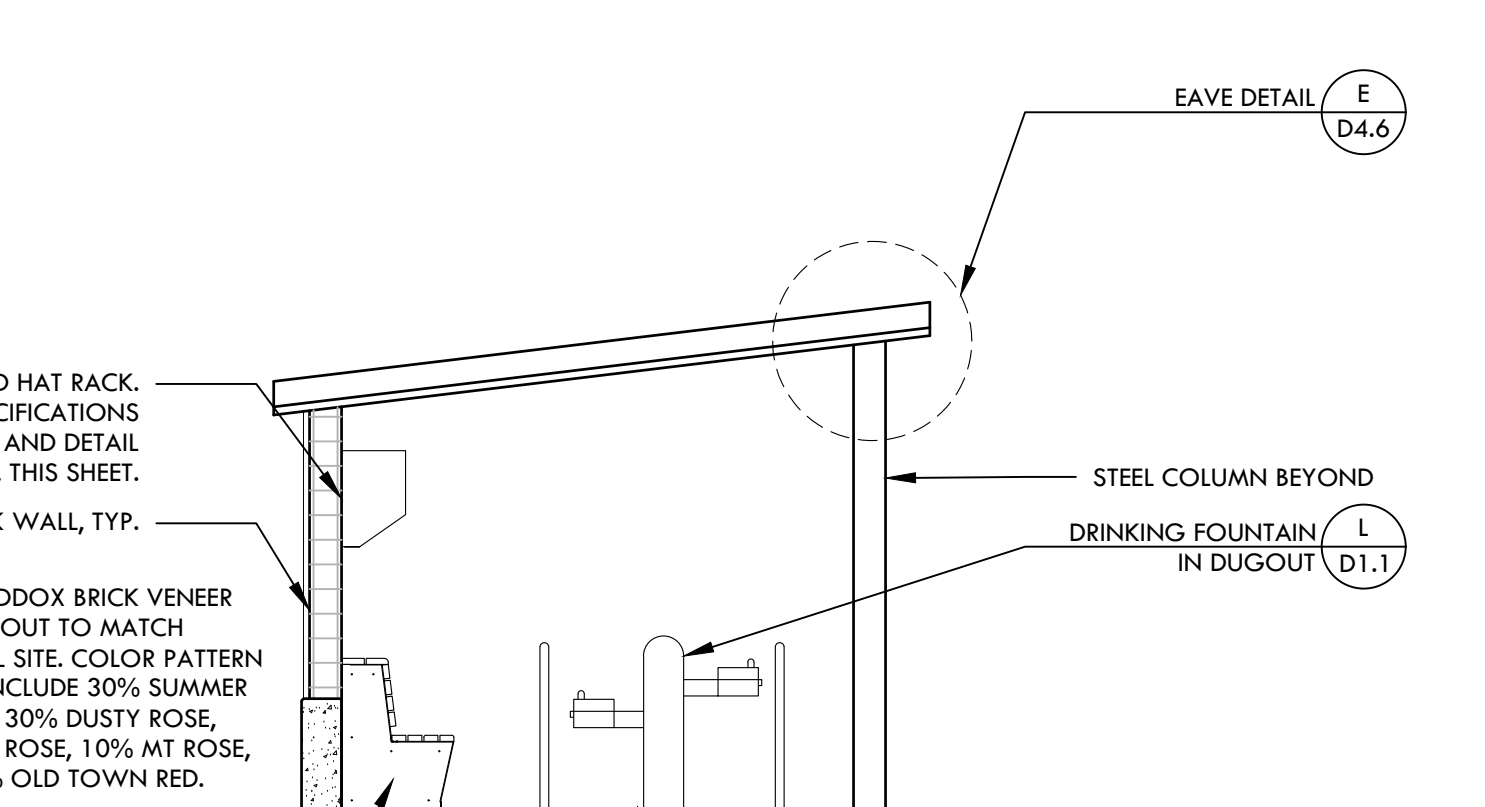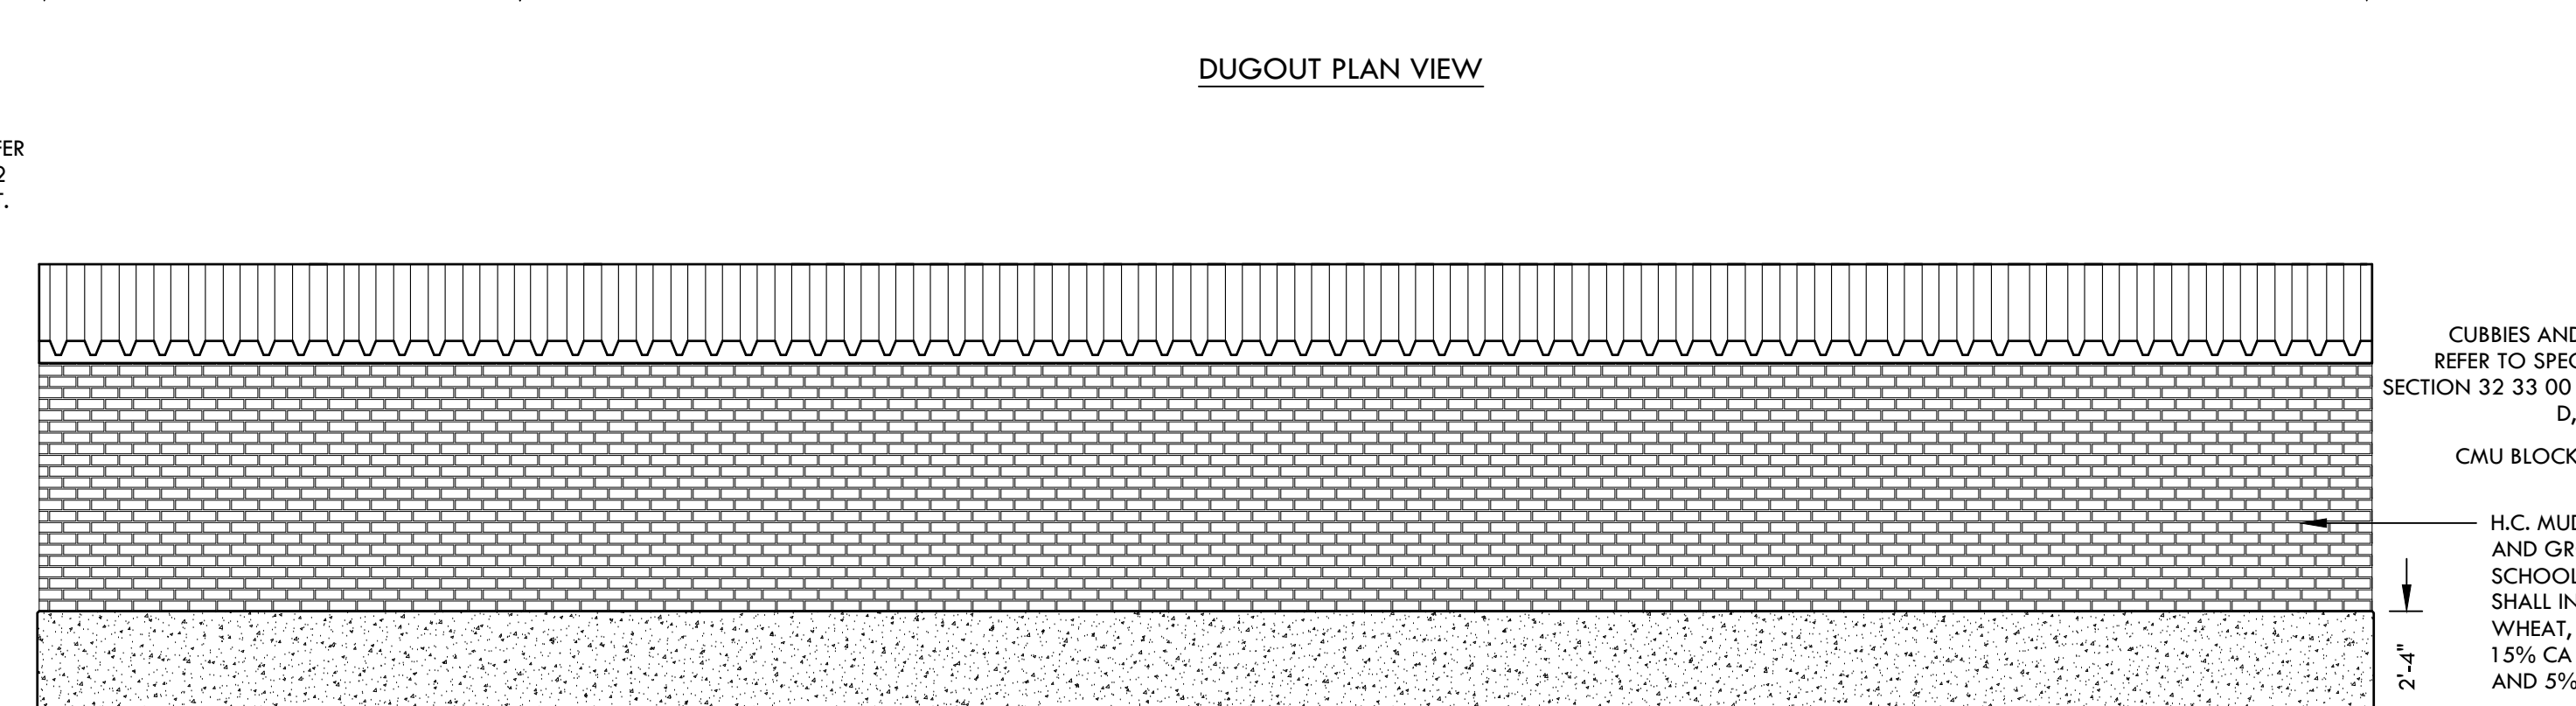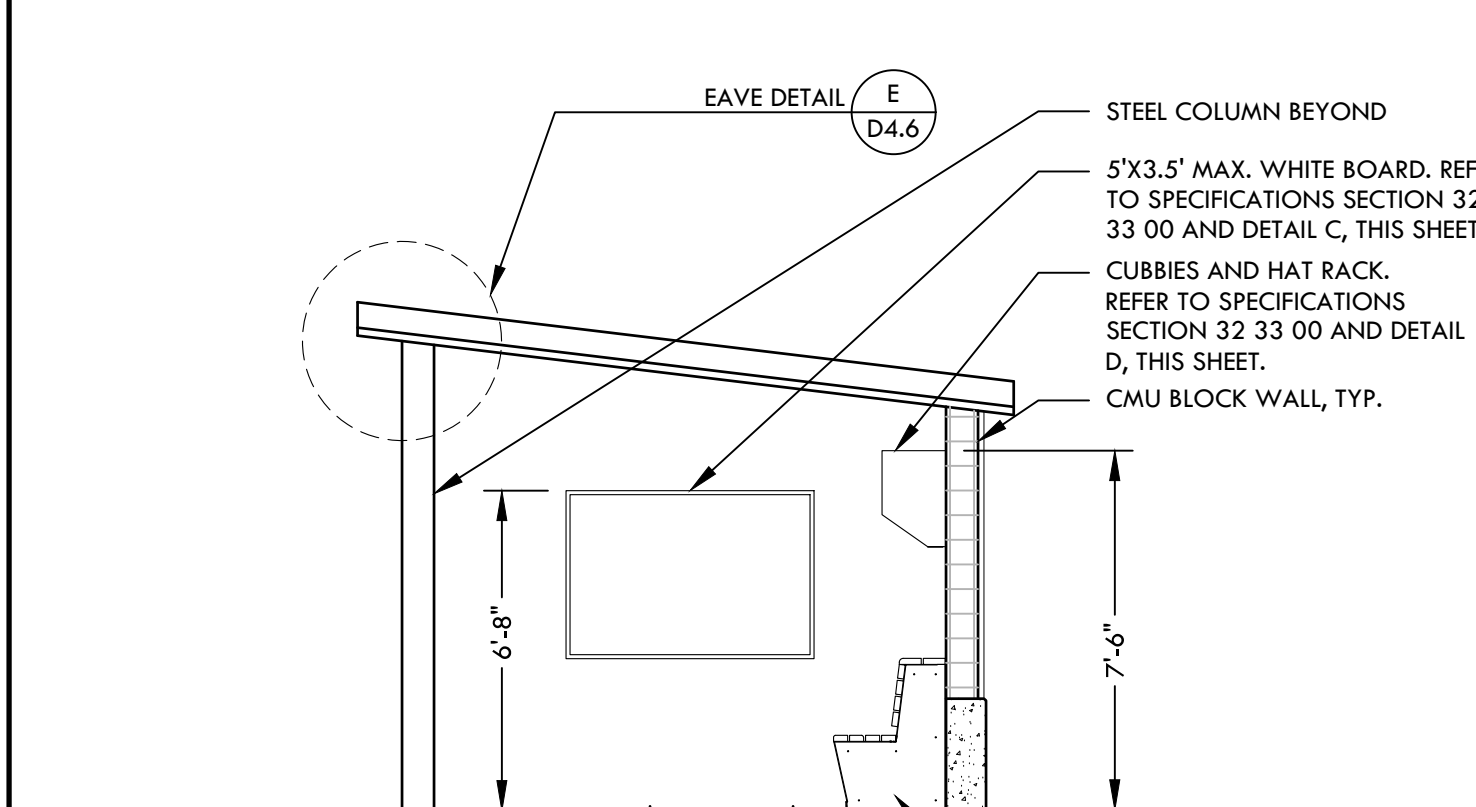

A BASEBALL DUGOUT - 1ST BASE SIDE (HOME) NTS

DUGOUT PLAN VIEW

BACK EXTERIOR ELEVATION

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STAMP

REGISTERED LANDSCAPE ARCHITECT
 HIRAM JOHNSON
 EXPIRATION DATE: JULY 2023
 STATE OF CALIFORNIA

CONSULTANT

KEYMAP

SHEET TITLE

CONSTRUCTION DETAILS - BASEBALL DUGOUTS

PROJECT NAME

HIRAM JOHNSON HIGH SCHOOL GOLF PRACTICE FACILITY, VARSITY BASEBALL AND SOFTBALL FIELDS

PROJECT ADDRESS

6879 14TH AVENUE SACRAMENTO, CA 95820

SUBMITTAL	DATE
DD 50% SUBMITTAL	04/15/22
100% DSA SUBMITTAL	05/27/22
DSA BACK CHECK	08/11/22
DSA ADDENDUM SUBMITTAL	09/16/22

NO.	REVISIONS	DATE
1	ADDENDUM	09/16/22

DRAWN BY: VDI CHECKED BY: MB/CS
 DATE ISSUED: 09/16/2022 SCALE: AS NOTED
 PROJ. NO.: 2203200

SHEET NO. **D4.6**





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H

F

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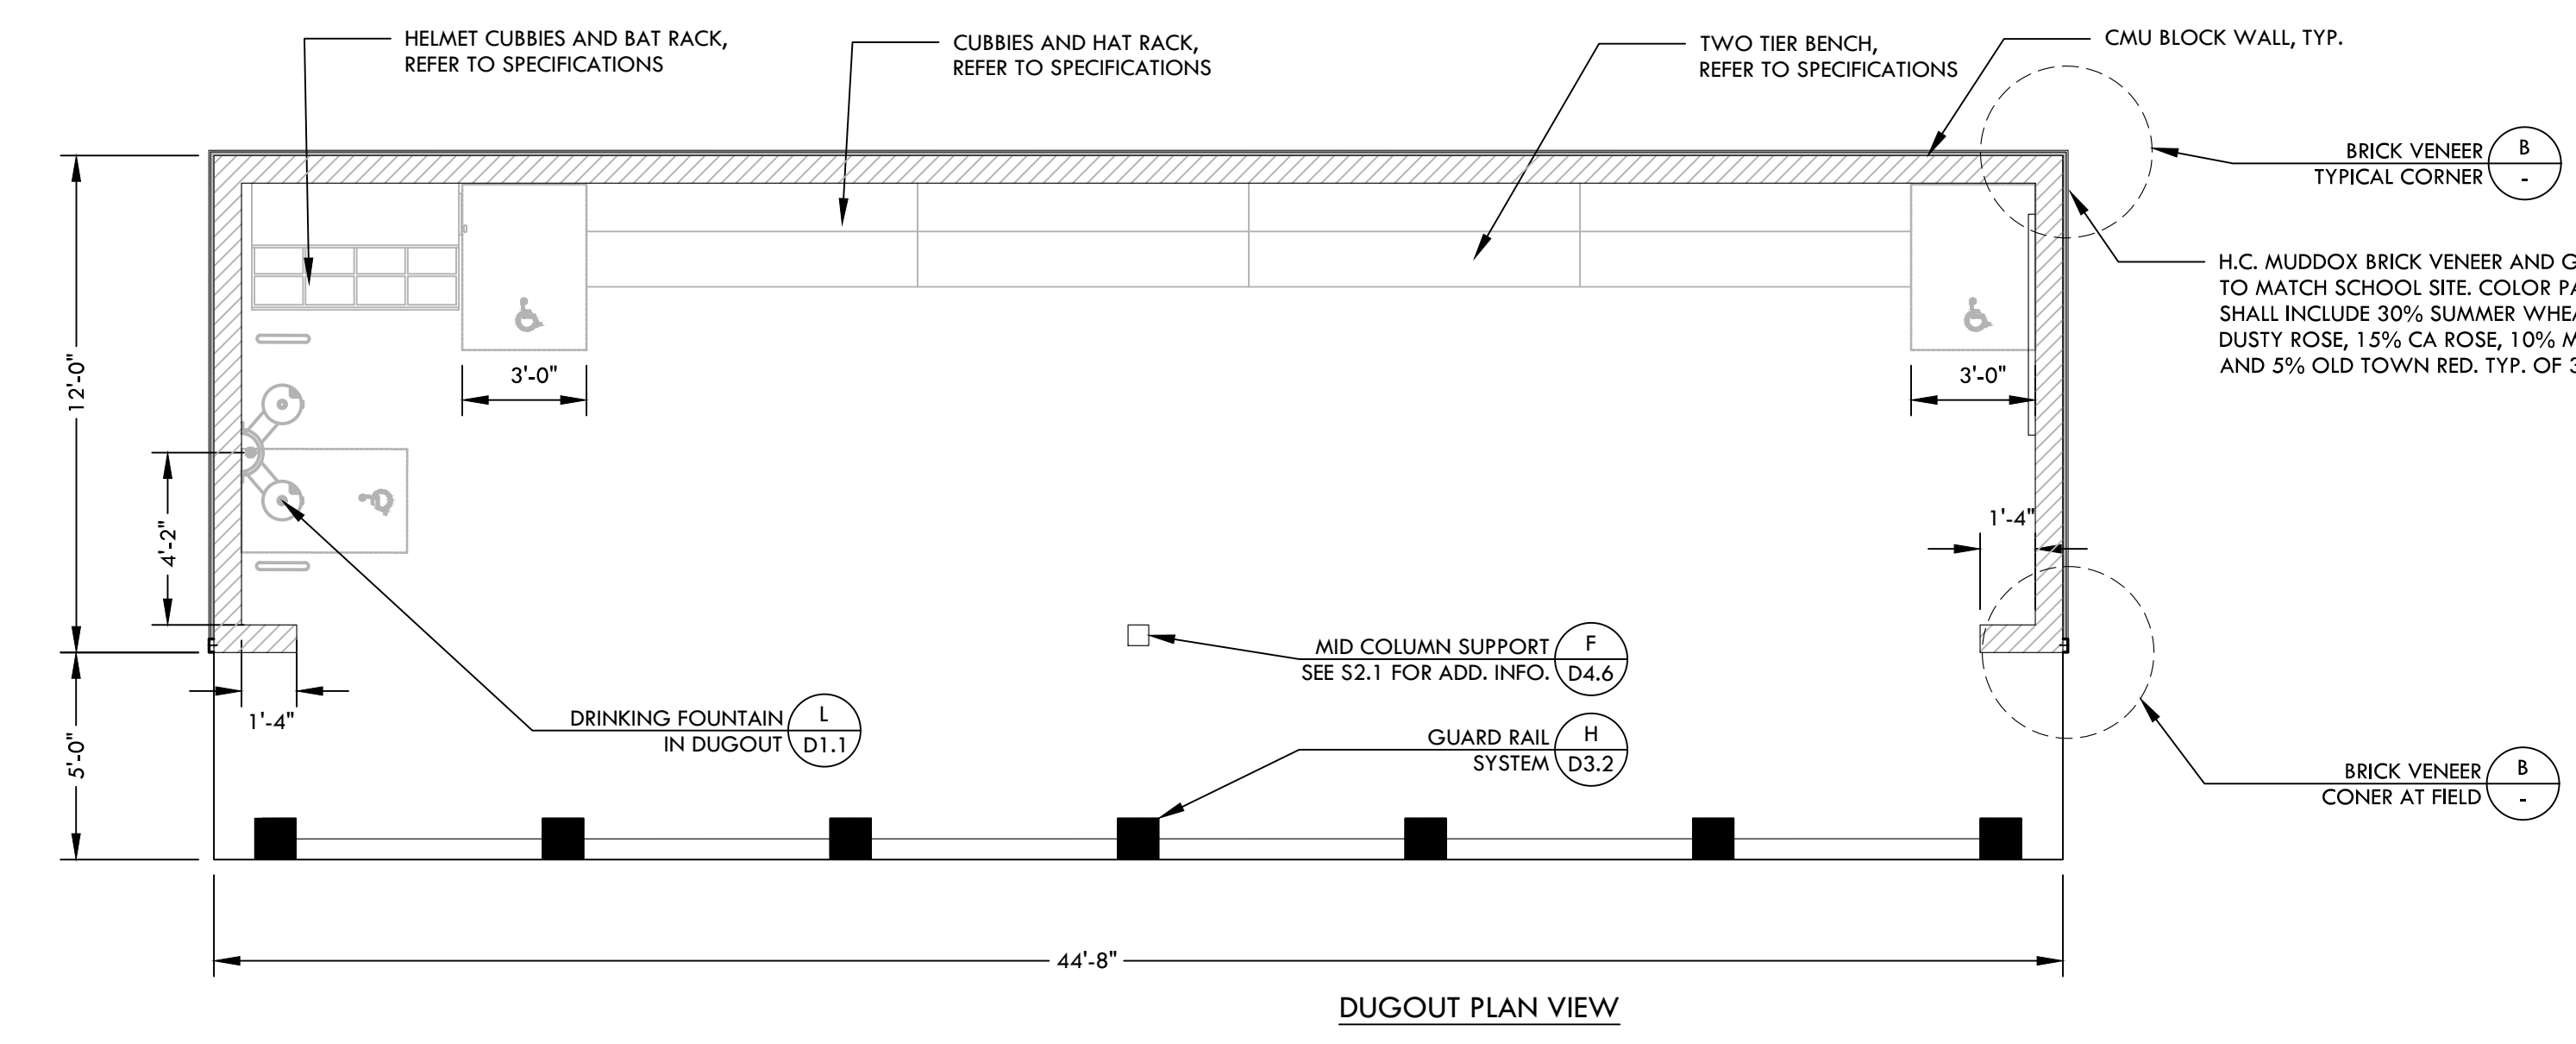
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B

BRICK VENEER

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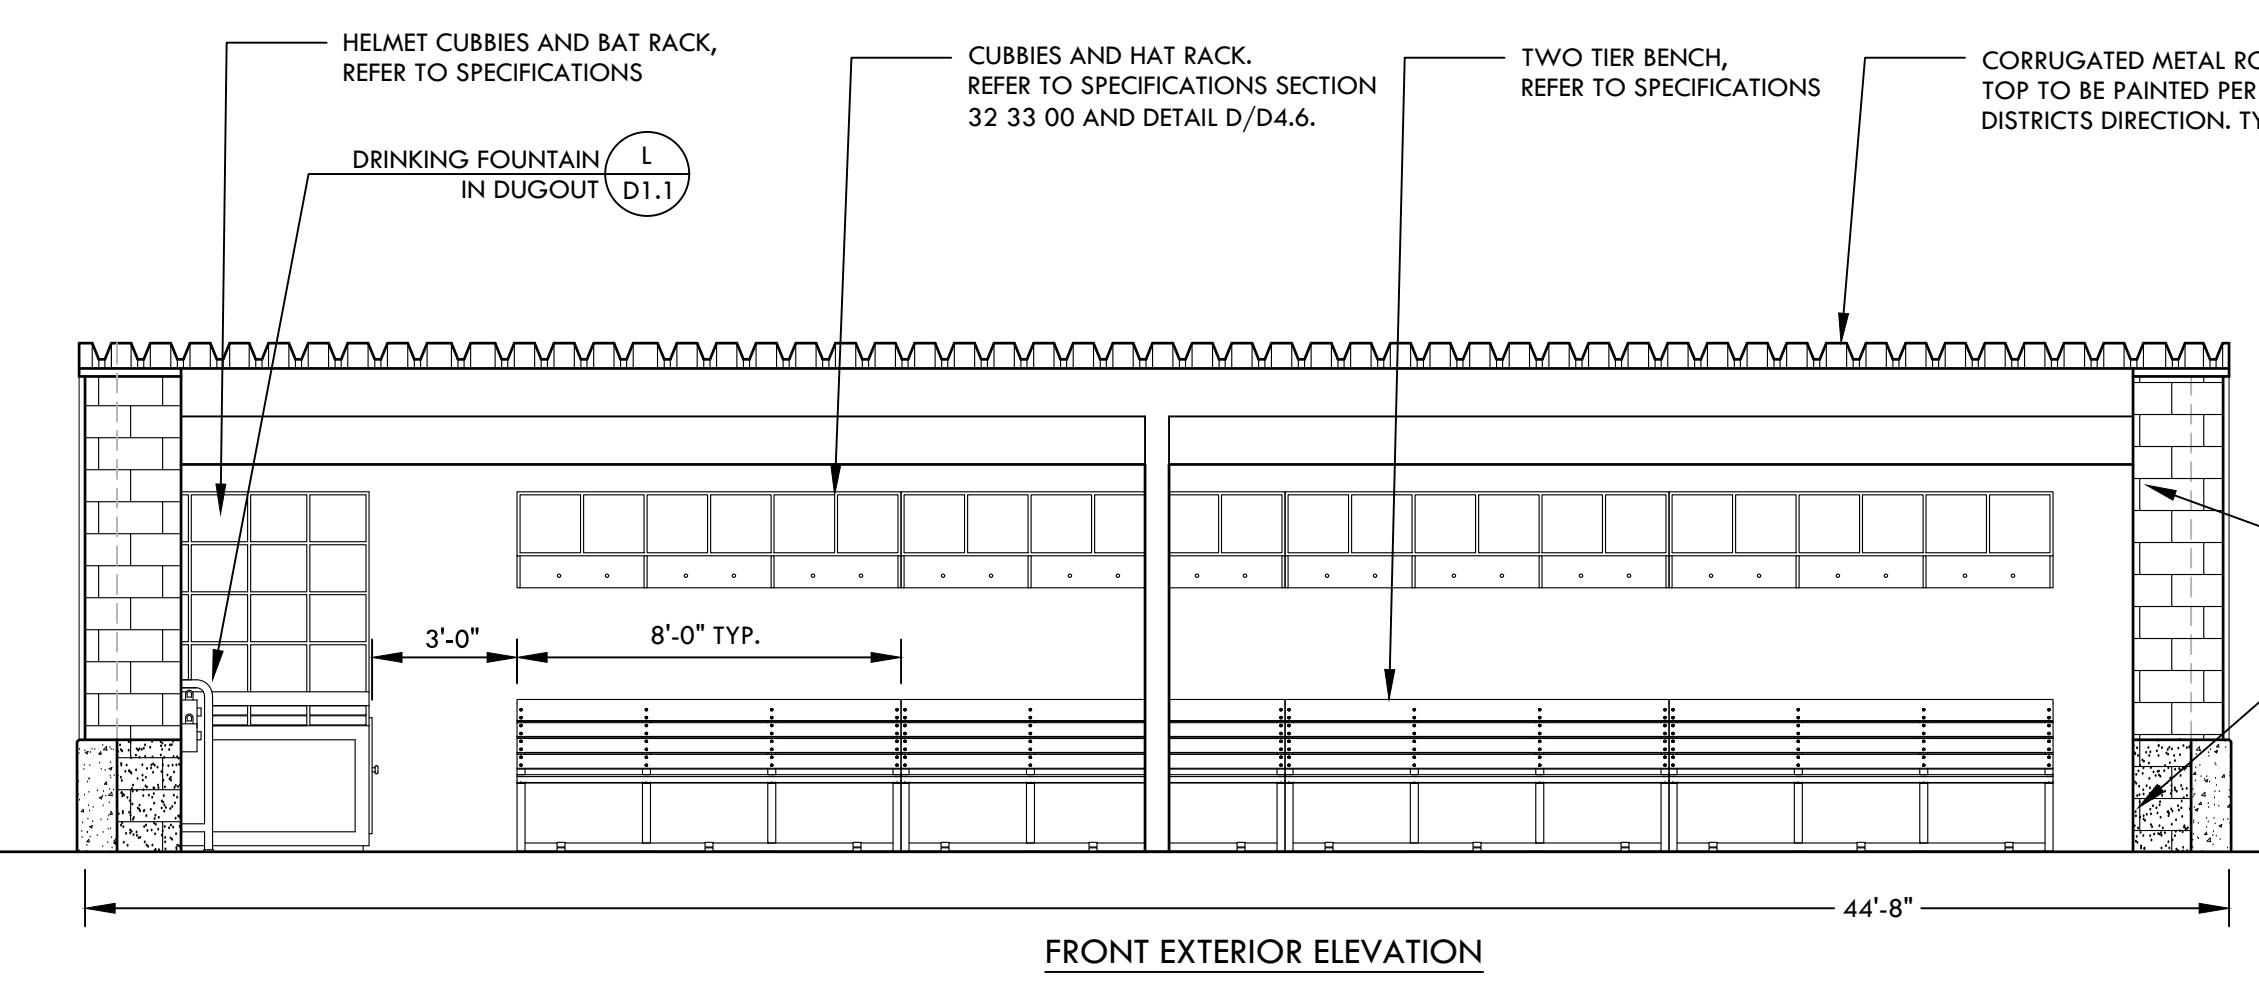
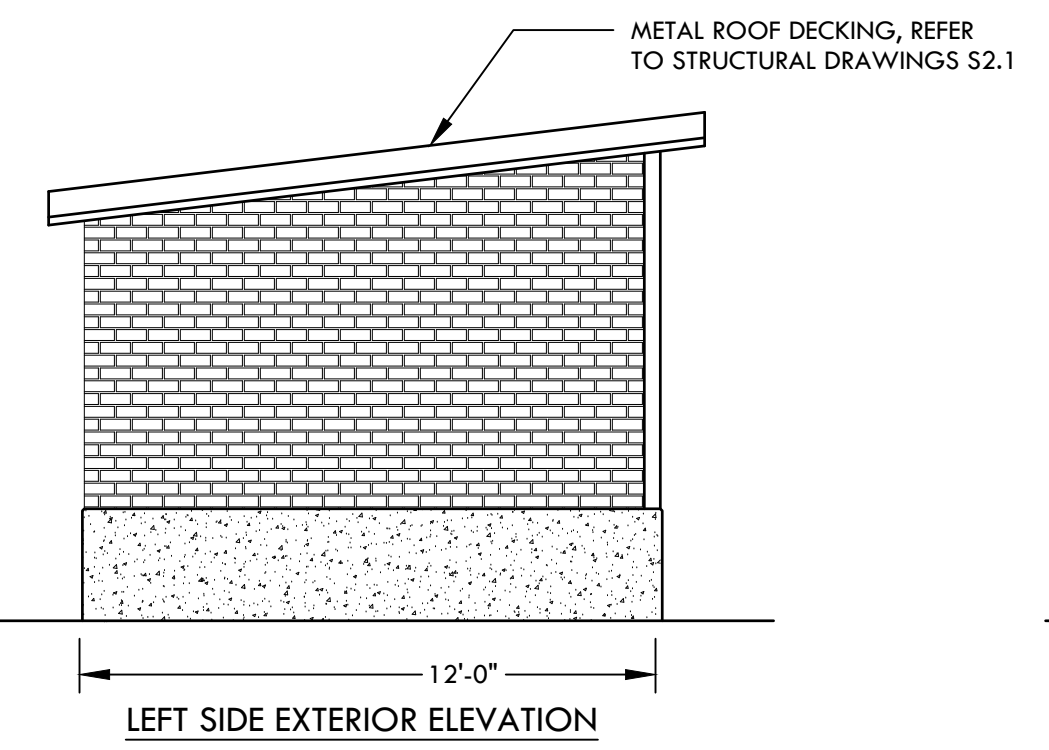
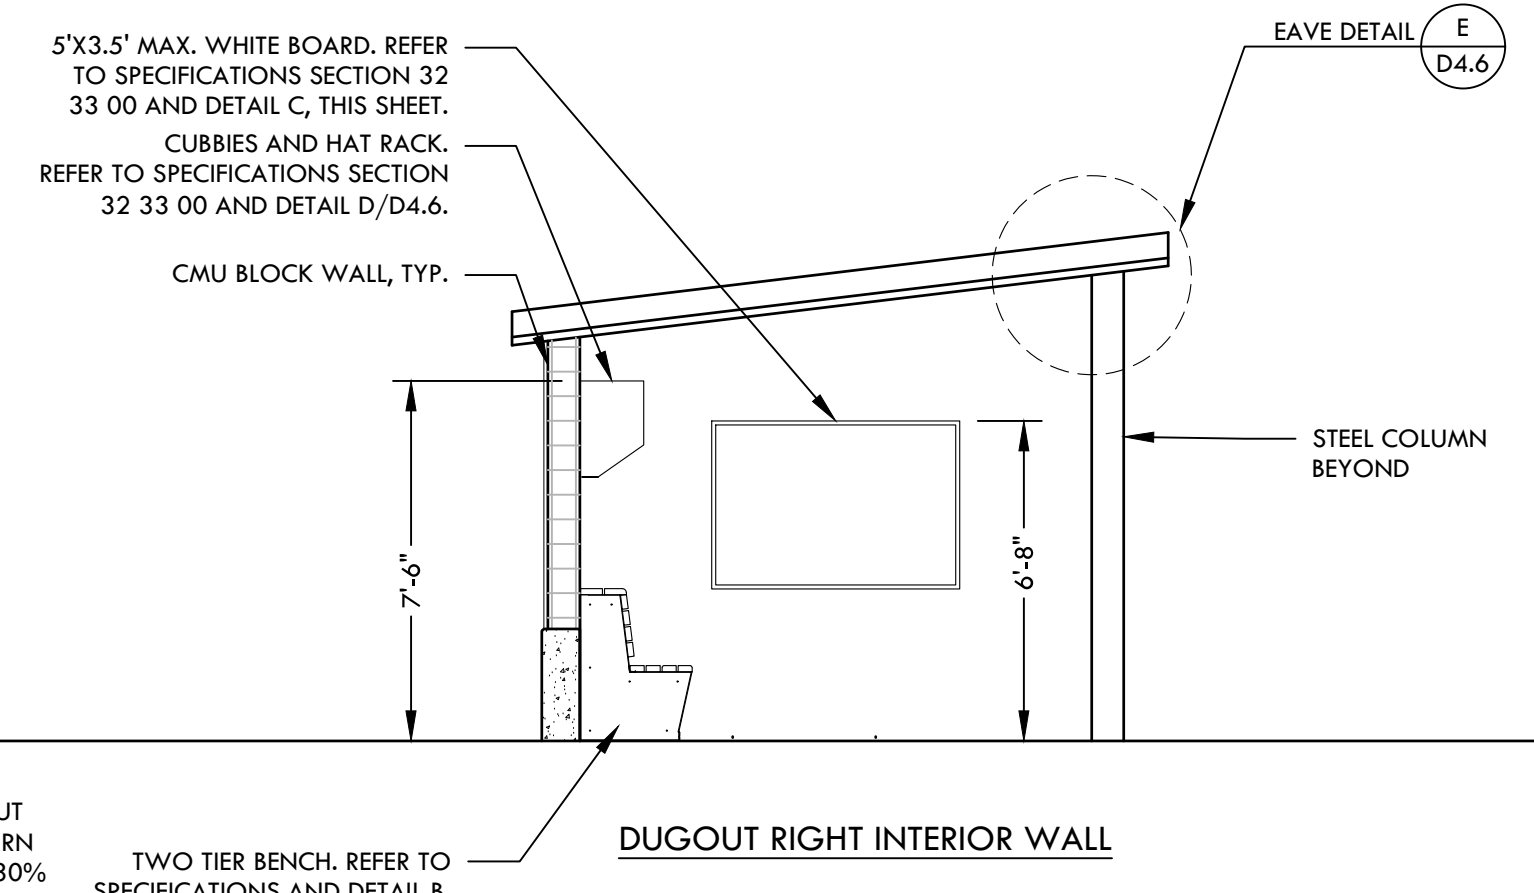
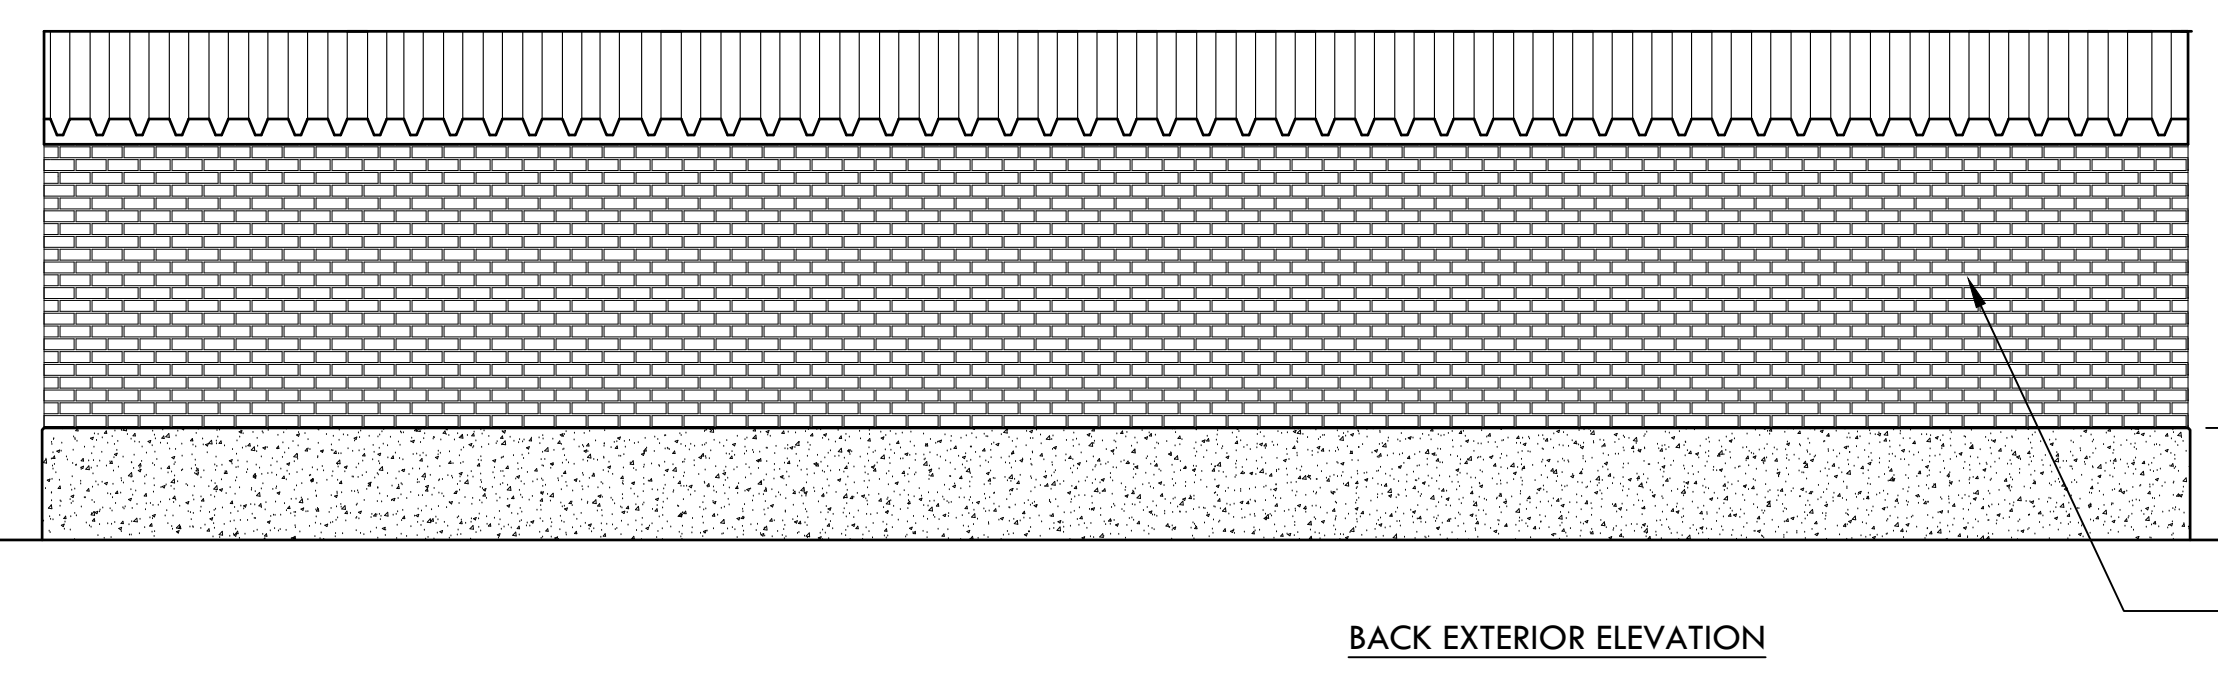
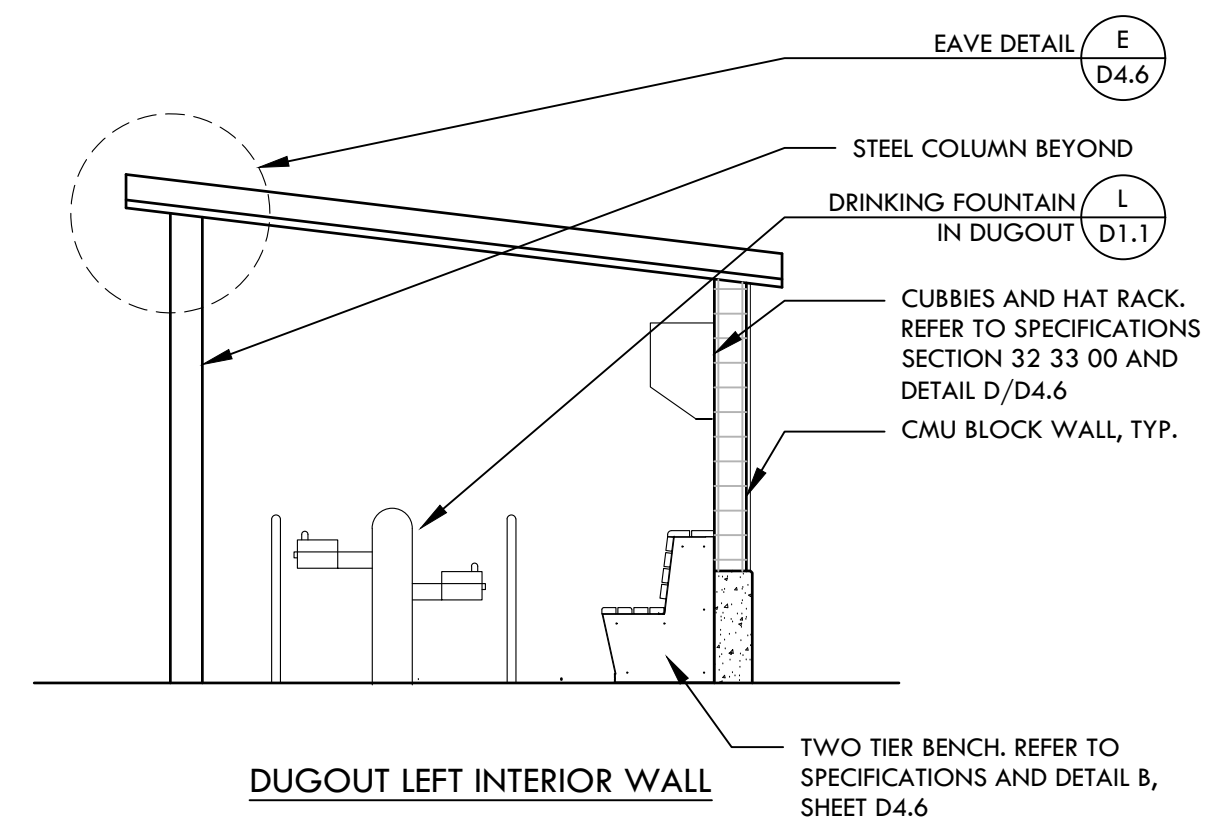

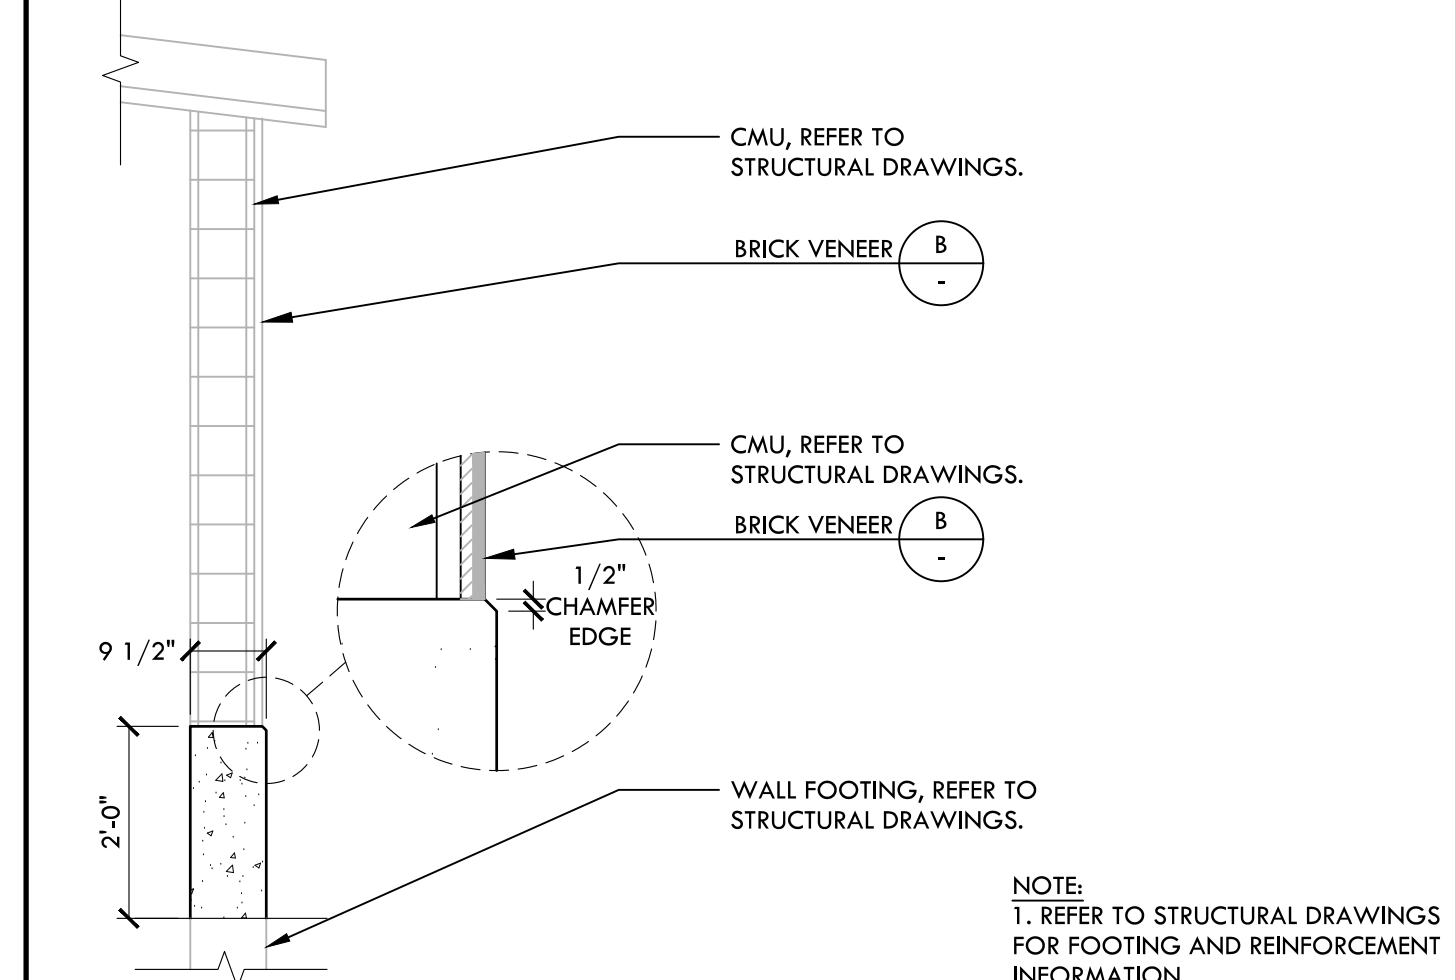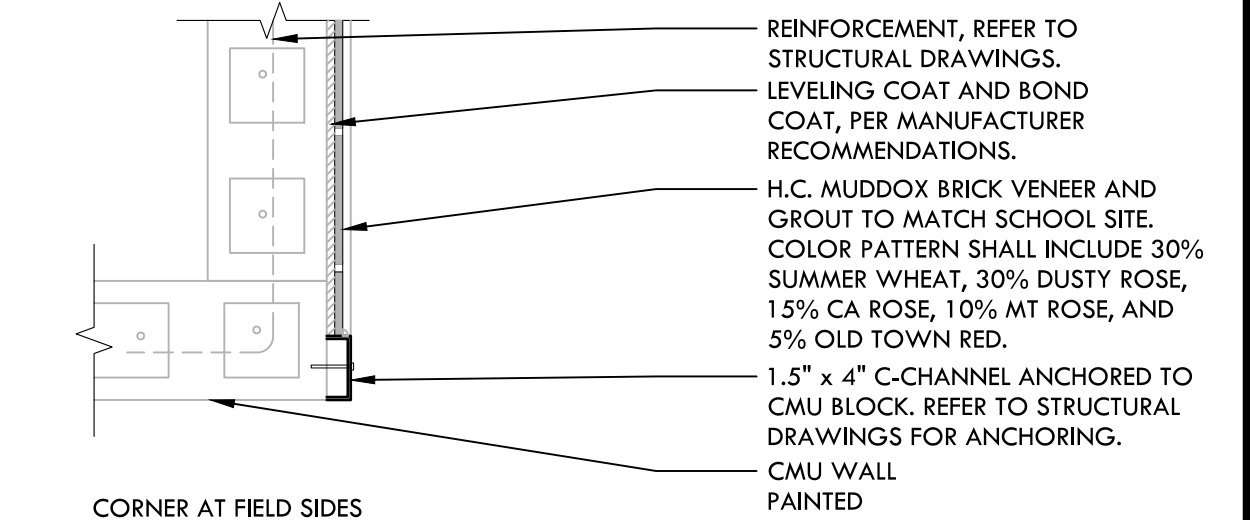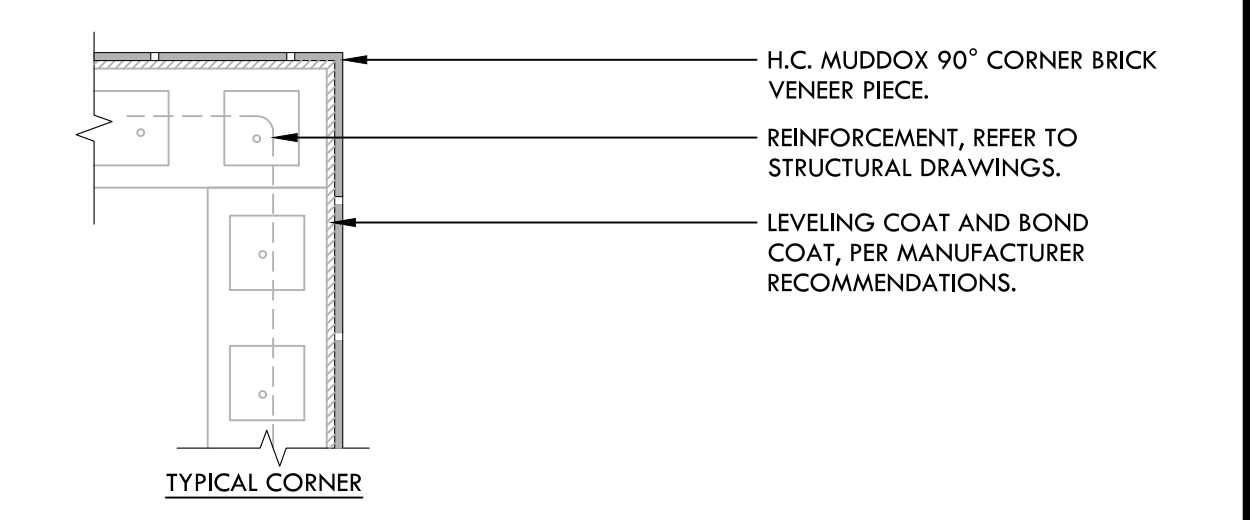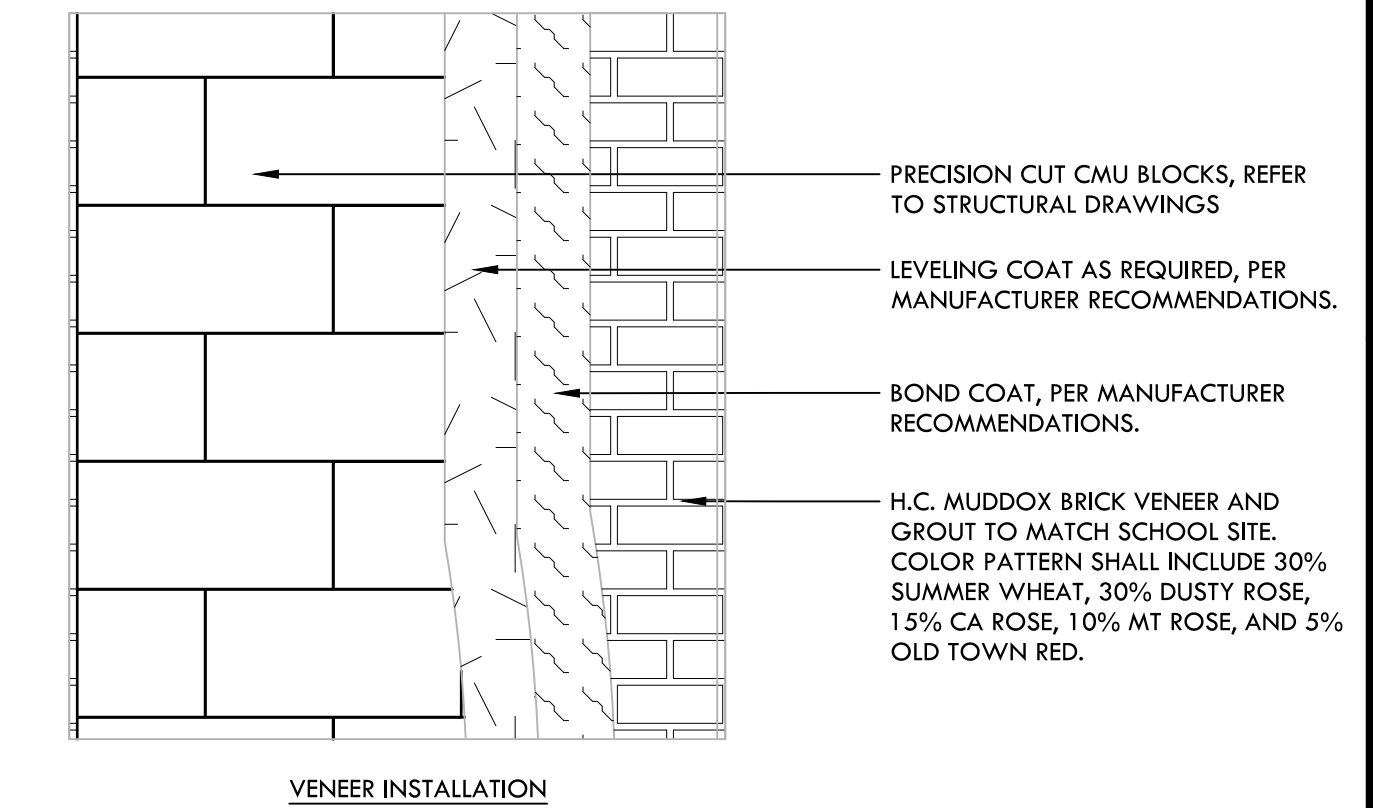
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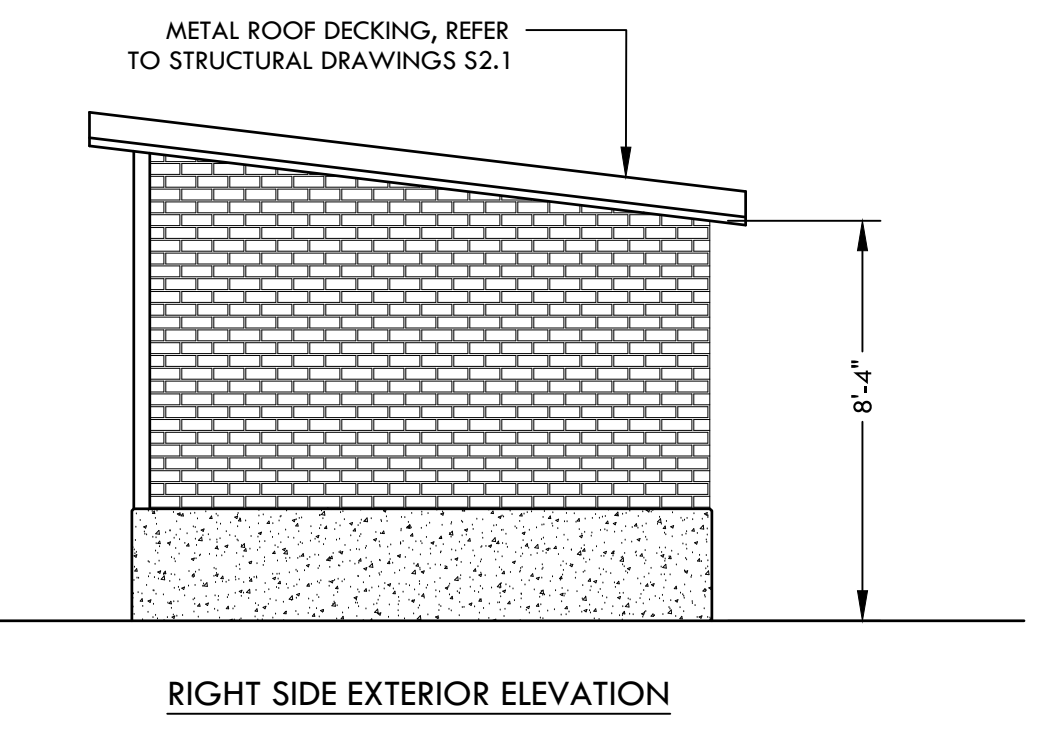
1. APPLY BLOCK FILLER PRIOR TO PAINTING. REFER TO SPECIFICATIONS.
2. REFER TO STRUCTURAL DRAWINGS FOR MORE INFORMATION.
3. REFER TO ELECTRICAL DRAWINGS FOR OUTLET AND LIGHTING INFORMATION.

OCCUPANCY COUNT

DUGOUT:
AREA: 462 SF
OCCUPANCY: A-5
LOAD FACTOR: 1/5 S.F.
OCCUPANT LOAD: 32



PRECISION CUT CMU BLOCK FACES. UPPER AND LOWER CMU BLOCK TO BE PAINTED PER SCHOOL DISTRICT DIRECTION. PAINT INSIDE AND OUTSIDE OF DUGOUT. CONTRACTOR TO PROVIDE SAMPLES FOR REVIEW AND APPROVAL BY THE DISTRICT. APPLY BLOCK FILLER PRIOR TO PAINTING. TYP.



A

BASEBALL DUGOUT - 3RD BASE SIDE (VISITOR)

NTS

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CONSULTANT

KEYMAP

SHEET TITLE

CONSTRUCTION DETAILS - BASEBALL DUGOUTS

PROJECT NAME

HIRAM JOHNSON HIGH SCHOOL GOLF PRACTICE FACILITY, VARSITY BASEBALL AND SOFTBALL FIELDS

PROJECT ADDRESS

6879 14TH AVENUE
SACRAMENTO, CA 95820

SUBMITTAL	DATE
50% SUBMITTAL	04/15/22
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DRAWN BY	VDI	CHECKED BY	MB/CS
DATE ISSUED	09/16/2022	SCALE	AS NOTED
PROJ. NO.	2203200		

SHEET NO. D4.7

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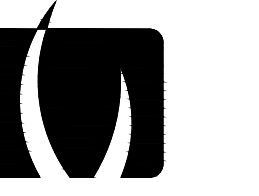
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CONSULTANT

KEYMAP

SHEET TITLE

CONSTRUCTION DETAILS -
SOFTBALL DUGOUTS

PROJECT NAME

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GOLF PRACTICE FACILITY,
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NO. REVISIONS DATE

ADDENDUM 09/16/22



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DATE ISSUED 09/16/2022 SCALE AS NOTED

PROJ. NO. 2203200

SHEET NO. D4.8

NTS

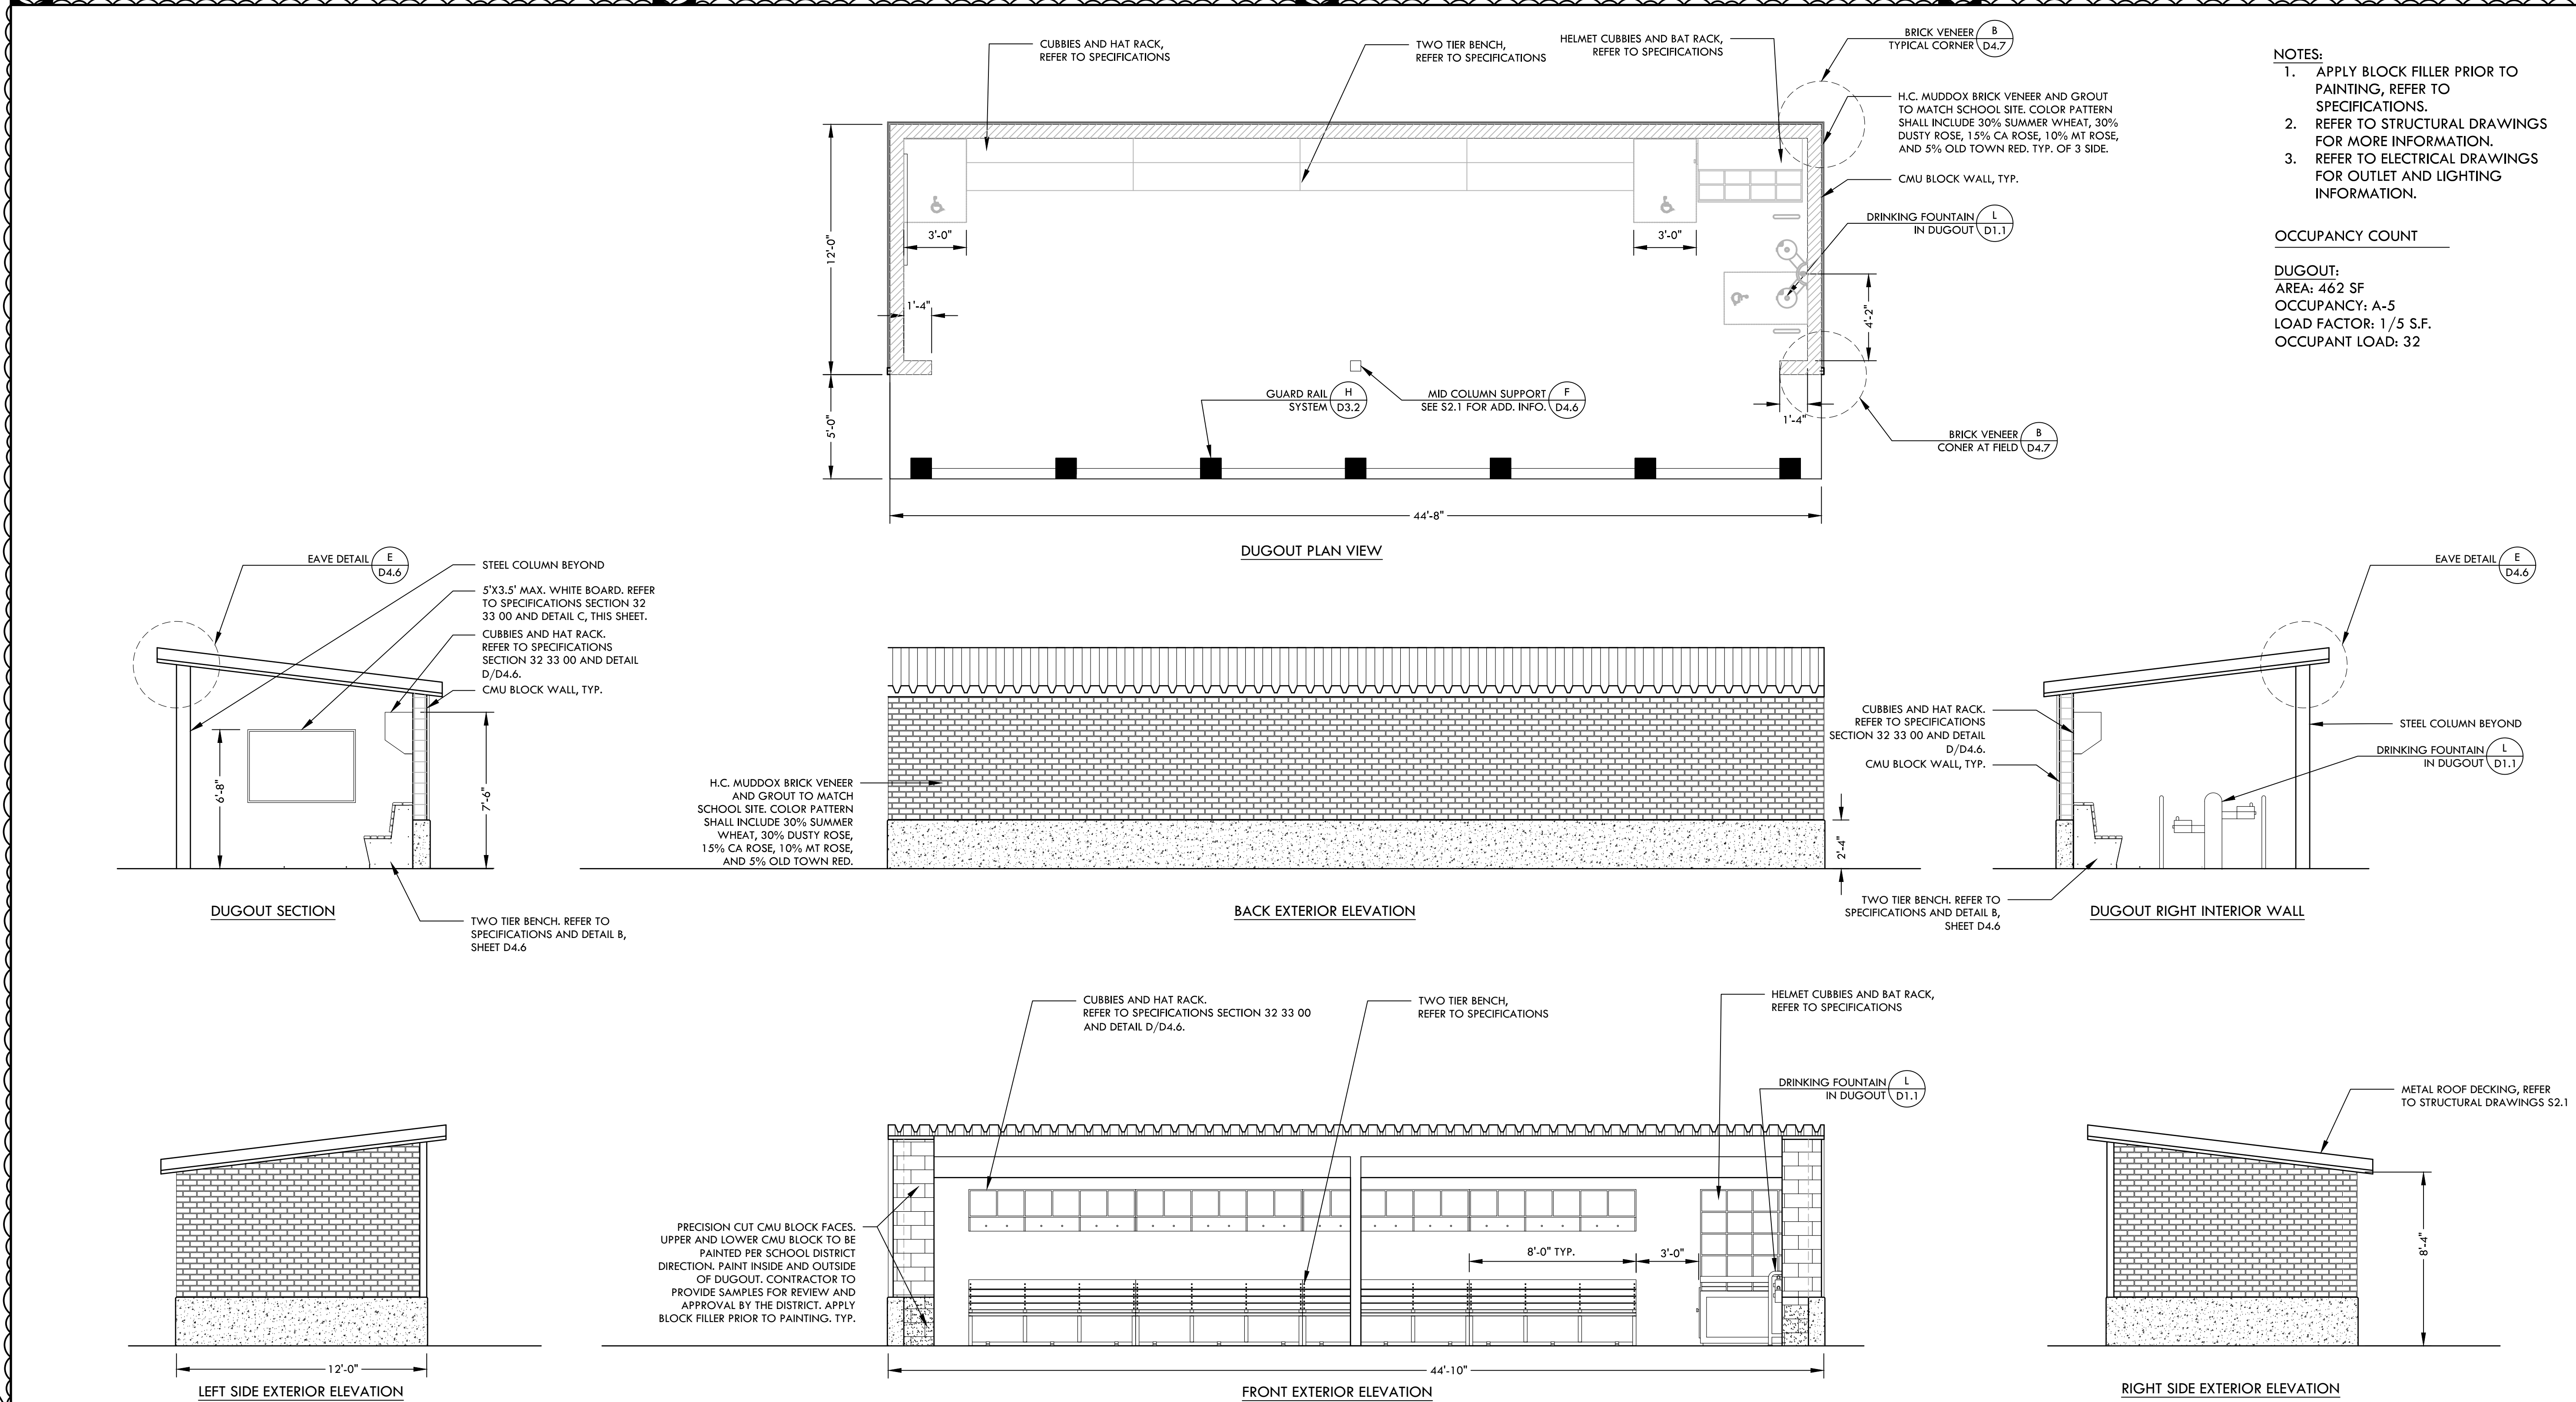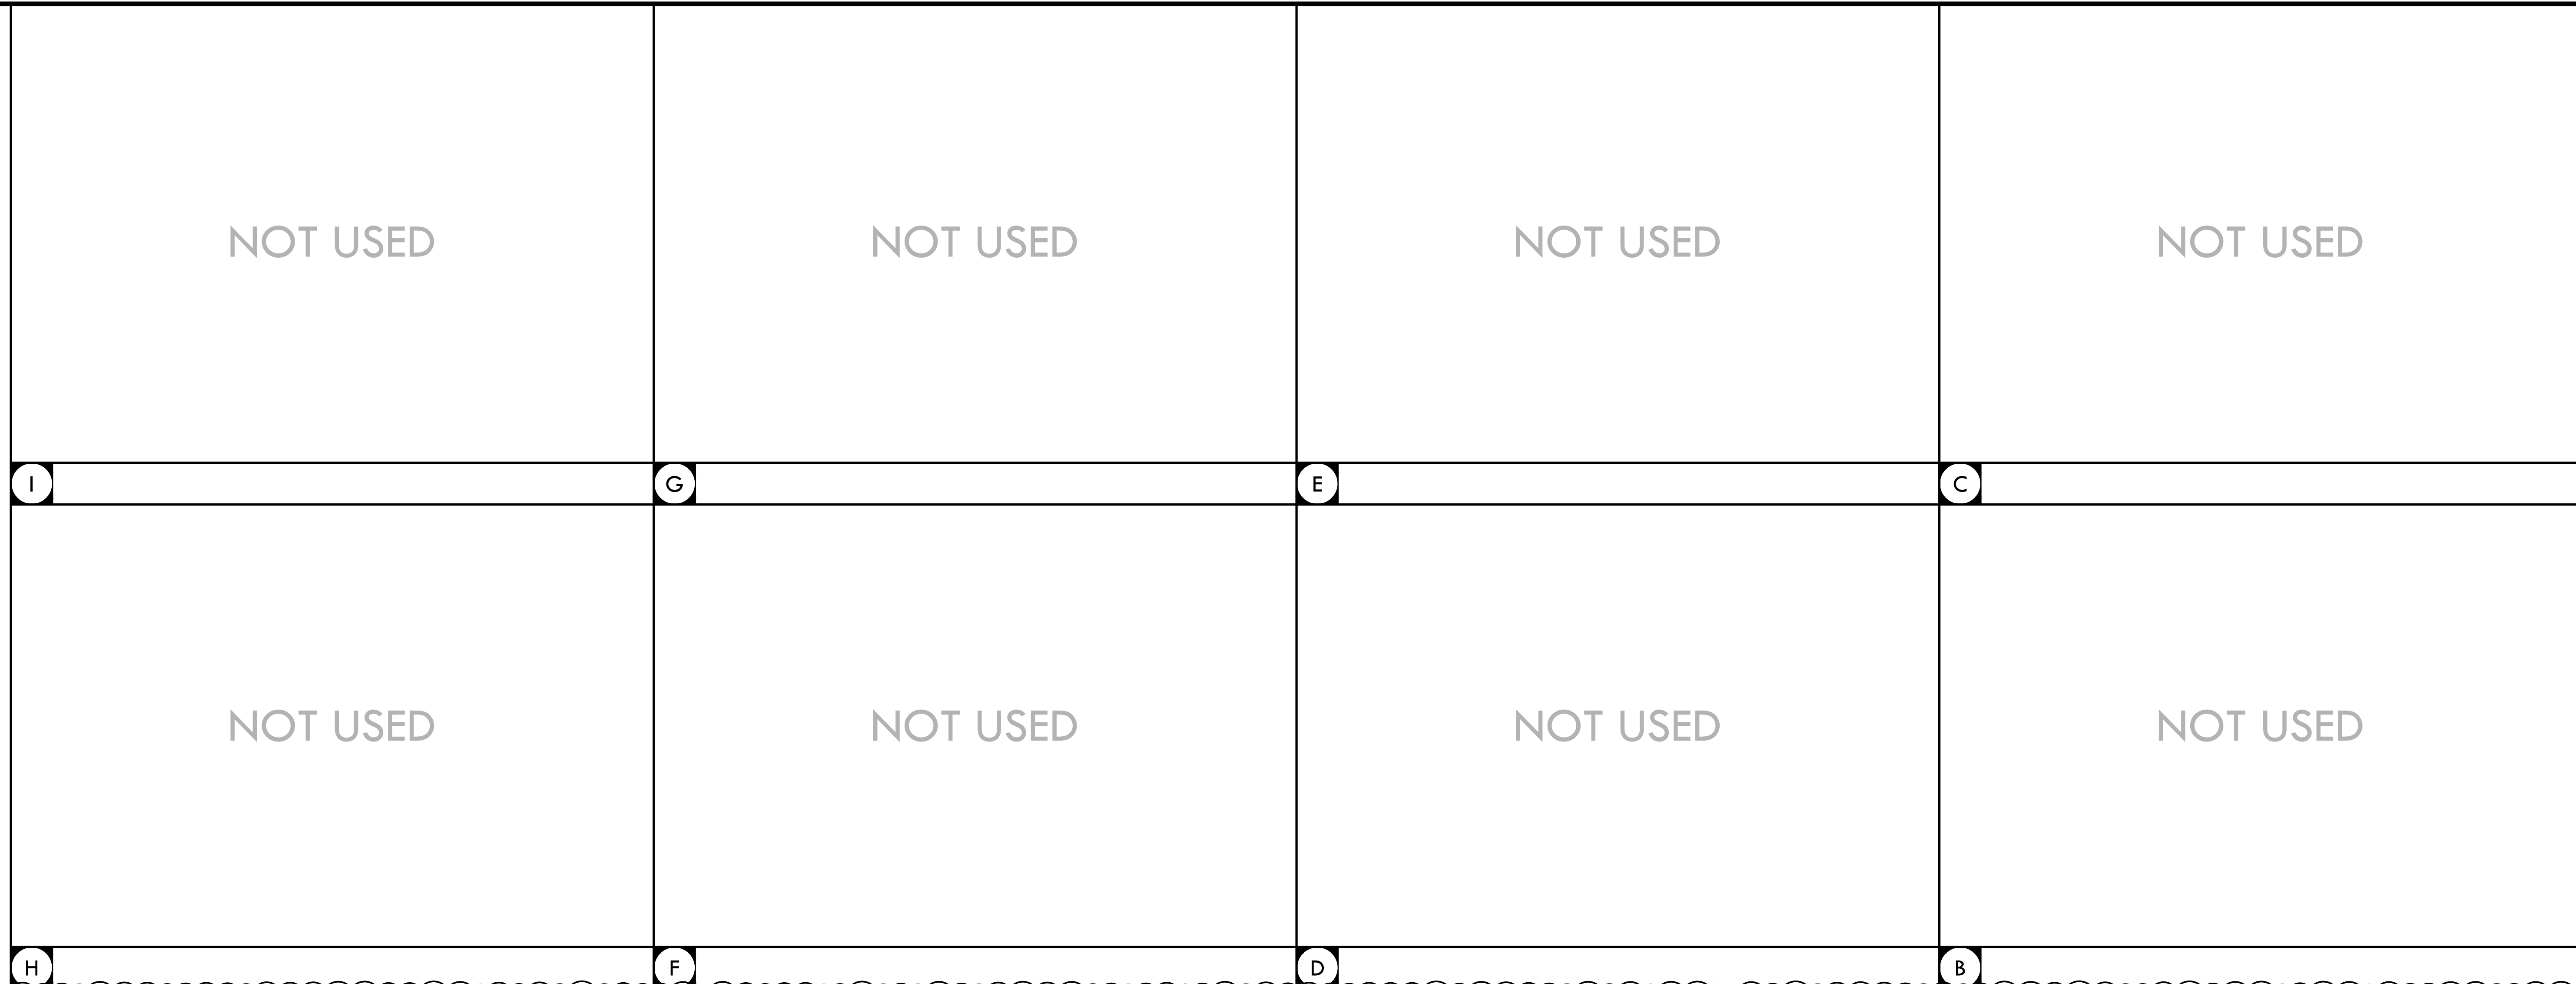

NOTES:
1. APPLY BLOCK FILLER PRIOR TO PAINTING, REFER TO SPECIFICATIONS.
2. REFER TO STRUCTURAL DRAWINGS FOR MORE INFORMATION.
3. REFER TO ELECTRICAL DRAWINGS FOR OUTLET AND LIGHTING INFORMATION.

OCCUPANCY COUNT
DUGOUT:
AREA: 462 SF
OCCUPANCY: A-5
LOAD FACTOR: 1/5 S.F.
OCCUPANT LOAD: 32

A SOFTBALL DUGOUT - 1ST BASE SIDE (VISITOR) NTS D4.8

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DRAWING NAME: I:\Projects\FO\2022\2203200 - Hiram Johnson Golf Baseball Softball CAD_D18-BASEBALL SOFTBALL.dwg
PLOT DATE: 09-15-22 PLOTTED BY: station27

CONSTRUCTION DETAIL - SOFTBALL DUGOUTS

NOT USED

NOT USED

NOT USED


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Tel: 916.415.6554
Fax: 916.415.6525
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CONSULTANT

KEYMAP

SHEET TITLE

CONSTRUCTION DETAILS -
SOFTBALL DUGOUTS

PROJECT NAME

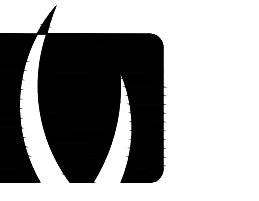HIRAM JOHNSON
HIGH SCHOOL
GOLF PRACTICE FACILITY,
VARSITY BASEBALL AND
SOFTBALL FIELDS

PROJECT ADDRESS

6879 14TH AVENUE
SACRAMENTO, CA 95820

SUBMITTAL	DATE
DD 50% SUBMITTAL	04/15/22
100% DSA SUBMITTAL	05/27/22
DSA BACK CHECK	08/11/22
DSA ADDENDUM SUBMITTAL	09/16/22

NO.	REVISIONS	DATE
▲	ADDENDUM	09/16/22
▲		
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DRAWN BY VDI	CHECKED BY MB/CS
DATE ISSUED 09/16/2022	SCALE AS NOTED

PROJ. NO. 2203200








SHEET NO. D4.9

- NOTES:
1. APPLY BLOCK FILLER PRIOR TO PAINTING, REFER TO SPECIFICATIONS.
 2. REFER TO STRUCTURAL DRAWINGS FOR MORE INFORMATION.
 3. REFER TO ELECTRICAL DRAWINGS FOR OUTLET AND LIGHTING INFORMATION.

OCCUPANCY COUNT

DUGOUT:
AREA: 462 SF
OCCUPANCY: A-5
LOAD FACTOR: 1/5 S.F.
OCCUPANT LOAD: 32

STORAGE:
AREA: 106 SF
OCCUPANCY: A-5
LOAD FACTOR: 1/300 S.F.
OCCUPANT LOAD: 1

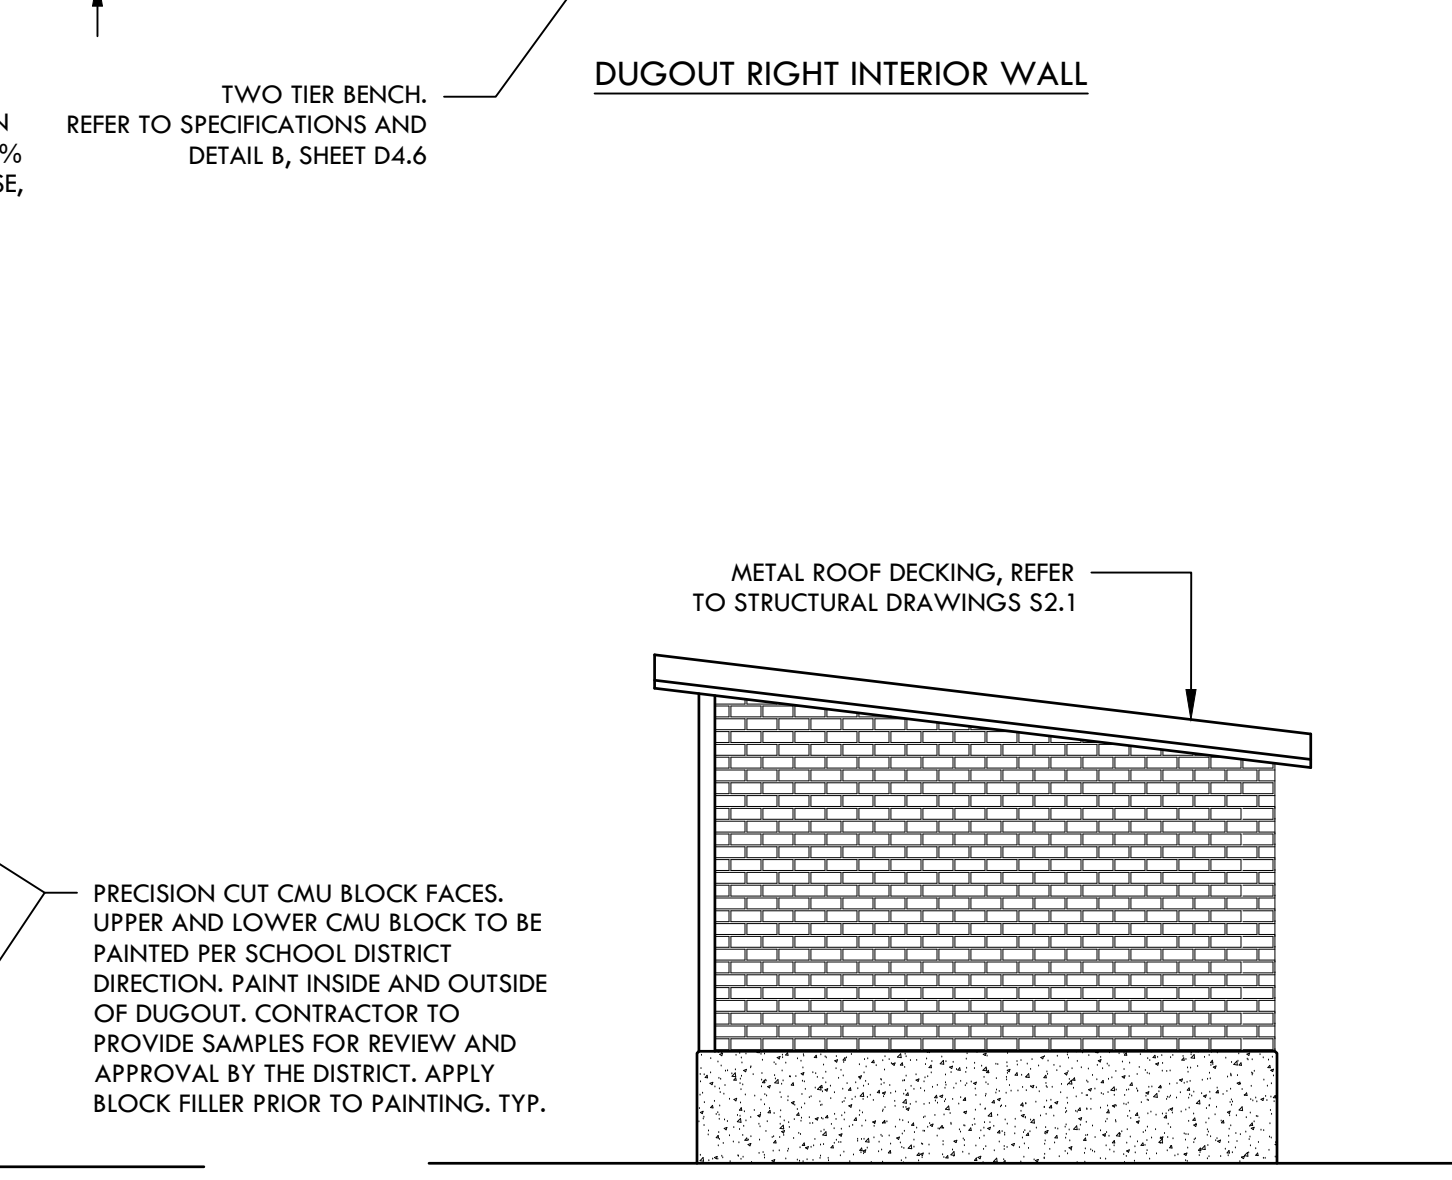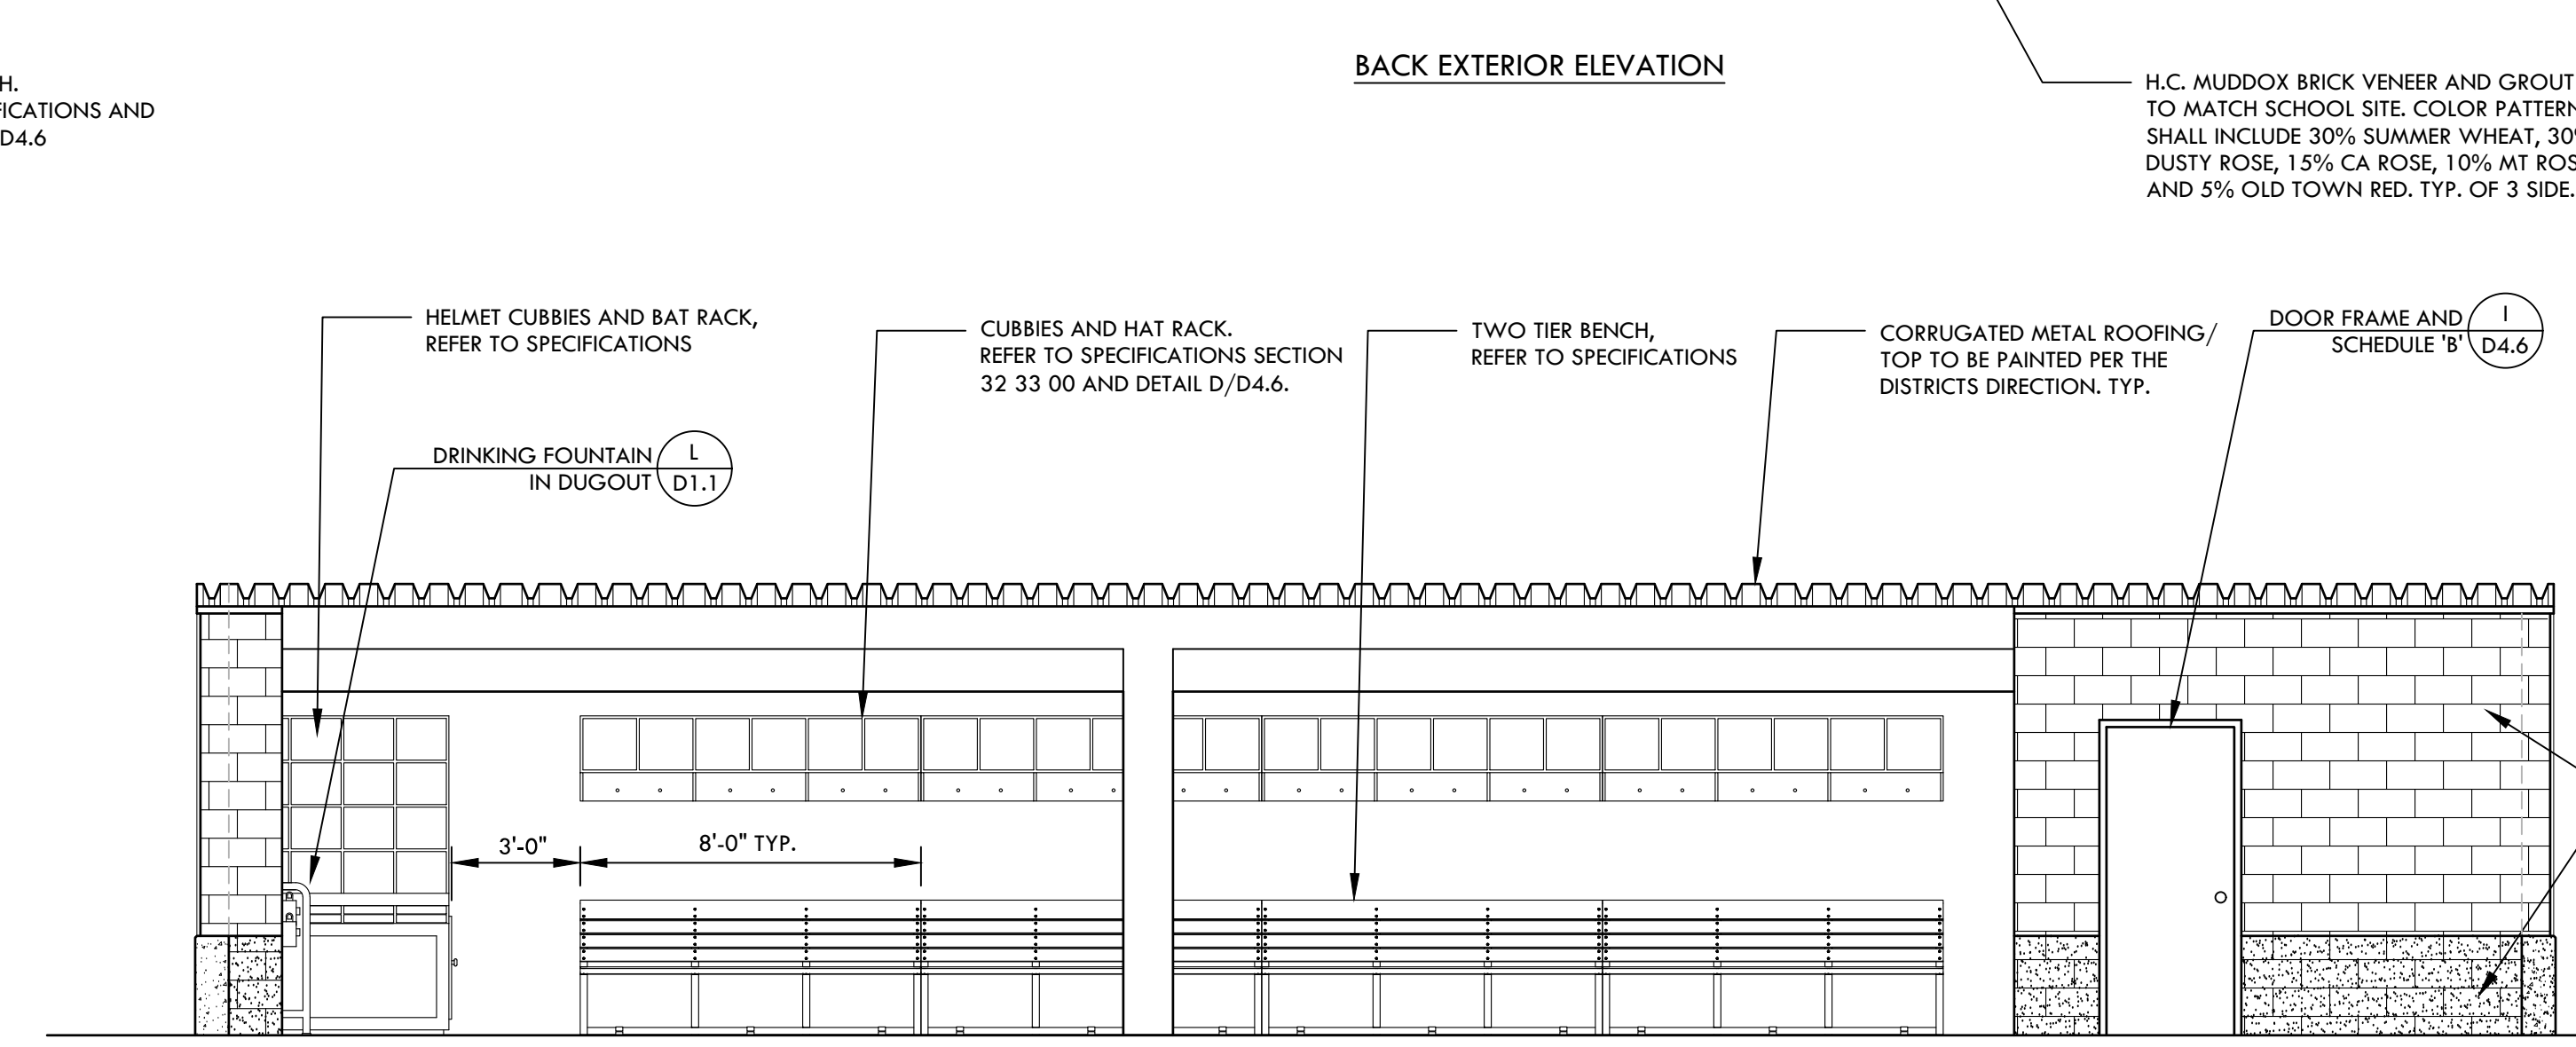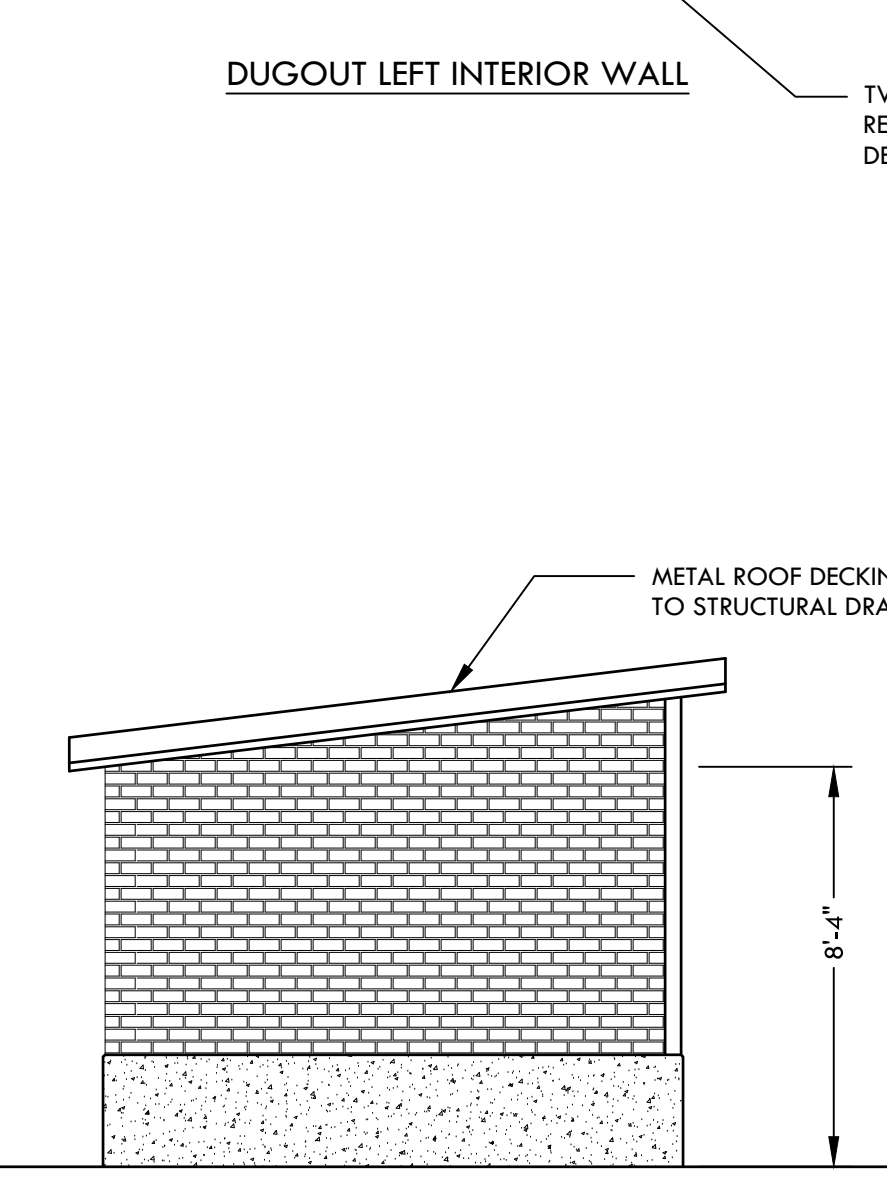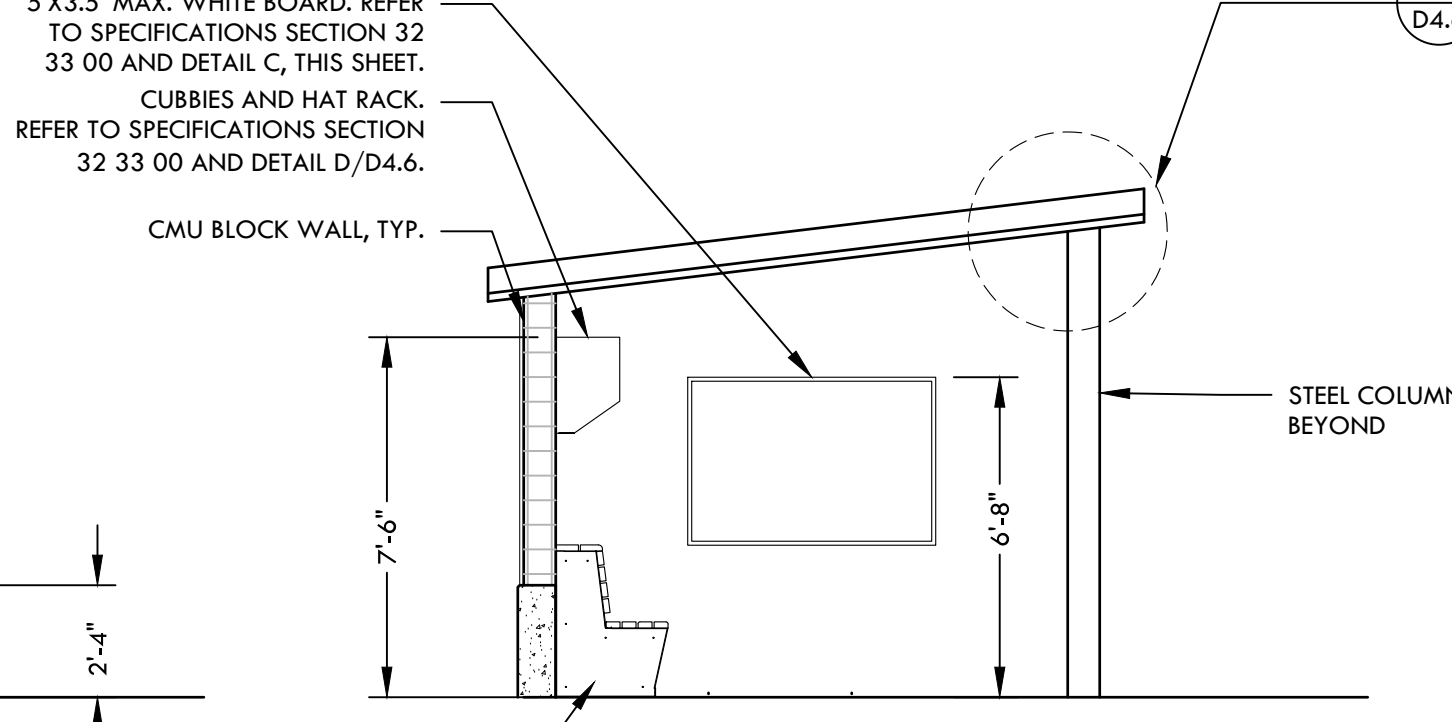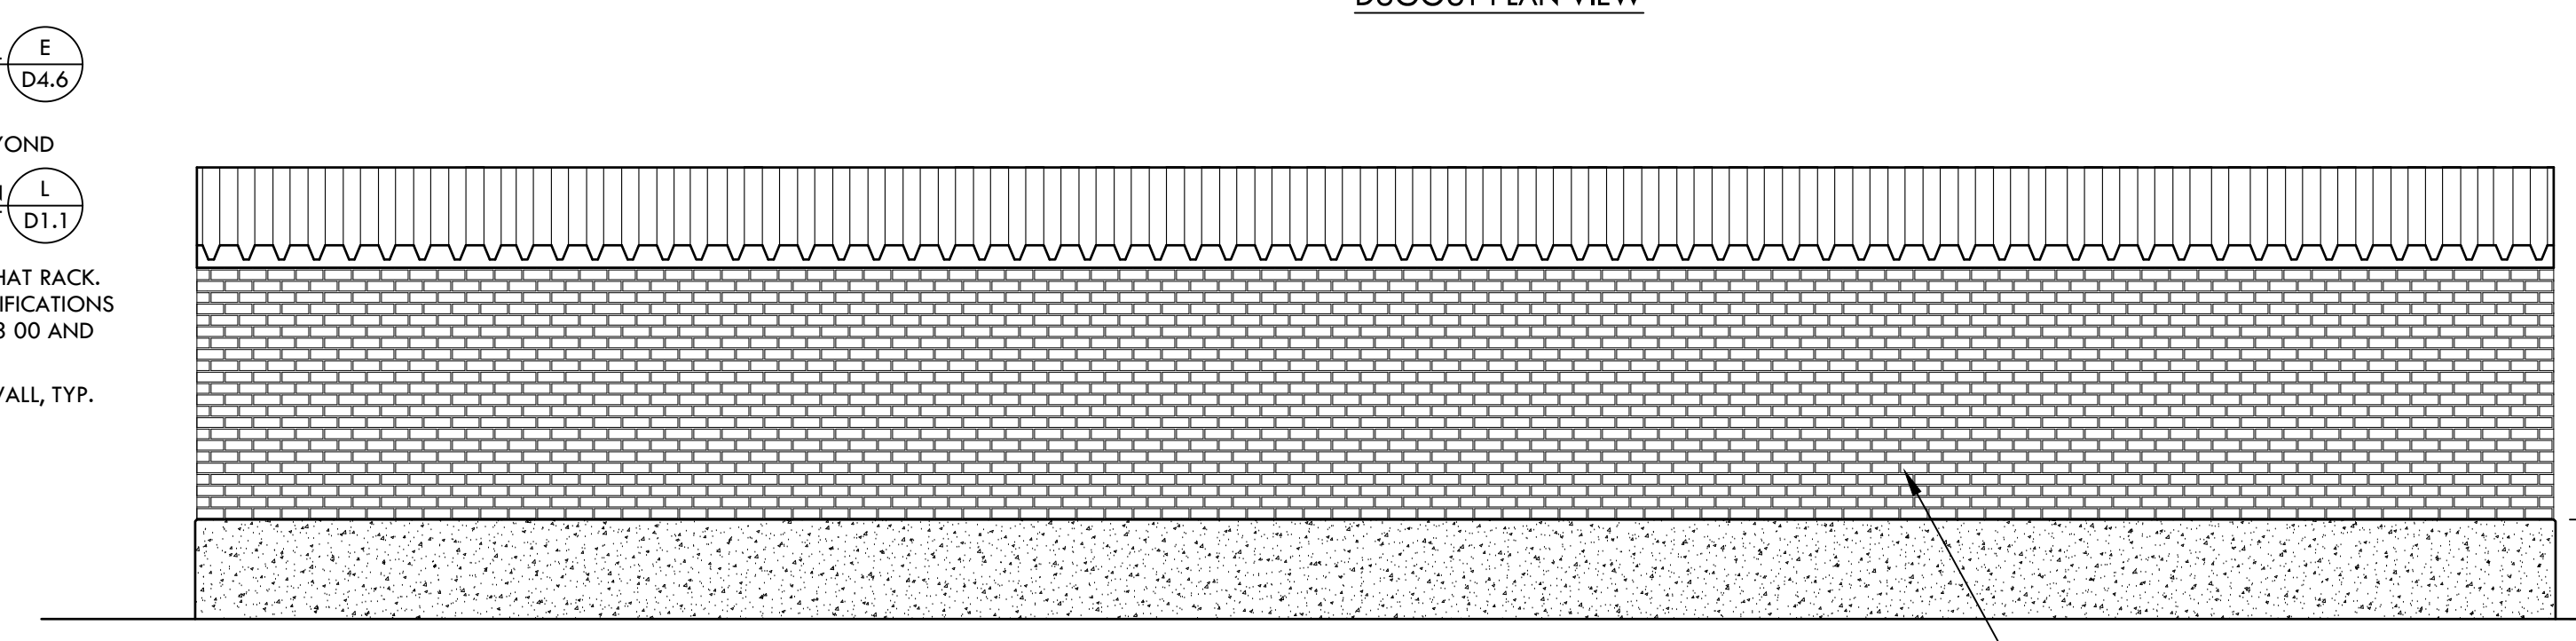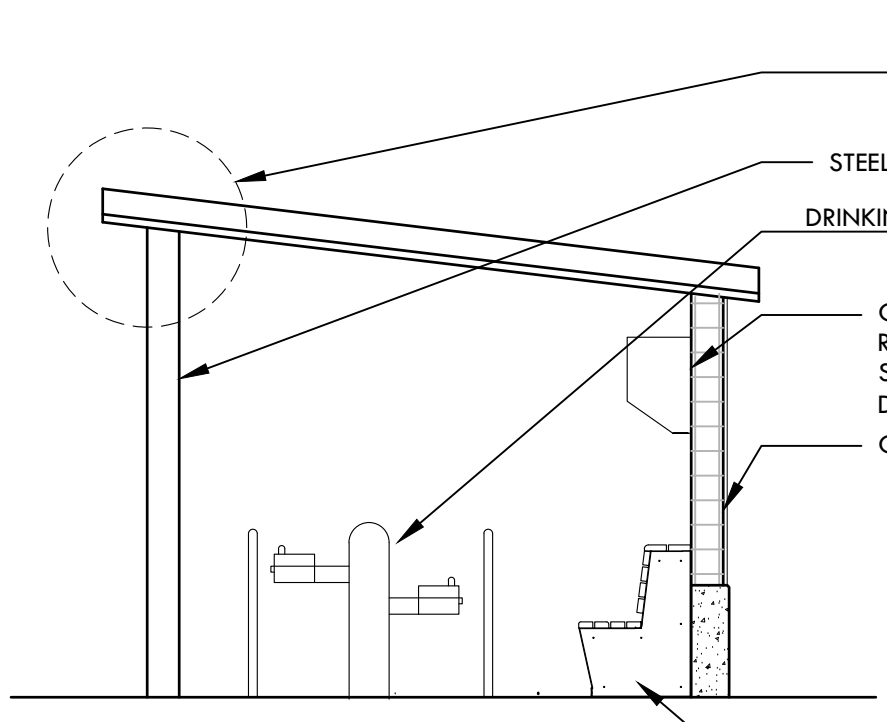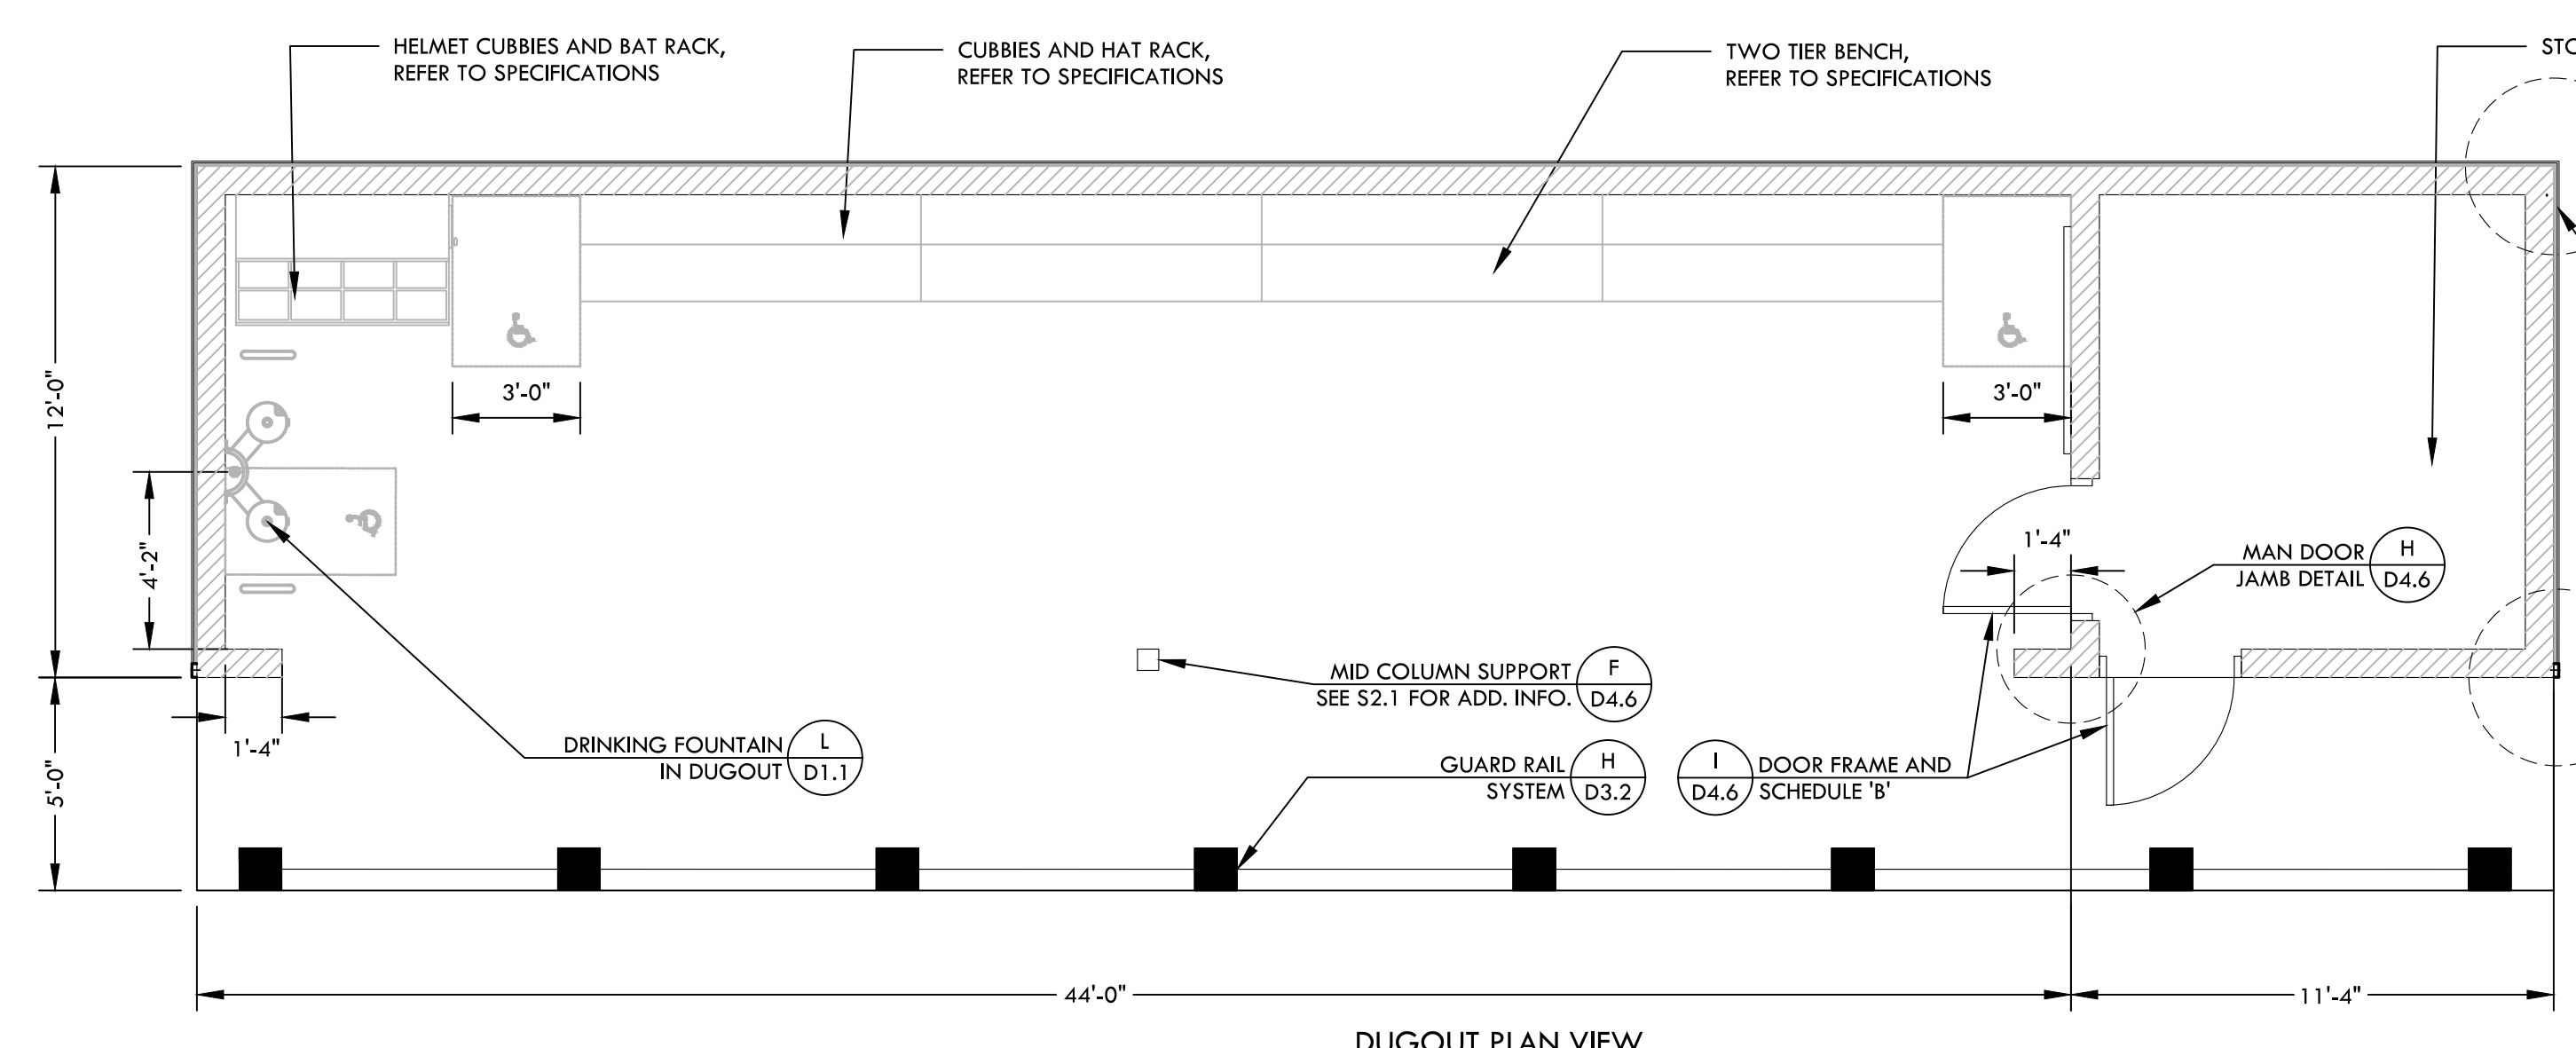

A SOFTBALL DUGOUT - 3RD BASE SIDE (HOME)


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CONSTRUCTION DETAIL - SOFTBALL DUGOUTS

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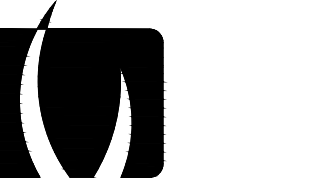
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NOT USED



NOTES PERTAIN TO ALL DETAILS WITH SYNTHETIC TURF.

- IDENTIFIED FINISH GRADES OF SYNTHETIC TURF SHALL BE THE TOP OF INFILL MATERIAL. INFILL MATERIAL SHALL BE 1/2" BELOW ADJACENT SURFACES UNLESS EDGE IS A VERTICAL CURB. REFER TO GOLF DETAIL THIS SHEET FOR INFILL DEPTH.
- NO MANUFACTURER, CONTRACTOR OR VENDOR LOGOS ARE TO BE INSTALLED UNLESS SPECIFIED.
- NO CUT OUTS IN TURF SHALL BE MADE UNLESS OTHERWISE NOTED AND ESPECIALLY NO CUT OUTS IN THE FIELD OF PLAY. QUICK COUPLERS AND CLEANOUTS ARE THE ONLY UTILITIES TO BE CUT THROUGH TURF. QUICK COUPLERS ARE LOCATED ON THE PERIMETER AND OUT OF THE FIELD OF PLAY AREAS.

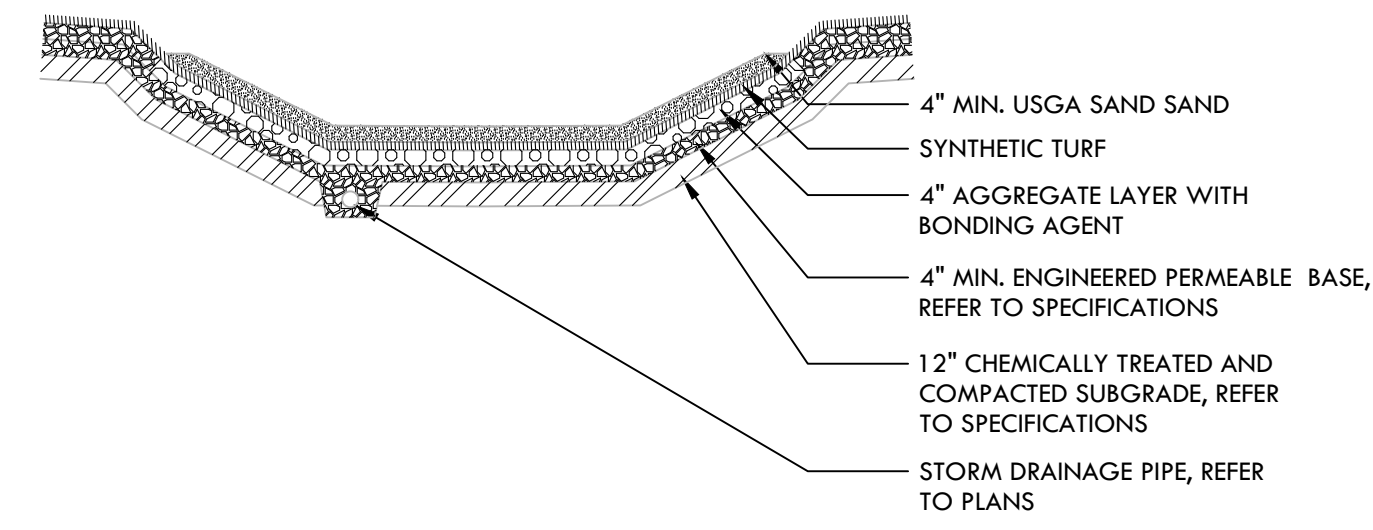

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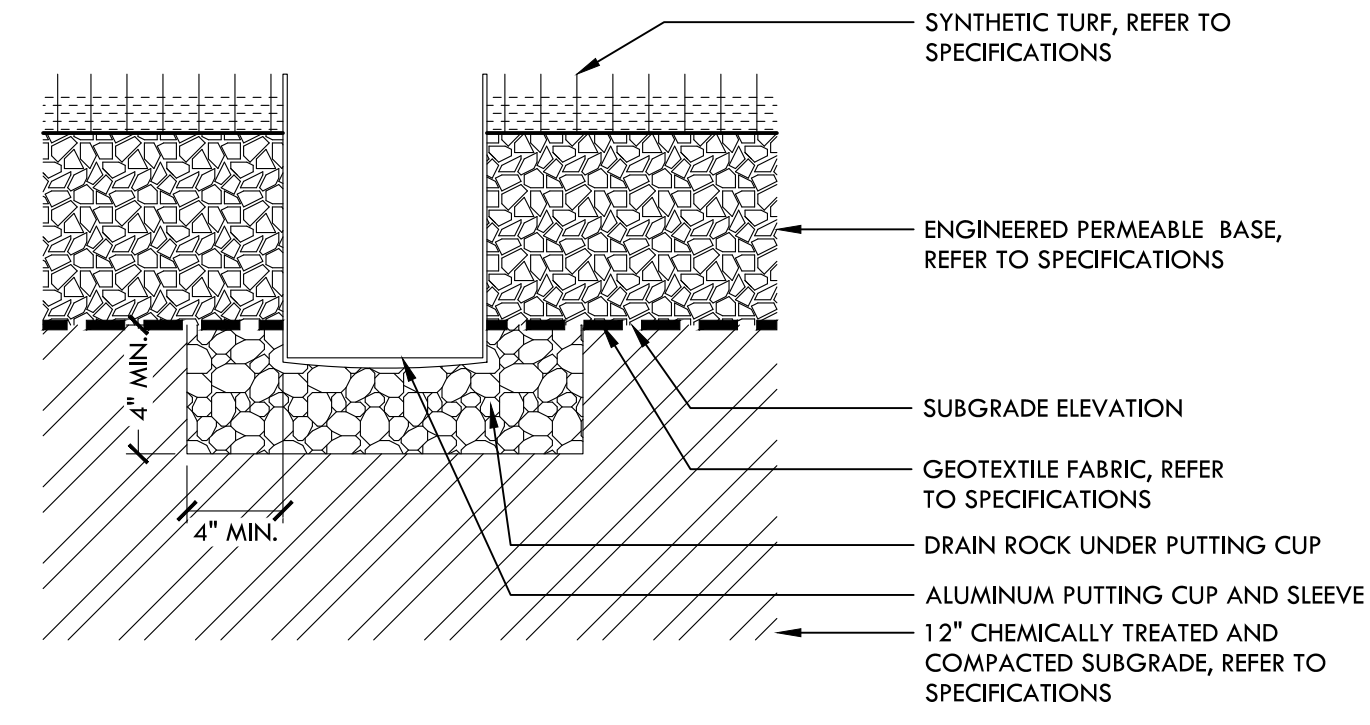
NTS

E

SYNTHETIC TURF NOTES


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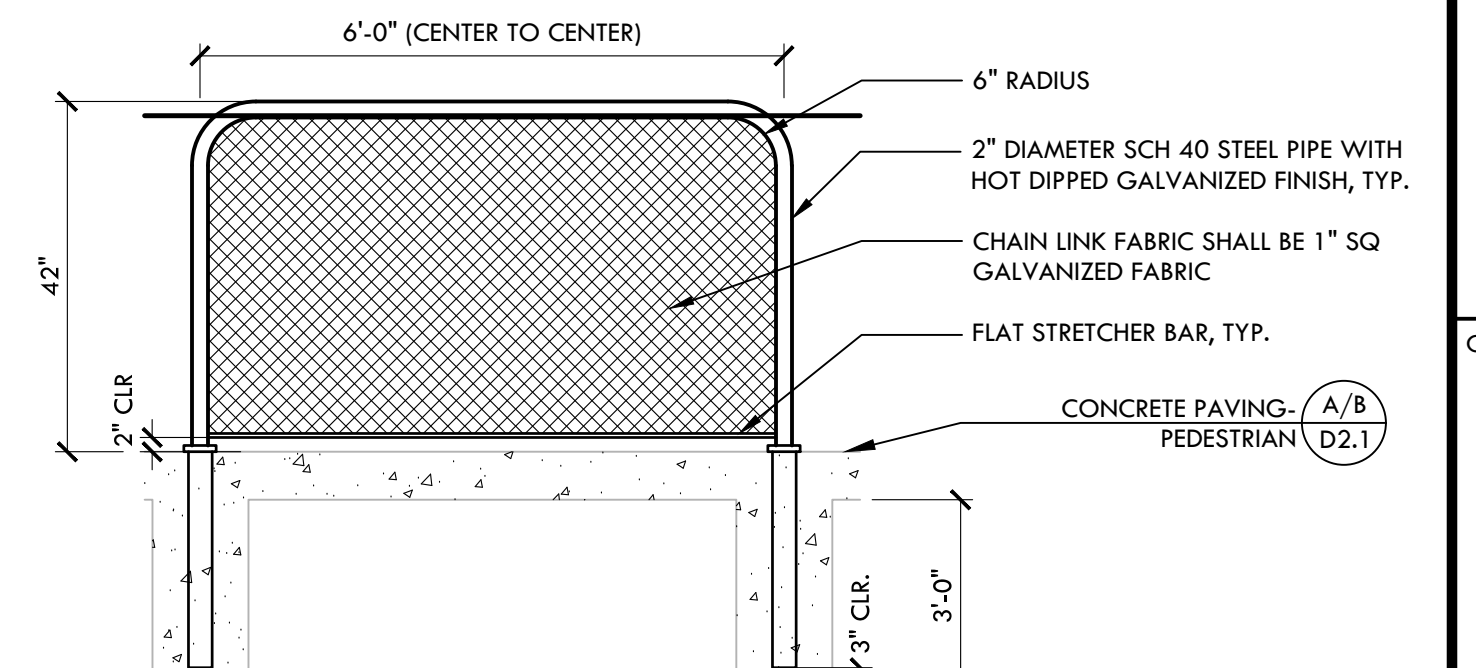
SYNTHETIC TURF SECTION

NOTE: REFER TO SYNTHETIC TURF NOTES, DETAIL E, THIS SHEET.



SYNTHETIC TURF SECTION

NOTE: REFER TO SYNTHETIC TURF NOTES, DETAIL E, THIS SHEET.

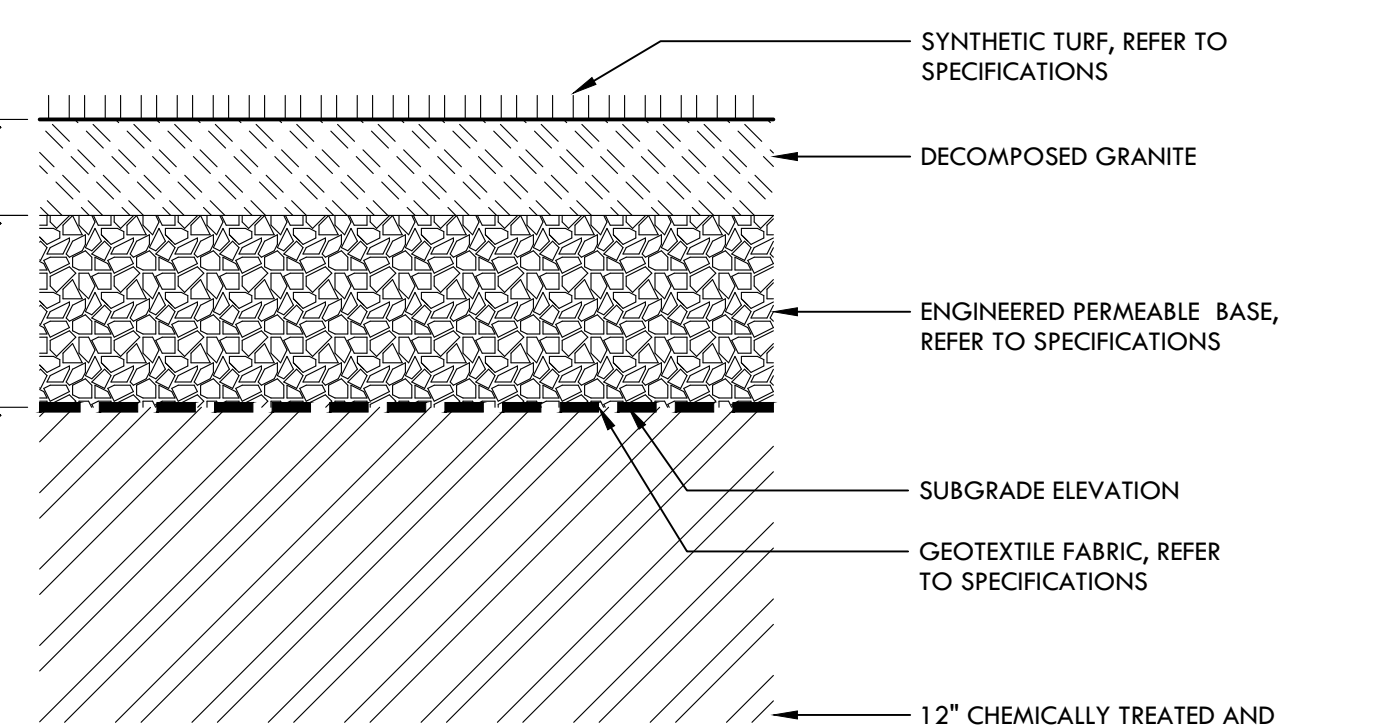

- NOTE:
- ALL PIPE TO BE SCHEDULE 40 WITH 1/2" THICKNESS, & SHALL BE GALVANIZED FINISH. VARIES, REFER TO PLANS.
 - ALL JOINTS SHALL BE FILLET WELD; GRIND SMOOTH JOINTS; TREAT ALL FINISHED WELDS WITH GALVANIZING.
 - ALL RAILINGS TO BE SHOP FABRICATED FOR FIELD INSTALLATION.
 - THIS DRAWING IS FOR DESIGN INTENT ONLY. SUBMIT SHOP DRAWING TO SHOW MATERIAL, WELDS AND FASTENERS.

K

I

SYNTHETIC TURF - PUTTING GREEN CUP

NTS

F



SYNTHETIC TURF - PUTTING GREEN SECTION

NTS

D


GUARD RAIL

NTS

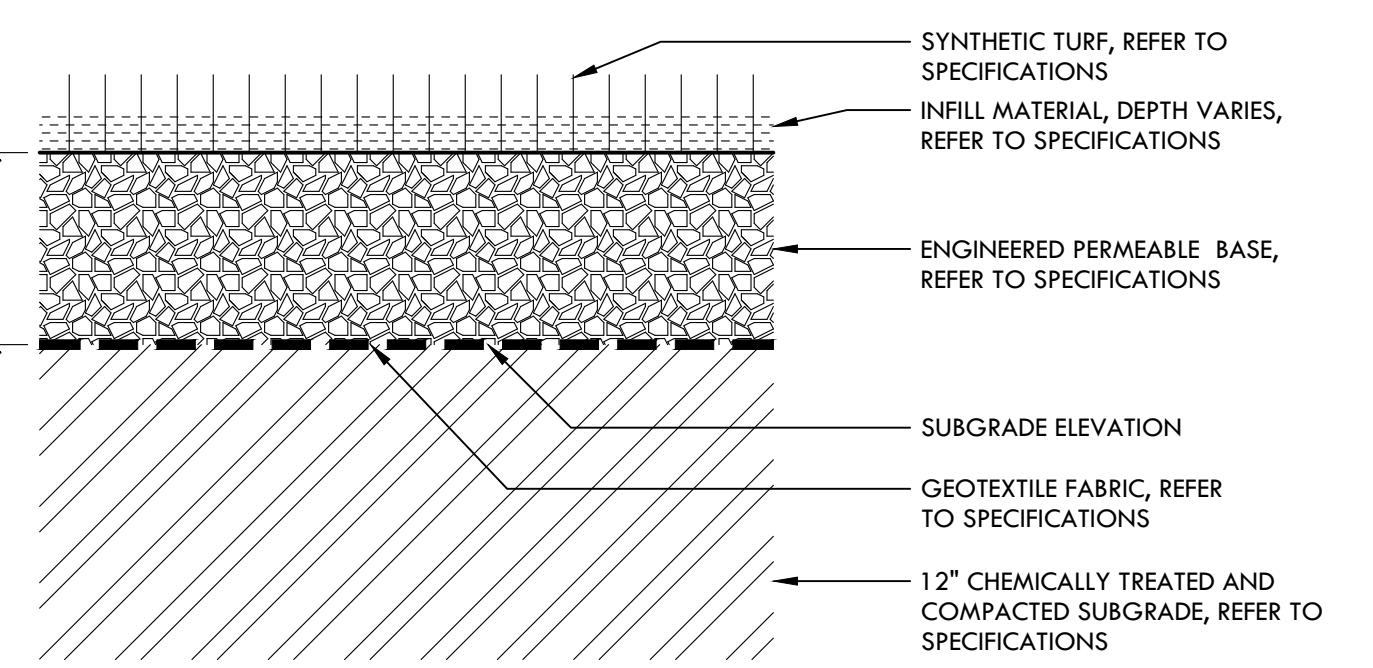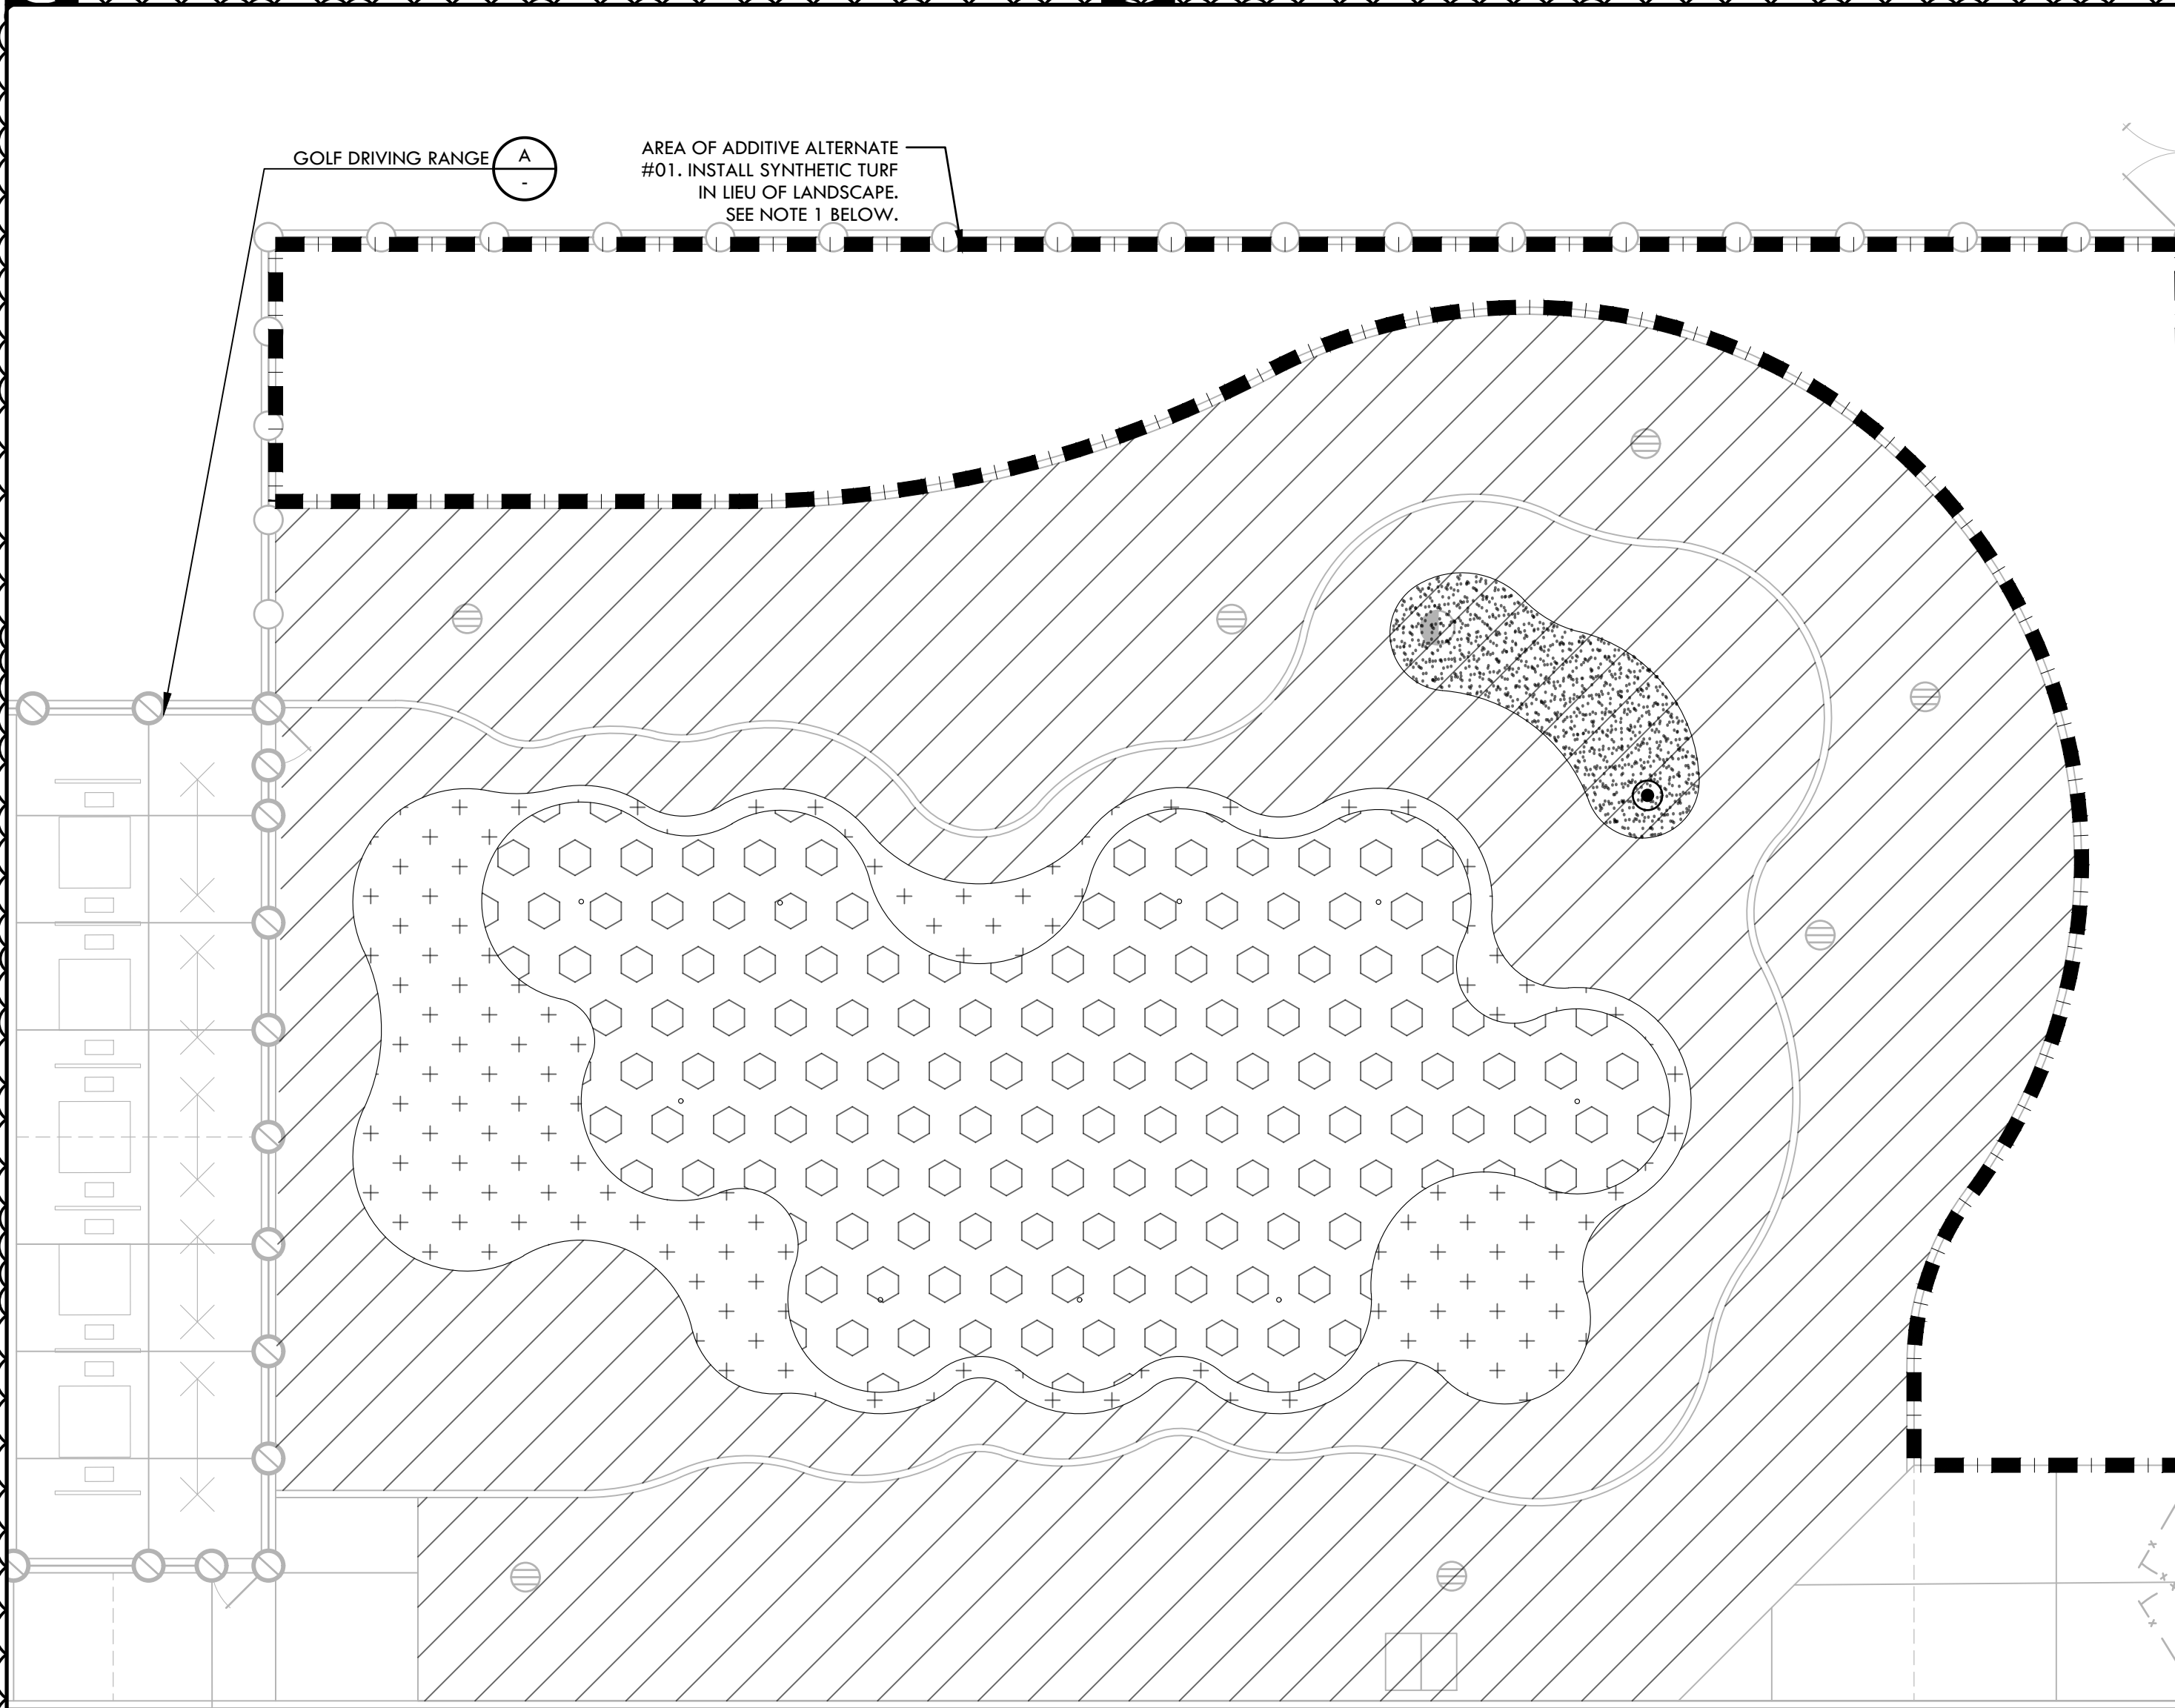

SYNTHETIC TURF SECTION

NOTE: REFER TO SYNTHETIC TURF NOTES, DETAIL E, THIS SHEET.

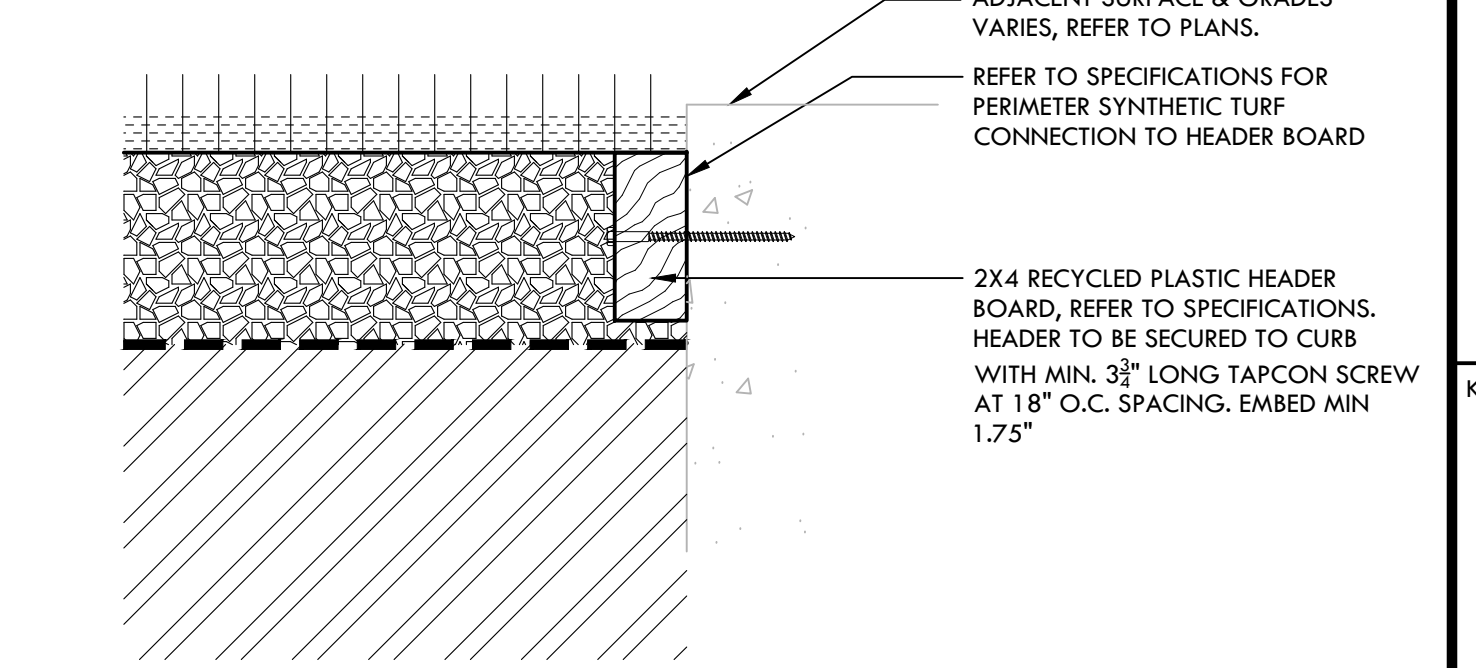


SYNTHETIC TURF CONNECTION

C

SYNTHETIC TURF - 2ND CUT AND FRINGE

NTS

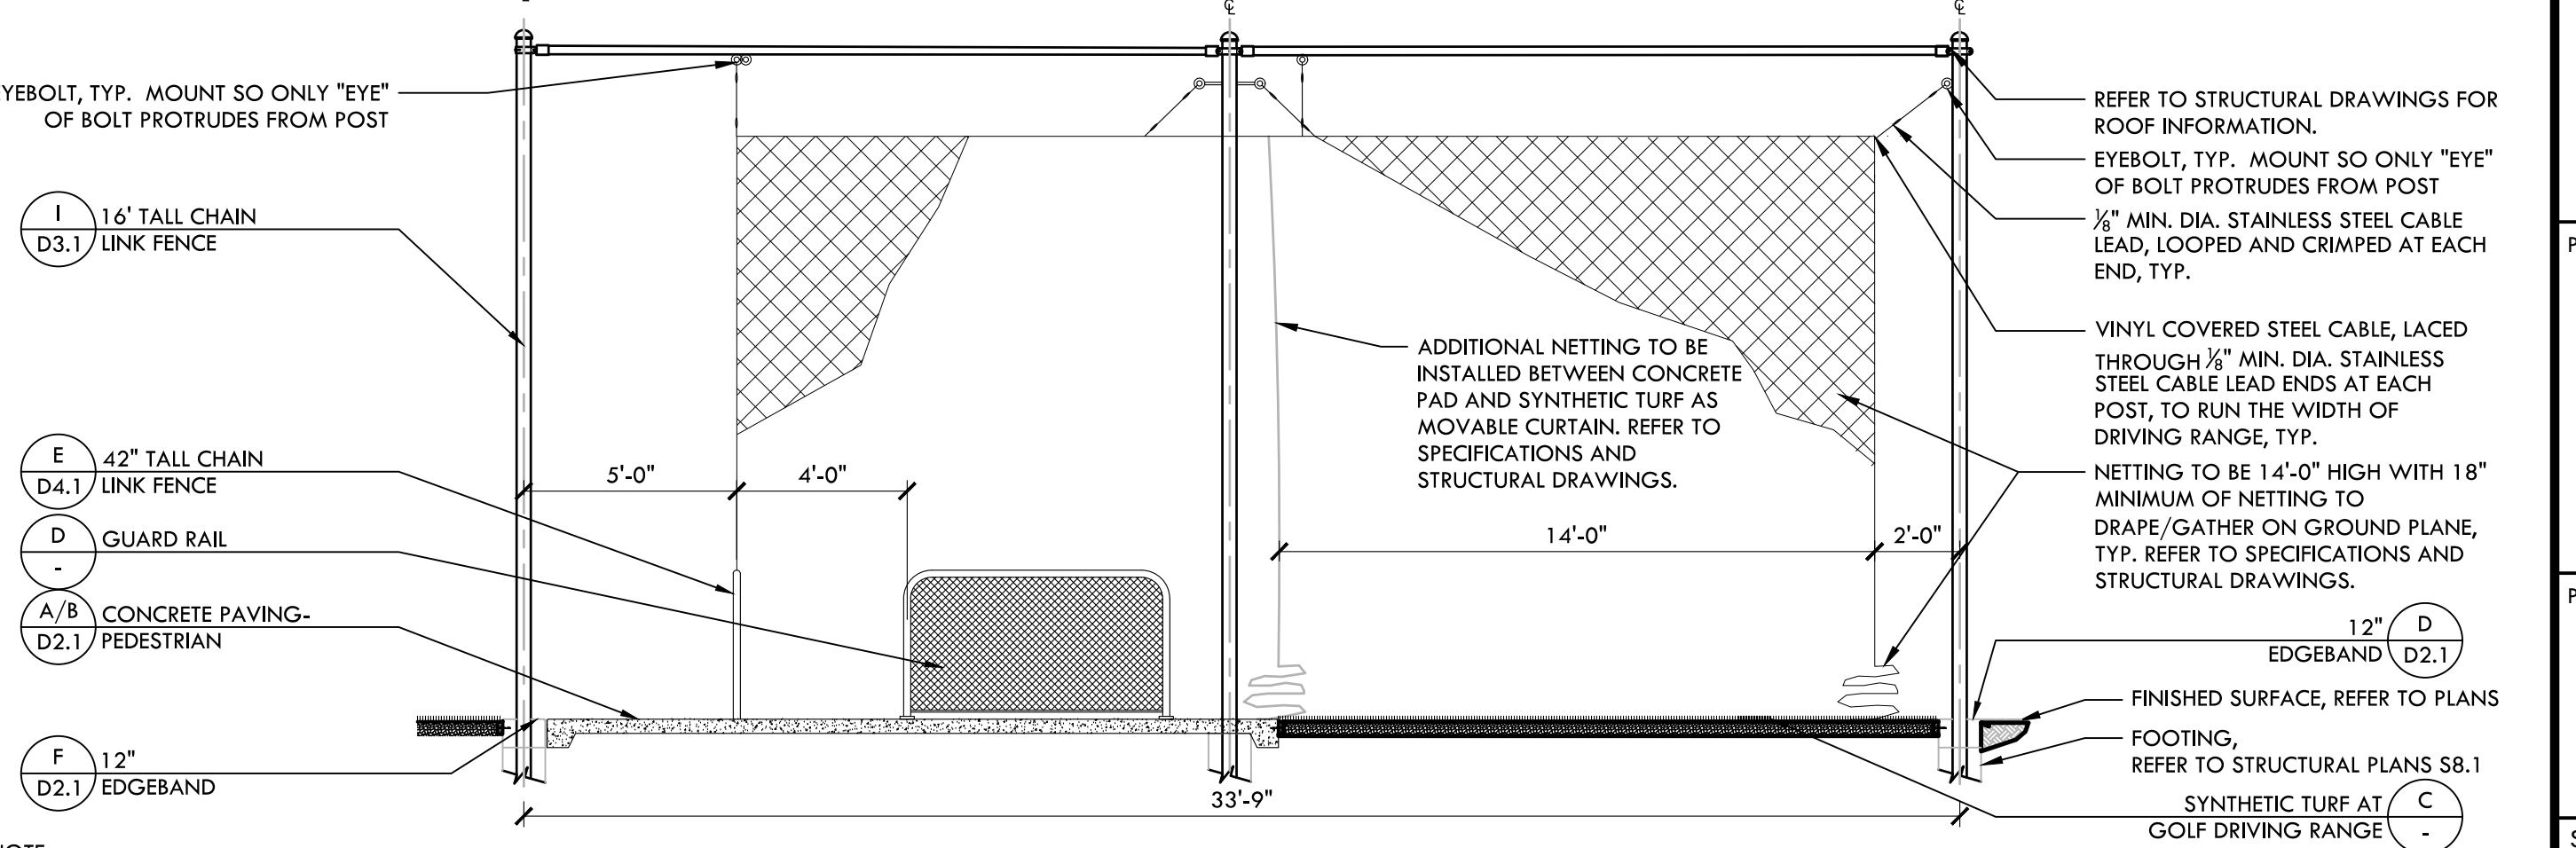


NOTE: REFER TO STRUCTURAL PLANS FOR MORE INFORMATION.

B

GOLF DRIVING RANGE - SECTION

NTS

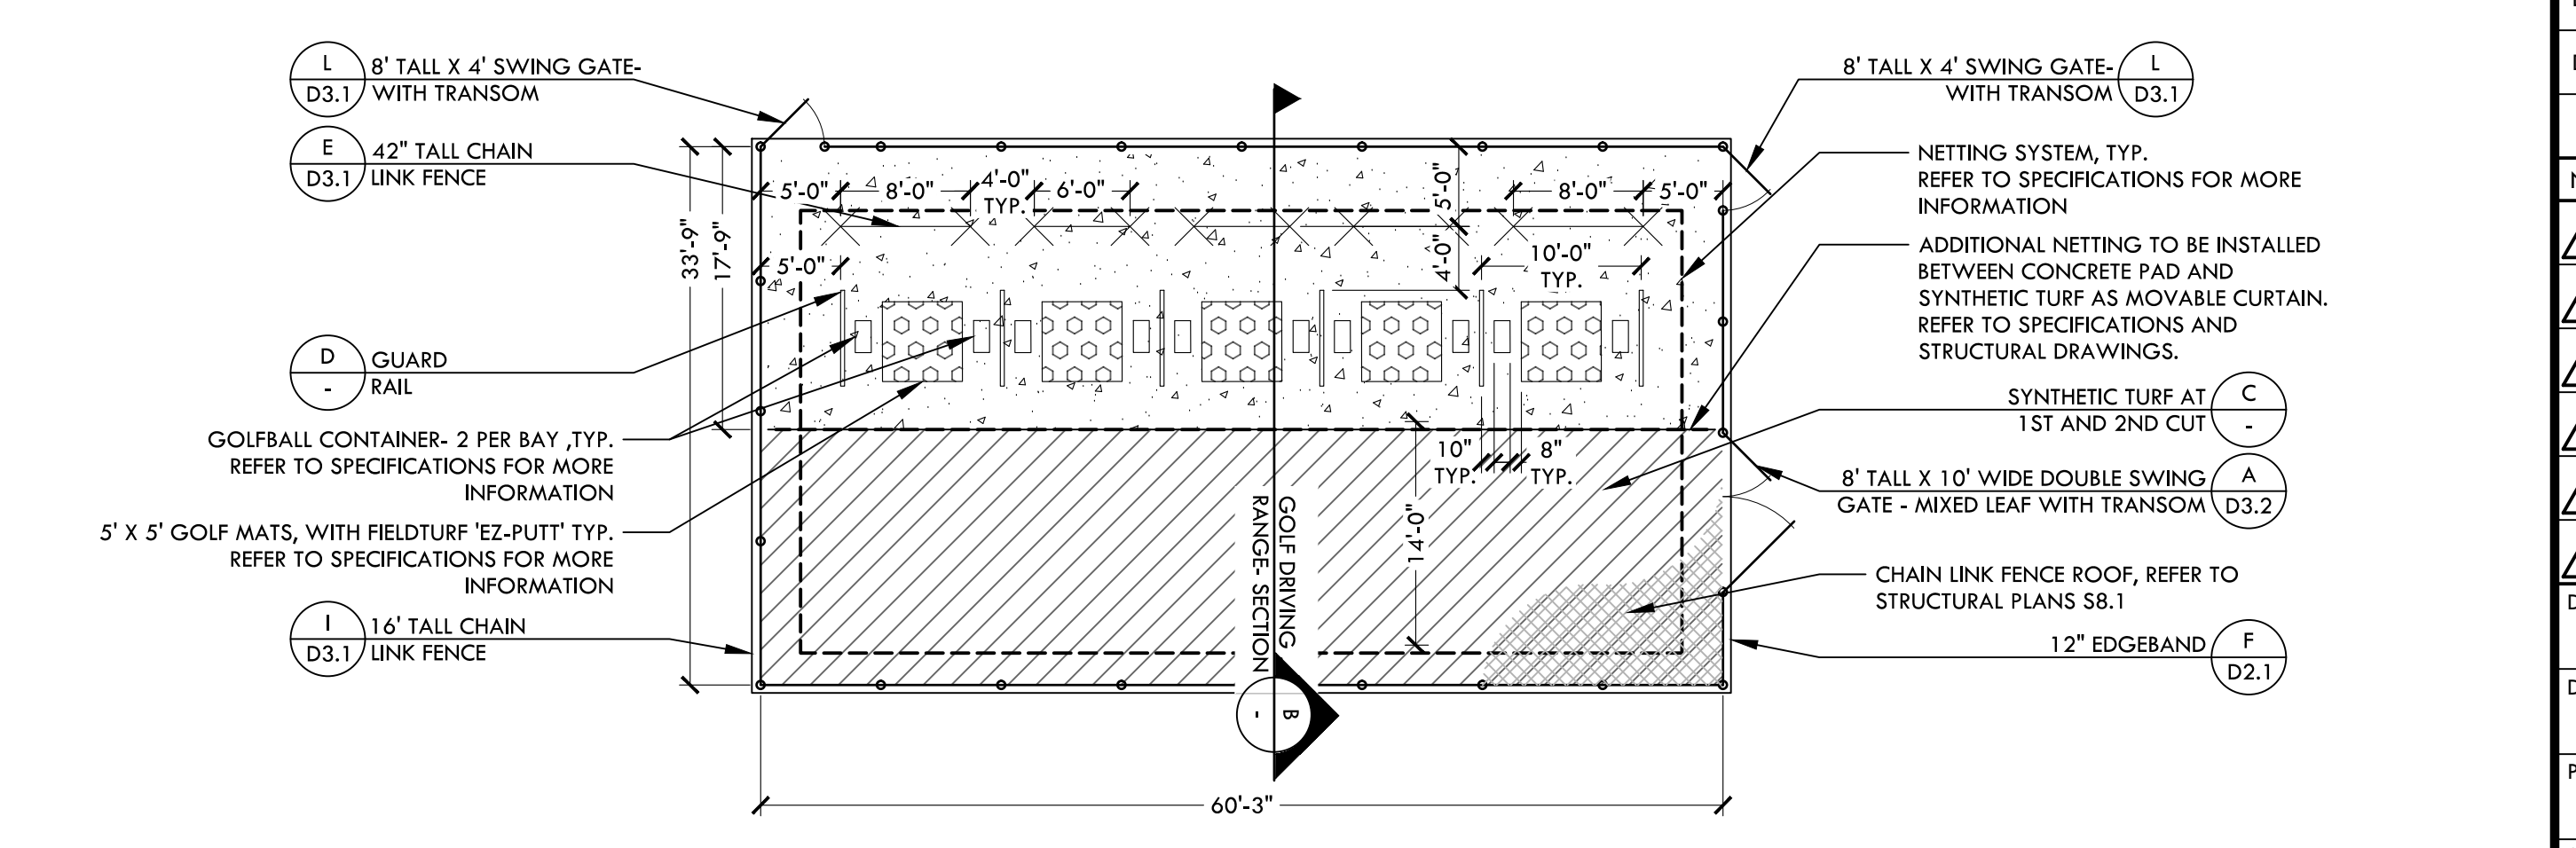

LEGEND

	PUTTING GREEN PRODUCT: FIELDTURF 'EZ-PUTT' PILE HEIGHT: 0.5"		2ND CUT PRODUCT: FIELDTURF 'ZL11' PILE HEIGHT: 2"
	FRINGE PRODUCT: FIELDTURF 'ZL02' PILE HEIGHT: 1"		BUNKER PRODUCT: USGA SAND OVER FIELDTURF 'ZL11'

- NOTE:
- IF ADDITIVE ALTERNATE 01 IS AWARDED, CONTRACTOR SHALL INSTALL FIELD TURF 'ZL11'. REFER TO MATERIALS PLAN FOR ADDITIONAL INFORMATION.
 - REFER TO SPECIFICATION FOR ADDITIONAL INFORMATION.

H


GOLF PUTTING GREEN

NTS

A

GOLF DRIVING RANGE - PLAN

NTS

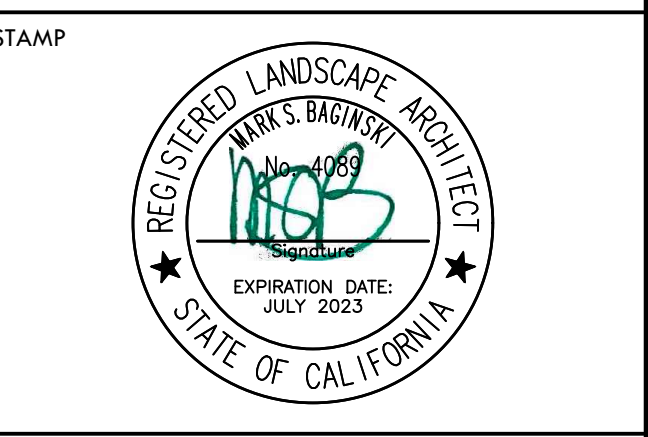

CONSULTANT

KEYMAP

SHEET TITLE

CONSTRUCTION DETAILS - GOLF

PROJECT NAME

**HIRAM JOHNSON
 HIGH SCHOOL
 GOLF PRACTICE FACILITY,
 VARSITY BASEBALL AND
 SOFTBALL FIELDS**

PROJECT ADDRESS

**6879 14TH AVENUE
 SACRAMENTO, CA 95820**

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100% DSA SUBMITTAL	05/27/22
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1	ADDENDUM	09/16/22

DRAWN BY: VDI
 CHECKED BY: MB/CS
 DATE ISSUED: 09/16/2022
 SCALE: AS NOTED
 PROJ. NO.: 2203200

SHEET NO. D5.1


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NOT USED

E

NOTE:
FOR FURTHER INSTALLATION INSTRUCTIONS REVIEW CREATIVE SENSOR TECHNOLOGY INSTALLATION LITERATURE.
PIPE SIZE TRANSITIONS MUST BE MADE 10 PIPE DIAMETERS UPSTREAM AND 5 DIAMETERS DOWNSTREAM OF SENSOR. MAKE SURE DIRECTION ARROW POINTS IN DIRECTION OF FLOW.

SIZING CHART:	MODEL	SIZE	OPERATING RANGE-GPM
FS1400	4"		10 - 480

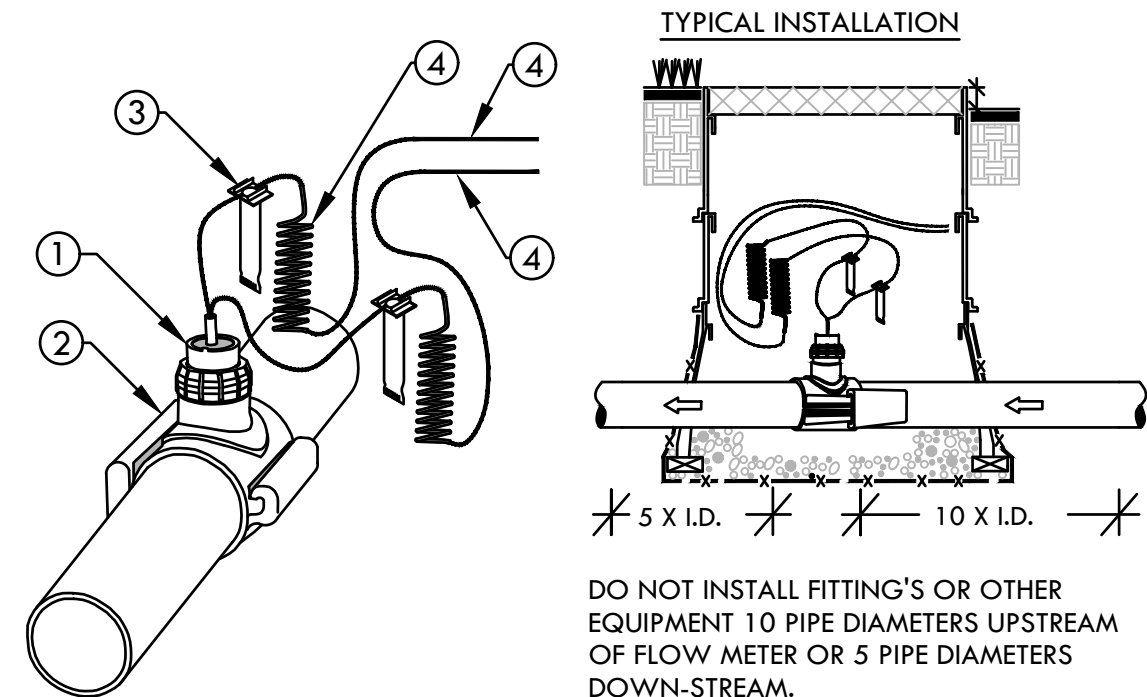


- SADDLE TYPE FLOW SENSOR - CREATIVE SENSOR TECHNOLOGY SERIES FS1-540-001. INSTALL WITH A CARSON 1419-12" BOX WITH REQUIRED EXTENSIONS. HEAT BRAND "FS" ON LID IN 2" HIGH BLOCK LETTERS.
- PVC SADDLE. SEE MATERIAL SCHEDULE ON PLANS FOR SIZE. CONTRACTOR WILL SPECIFY SIZE OF SADDLE WHEN ORDERING. USE 1 3/4-INCH HOLE SAW ONLY TO DRILL ENTRY HOLE IN PIPE.
- WATERPROOF WIRE SPLICE, 3M SCOTCHPAK OF EQUIVALENT, 2 SPLICES ARE REQUIRED.
- DIRECT BURIAL 1 PAIR, TWISTED SHIELDED CABLE—MINIMUM CONDUCTOR SIZE 20 AWG. INSTALL WITH A MINIMUM OF 30-INCH LOOPED WIRE EXPANSION COIL.

D

FLOW METER

NTS

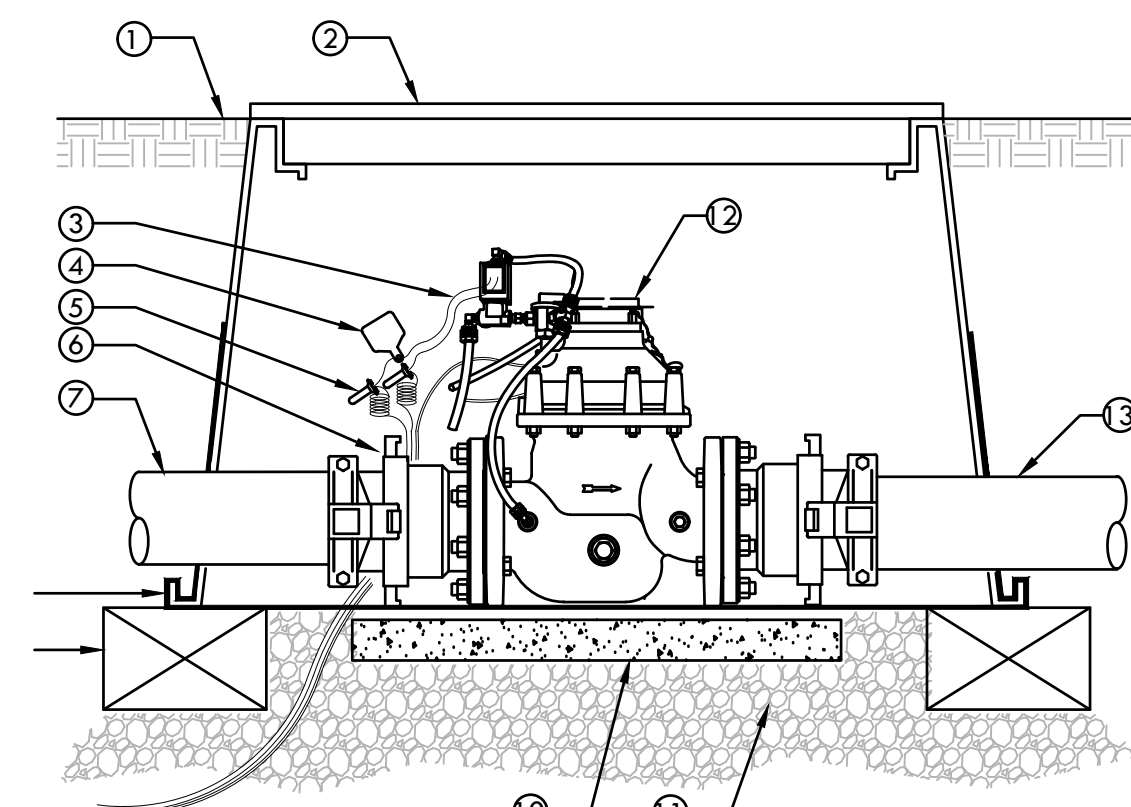

- FINISH GRADE
- CARSON 17"x30"x24" DEPTH BOX WITH EXTENSIONS. HEAT BRAND "MV" ON LID IN 2" HIGH BLOCK LETTERS.
- MASTER VALVE WIRES FROM SOLENOID.
- VALVE I.D. TAG WITH "MV" PRINTED ON IT.
- MASTER VALVE CONTROL WIRE FROM CONTROLLER. PROVIDE 3M-DBY SEAL PACKS AT ALL SPLICES AND 3/4" OF EXCESS OF WIRE IN A 1" DIAMETER COIL.
- 4"x4" FLANGE x BELL ADAPTER. TRANSITION FROM 4" CL200 PVC WITH HARCO MODEL 80460FB FLANGE x BELL ADAPTER. USE JOINT RESTRAINT AT SPIGOT END. (2 TOTAL)
- 4" CLASS 200 PVC MAIN LINE
- 1/2" GAUGE 1/2" (12mm) SQUARE WIRE MESH.
- BRICK SUPPORT. (4 TOTAL) / 1 @ EA CORNER.
- 16" CONCRETE PAVER SUPPORT BLOCK.
- 3/4" PEA GRAVEL OR 3/4" DRAIN ROCK. 6" DEEP BELOW VALVE (NO SOIL IN VALVE BOX).
- 4" FLANGED MASTER VALVE.
- 4" CLASS 200 PVC MAIN LINE TO FLOW SENSOR.

C


MASTER VALVE

NTS

B

BACKFLOW AND BOOSTER PUMP

NTS



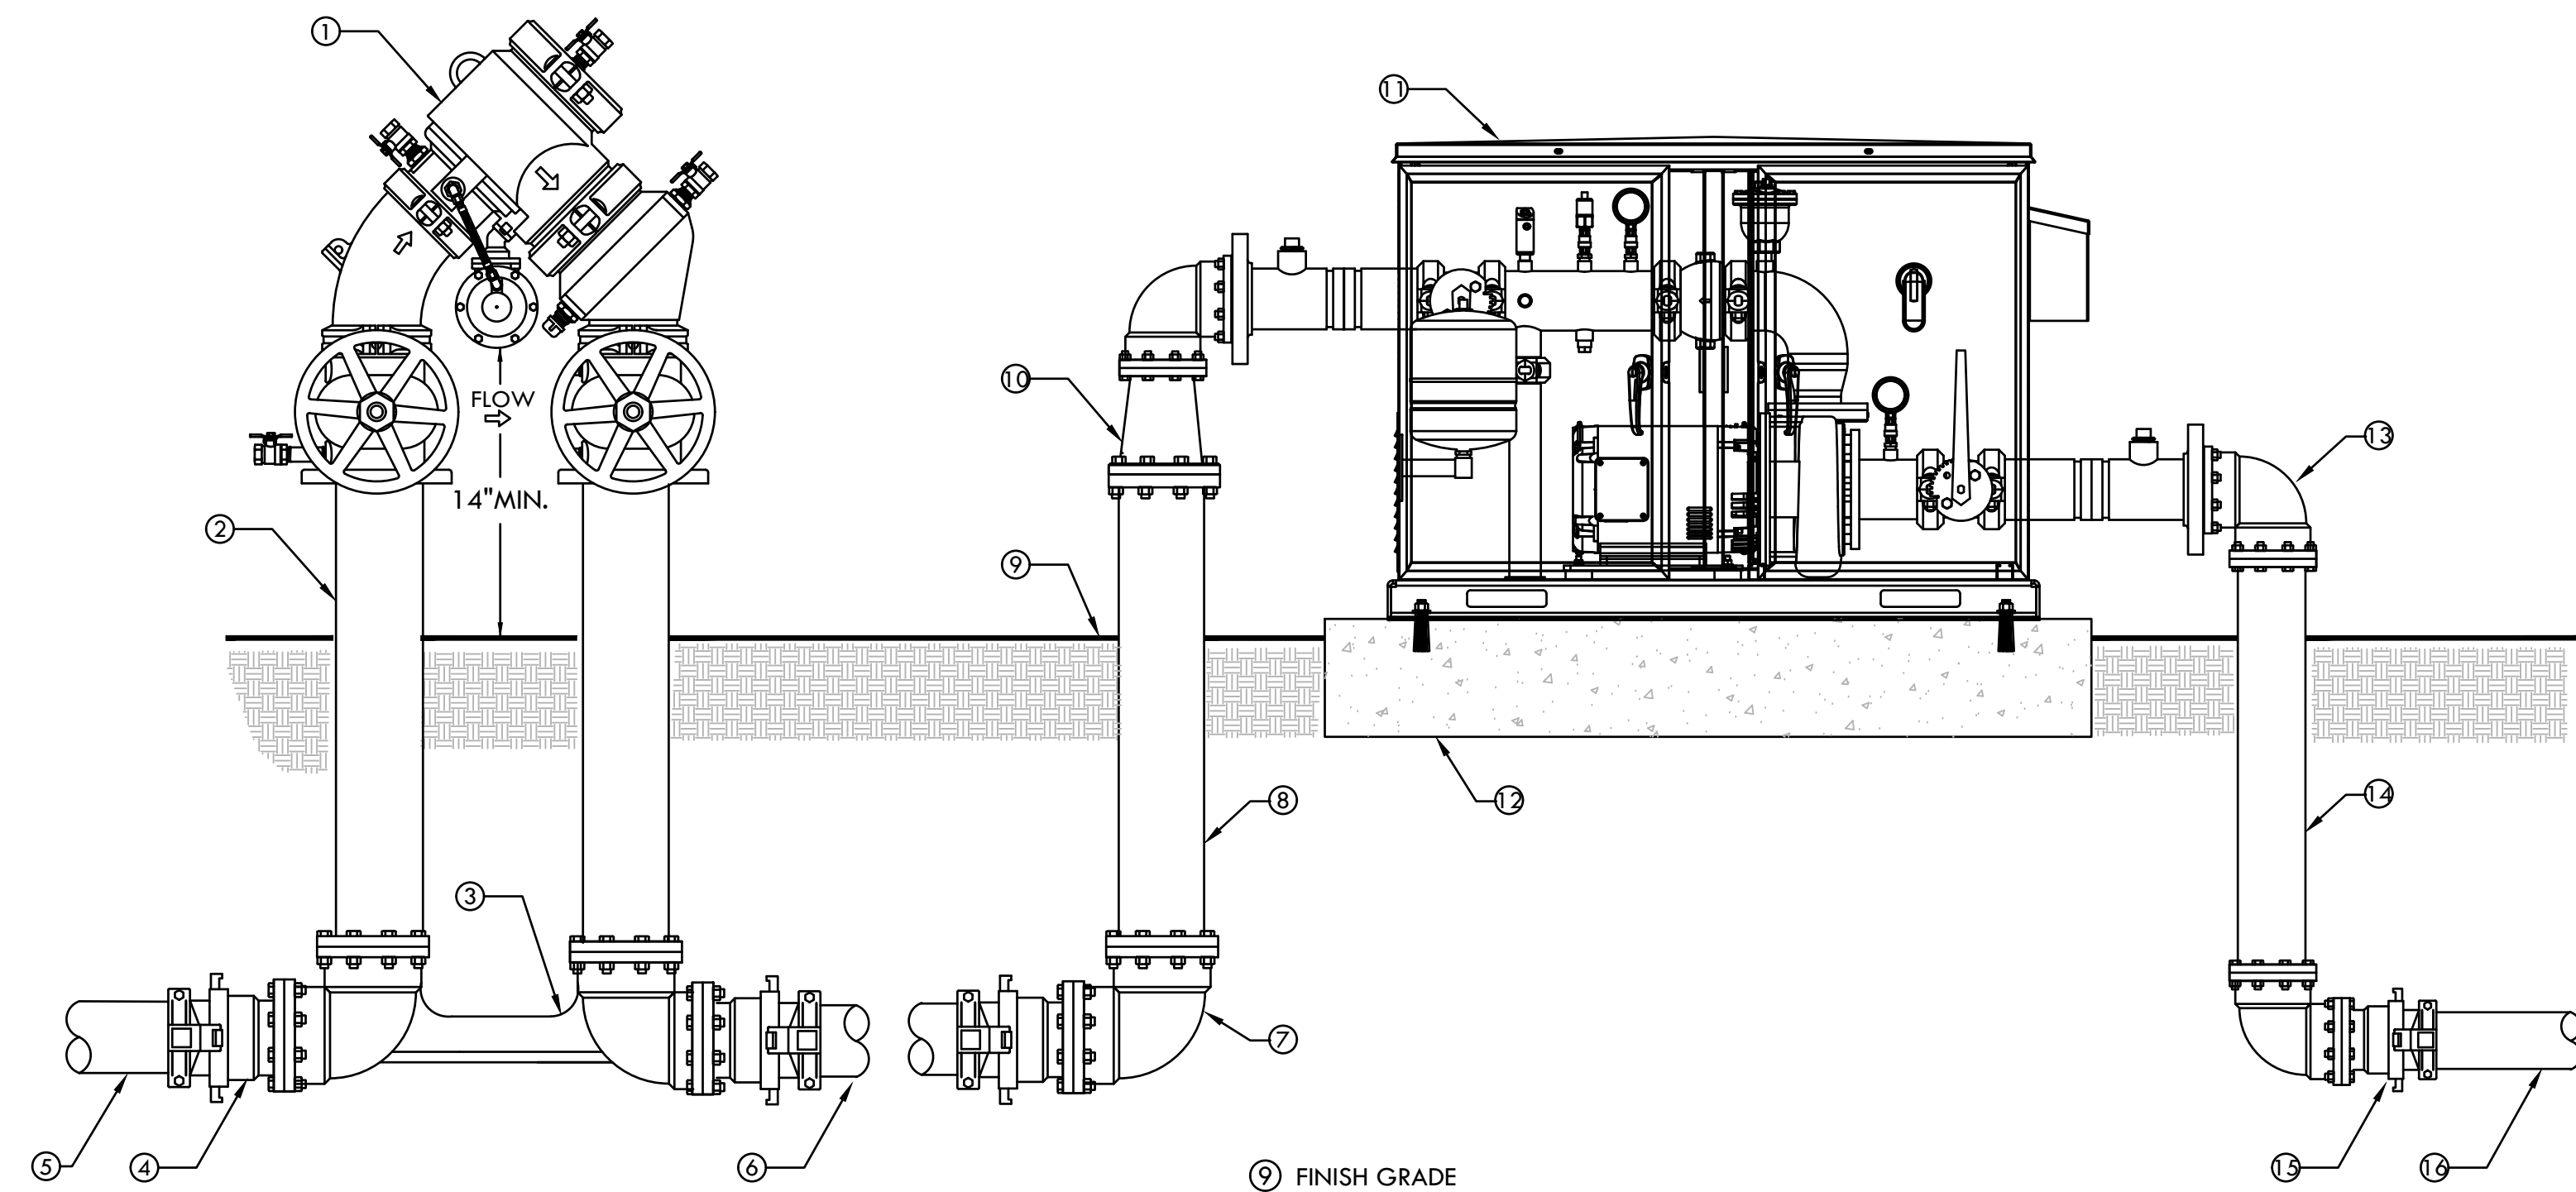


- 6" REDUCED PRESSURE BACKFLOW ASSEMBLY (WILKINS MODEL 475-6") WITH VALVE SETTER (WILKINS MODEL FLS). INSTALL FREEZE BLANKET ON BACKFLOW. VIT MODEL PBB-60HP
- 6" DUCTILE IRON SPOOL LENGTH AS REQUIRED (2 TOTAL)+.42" IN LENGTH. WRAP PIPE WITH PROTECTIVE TAPE WHEN PIPE IS IN CONTACT WITH SOIL.
- WILKINS 6" MODEL FLS (FLANGE x FLANGE) VALVE SETTER
- HARCO 6" IPS FLANGE x BELL ADAPTER MODEL 80660FB. USE JOINT RESTRAINT AS REQUIRED (3 TOTAL)
- 6" CL200 PIPE FROM WATER SOURCE
- 6" CL200 PIPE LENGTH AS REQUIRED.
- 6" DUCTILE IRON (D.I.) FLANGED 90° ELBOW
- 6" DUCTILE IRON SPOOL LENGTH AS REQUIRED. WRAP PIPE WITH PROTECTIVE TAPE WHEN PIPE IS IN CONTACT WITH SOIL.
- FINISH GRADE
- 6"x4" D.I. FLANGE REDUCER
- PPS BOOSTER PUMP WITH 4" FLANGED INLET AND OUTLET. REFER TO BOOSTER PUMP DETAIL FOR MORE INFORMATION
- 6" THICK CONCRETE PAD FOR BOOSTER PUMP TO EXTEND 6" BEYOND ENCLOSURE ON ALL SIDES. CONCRETE TO HAVE MEDIUM BROOM FINISH. SET PAD 1" ABOVE FINISH GRADE. USE #4 REBAR ON A 18" GRID WITHIN THE PAD
- 4" DUCTILE IRON (D.I.) FLANGED 90° ELBOW (2 TOTAL)
- 4" DUCTILE IRON SPOOL LENGTH AS REQUIRED. WRAP PIPE WITH PROTECTIVE TAPE WHEN PIPE IS IN CONTACT WITH SOIL.
- 4"x4" FLANGE x BELL ADAPTER. TRANSITION INTO 4" CLASS 200 PVC TO SERVICE MASTER VALVE WITH HARCO MODEL 80460FB FLANGE x BELL ADAPTER. USE JOINT RESTRAINT AT SPIGOT END.
- 4" CLASS 200 PVC PIPE TO MASTER VALVE AND FLOW SENSOR

A

IRRIGATION BOOSTER PUMP

NTS

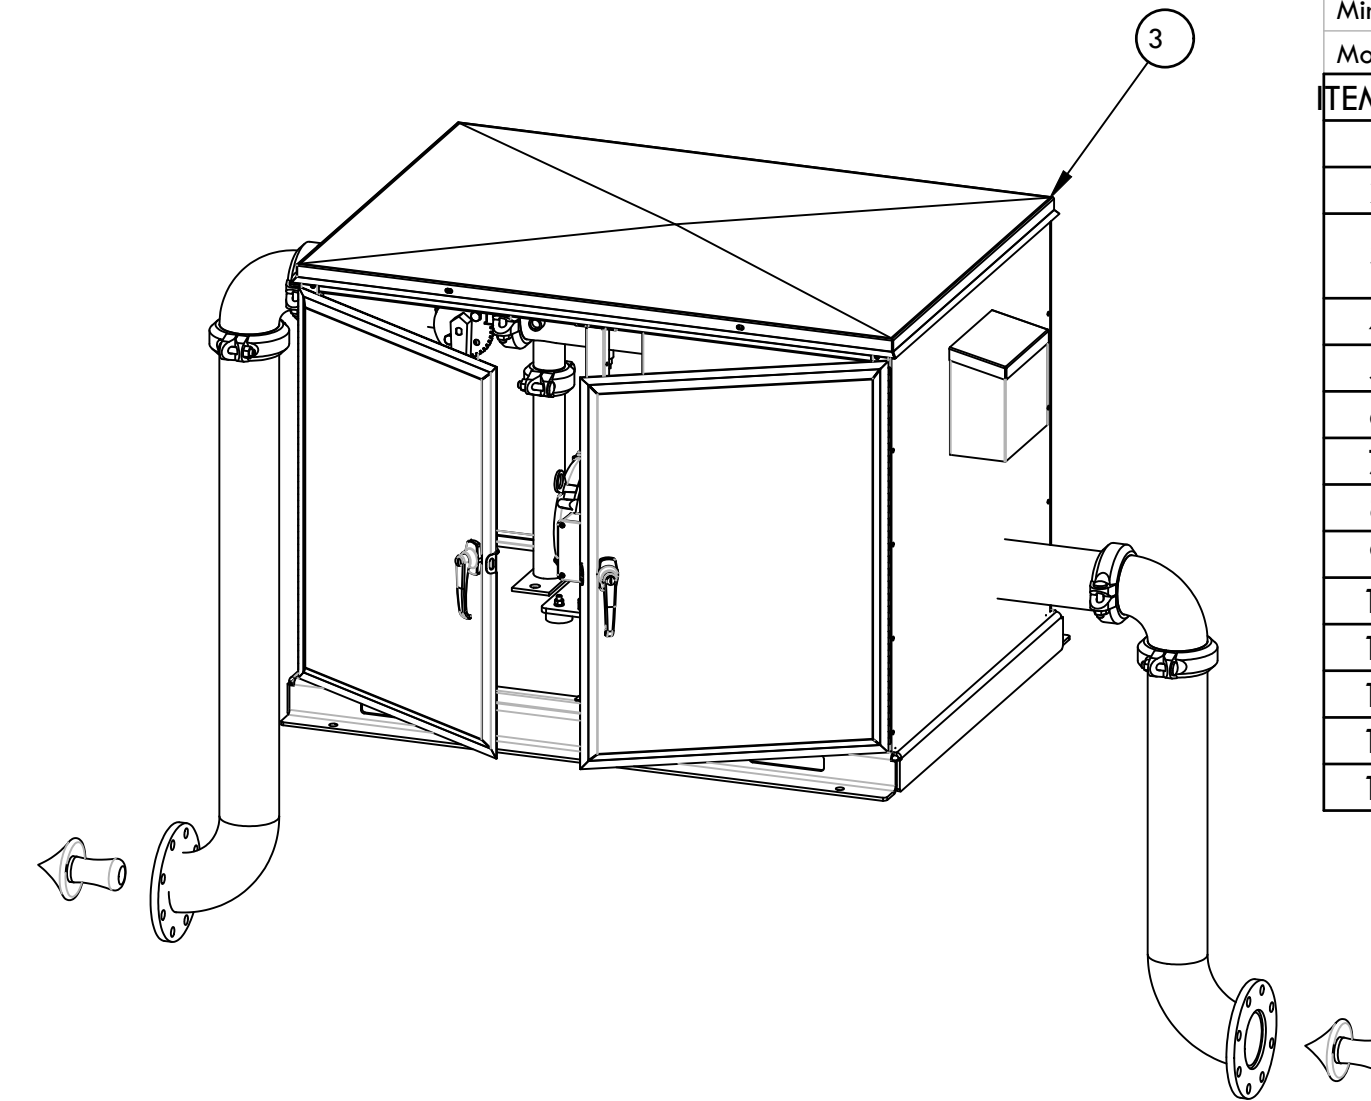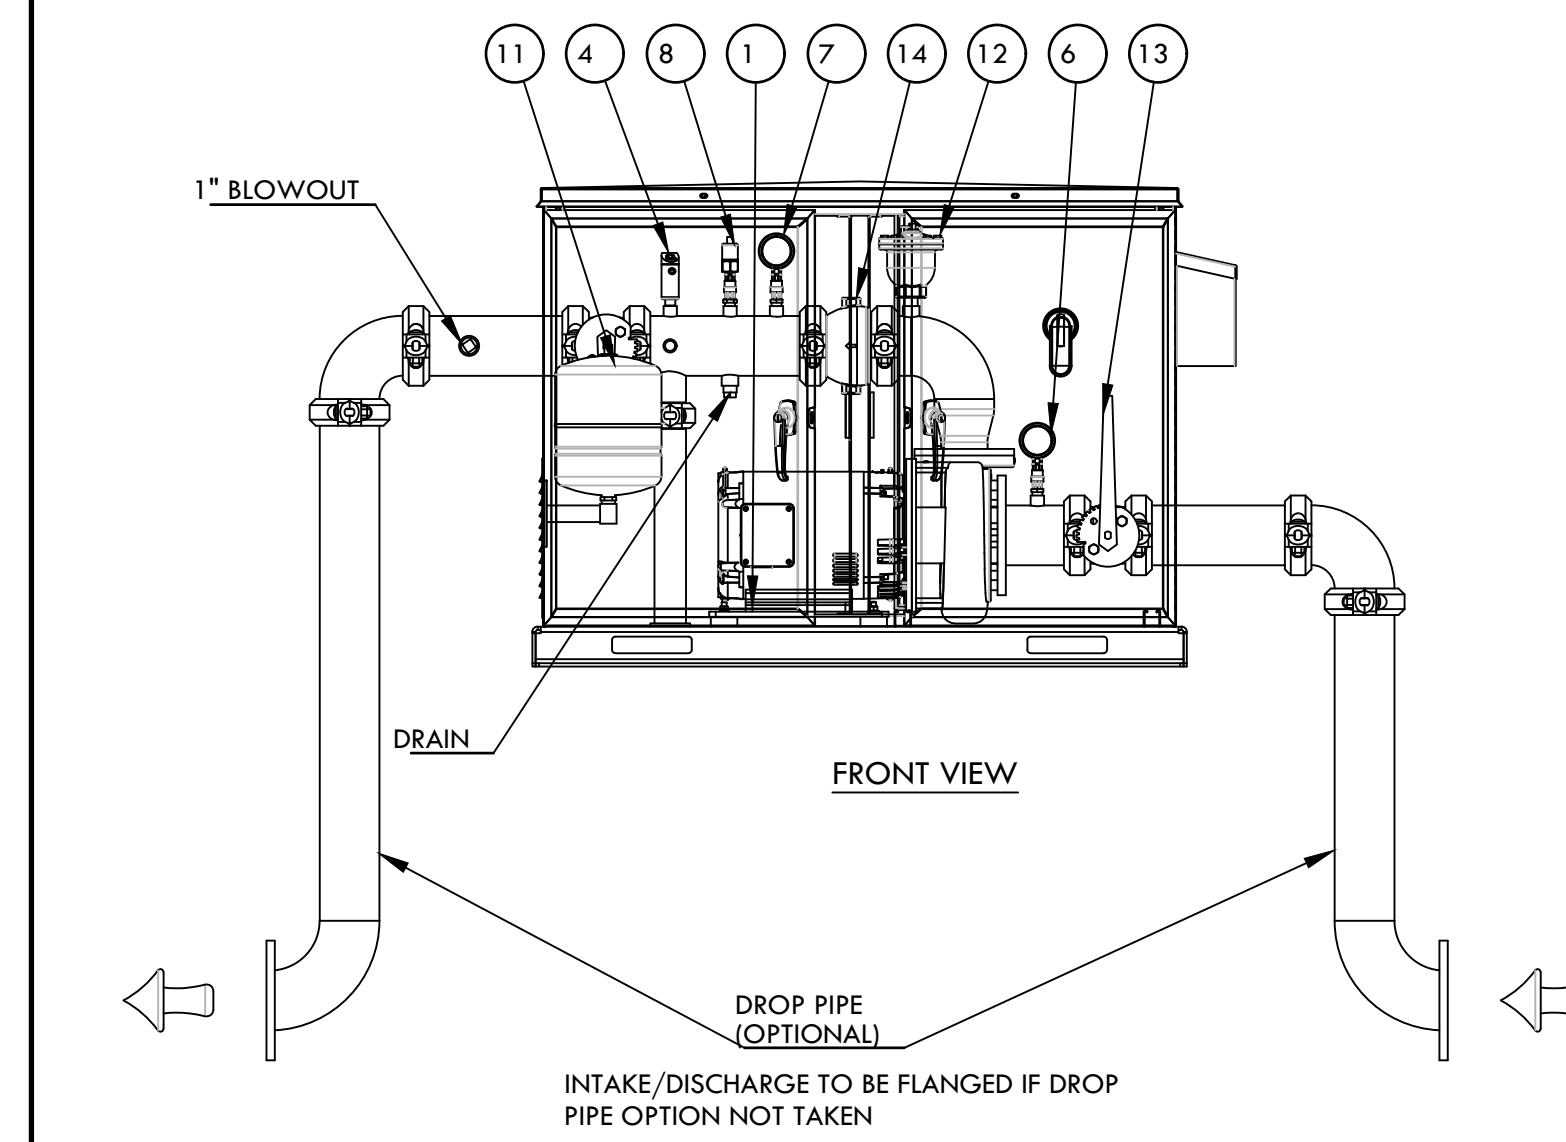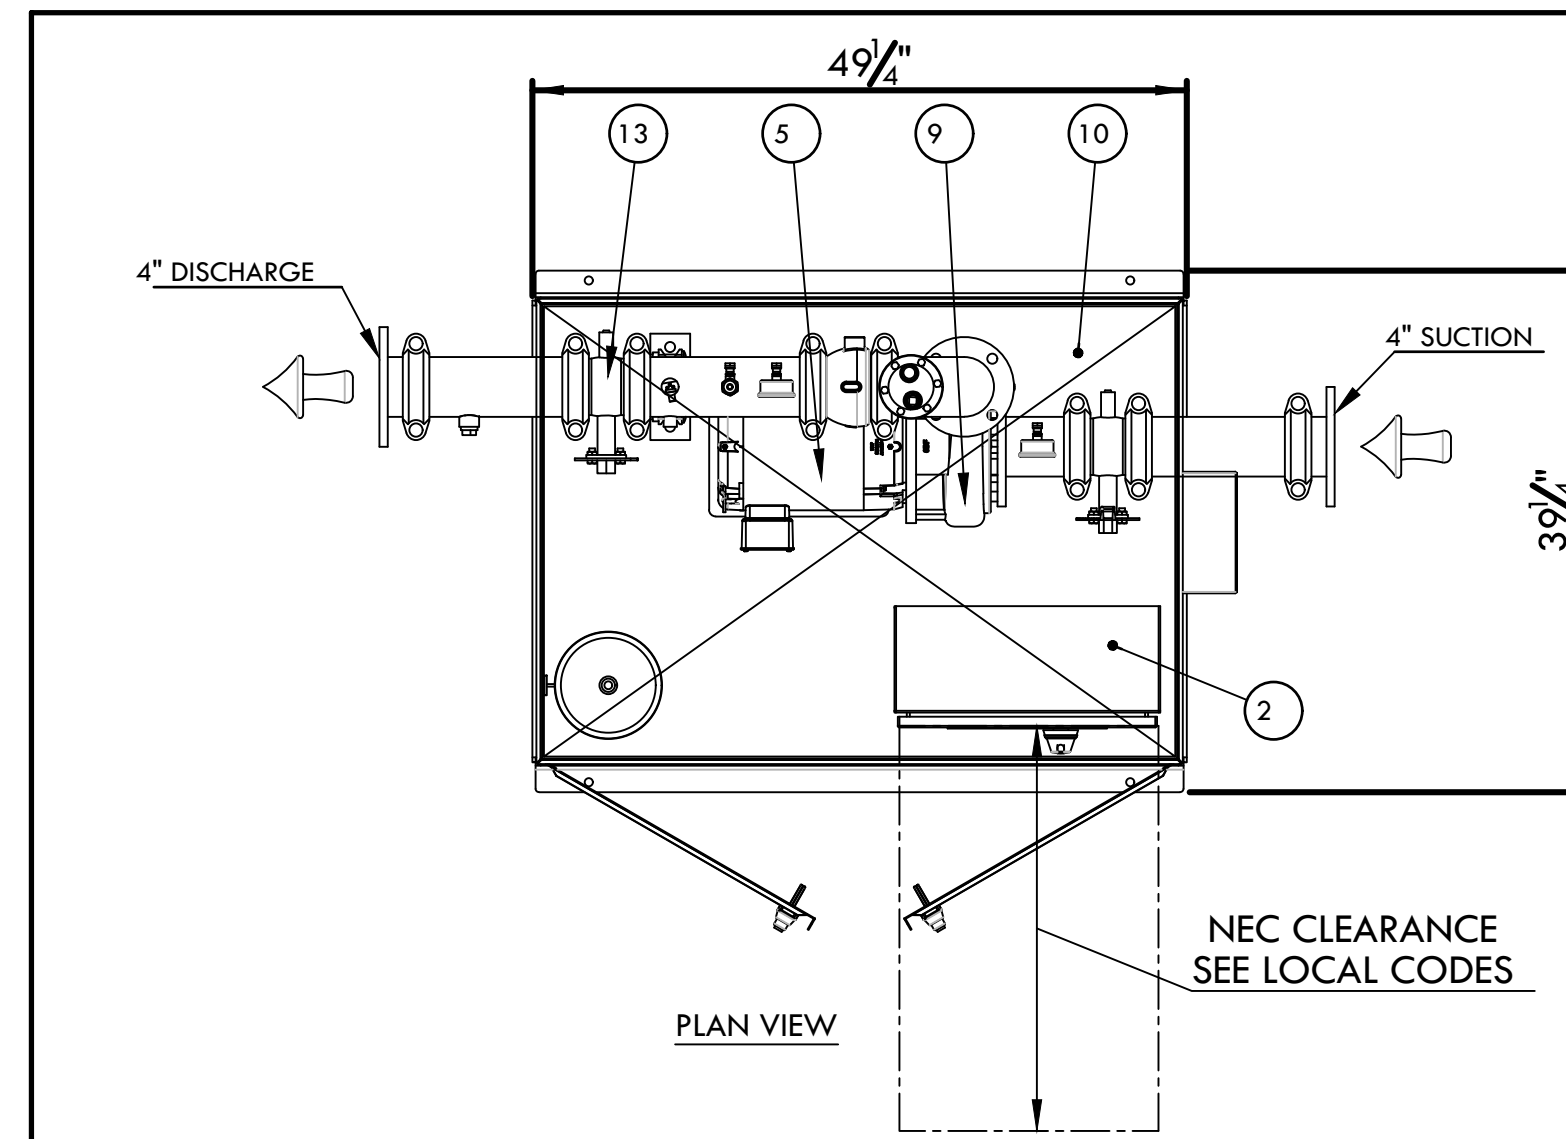


DESIGN SPECIFICATIONS			
Design Flow Rate:	325 GPM @ 65 PSI Boost		
Duty Pump Details:	20 HP/Pump 325 GPM @150TDH		
Minimum Power:	240 Valt / 3 Phase		
Model #:	CB##V1C020X00325-065XXXX243ONS-4		
ITEM NO.	DESCRIPTION	Size	QTY.
1	BASE, POLY, WHITE, 1/2" THICK	10"x8"	1
2	CONTROL PANEL		1
3	ENCLOSURE, MARINE GRADE ALUMINUM	48"x33"x42"	1
4	FLOW METER/FLOW SWITCH	1/2"	1
5	MOTOR, 3600 RPM		1
6	PRESSURE GAUGE, 100PSI	2-1/2"	1
7	PRESSURE GAUGE, 160PSI	2-1/2"	1
8	PRESSURE TRANSDUCER, 200PSI	1/4"	1
9	PUMP, CENTRIFUGAL	20HP	1
10	SKID, BENT	48x33	1
11	TANK, PRESSURE	2 Gal	1
12	VALVE, AIR RELIEF	3/4"	1
13	VALVE, BUTTERFLY, GROOVE, LEVER	4"	2
14	VALVE, CHECK, GROOVED	4"	1


NON-POTABLE
NOT FOR FABRICATION



REV.	DESCRIPTION	DATE	APVD
REVISIONS			
MATERIAL Piping: STEEL A 53 Skid: GALVANIZED		TITLE: BOOSTER SYSTEM PUMP STATION	
UNLESS OTHERWISE SPECIFIED: DIMENSIONS ARE IN INCHES TOLERANCES: FRACTIONAL: ±1/8" ONE PLACE DECIMAL: ±.10 TWO PLACE DECIMAL: ±.05 DO NOT SCALE DRAWING		PROJECT: HIRAM JOHNSON HS	
DRAWN: [Signature]		LEVEL: [Blank]	
DATE: 1/11/2021		PART NO: CB##V1C020X00325-065XXXX243ONS-4	
JOB: [Blank]		SIZE: B SCALE: NTS SHEET: 1 OF 1 REV: -	

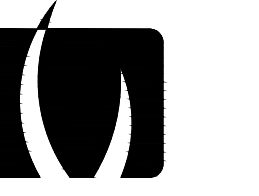

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STAMP

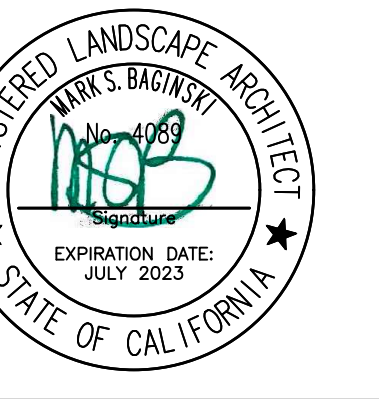CONSULTANT

KEYMAP

SHEET TITLE

PLANTING AND IRRIGATION
DETAILS

PROJECT NAME

HIRAM JOHNSON
HIGH SCHOOL
GOLF PRACTICE FACILITY,
VARSITY BASEBALL AND
SOFTBALL FIELDS

PROJECT ADDRESS

6879 14TH AVENUE
SACRAMENTO, CA 95820

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VDI	MB/CS
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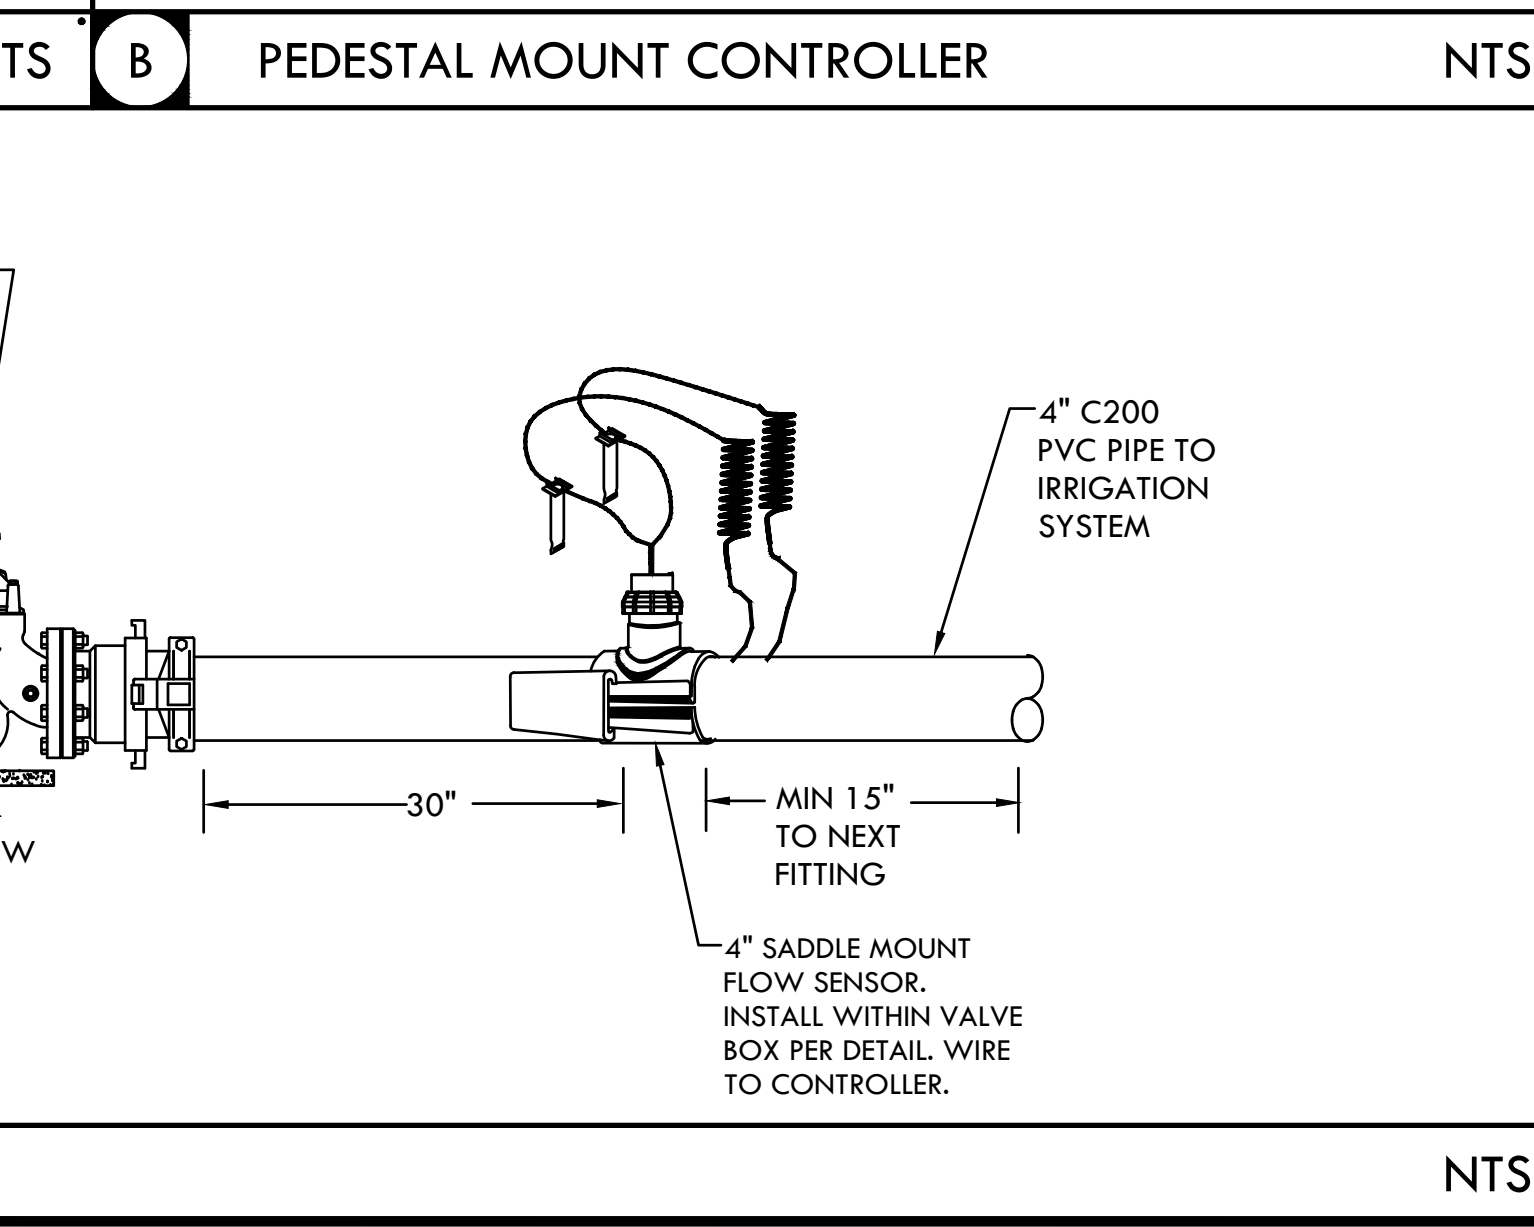
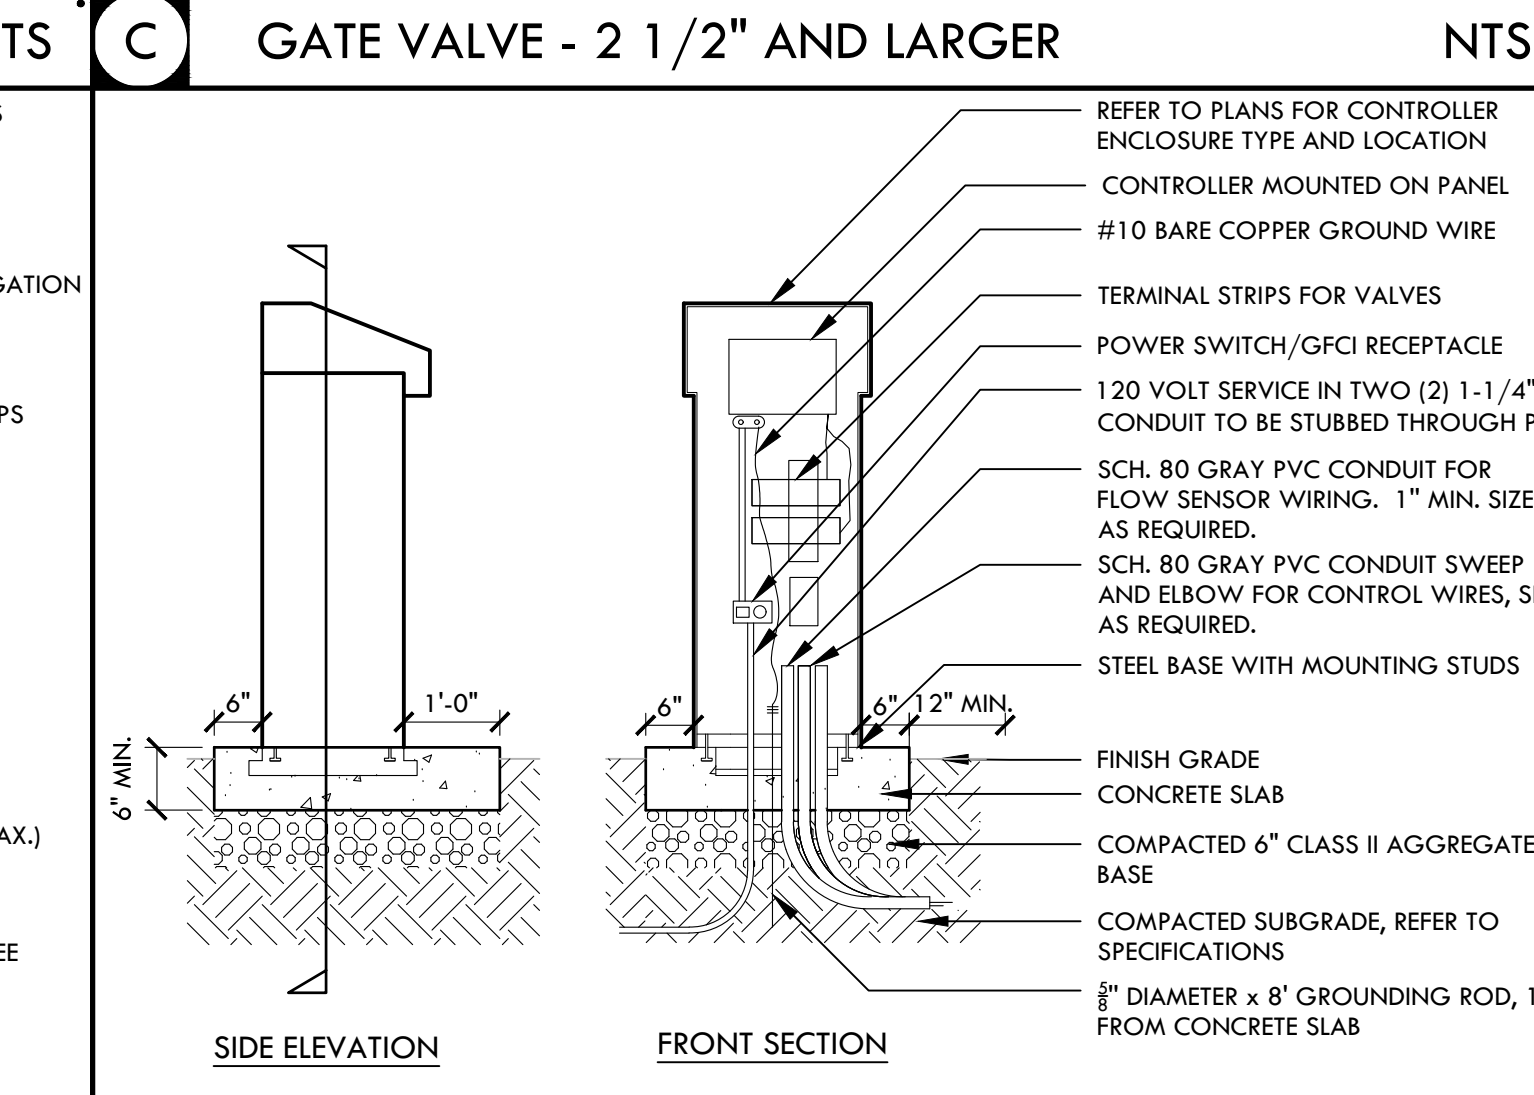
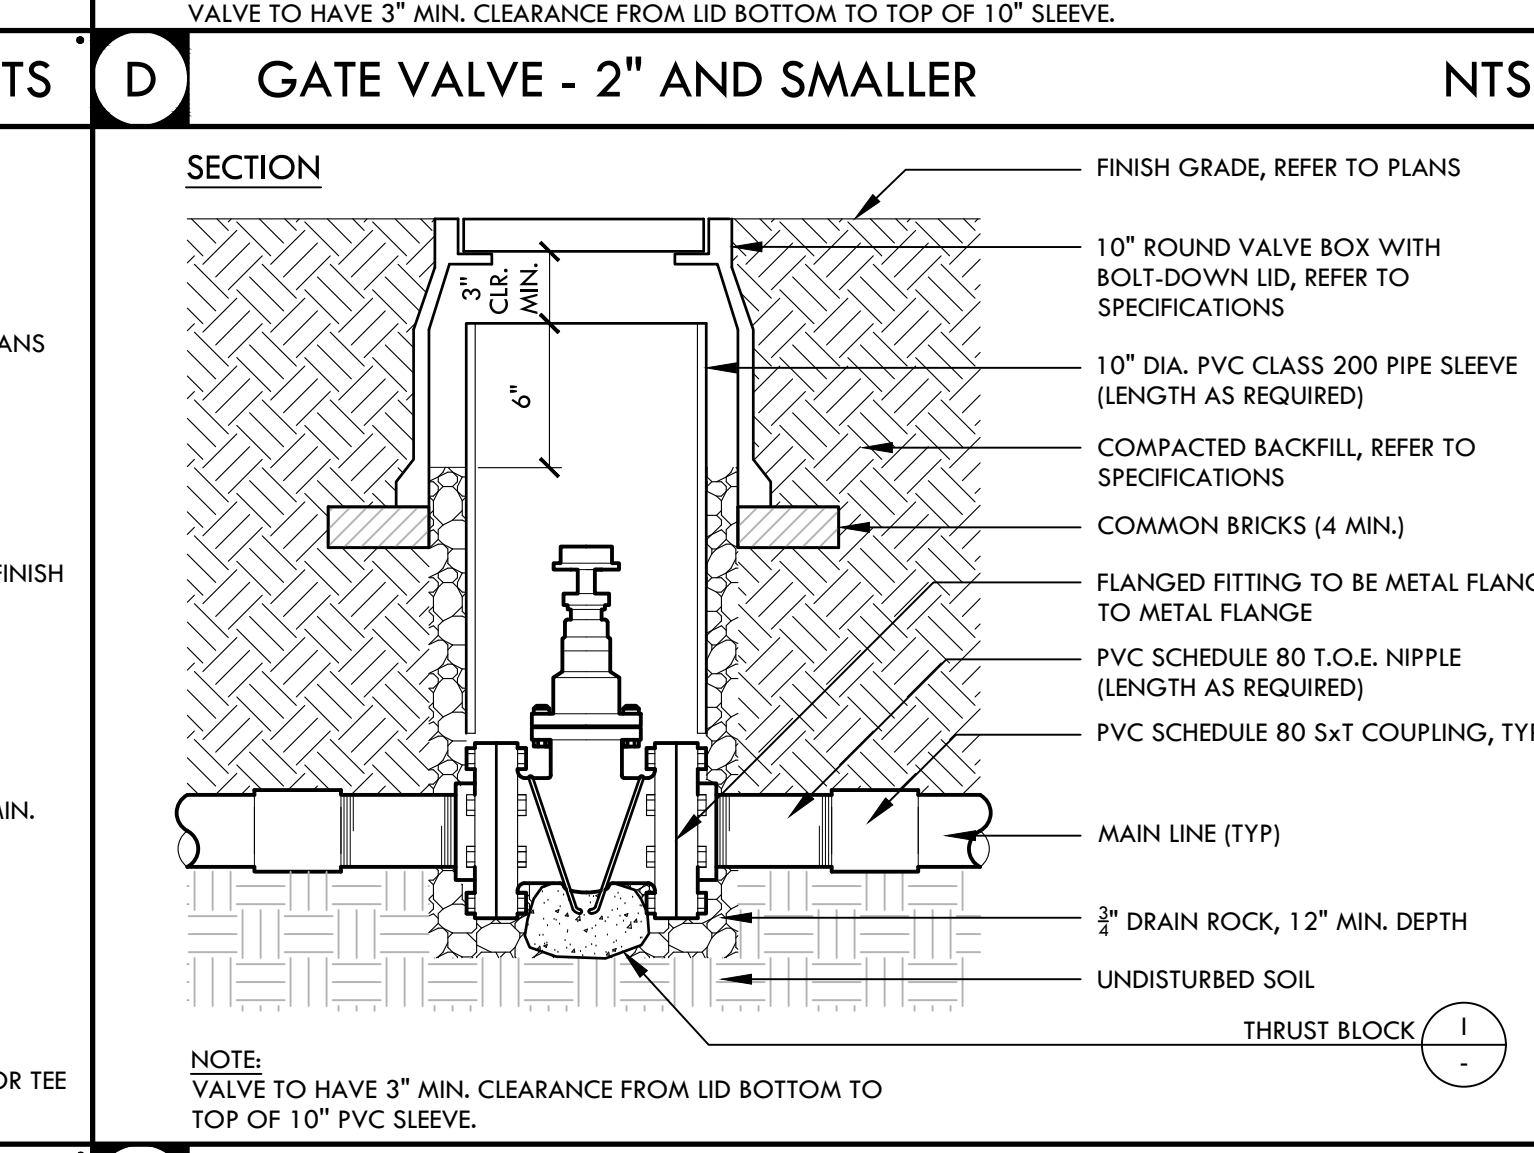
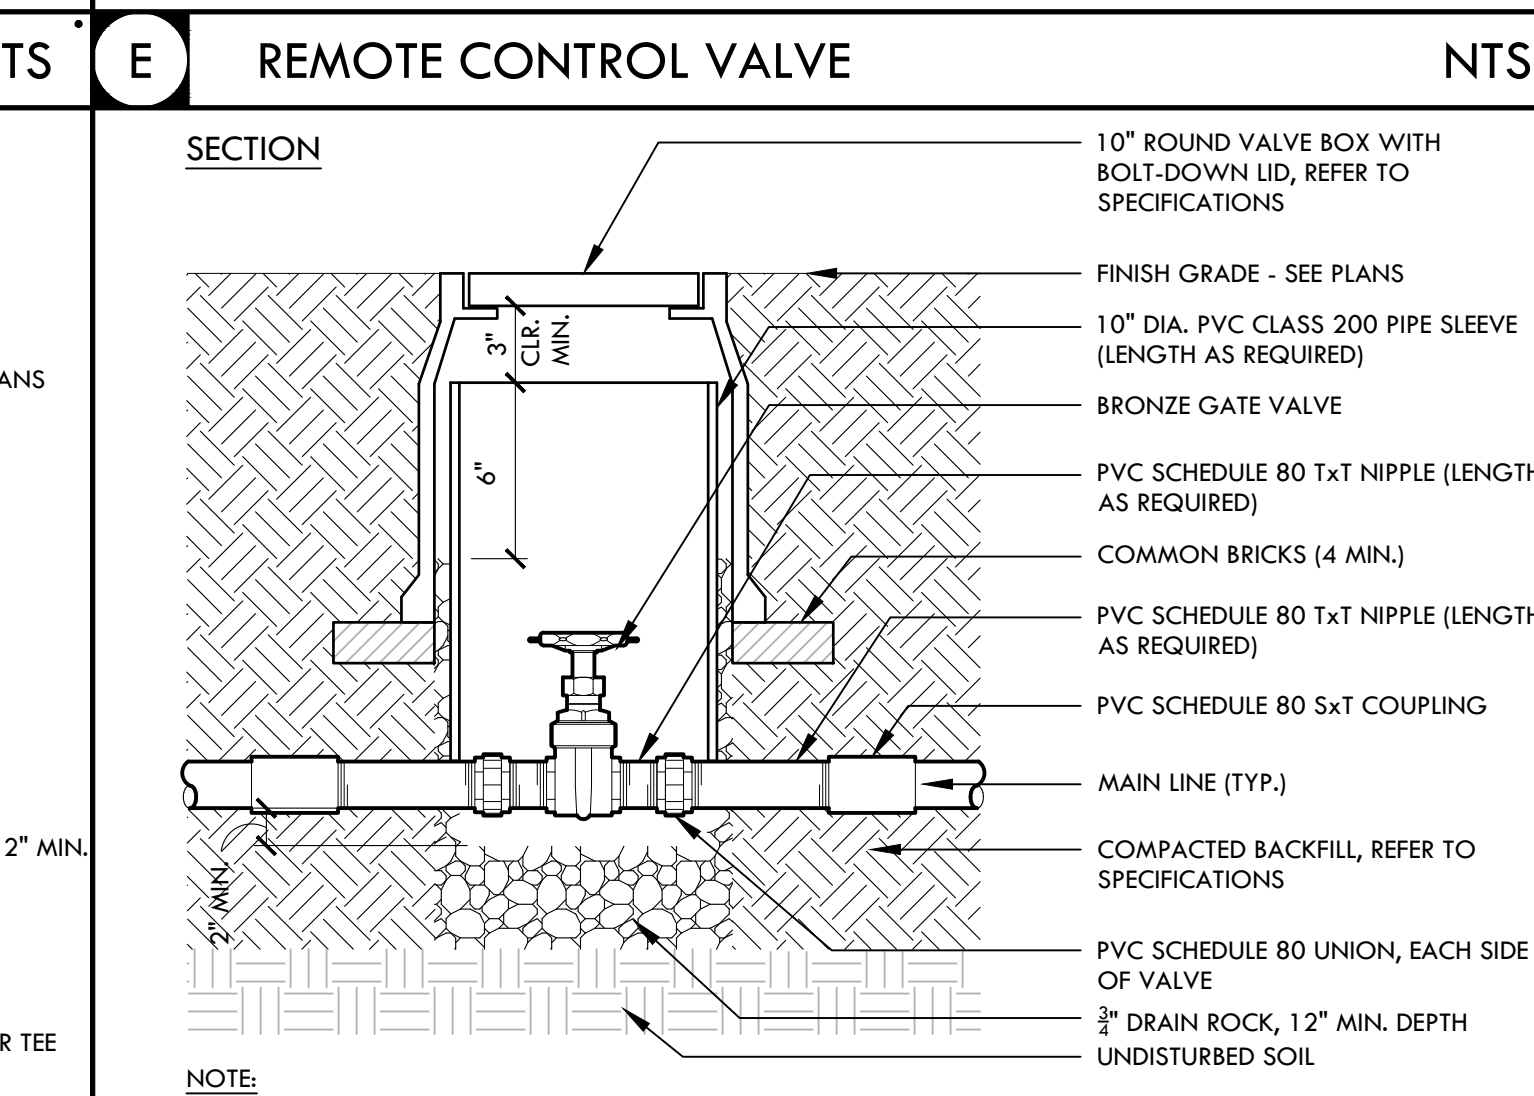
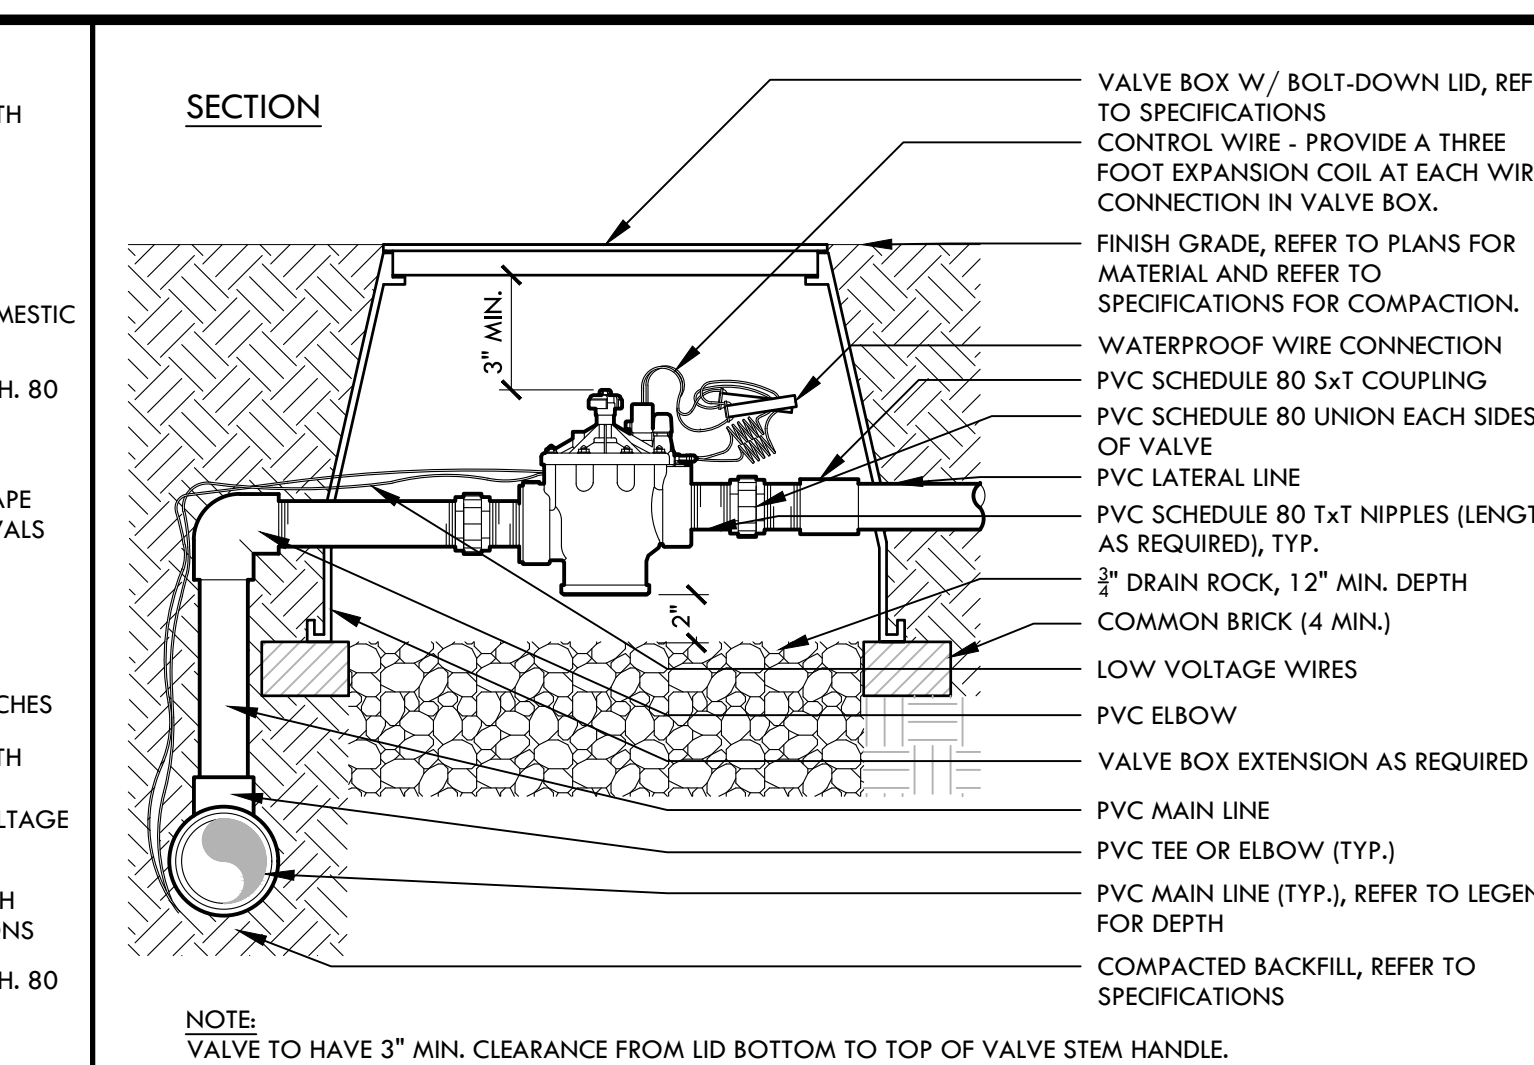
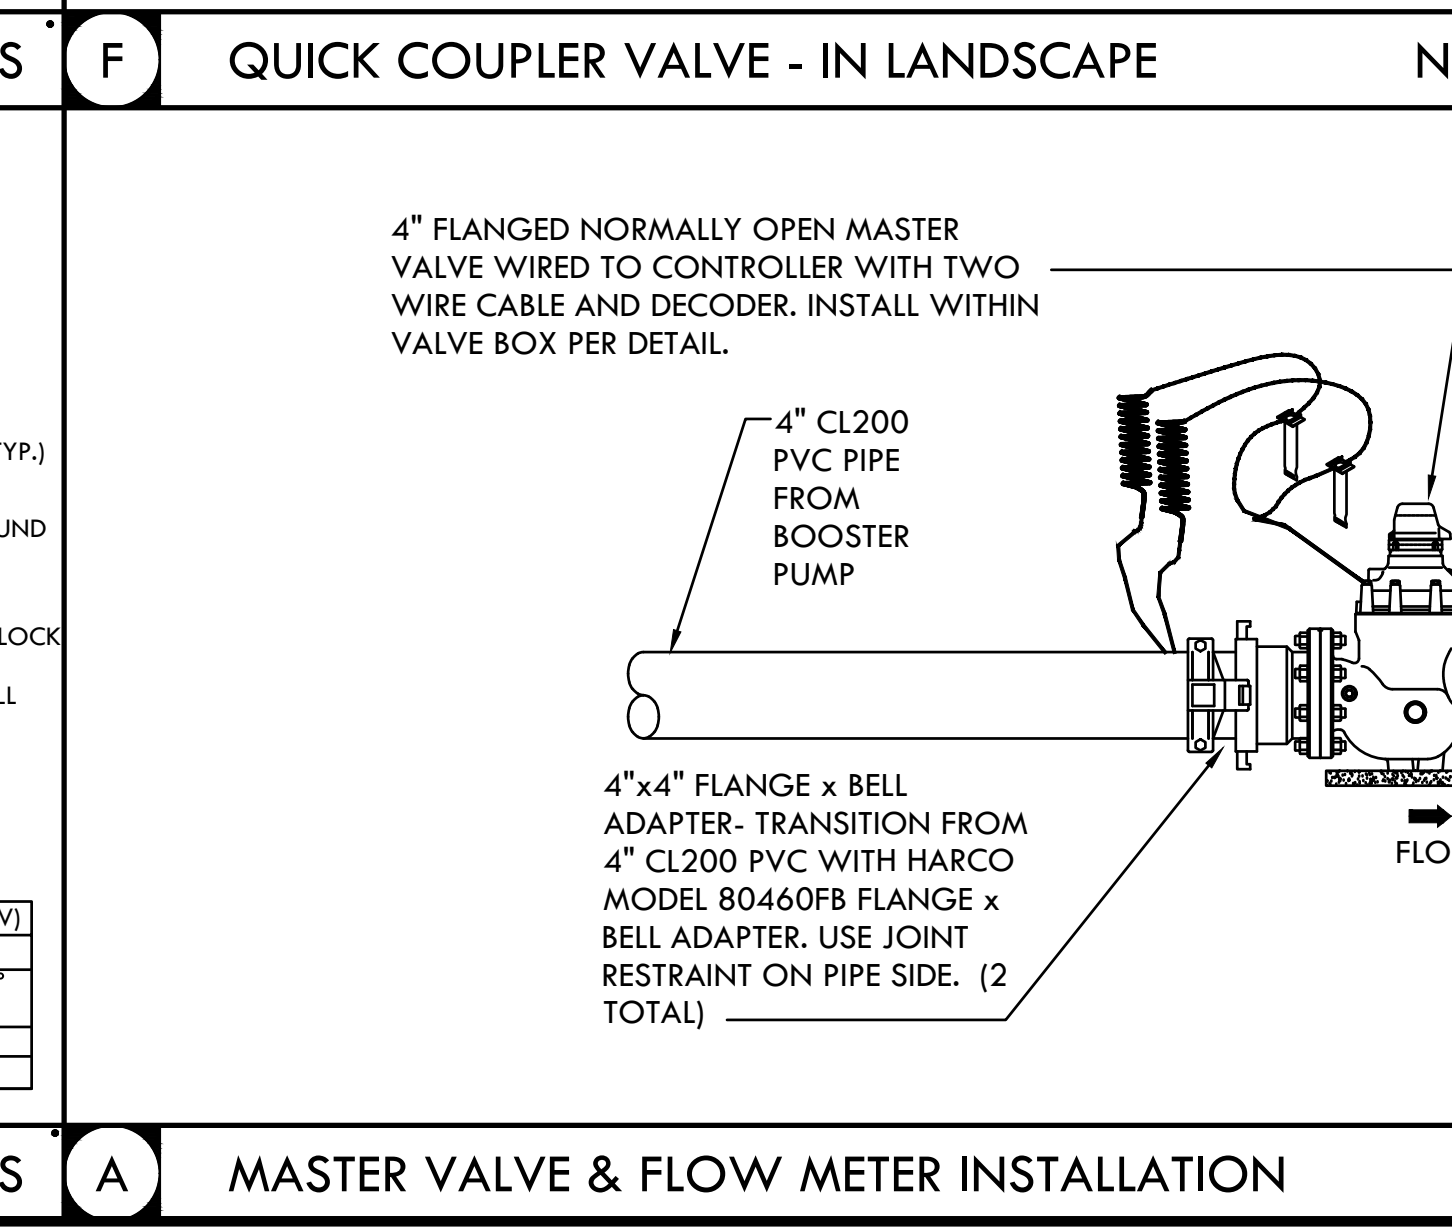
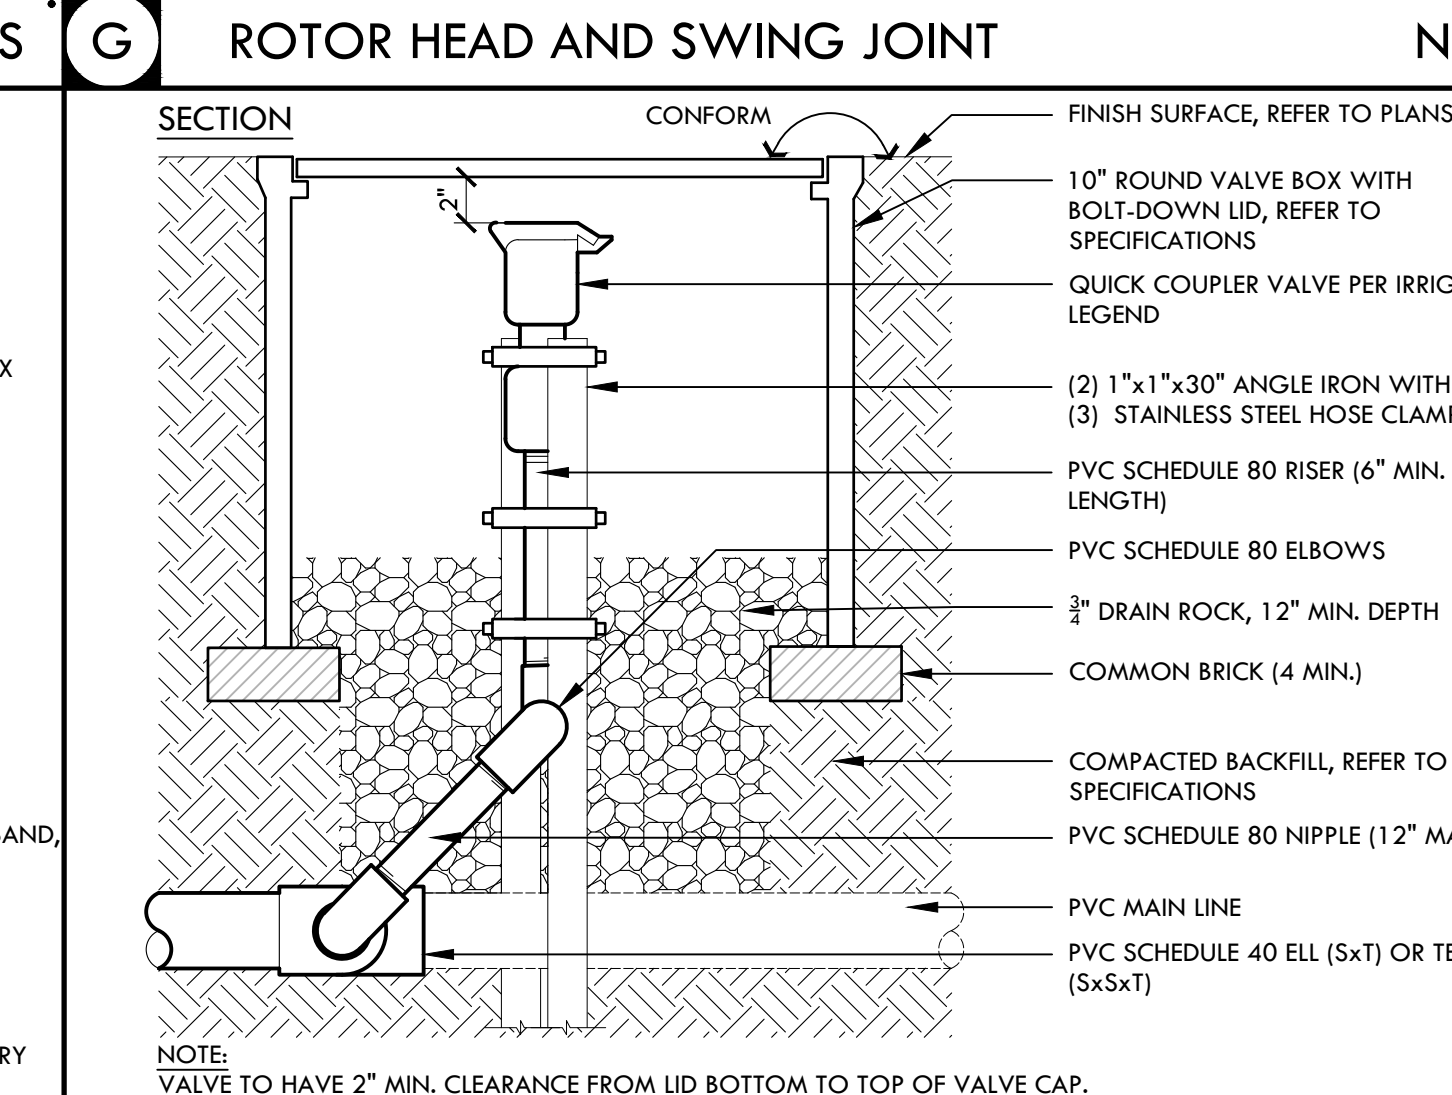
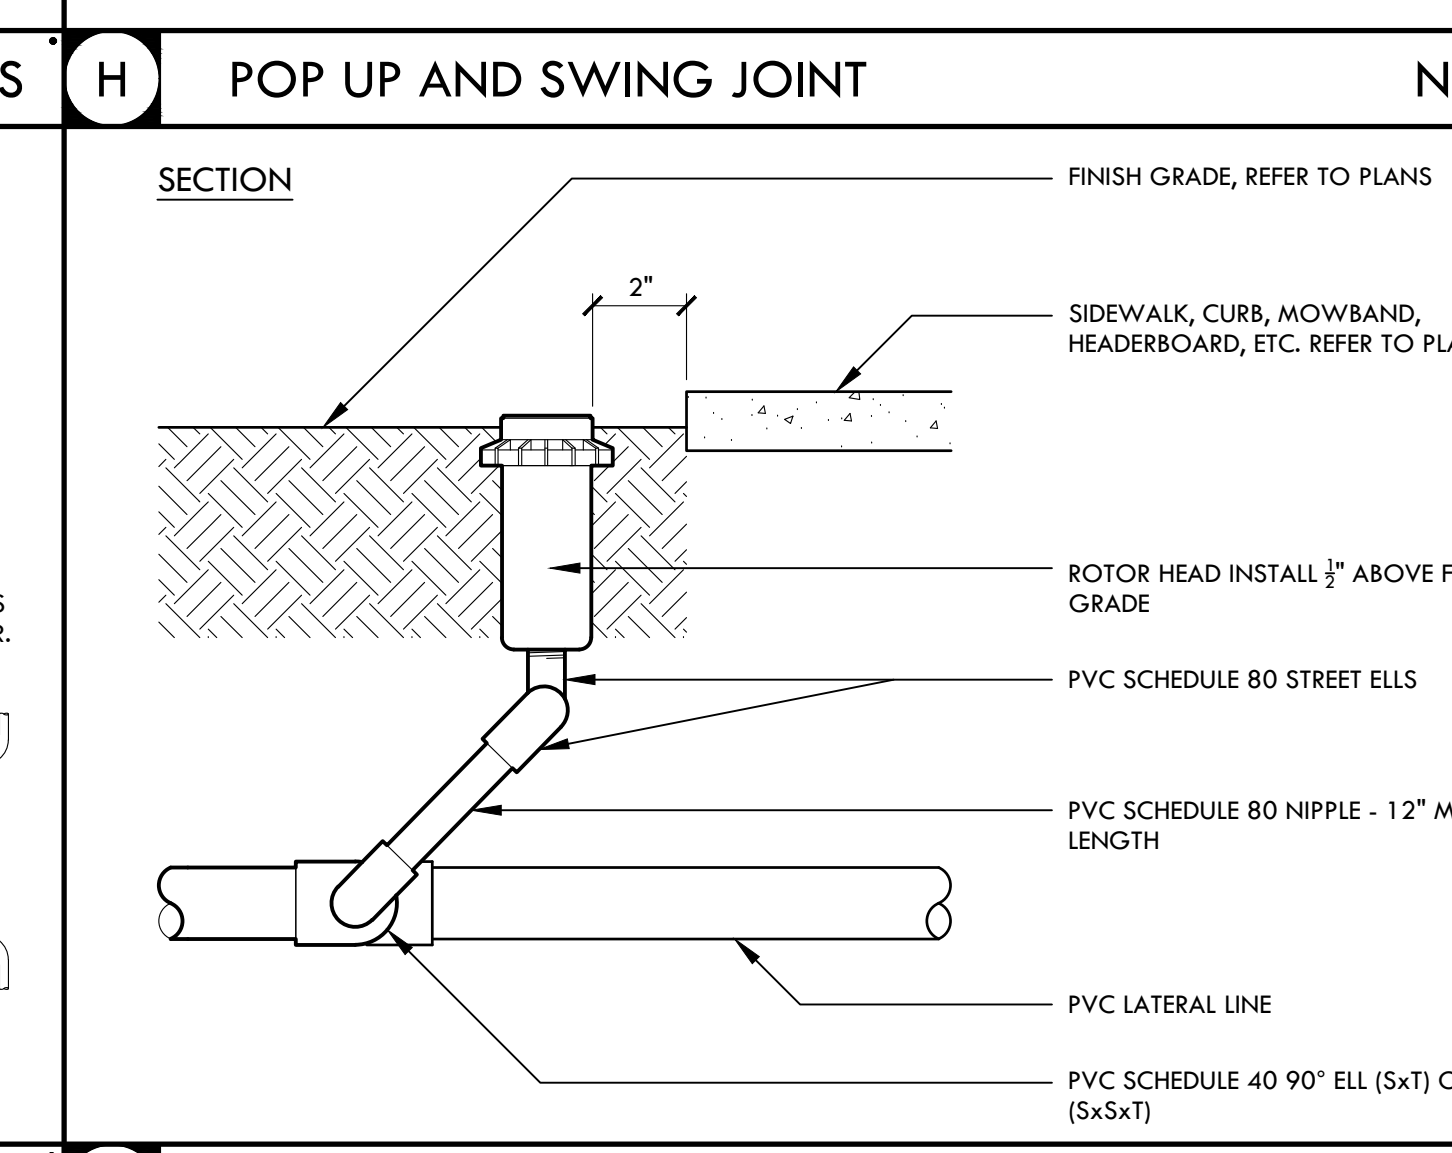
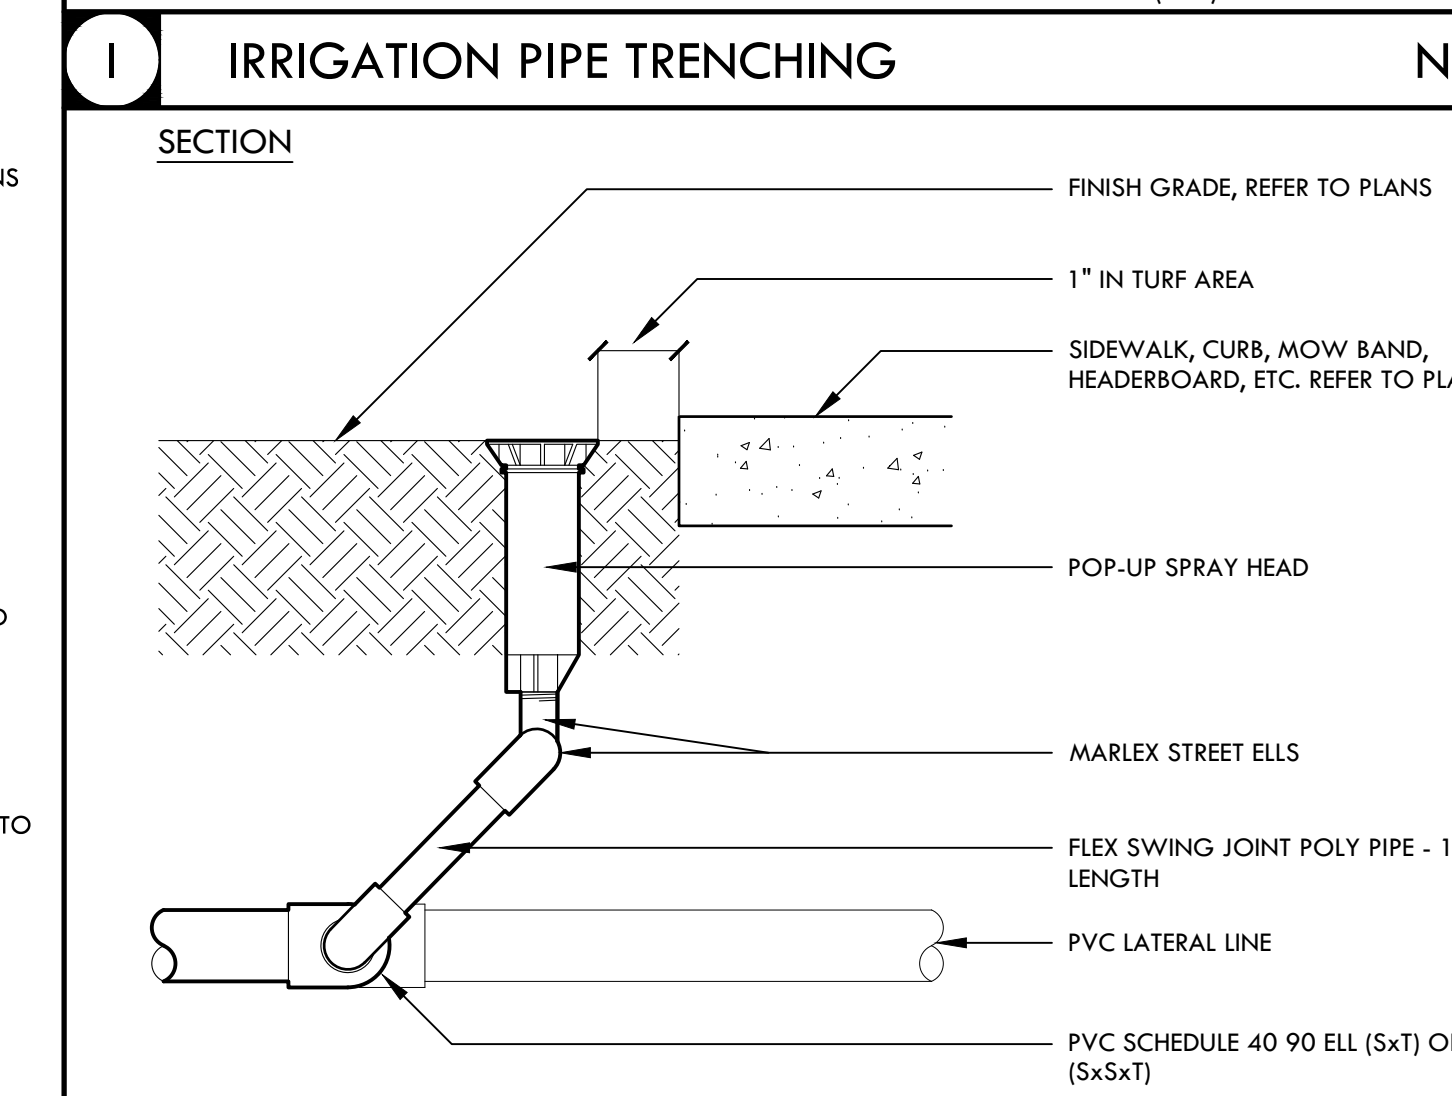
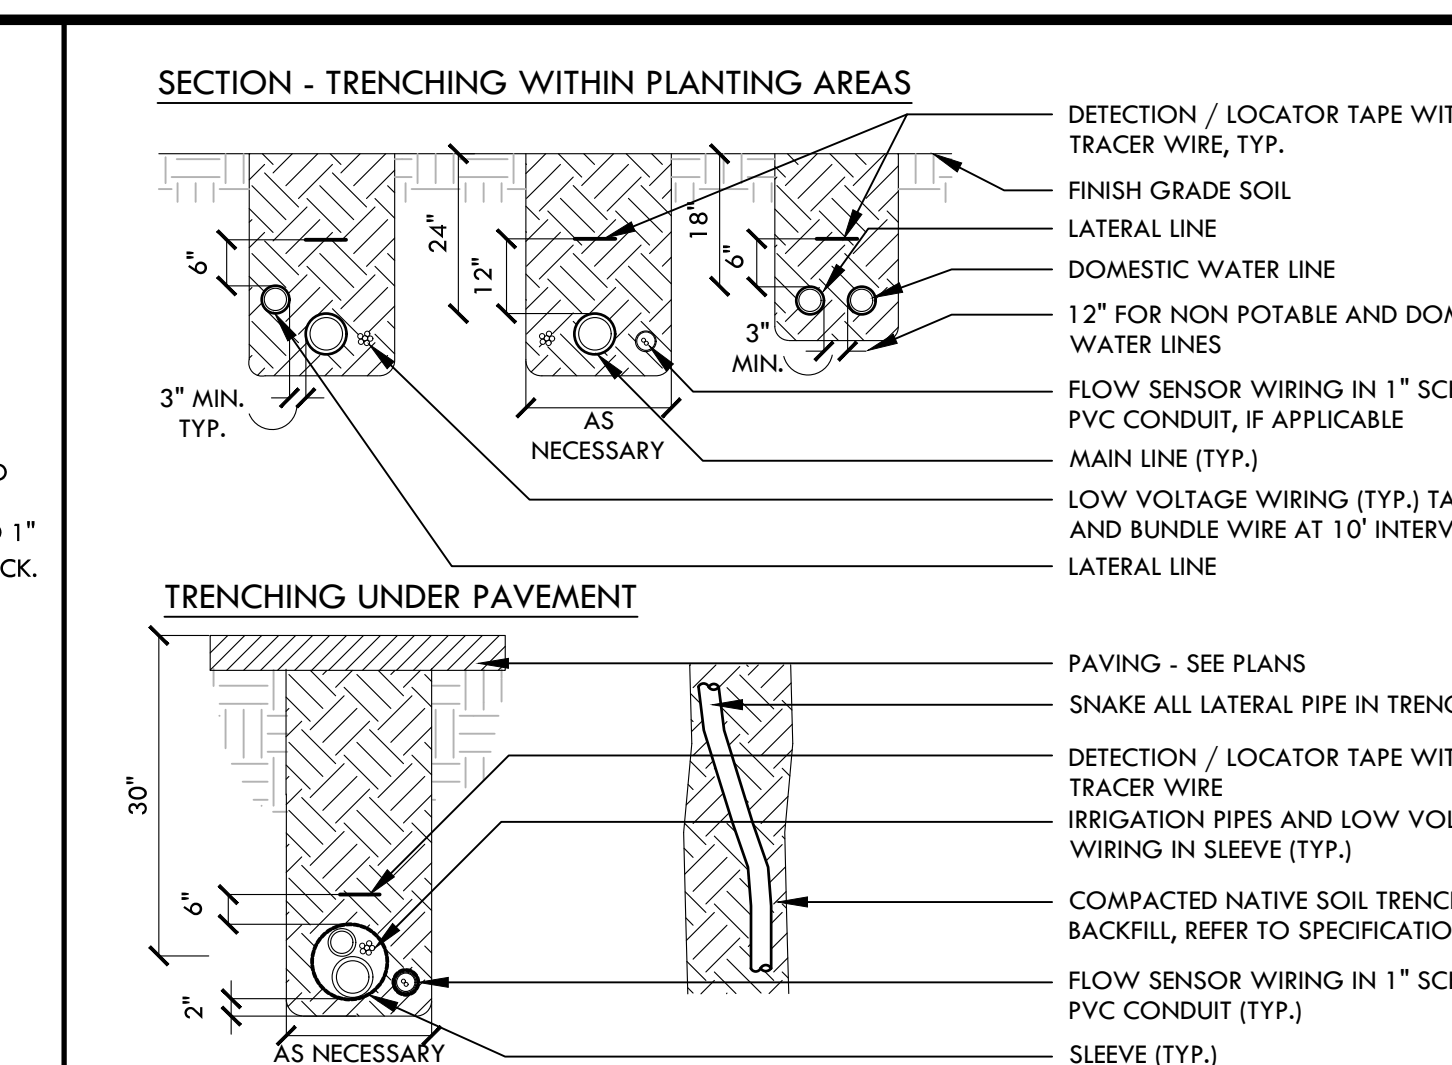
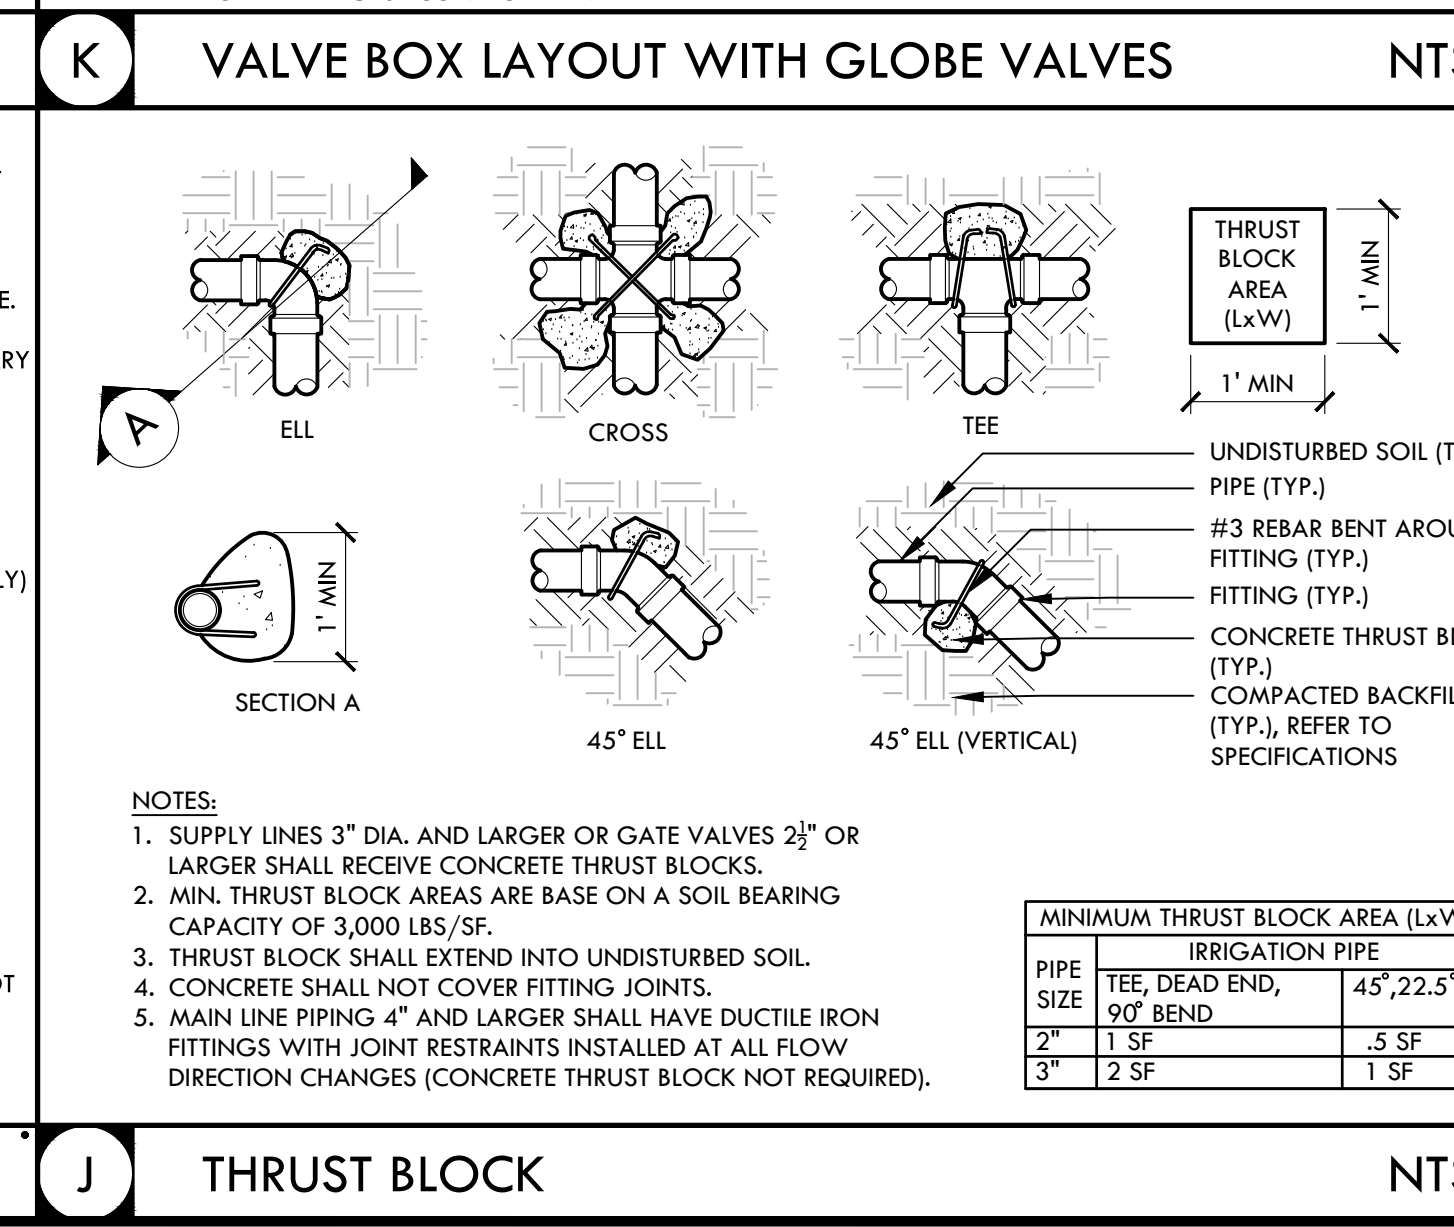
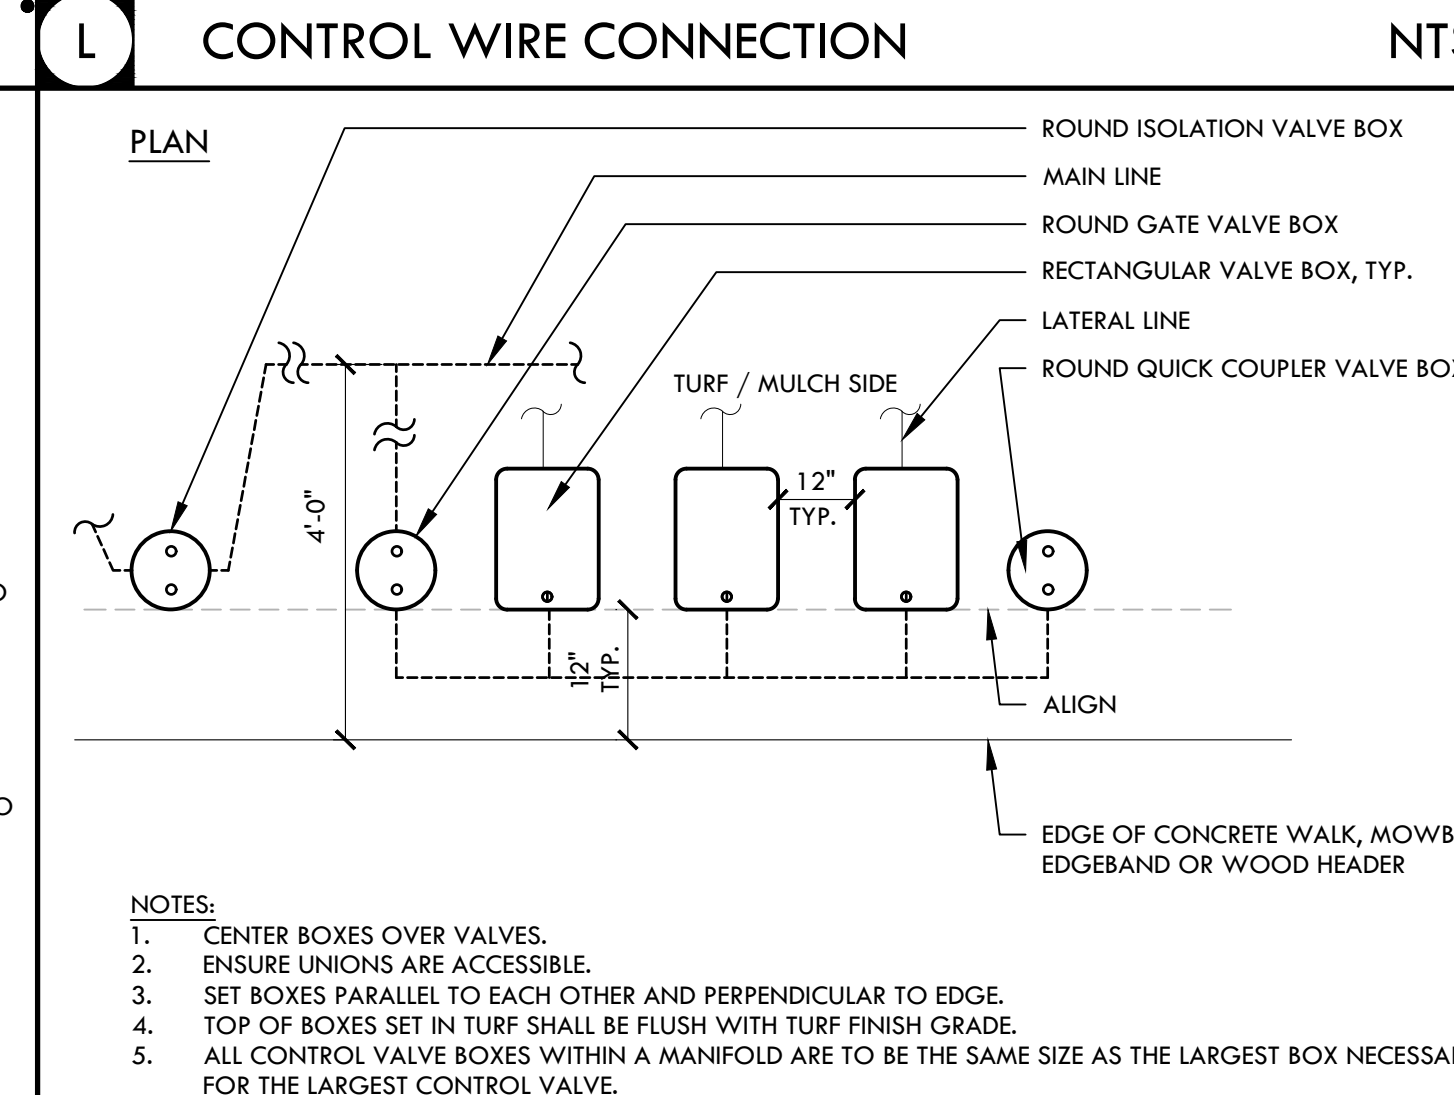
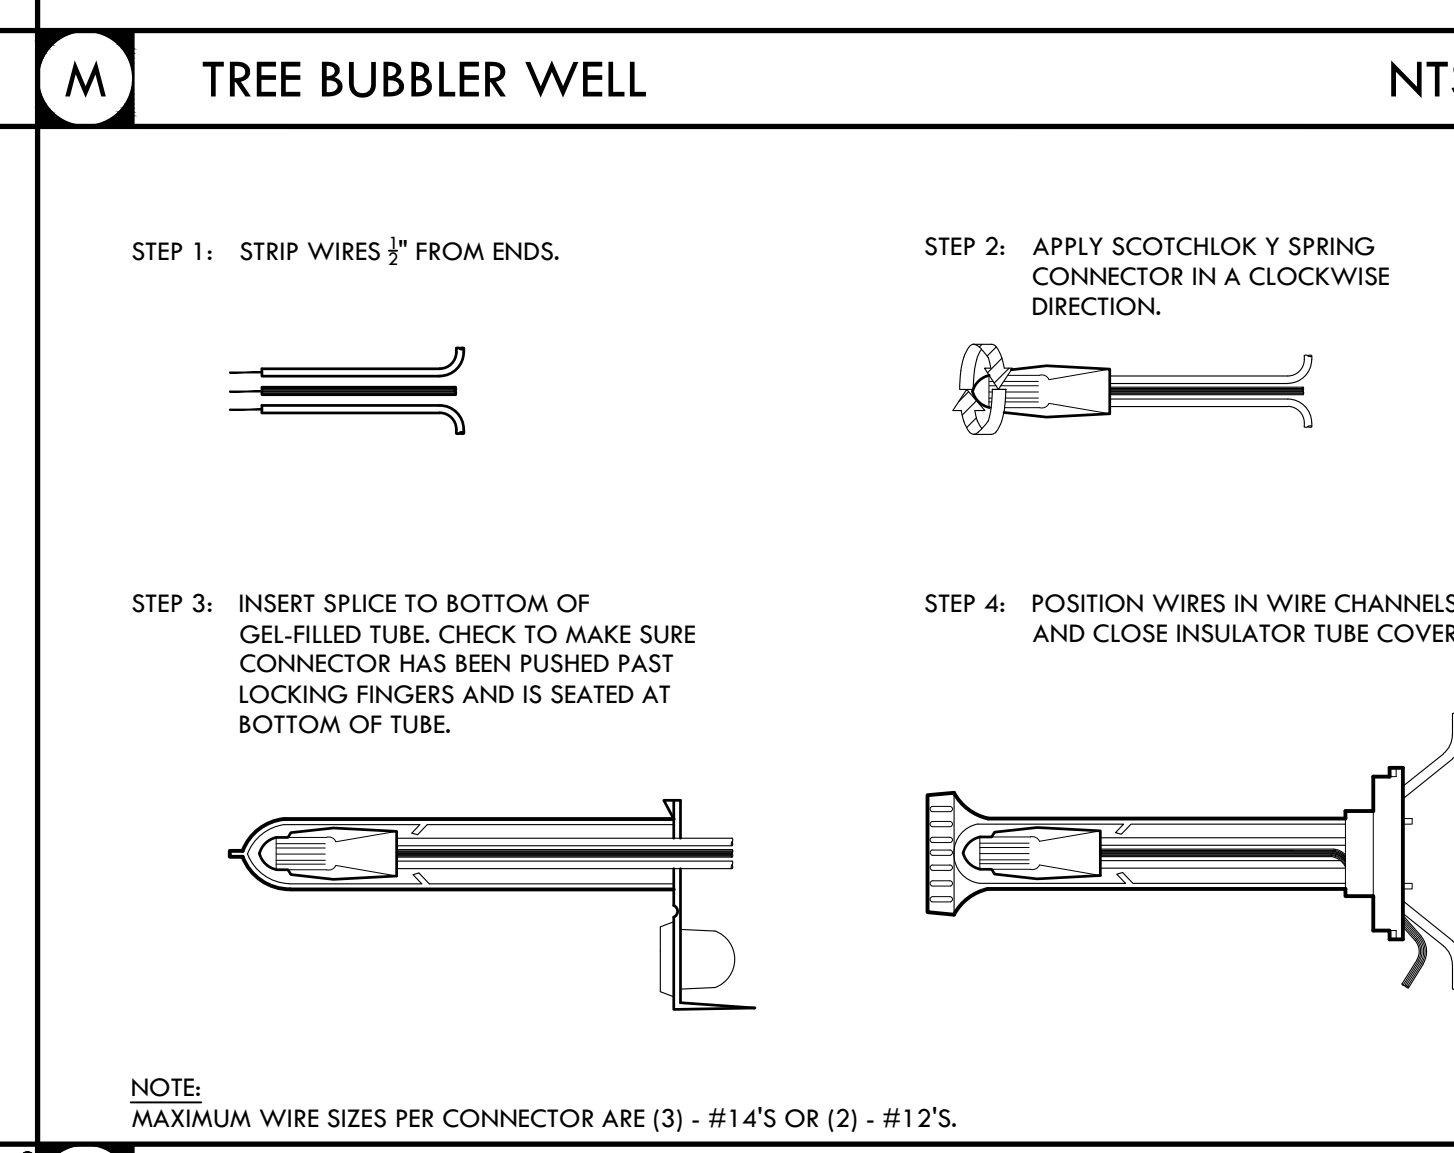
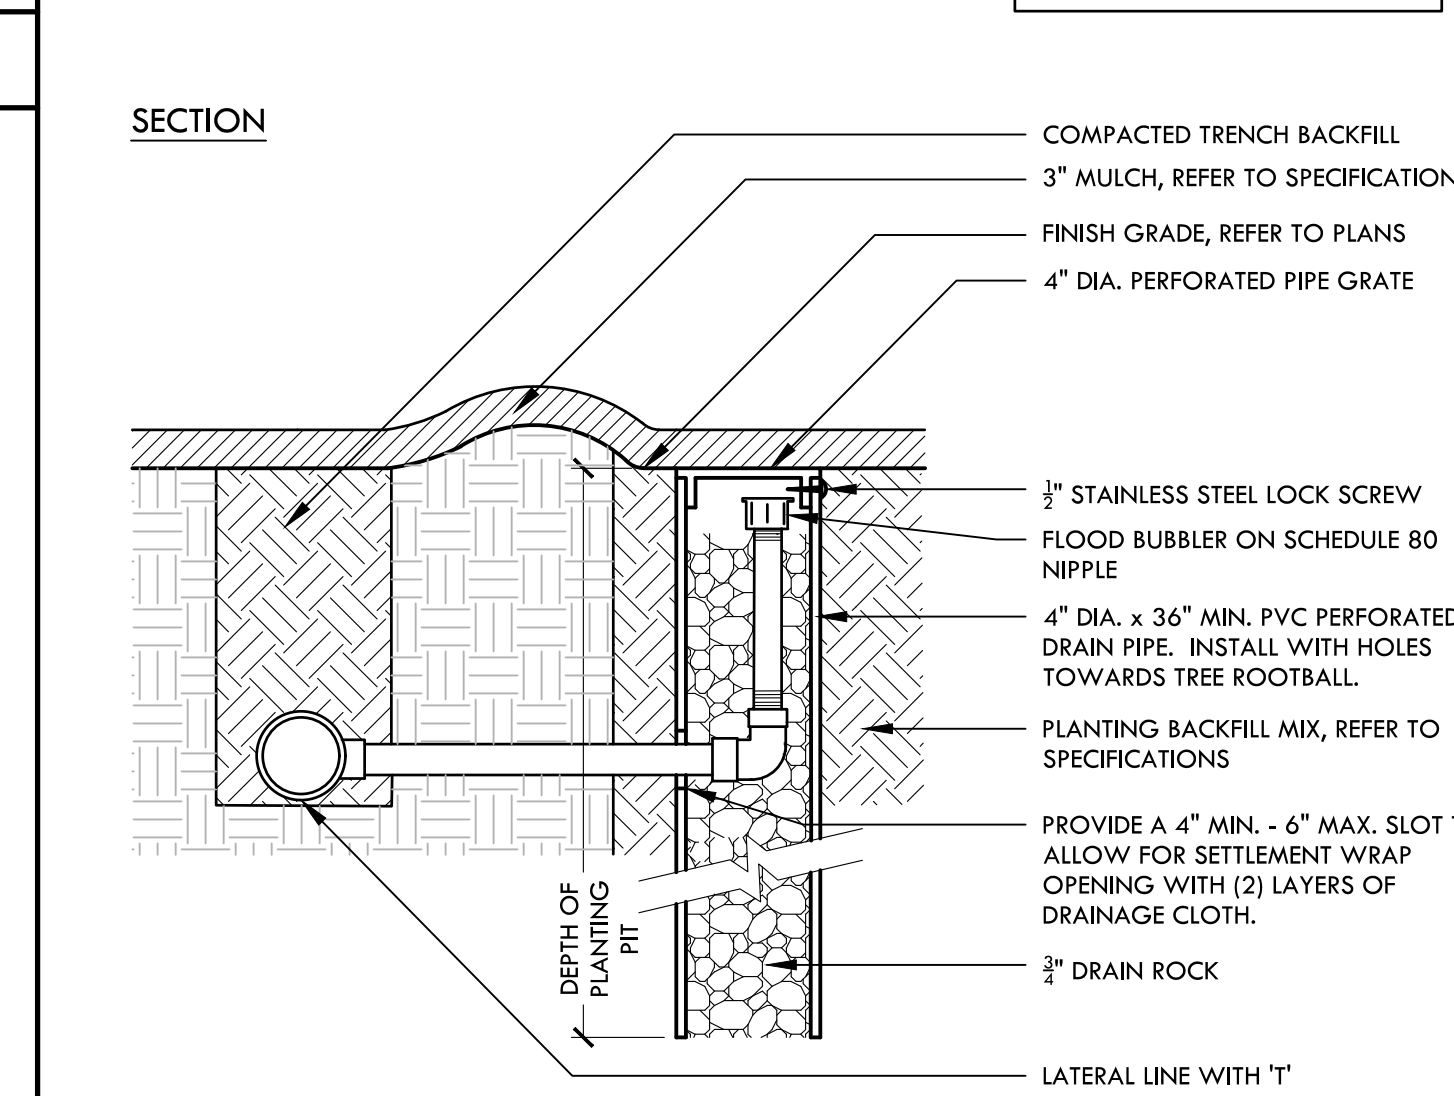
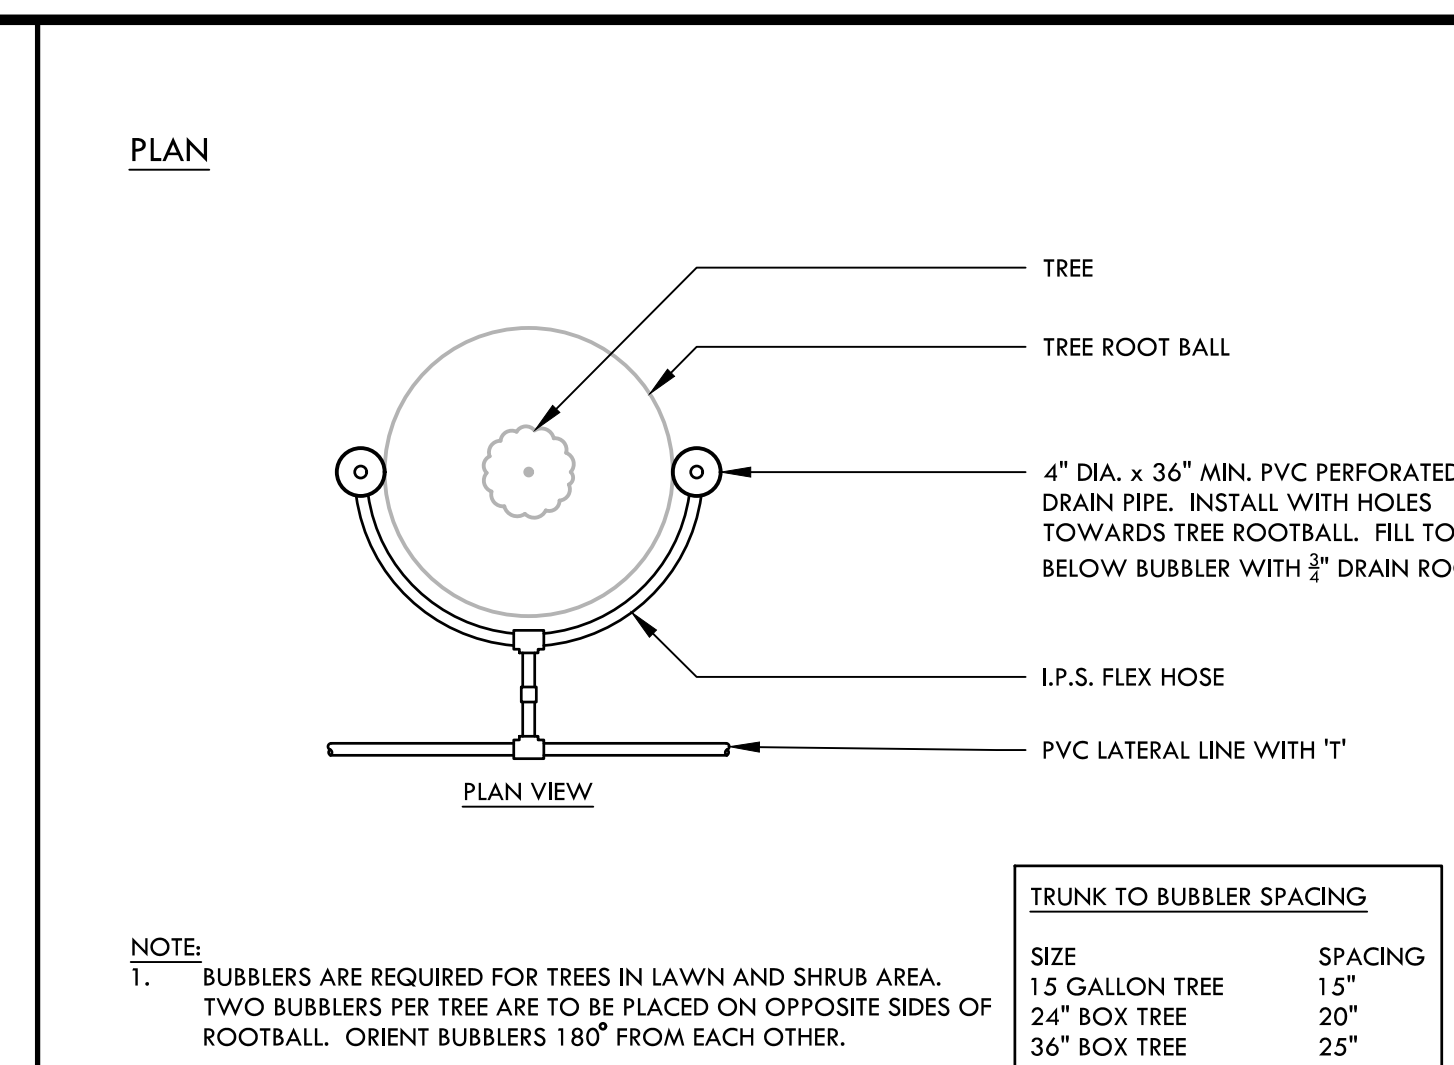
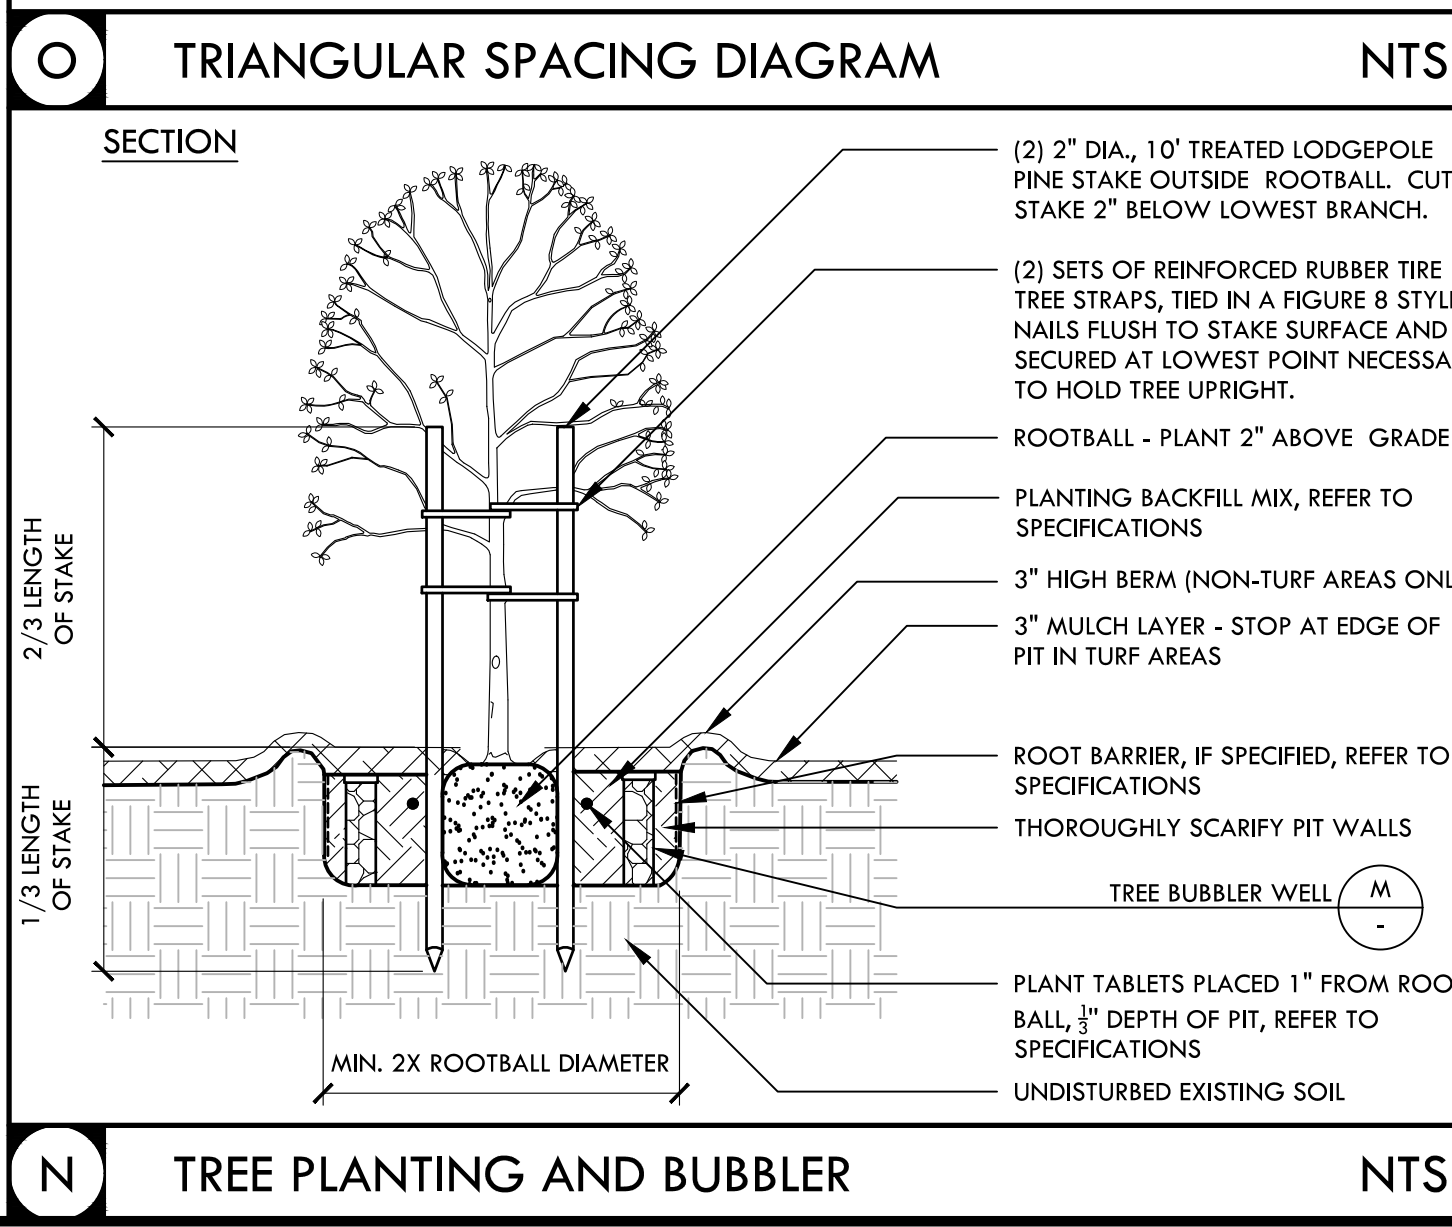
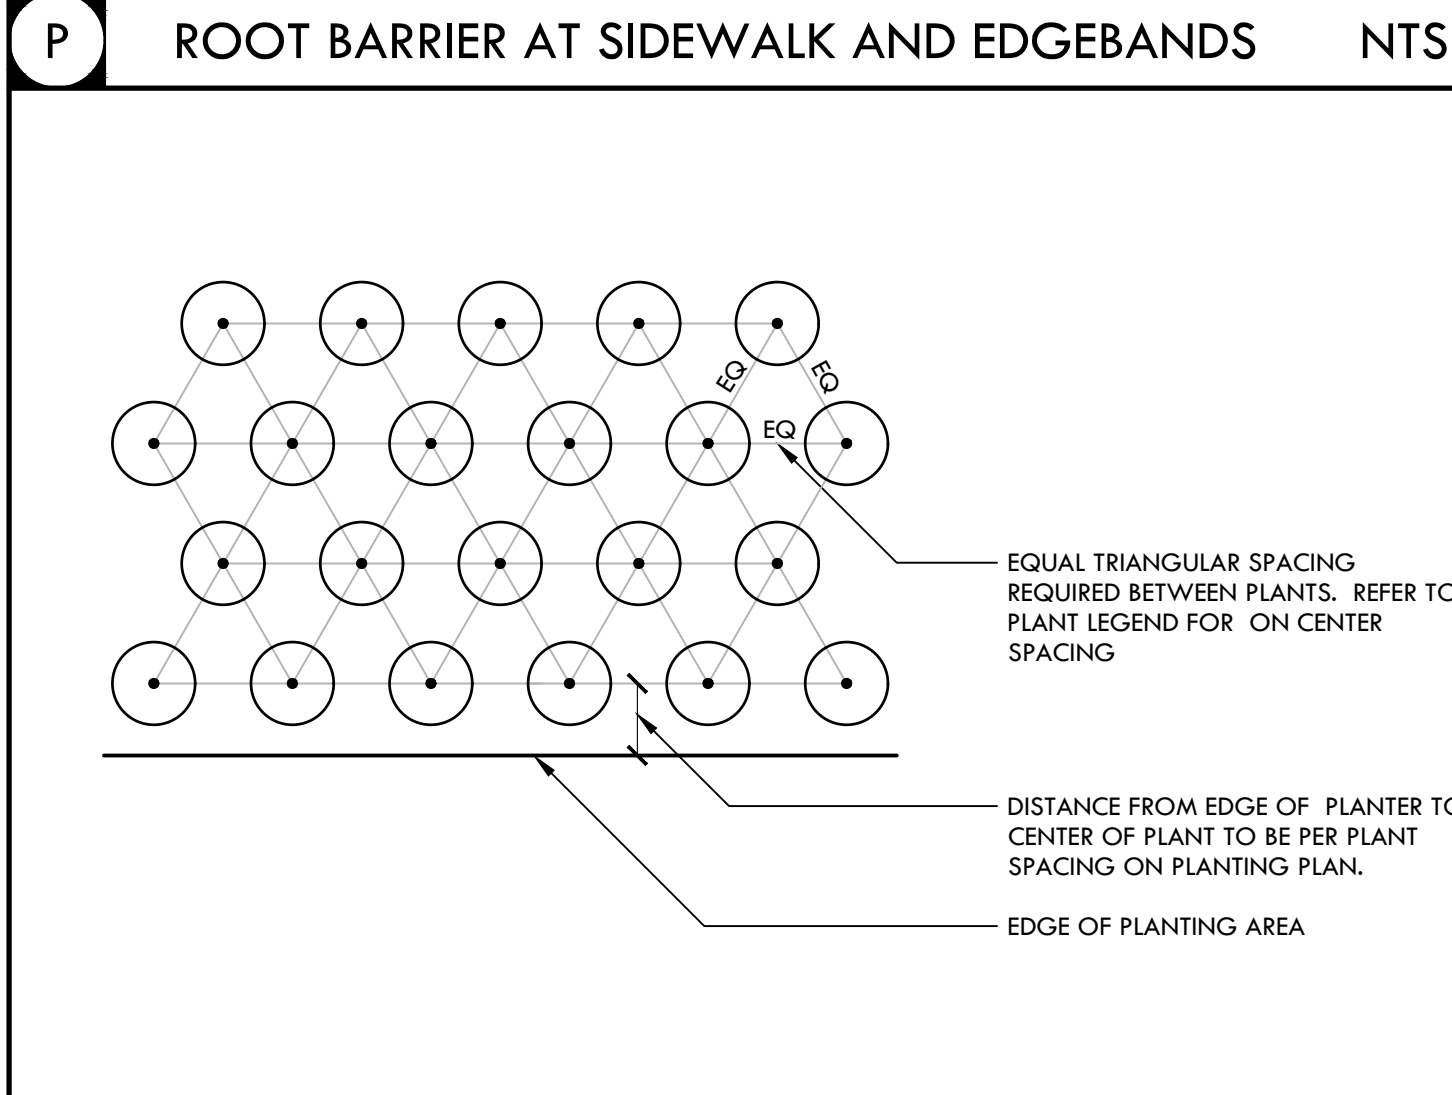
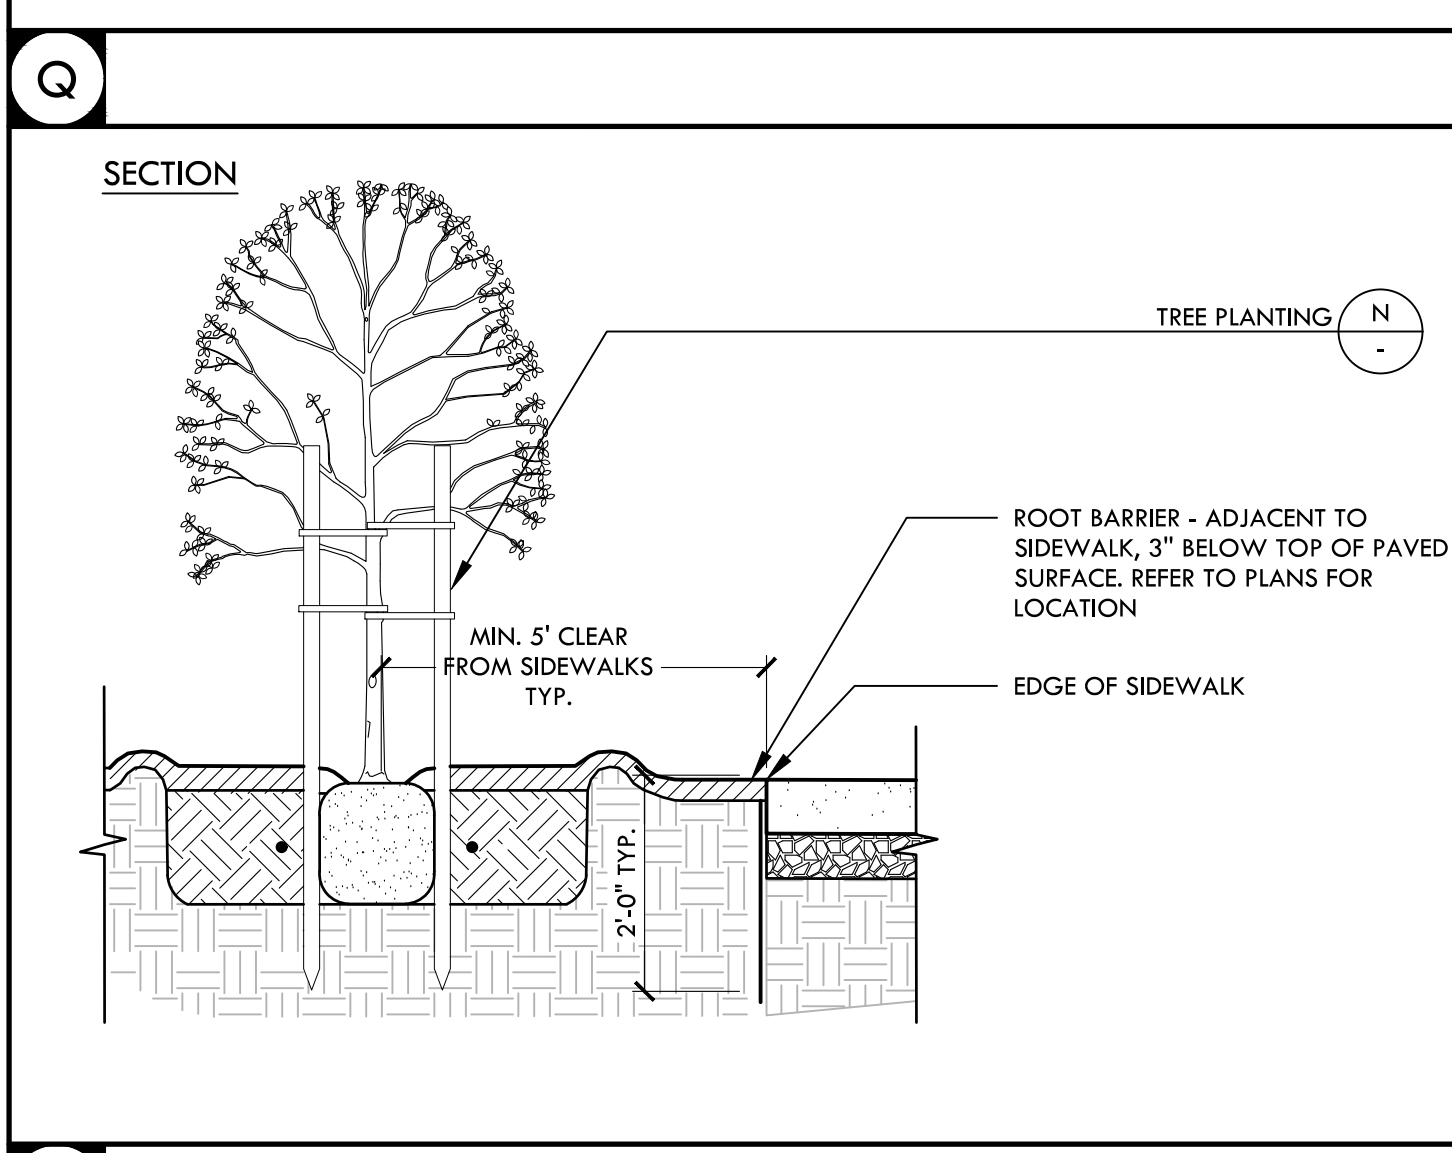
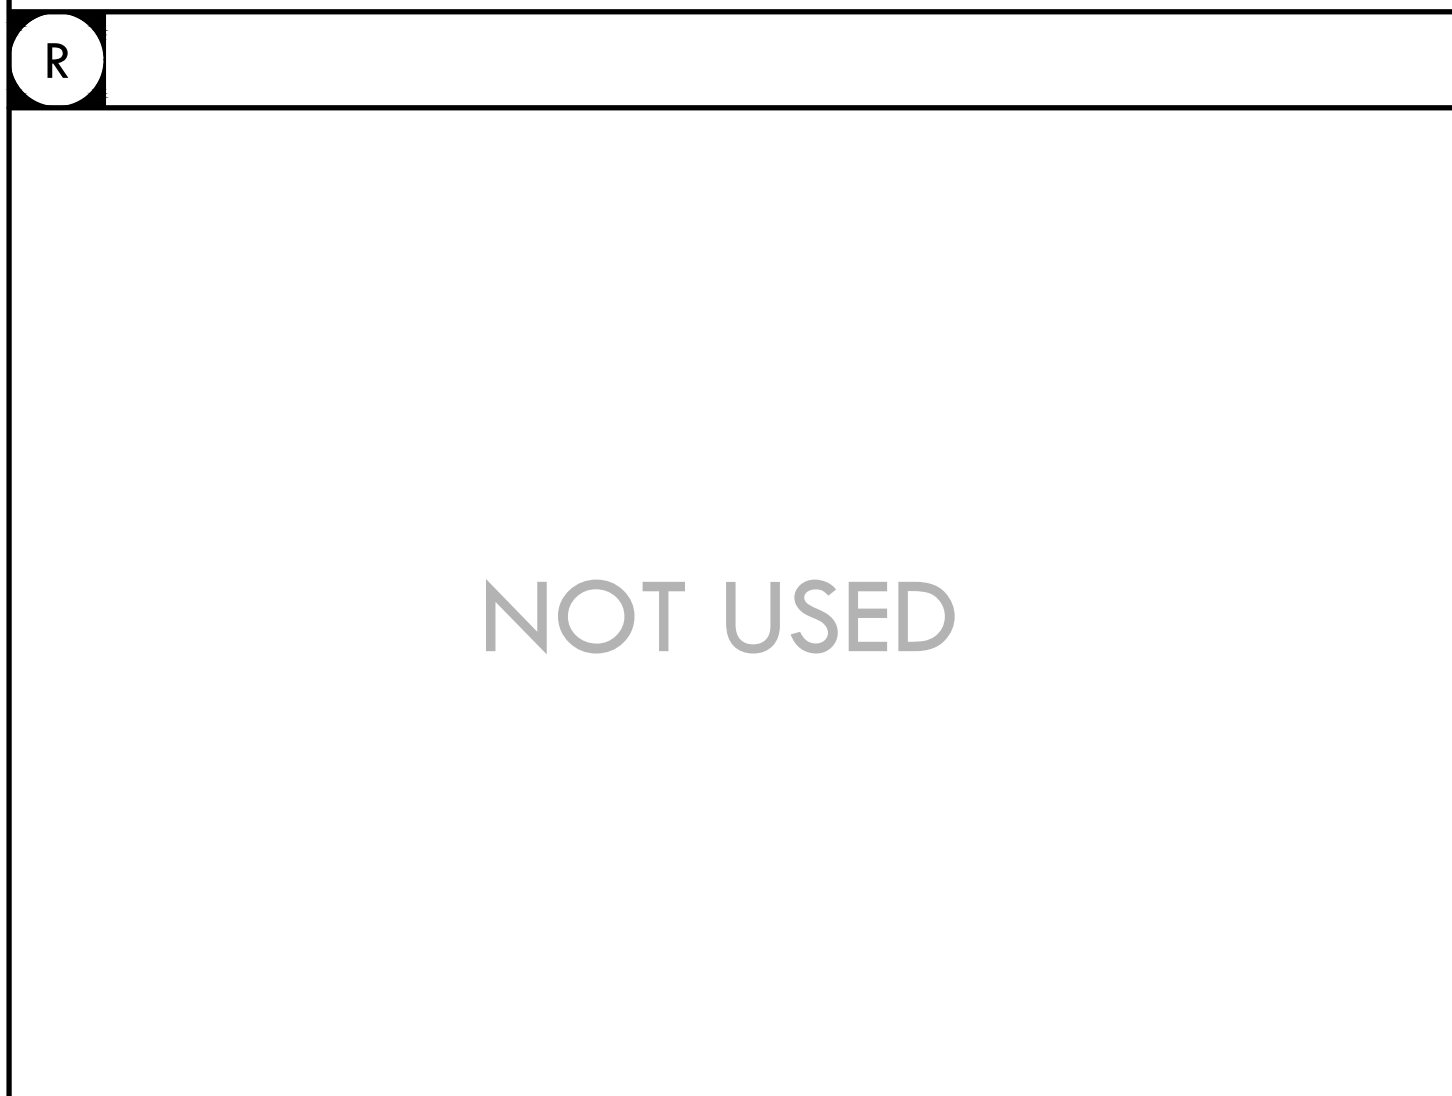
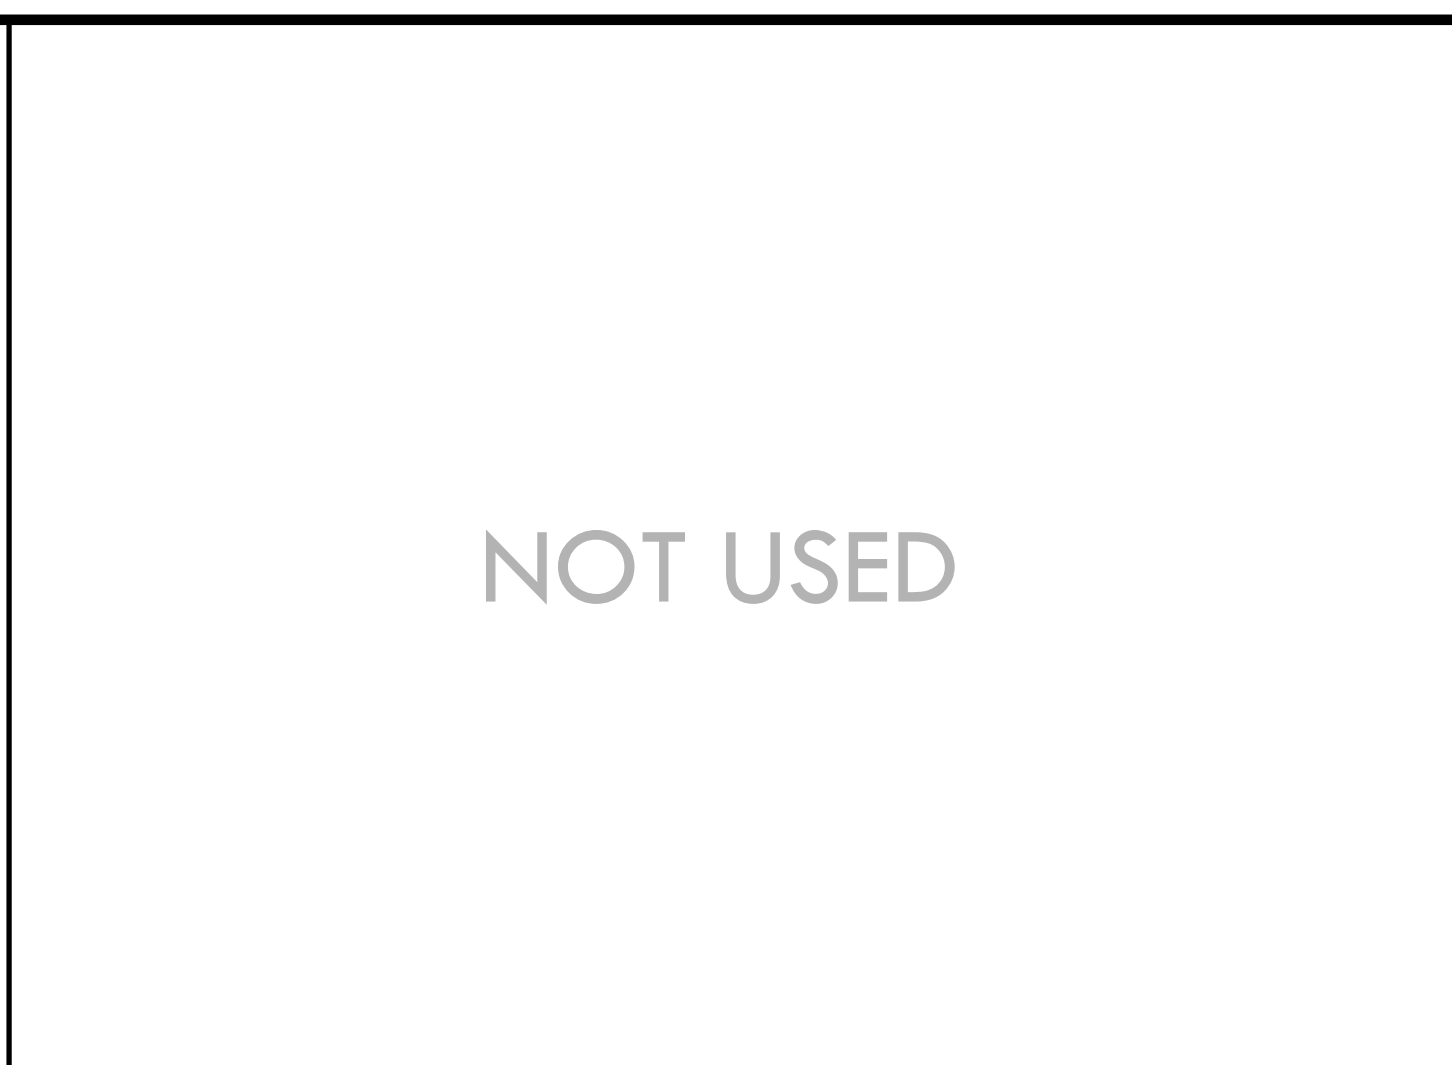
SHEET NO. D6.1

NTS

PLANTING AND IRRIGATION DETAILS

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 Fax: 916.415.6525
 www.VerdeDesign.com

REGISTERED LANDSCAPE ARCHITECT
 STATE OF CALIFORNIA
 EXPIRATION DATE: JULY 2023

CONSULTANT

KEYMAP

PLANTING AND IRRIGATION DETAILS

PROJECT NAME
HIRAM JOHNSON HIGH SCHOOL GOLF PRACTICE FACILITY, VARSITY BASEBALL AND SOFTBALL FIELDS

PROJECT ADDRESS
6879 14TH AVENUE SACRAMENTO, CA 95820

SUBMITTAL	DATE
DD 50% SUBMITTAL	04/15/22
100% DSA SUBMITTAL	05/27/22
DSA BACK CHECK	08/11/22
DSA ADDENDUM SUBMITTAL	09/16/22

NO.	REVISIONS	DATE
▲	ADDENDUM	09/16/22

DRAWN BY: **VDI** CHECKED BY: **MB/CS**
 DATE ISSUED: **09/16/2022** SCALE: **AS NOTED**
 PROJ. NO.: **2203200**

SHEET NO. **D6.2**
PLANTING AND IRRIGATION DETAILS

GENERAL

- 1. ALL CONSTRUCTION SHALL COMPLY WITH THE PROVISIONS OF THE 2019 CALIFORNIA BUILDING CODE (CBC), TITLE 24, PART 2, VOLUMES 1-2 (2018 INTERNATIONAL BUILDING CODE (IBC) WITH 2019 CALIFORNIA AMENDMENTS, INCLUDING SECTIONS AND 'A' CHAPTERS PERTAINING TO DSA--SS).

- 2. ALL DISCREPANCIES SHALL BE BROUGHT TO THE ATTENTION OF THE STRUCTURAL ENGINEER FOR DIRECTION PRIOR TO PROCEEDING.
- 3. DETAILS OF CONSTRUCTION ARE TYPICAL, UNLESS NOTED OTHERWISE, AND SHALL APPLY AT ALL LOCATIONS OF SIMILAR CONSTRUCTION. TYPICAL DETAILS ARE NOT CUT AT EVERY APPLICABLE LOCATION ON THE PLANS.

- 4. DO NOT SCALE DRAWINGS FOR DIMENSIONAL INFORMATION.
- 5. SHORING, TEMPORARY BRACING AND OTHER METHODS AND MEANS OF CONSTRUCTION IS THE RESPONSIBILITY OF THE CONTRACTOR, AND IS NOT INCLUDED IN THE SCOPE OF THE STRUCTURAL DRAWINGS.
- 6. THE FOLLOWING NOTES ARE FOR GENERAL MATERIAL GRADES AND PROCEDURES. SEE SPECIFICATIONS AND REMAINDER OF DRAWINGS FOR COMPLETE REQUIREMENTS. ITEMS NOTED IN PLANS, SECTIONS AND DETAILS TAKE PRECEDENCE OVER GENERAL NOTES.

STRUCTURAL ABBREVIATIONS

Table with 4 columns: A.B. APPROX ARCH, ANCHOR BOLT ADJ ADJ APPROX ARCH, I.D. INSIDE DIAMETER IN INCH INTERIOR, and various abbreviations like BLDG, BEAM, B.N., etc.

GEOTECHNICAL & FOUNDATIONS

- 1. GEOTECHNICAL CRITERIA USED FOR FOUNDATION DESIGN: a) GEOTECHNICAL REPORT BY WALLACE KUEHL & ASSOCIATES INC., STOCKTON, CA, REPORT NO. 11843.01P, DATED 04-17-18 & 02-02-22.
- 2. CONTINUOUS & SPREAD FOOTINGS: MINIMUM WIDTH: 12" (CONTINUOUS FOOTINGS) & 18" (SPREAD FOOTINGS) MINIMUM EMBEDMENT BELOW LOWEST ADJACENT FINISHED GRADE: 18"

STRUCTURAL CONCRETE

- 1. ALL CONCRETE WORK SHALL CONFORM TO CHAPTER 19A OF THE 2019 CALIFORNIA BUILDING CODE (CBC) AND 2014 ACI STANDARD 318 AND ASTM C94, SPECIFICATION FOR READY-MIX CONCRETE. CEMENT SHALL BE PORTLAND CEMENT TYPE II AND SHALL COMPLY WITH ASTM C150. CALCIUM CHLORIDE SHALL NOT BE USED.
- 2. ALL STRUCTURAL CONCRETE MIXES SHALL HAVE MIN. FIVE (5) SACKS CEMENT PER CU. YARD AND MAX. WATER-TO-CEMENT RATIO OF 0.60.

CONCRETE MASONRY

- 1. ALL CONCRETE UNIT MASONRY WORK SHALL CONFORM TO CHAPTER 21A OF THE 2019 CALIFORNIA BUILDING CODE (CBC) AND 2013 EDITIONS OF TMS 402/ACI 530/ASCE 5 AND TMS 602/ACI 530.1/ASCE 6.
- 2. ALL BLOCK UNITS SHALL BE NORMAL OR MEDIUM WEIGHT UNITS, WITH MINIMUM COMPRESSIVE STRENGTH OF 2,800 PSI, CONFORMING TO ASTM C90. MORTAR SHALL BE TYPE "S", CONFORMING TO ASTM C270.

POST-INSTALLED ANCHORS & DOWELS


- ANCHOR: POST-INSTALLED ANCHORS PROMOTED IN THE EVENT THAT REBAR OR CAST-IN-PLACE ANCHORS ARE MISSED OR INCORRECTLY PLACED, CONTRACTOR SHALL NOTIFY PROJECT INSPECTOR & SEOR ENGINEER FOR DIRECTIONS PRIOR TO PROCEEDING WITH INSTALLATION.
- GENERAL - APPLICABLE TO ALL ANCHORS: ANCHORS SHALL BE INSTALLED ONLY WHERE SPECIFIED ON DRAWINGS, PER MANUFACTURER'S INSTRUCTIONS, USING MANUFACTURER'S EQUIPMENT, WHERE APPLICABLE.

TESTING AND SPECIAL INSPECTIONS

- GENERAL: ALL TESTS AND SPECIAL INSPECTIONS SHALL CONFORM TO APPLICABLE REQUIREMENTS OF 2019 CALIFORNIA BUILDING CODE (CBC) SECTION 1701A AND APPROVED FORM DSA-103, 'STATEMENT OF STRUCTURAL TESTS AND SPECIAL INSPECTIONS'.
- FOUNDATIONS (DRILLED PIERS, FOOTINGS, GRADE BEAMS), WALLS AND SLABS-ON-GRADE: A) NOTIFY ENGINEER AND PROJECT INSPECTOR 48 HOURS BEFORE CONCRETE IS TO BE PLACED OR FORMS CLOSED TO ALLOW FOR INSPECTION OF EXCAVATIONS AND REINFORCING PLACEMENT.

VERDE DESIGN LANDSCAPE ARCHITECTURE CIVIL ENGINEERING SPORT PLANNING & DESIGN. AKH Structural Engineers, Inc. STRUCTURAL NOTES & MATERIAL GRADES. HIRAM JOHNSON HIGH SCHOOL GOLF PRACTICE FACILITY, VARSITY BASEBALL AND SOFTBALL FIELDS. 8799 14TH AVENUE SACRAMENTO, CA 95820


DRAWING NAME: P:\Verde Design\2022-016 Hiram Johnson 08 08 Golf Fields\dwg\Structural\ST-1 Structural Notes.dwg PLOT DATE: 09-15-22 FLOTTED BY: jsoe

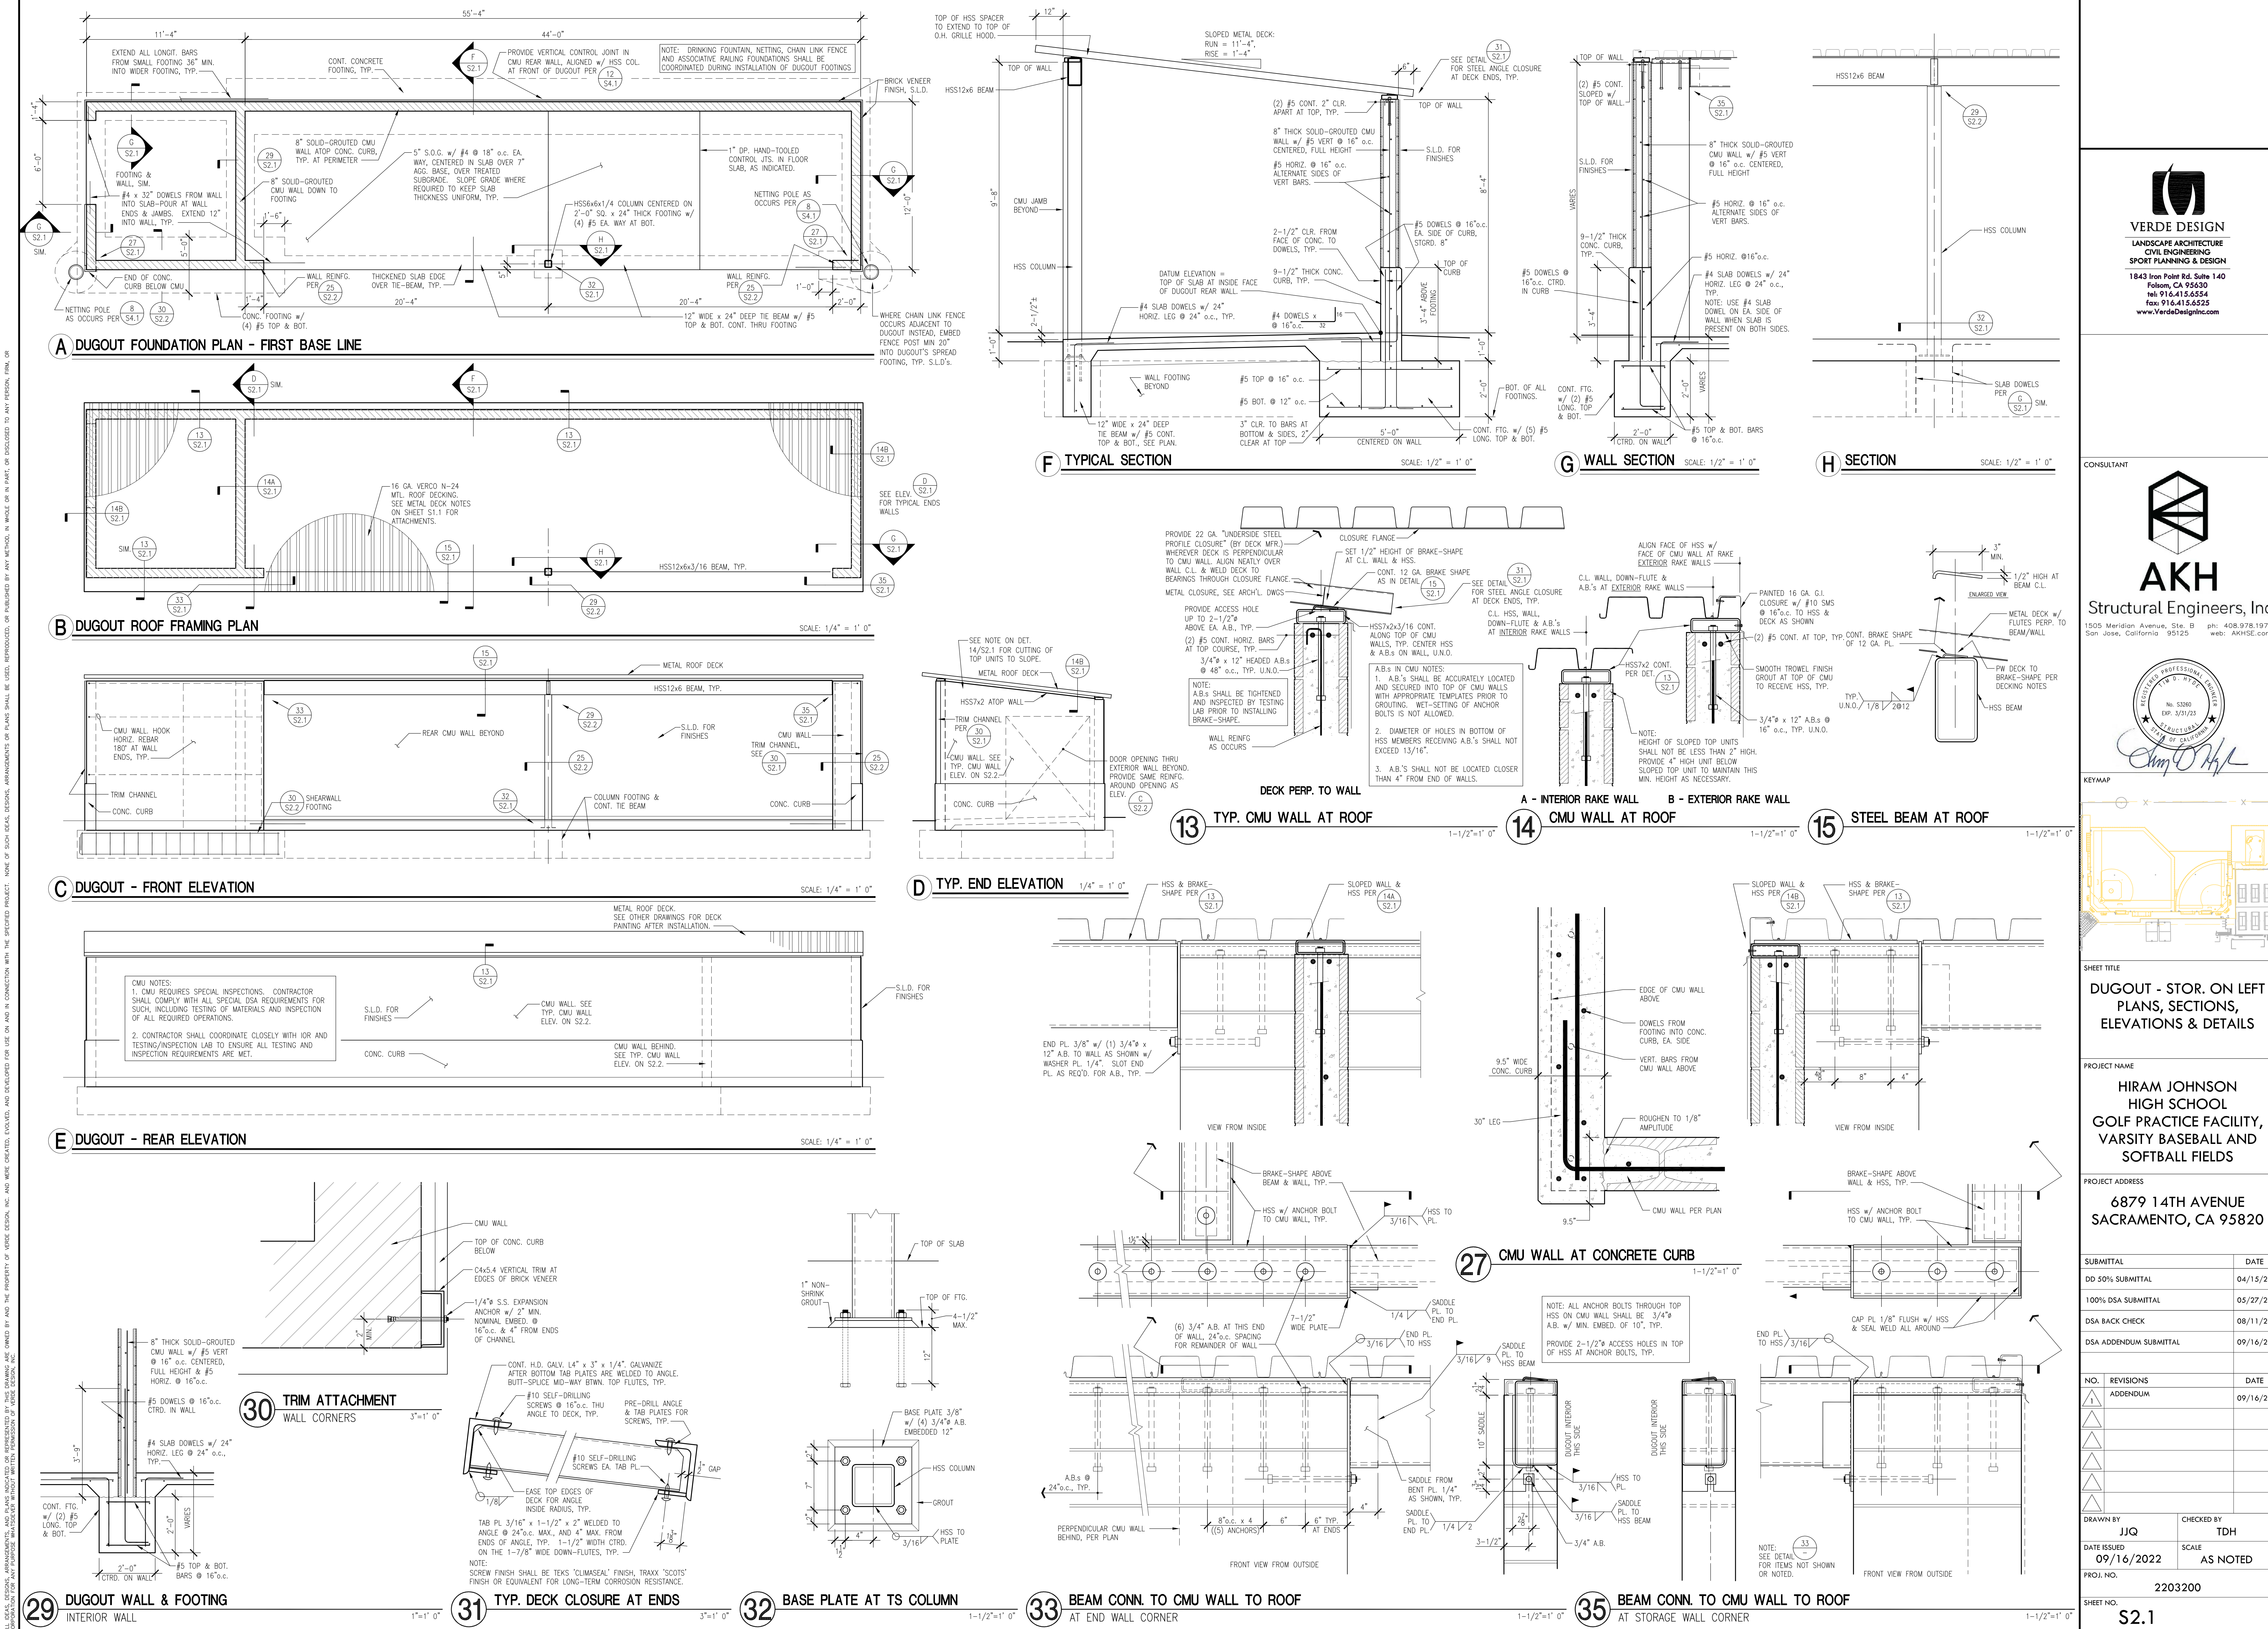

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 web: AKHSE.com

Professional Engineer
 No. 52960
 Exp. 3/31/23
 State of California
Chm O Hyl

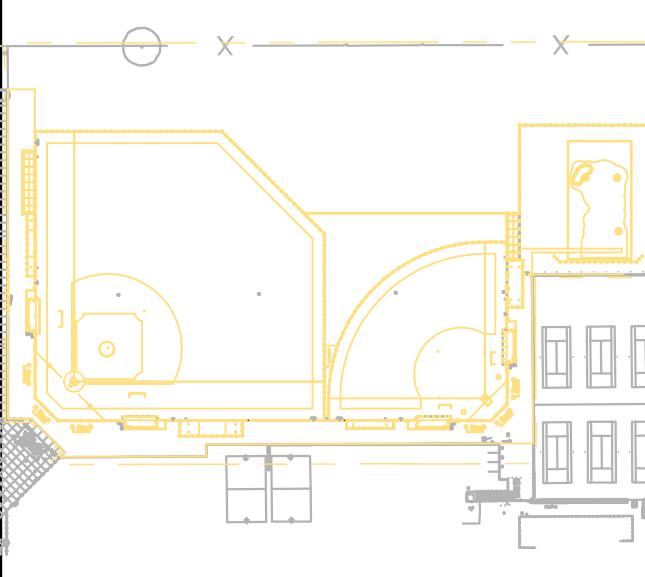

SHEET TITLE
 DUGOUT - STOR. ON LEFT
 PLANS, SECTIONS,
 ELEVATIONS & DETAILS

PROJECT NAME
 HIRAM JOHNSON
 HIGH SCHOOL
 GOLF PRACTICE FACILITY,
 VARSITY BASEBALL AND
 SOFTBALL FIELDS


PROJECT ADDRESS
 6879 14TH AVENUE
 SACRAMENTO, CA 95820

SUBMITTAL	DATE
DD 50% SUBMITTAL	04/15/22
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DSA ADDENDUM SUBMITTAL	09/16/22

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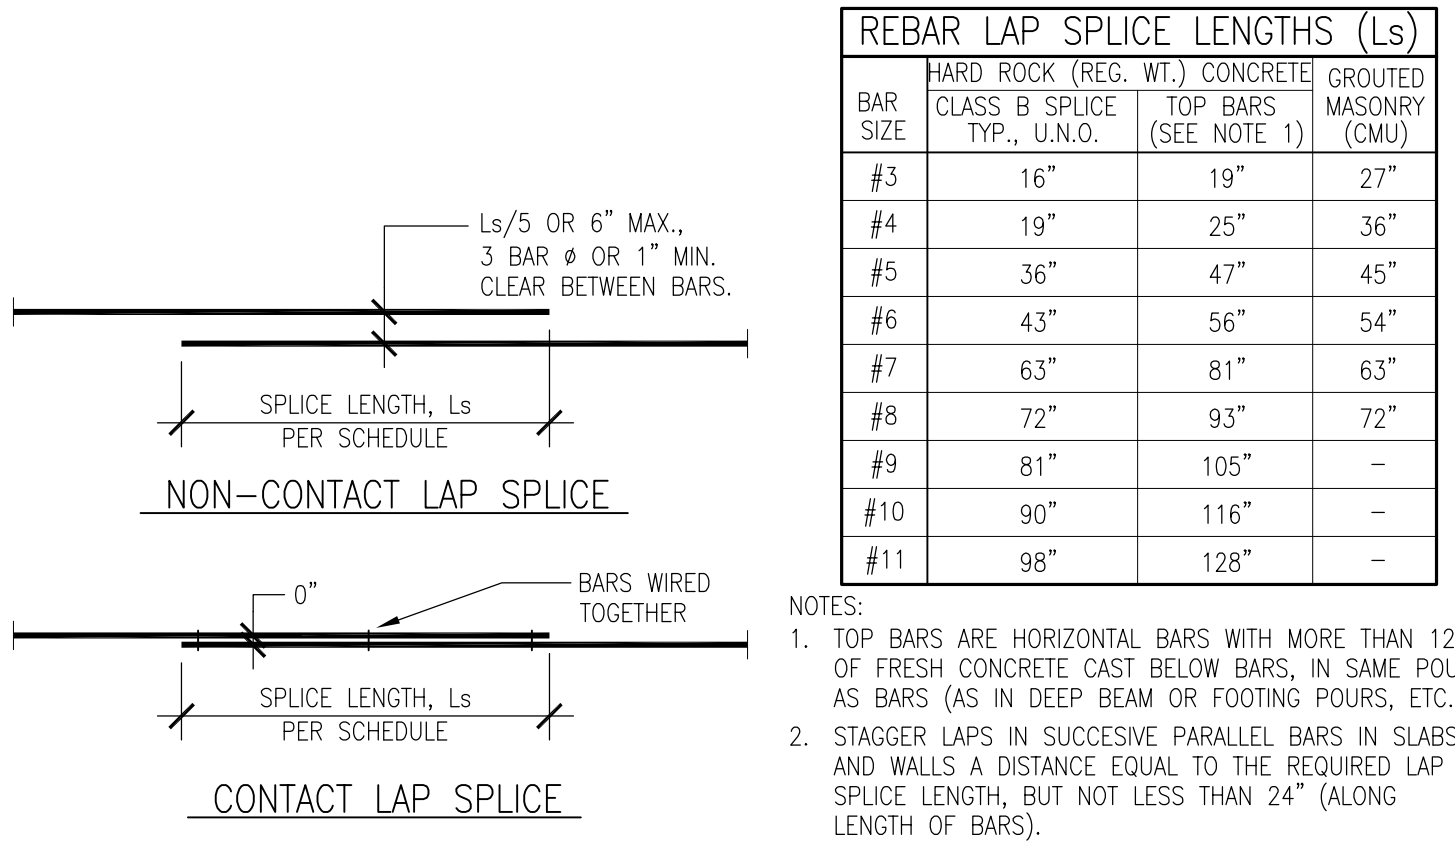
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CHECKED BY TDH
DATE ISSUED 09/16/2022
SCALE AS NOTED
PROJ. NO. 2203200

SHEET NO.
S2.1

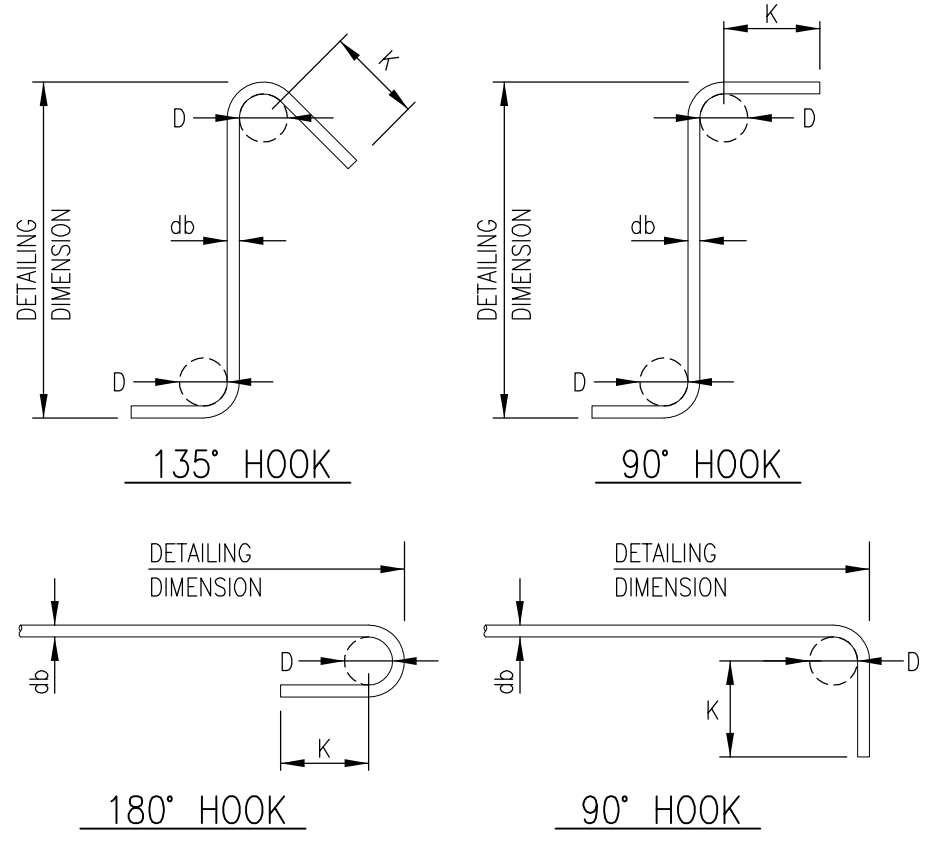




STANDARD HOOKS			
BAR SIZE	180° HOOKS	135° HOOKS	90° HOOKS
#3	2-1/4"	2-1/2"	4-1/2"
#4	3"	2-1/2"	6"
#5	3-3/4"	2-1/2"	7-1/2"
#6	4-1/2"	3"	9"
#7	5-1/4"	3-1/2"	10-1/2"
#8	6"	4"	12"

STIRRUP AND TIE HOOKS			
BAR SIZE	180° HOOKS	135° HOOKS	90° HOOKS
#3	1-1/2"	2-1/2"	3"
#4	2"	2-1/2"	3"
#5	2-1/2"	2-1/2"	3-3/4"
#6	4-1/2"	3"	4-1/2"



1 TYPICAL REBAR BENDS AND HOOKS




3 TYPICAL REBAR LAP SPLICES

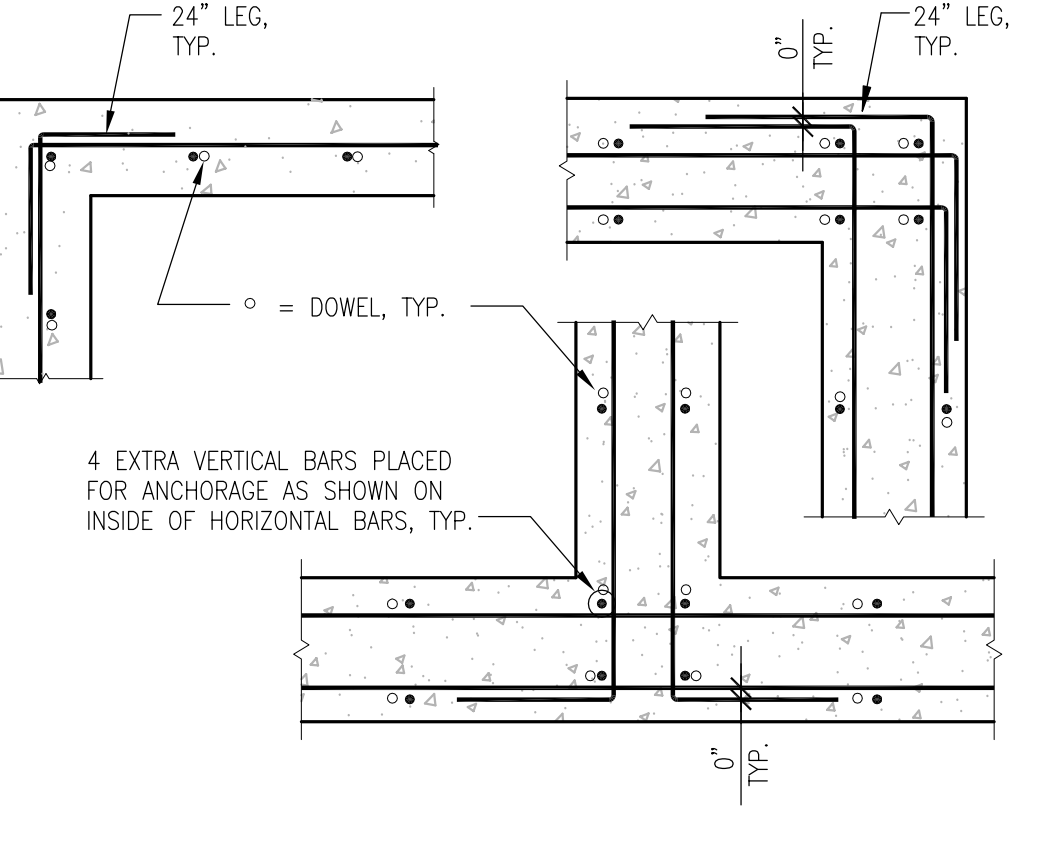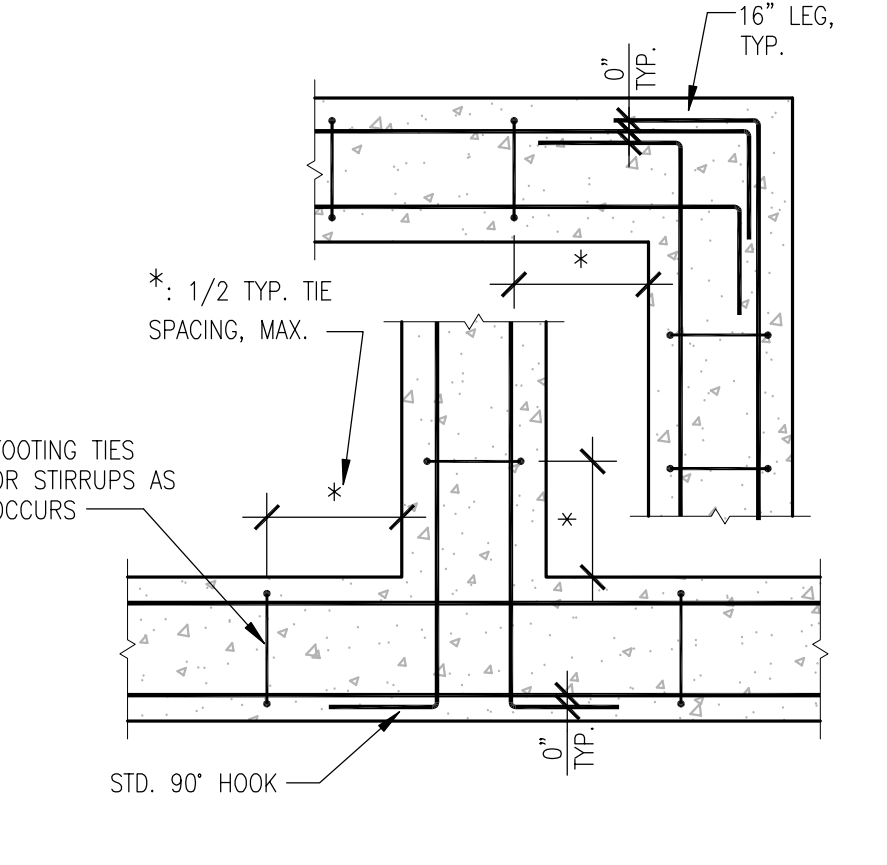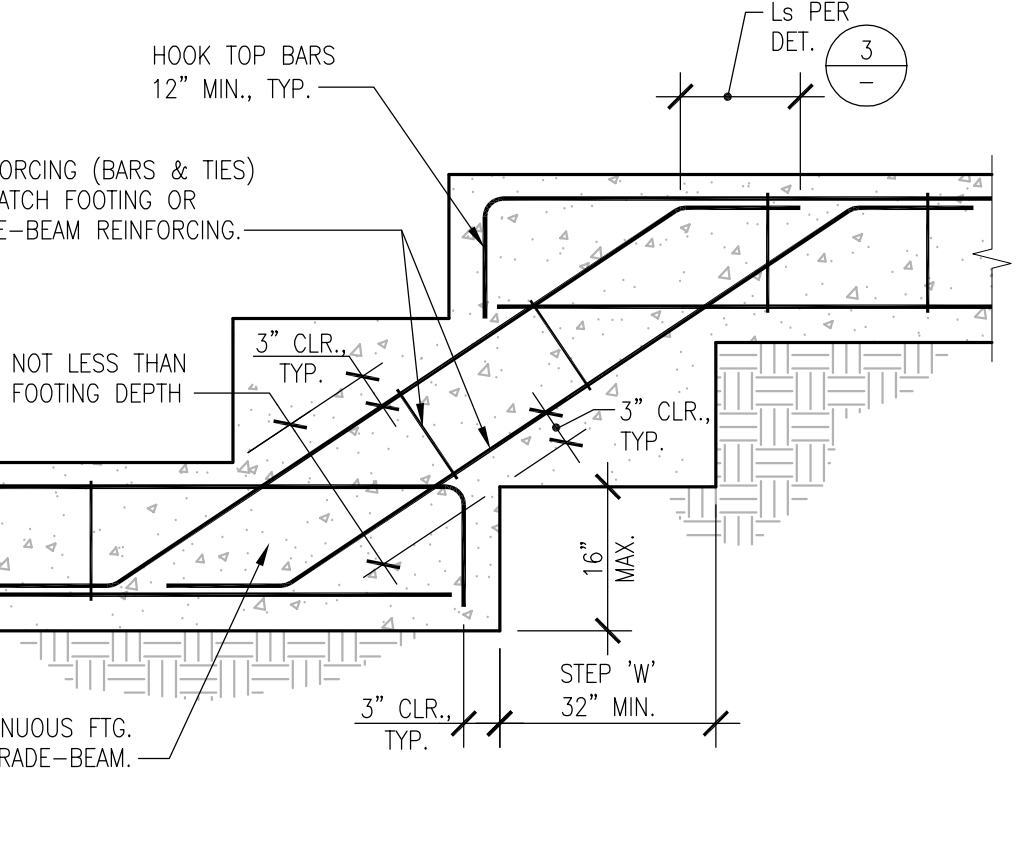

5 TYPICAL FOOTING STEPS

6 TYP. FOOTING INTERSECTION REBAR

7 TYP. WALL INTERSECTION REBAR

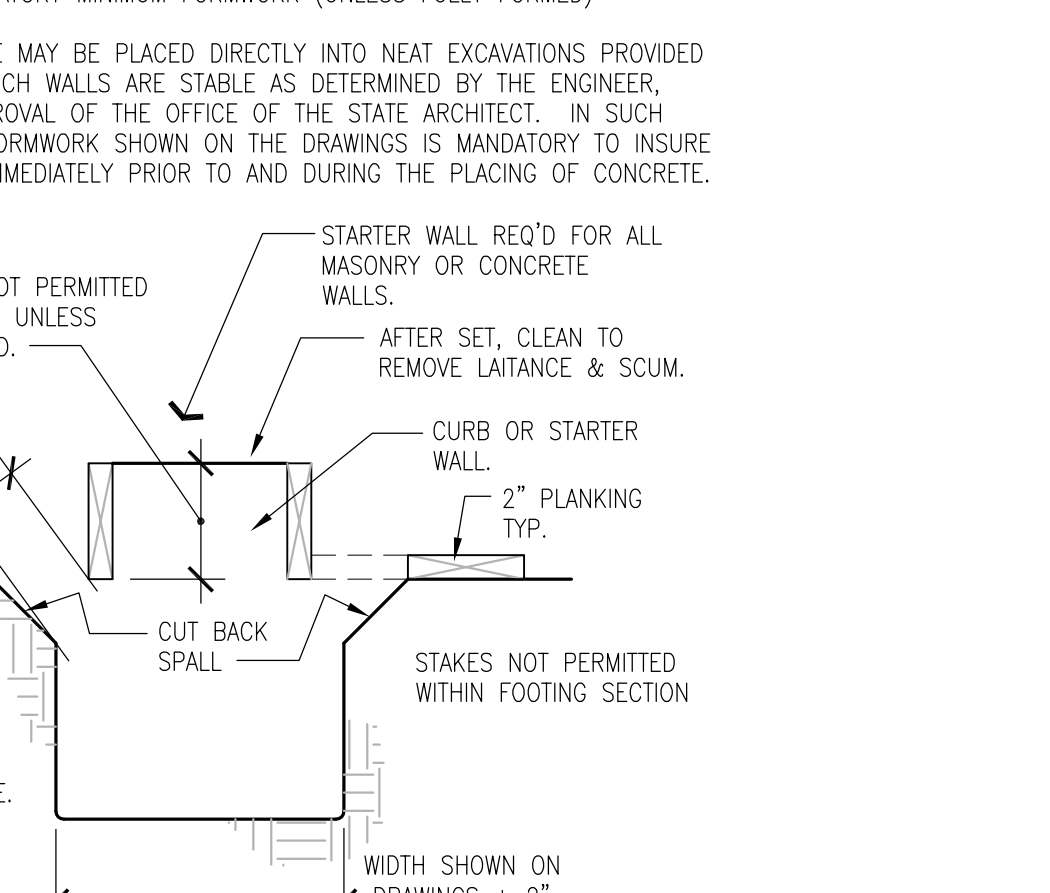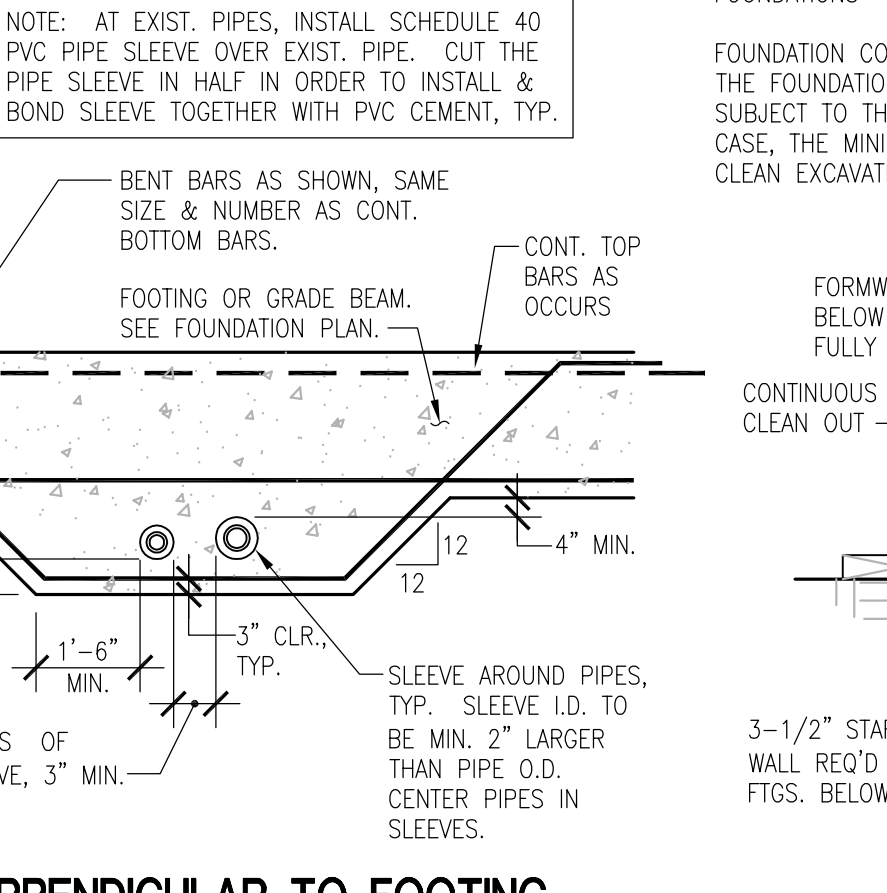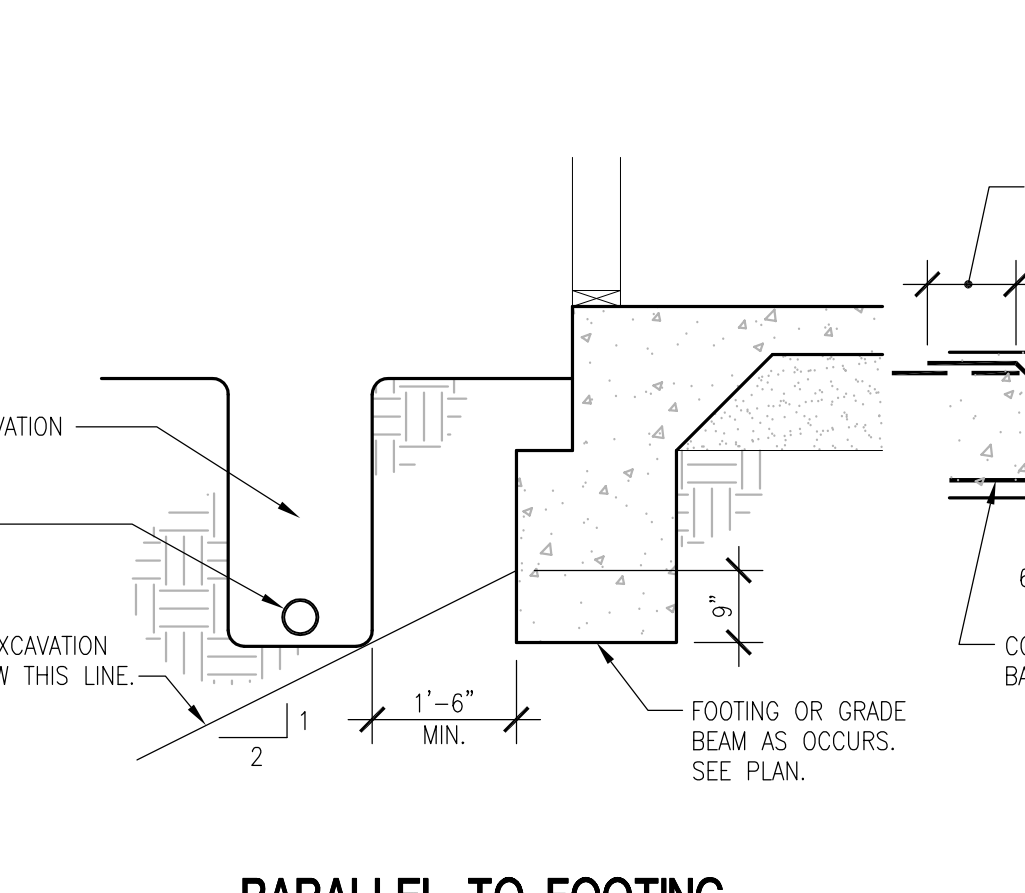

8 TYP. PIPES AND EXCAVATIONS NEAR FOOTINGS




11 TYP. FOOTING TRENCHING & FORMING

MINIMUM ANCHOR BOLT EMBEDMENT, Le (1)			
ANCHOR BOLT DIAMETER (d)	IN TOP OF CONCRETE & MASONRY (CMU) COLUMNS & PILASTERS	IN CONCRETE FOOTINGS, SLABS & WALLS	IN MASONRY (CMU) WALLS
3/8"	6"	4"	4"
1/2"	7"	5"	5"
5/8"	8"	5"	5-1/2"
3/4"	10"	6"	5-1/2"
7/8"	10"	7"	6" (6)
1" - 1-1/4"	12"	7"	10"

TYP. WALL INTERSECTION PLAN			
SEE NOTE 4.	SEE NOTE 7.	SEE NOTES 2 & 3.	FOOTING AS OCCURS

12 TYP. A.B. EMBEDMENTS

13 TYP. MASONRY WALL

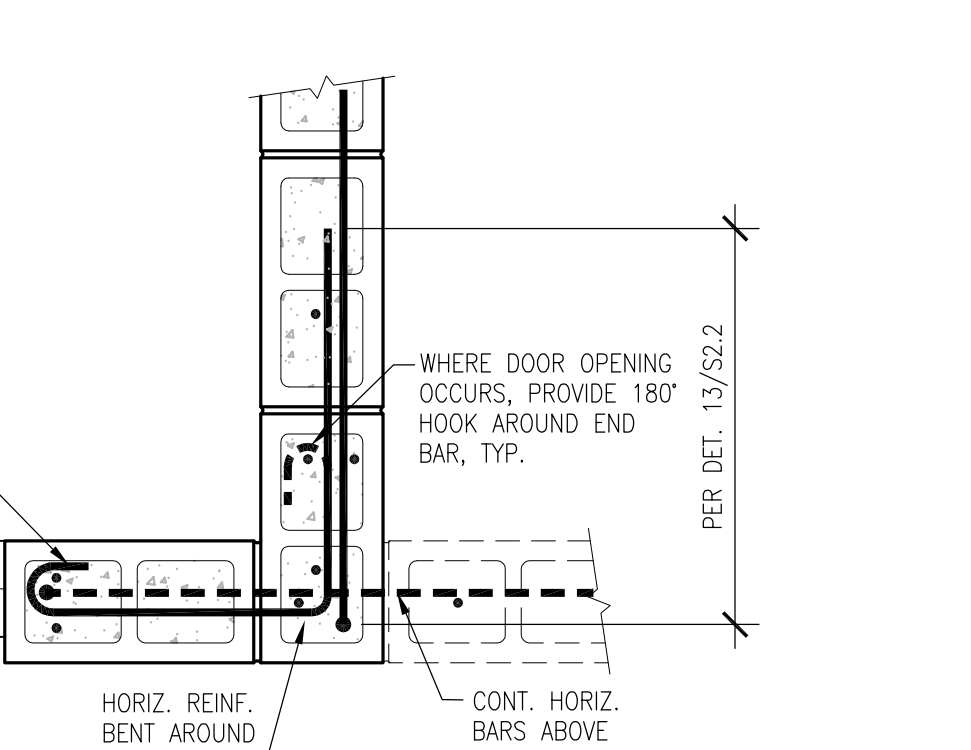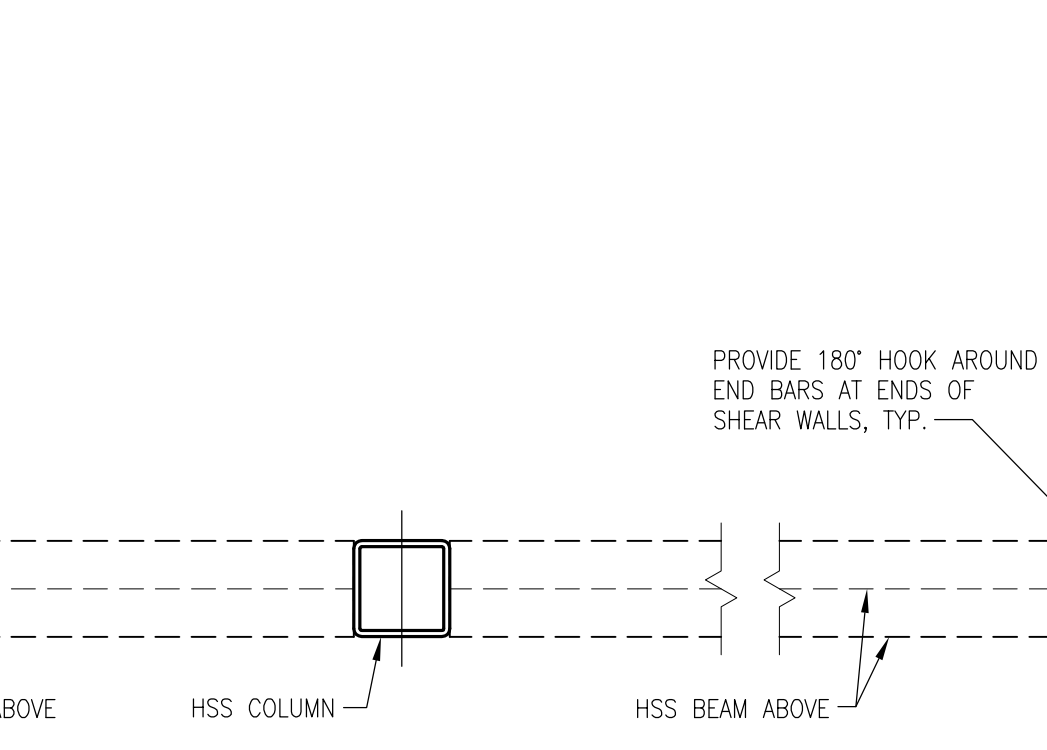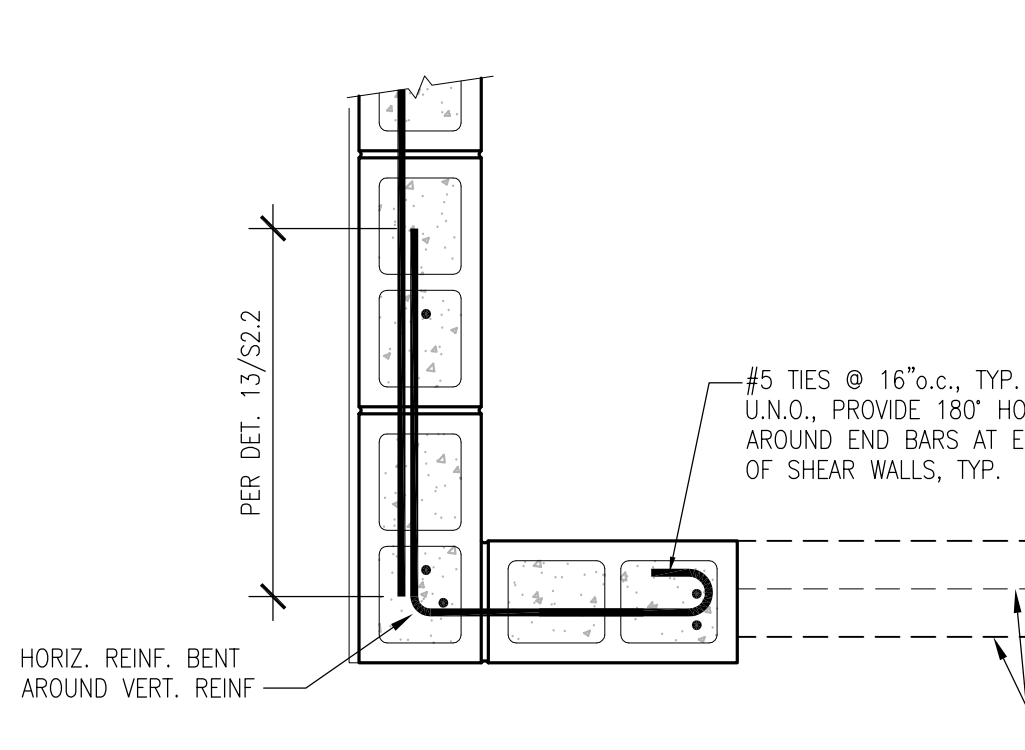


25 WALL REINFORCING PLAN AT DUGOUT OPENING

28 CONT. INTERIOR FOOTING


29 HSS BEAM CONNECTION AT HSS COLUMN

30 SHEARWALL FOOTING


J DUGOUT FOUNDATION PLAN - THIRD BASE LINE WITH STORAGE ROOM

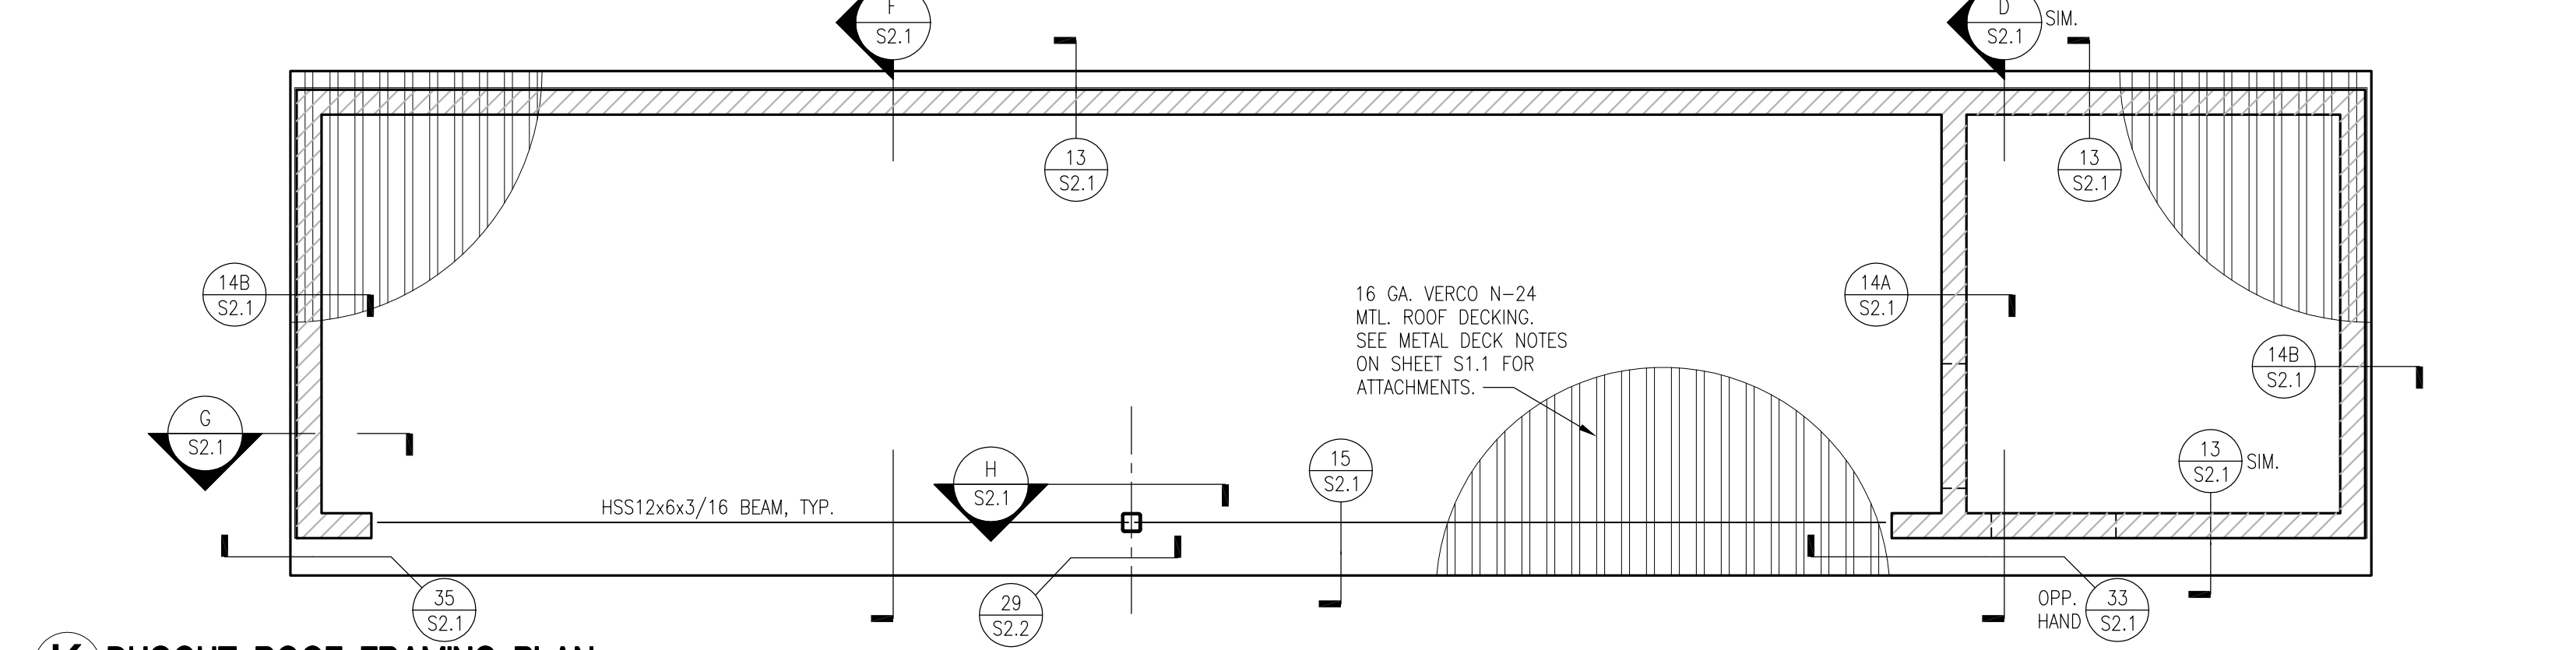


K DUGOUT ROOF FRAMING PLAN

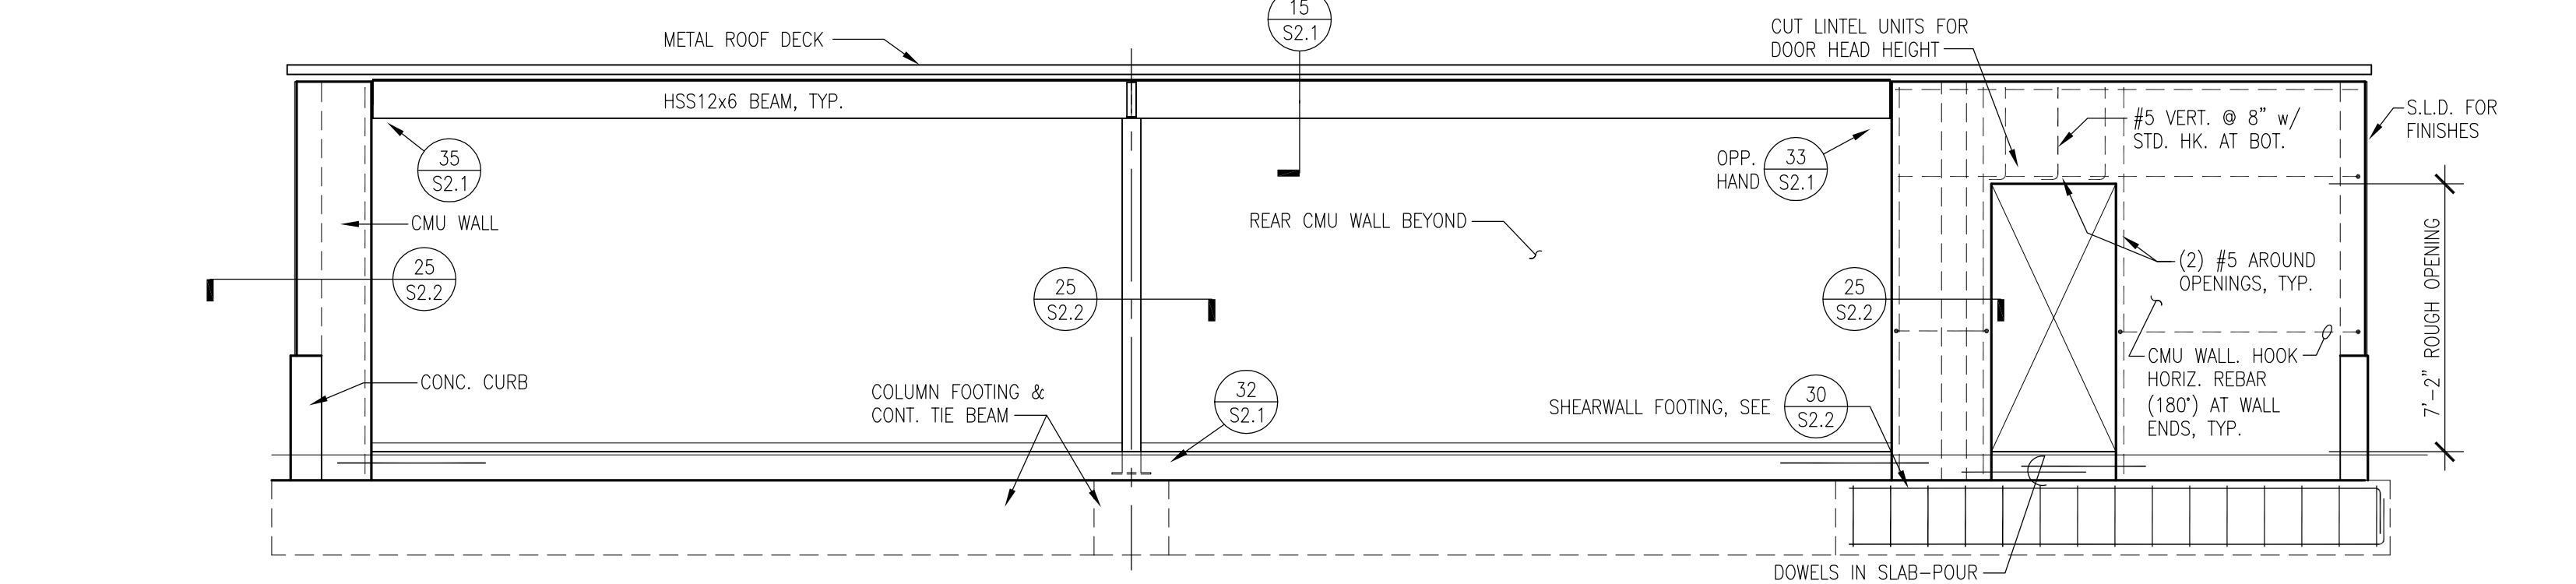

L DUGOUT - FRONT ELEVATION

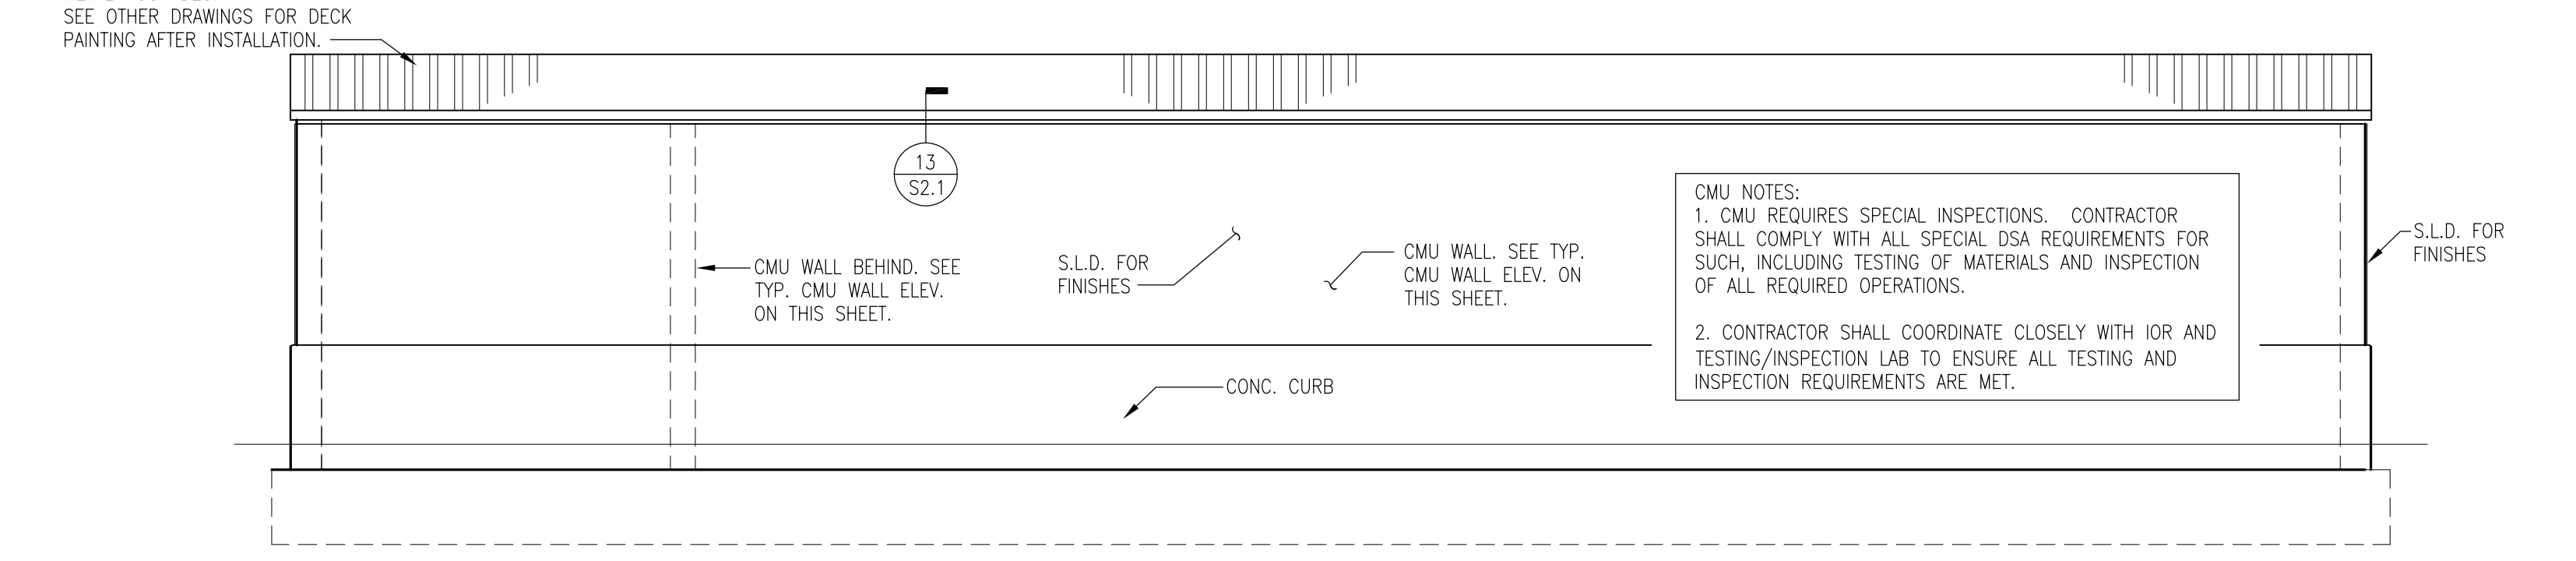

M DUGOUT - REAR ELEVATION

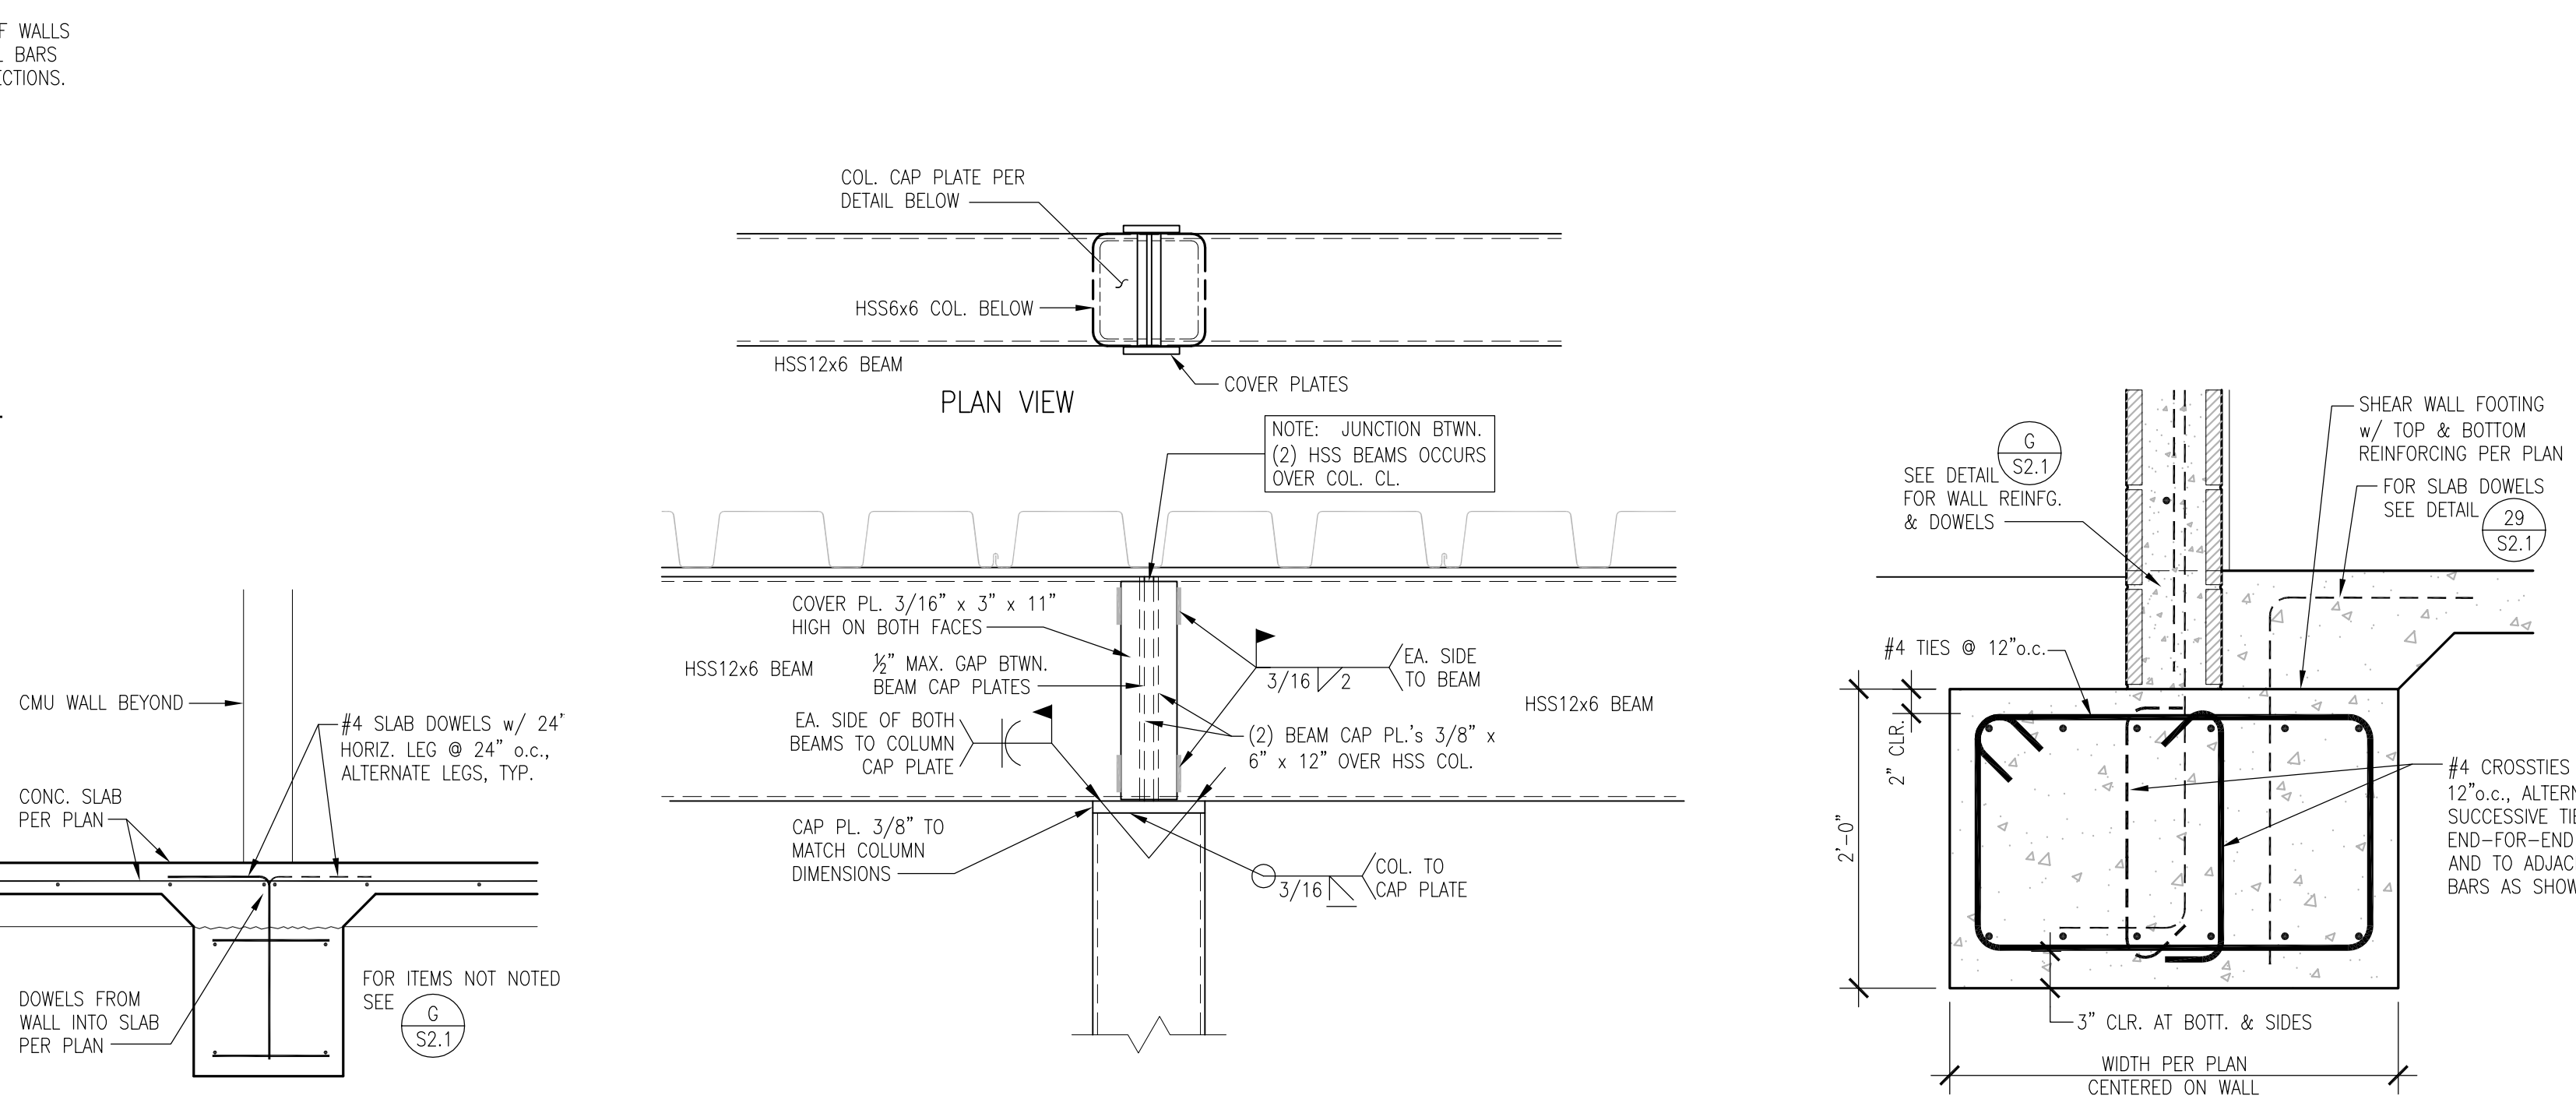


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CONSULTANT

 Chris D. Hylleberg



SHEET TITLE
**DUGOUT, STOR. ON RIGHT
 PLANS, ELEVATIONS &
 DETAILS**

PROJECT NAME
**HIRAM JOHNSON
 HIGH SCHOOL
 GOLF PRACTICE FACILITY,
 VARSITY BASEBALL AND
 SOFTBALL FIELDS**

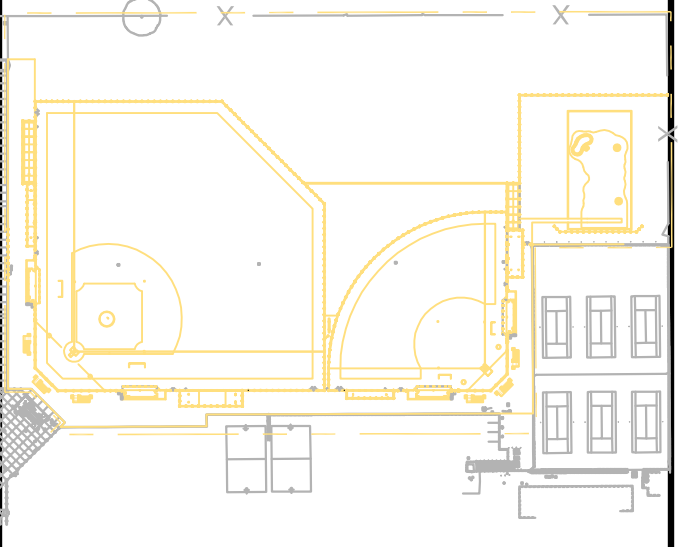PROJECT ADDRESS
**6879 14TH AVENUE
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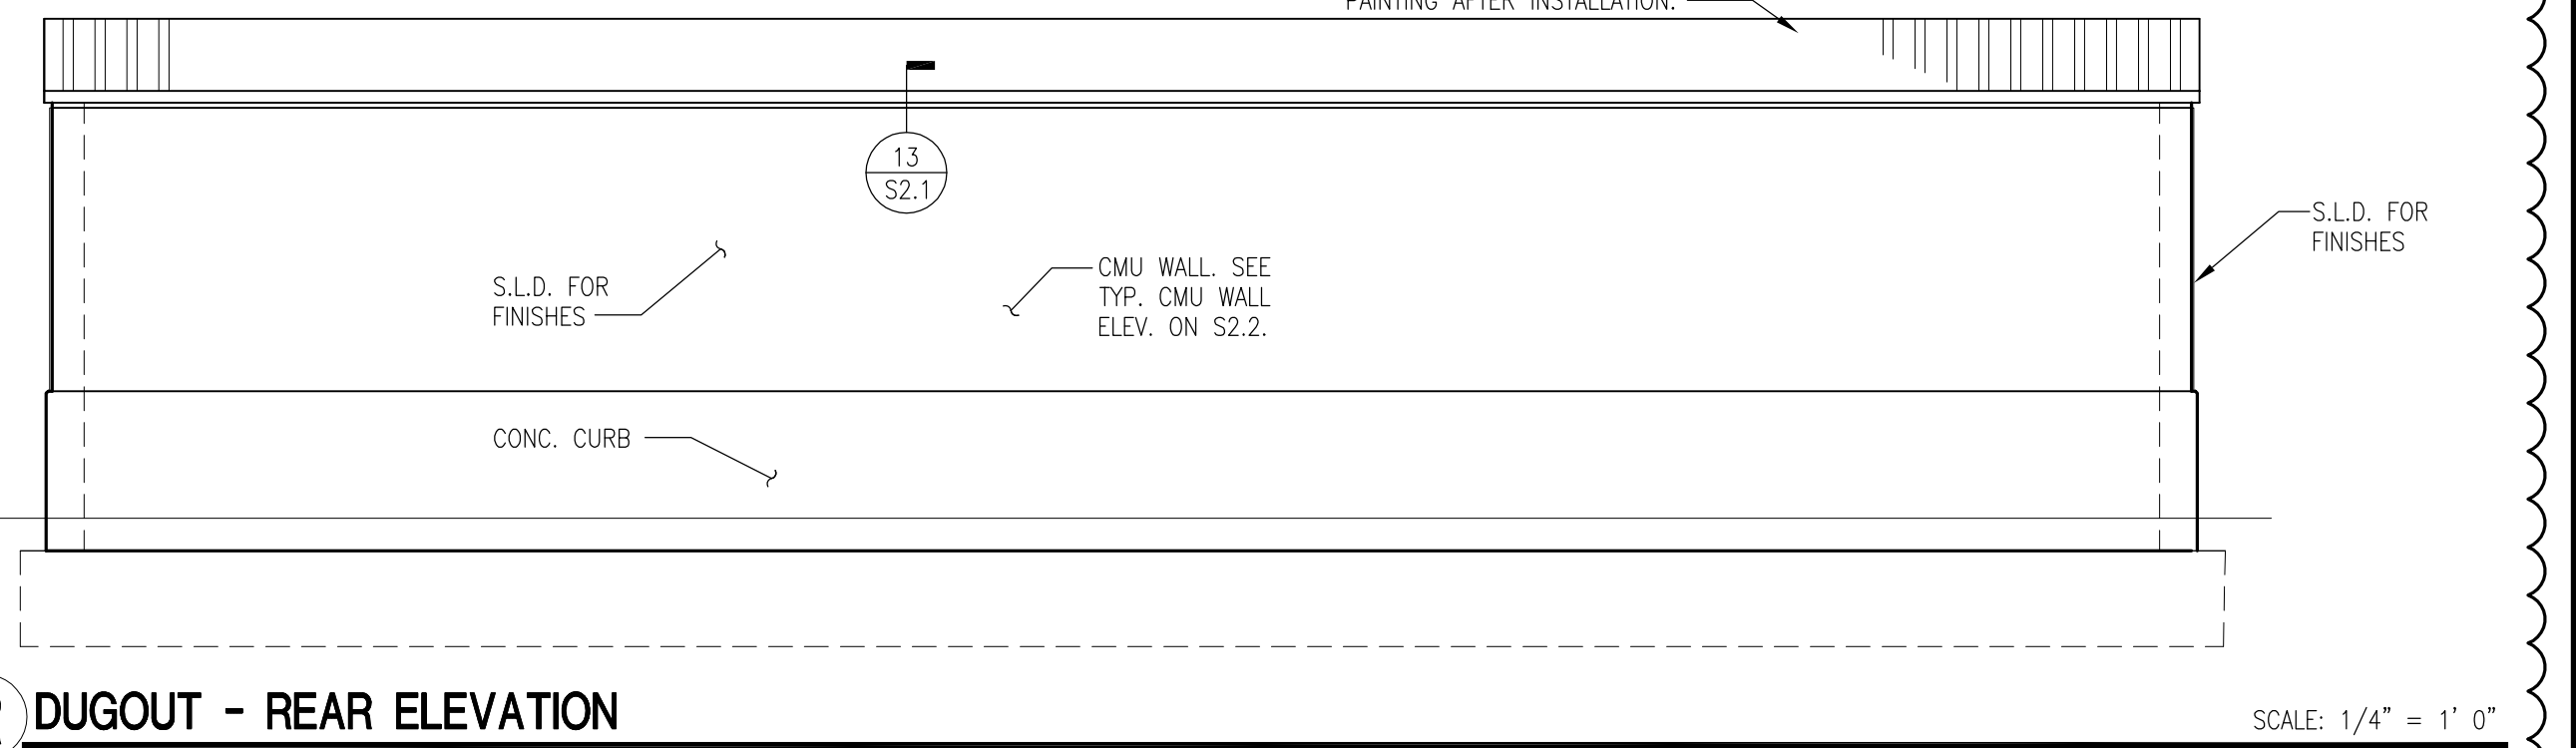
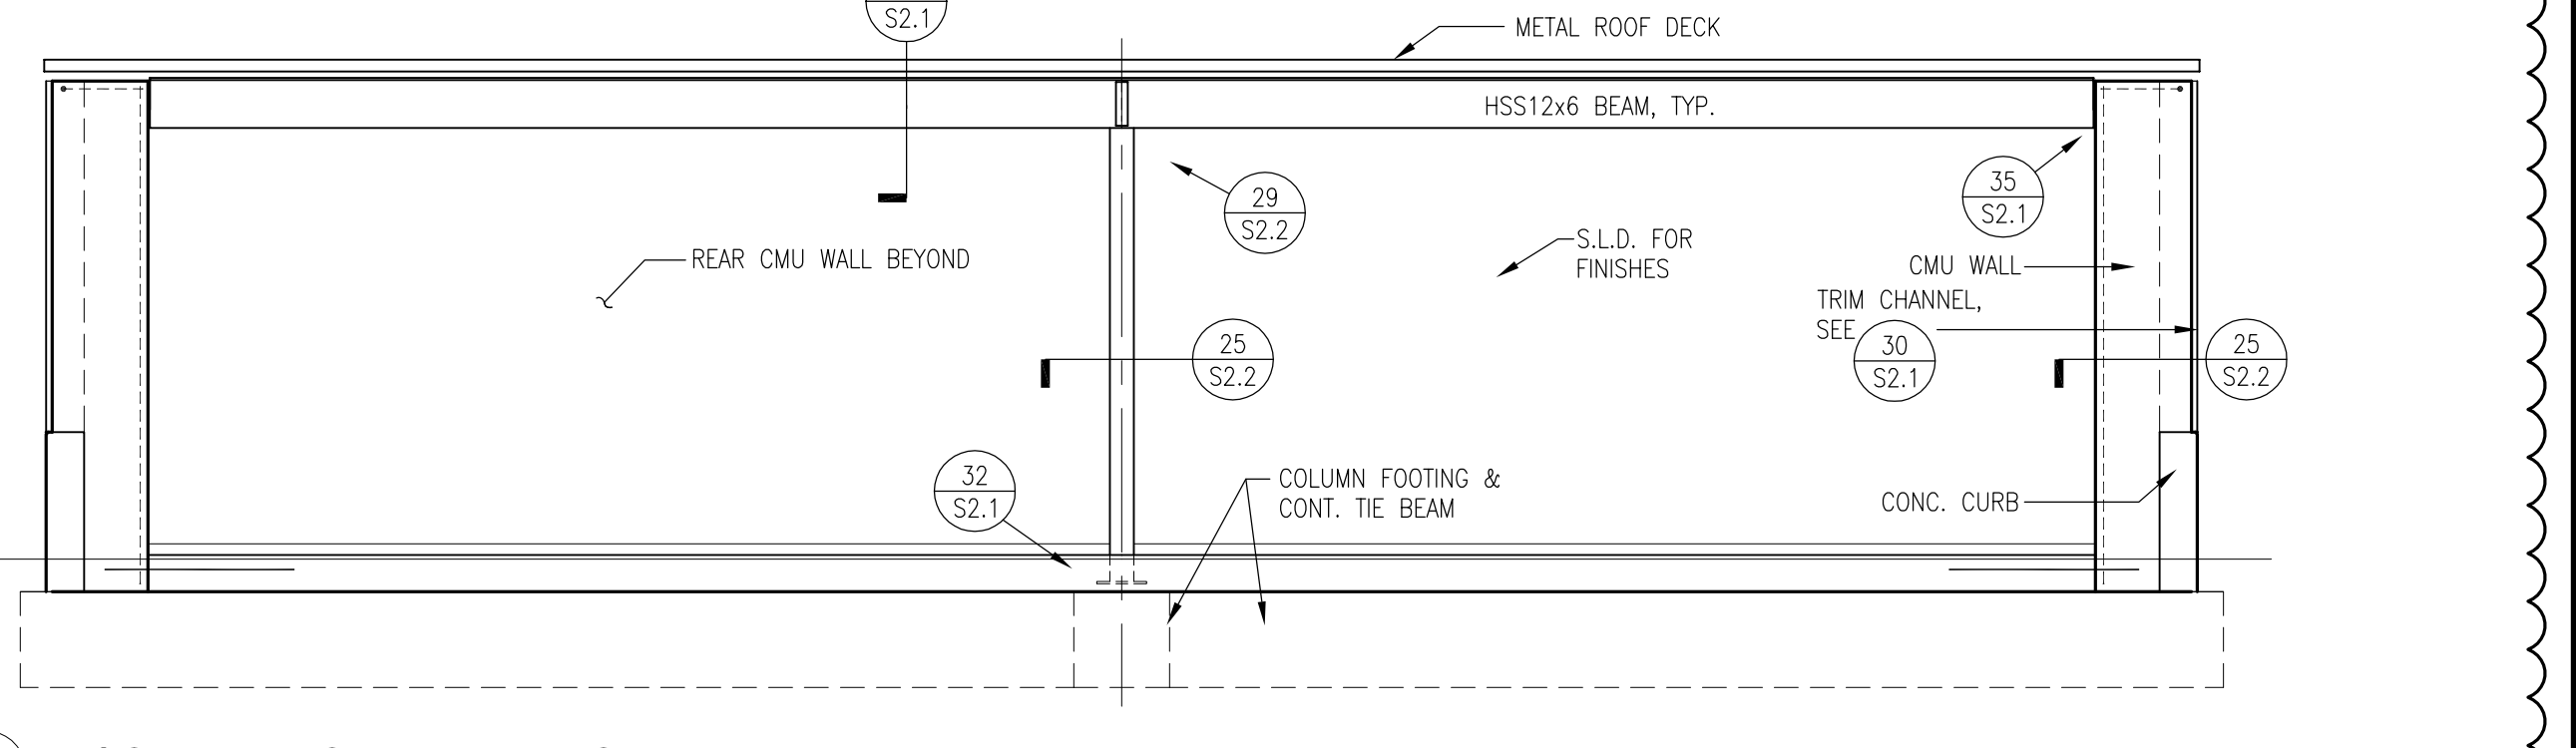
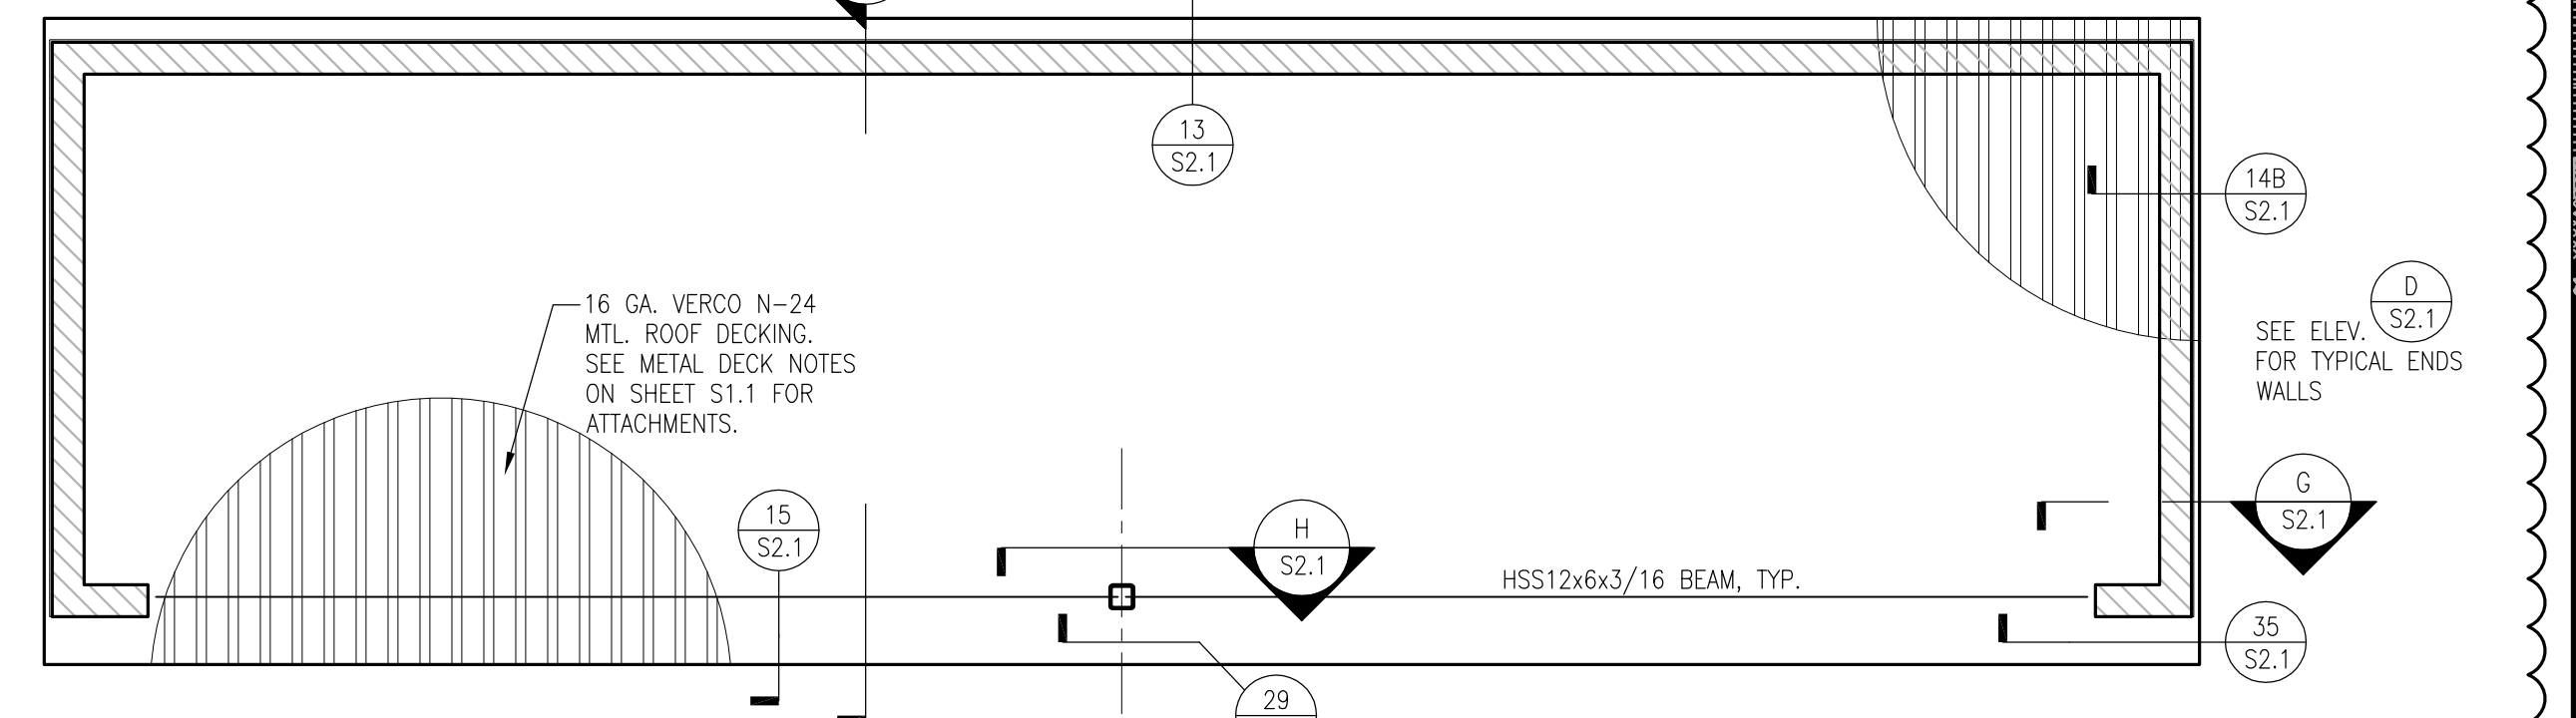
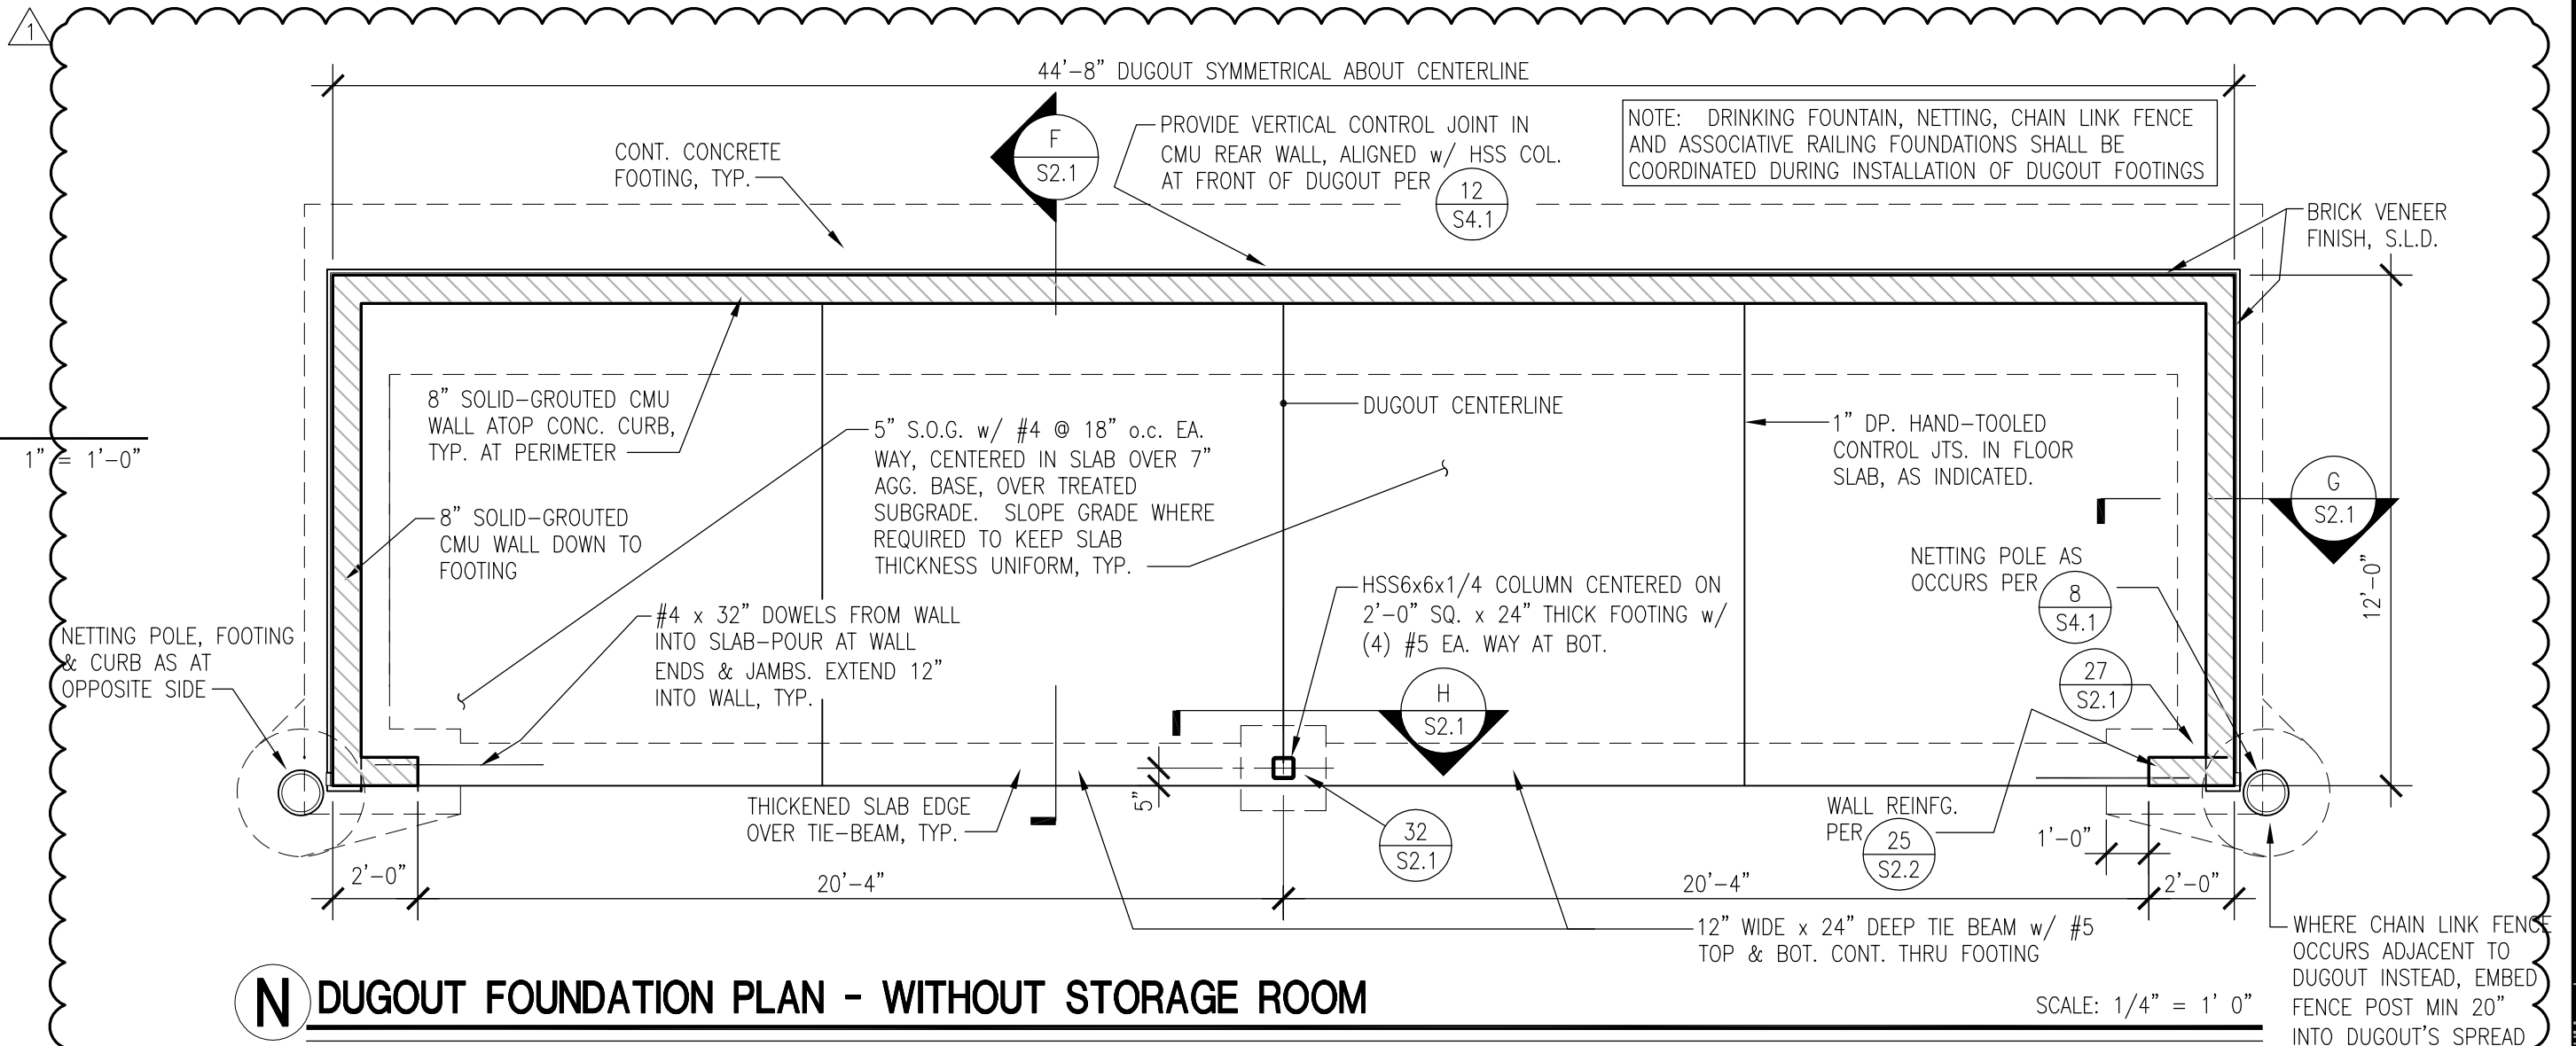
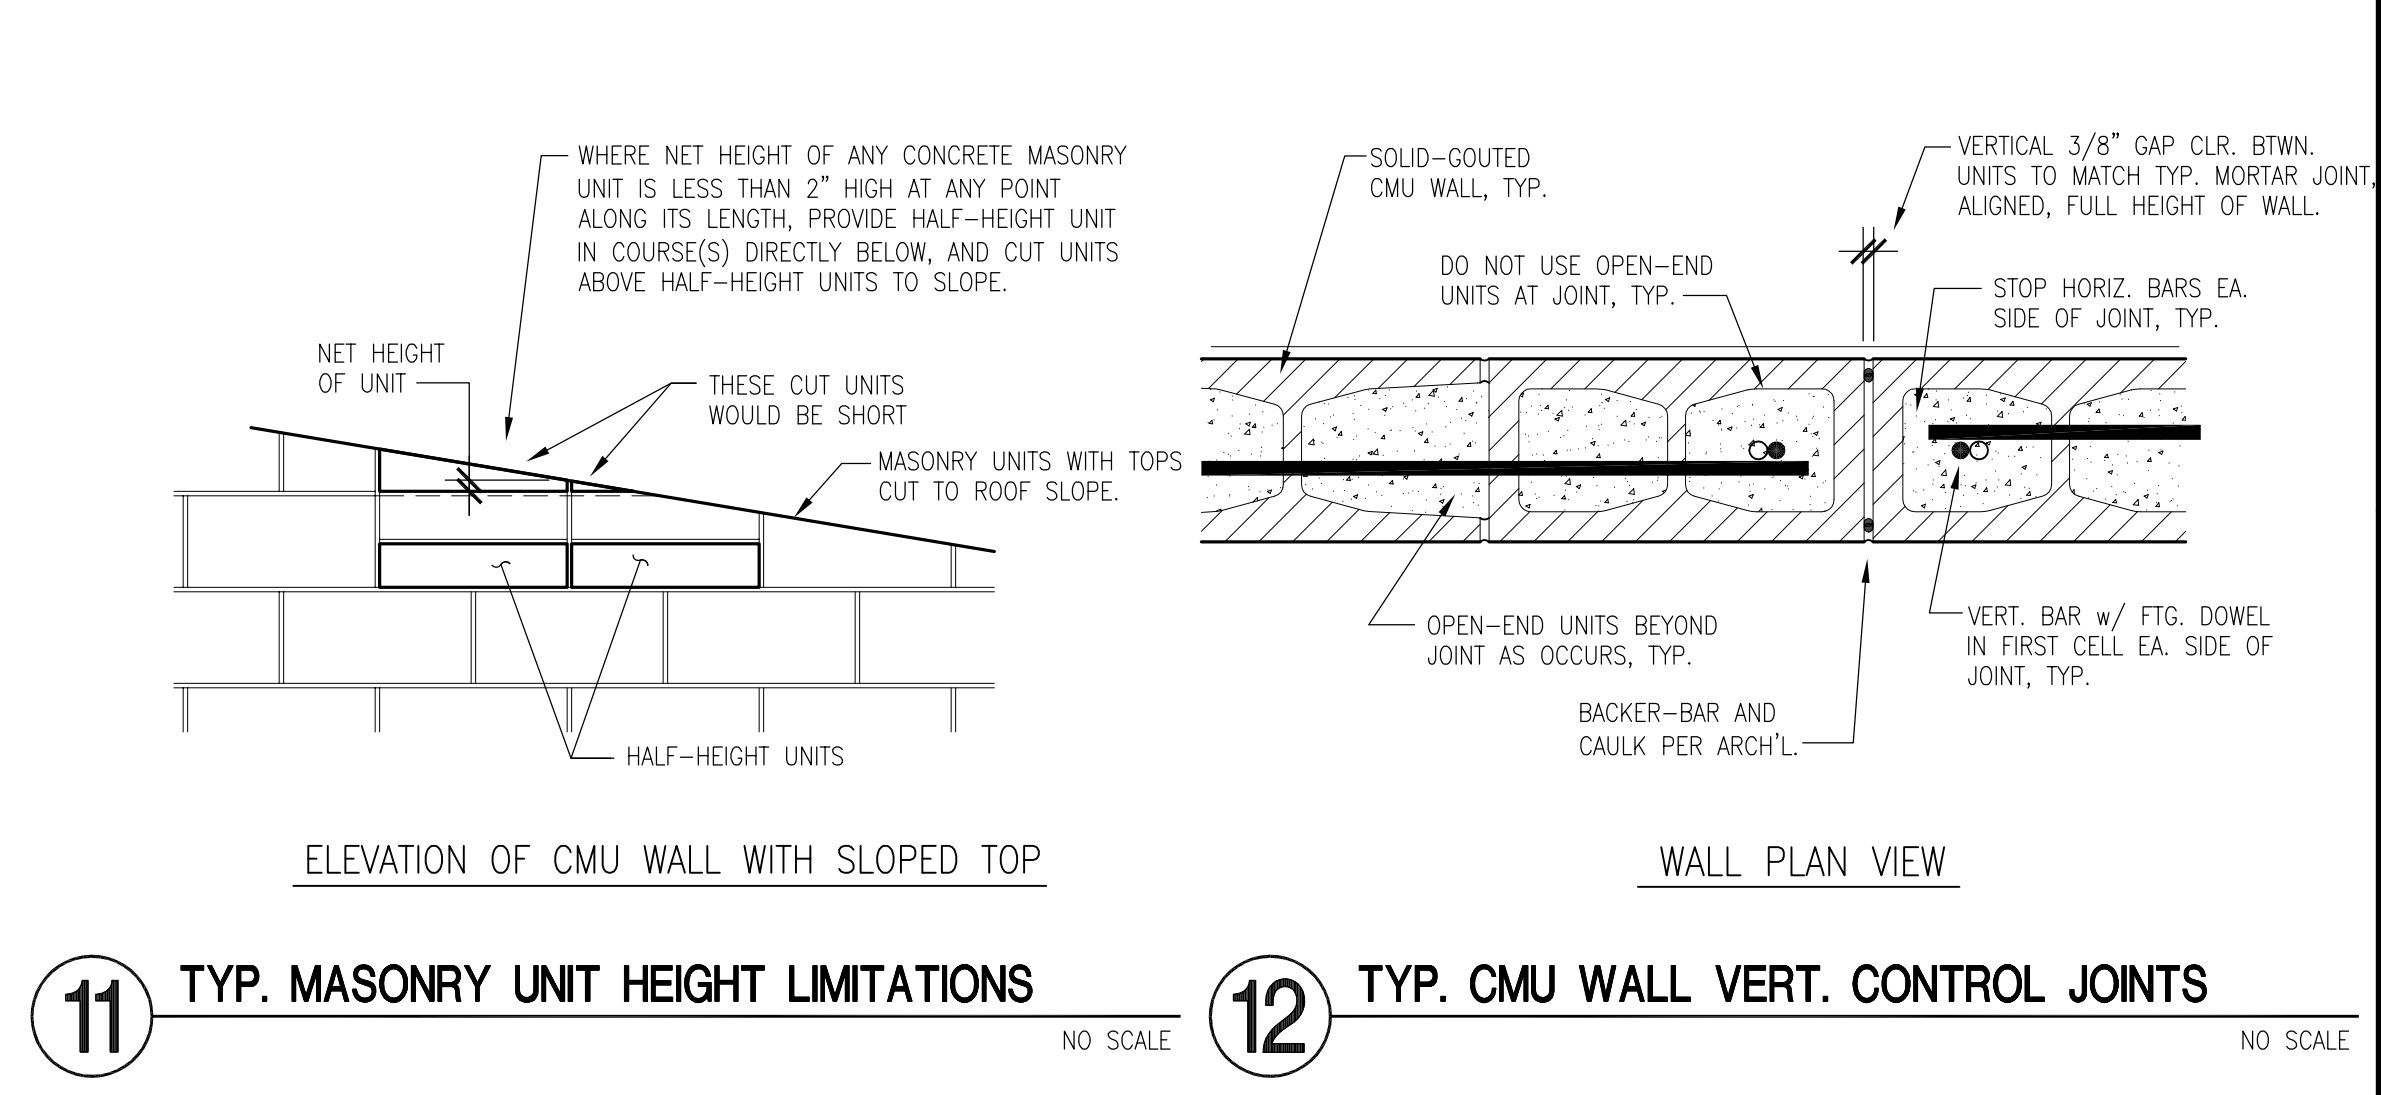
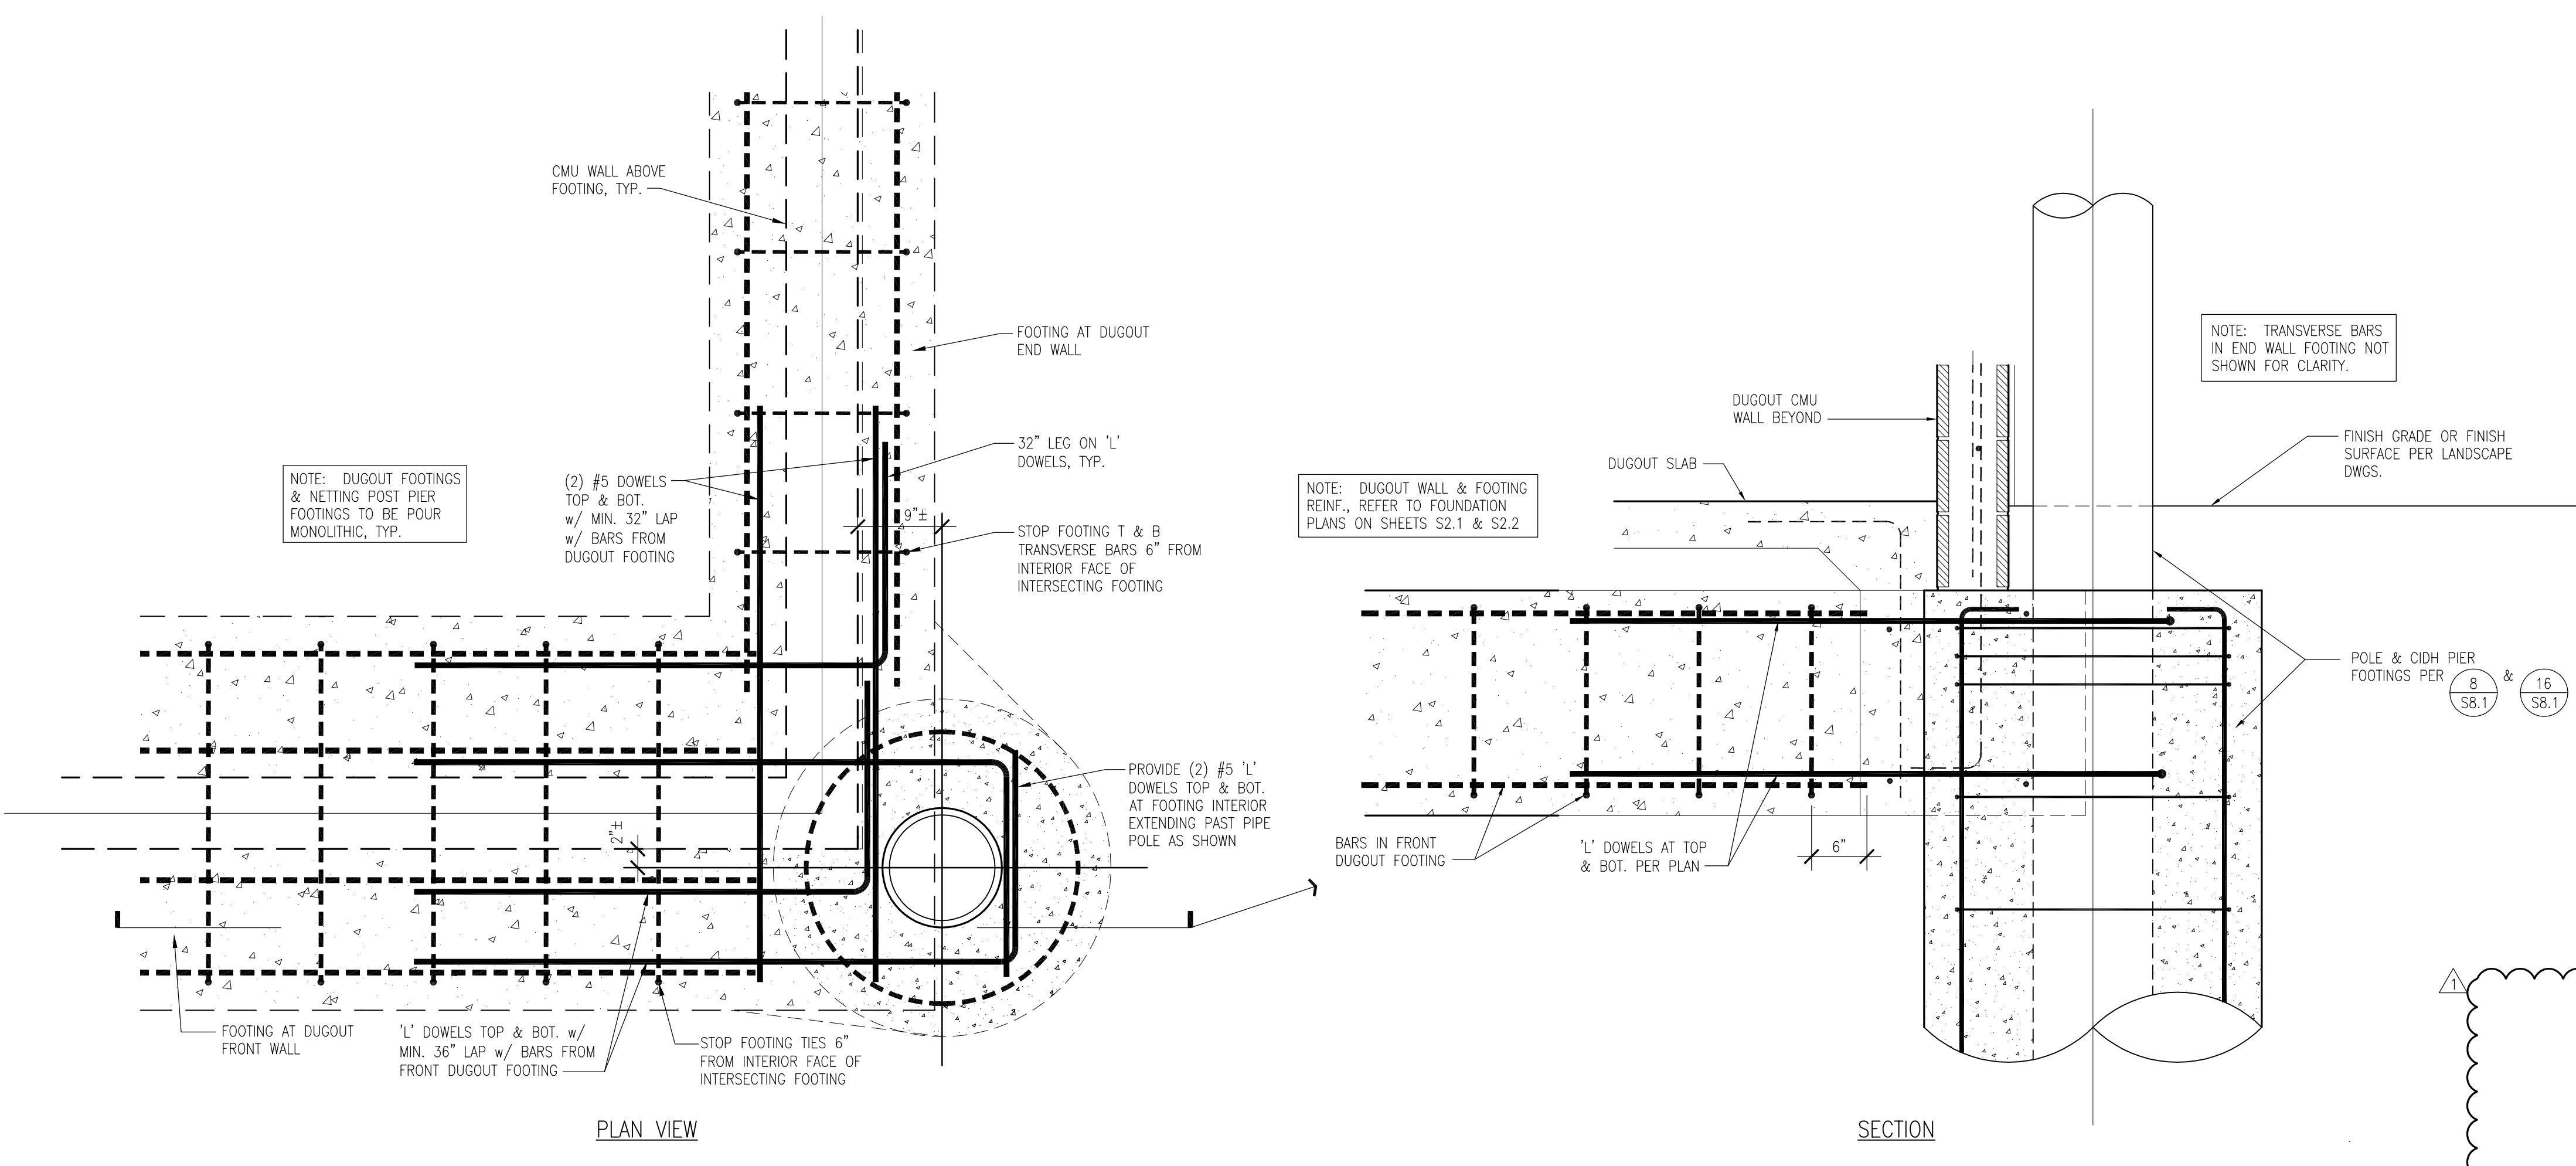
SUBMITTAL	DATE
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DRAWN BY: JJQ
 CHECKED BY: TDH
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 SCALE: AS NOTED
 PROJ. NO.: 2203200

SHEET NO.
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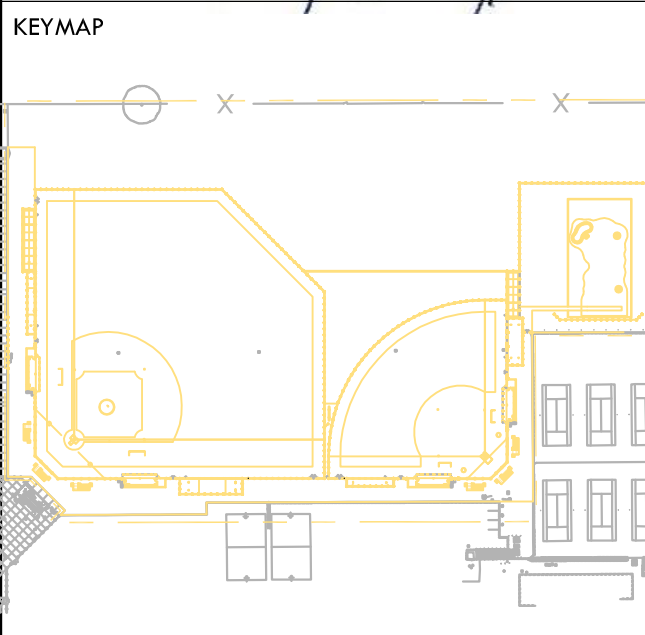
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 ph: 408.978.1970
 web: AKHSE.com

REGISTERED PROFESSIONAL ENGINEER
 No. 52960
 Exp. 3/31/23
 STATE OF CALIFORNIA

Chm O'Neil



DUGOUT w/o STORAGE PLANS, STRUCTURAL DETAILS

PROJECT NAME
HIRAM JOHNSON HIGH SCHOOL GOLF PRACTICE FACILITY, VARSITY BASEBALL AND SOFTBALL FIELDS













PROJECT ADDRESS
6879 14TH AVENUE SACRAMENTO, CA 95820

SUBMITTAL	DATE
DD 50% SUBMITTAL	04/15/22
100% DSA SUBMITTAL	05/27/22
DSA BACK CHECK	08/11/22
DSA ADDENDUM SUBMITTAL	09/16/22

NO.	REVISIONS	DATE
▲	ADDENDUM	09/16/22

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 DATE ISSUED: **09/16/2022** SCALE: **AS NOTED**

PROJ. NO. **2203200**
 SHEET NO. **S4.1**

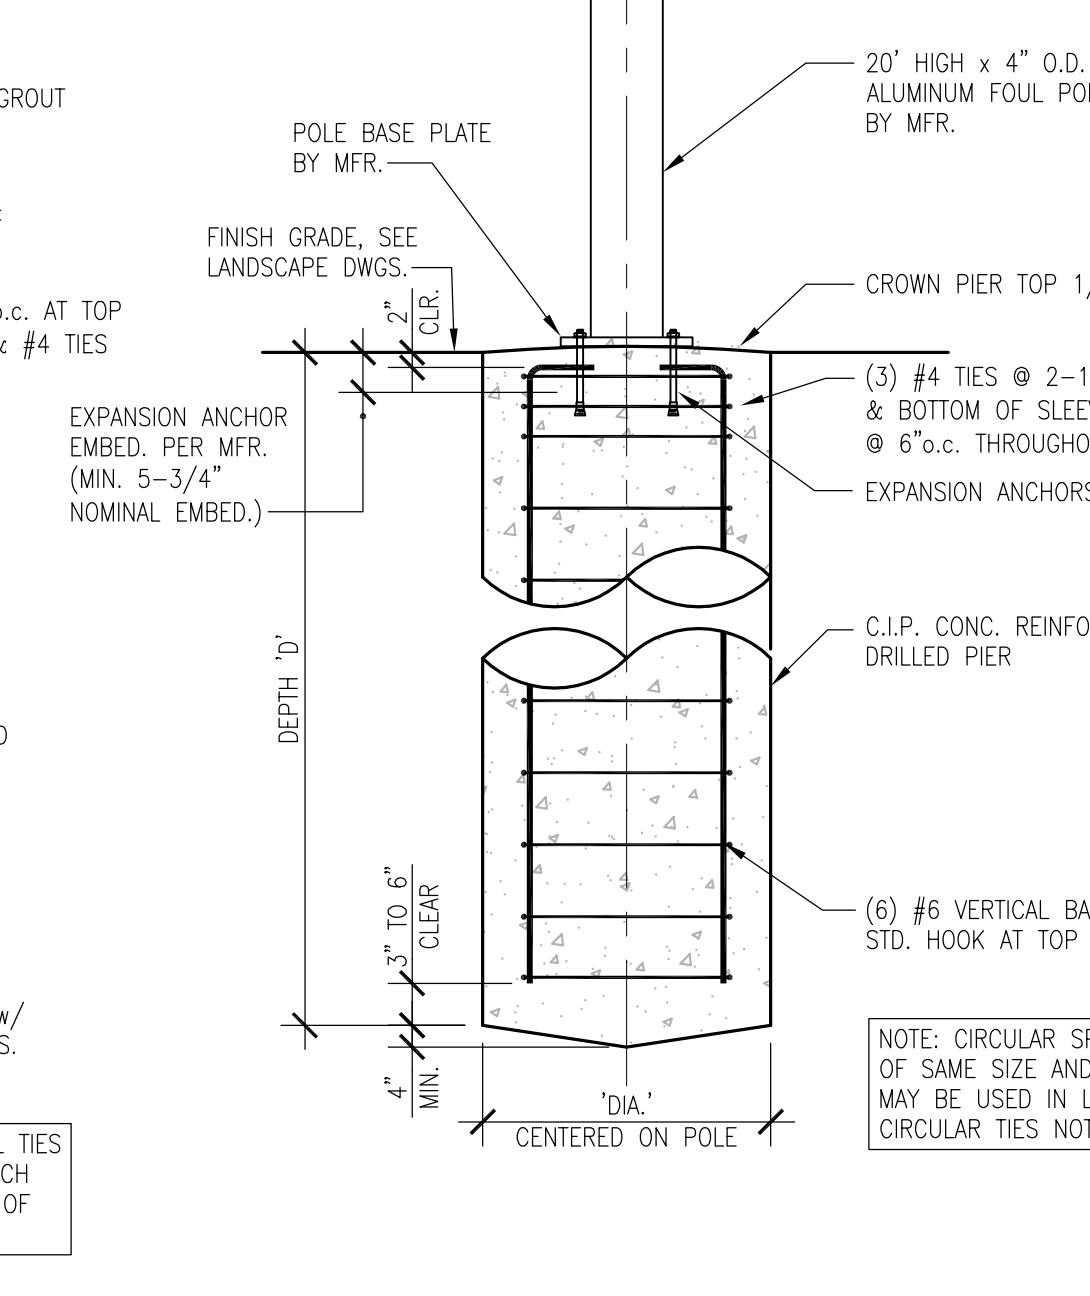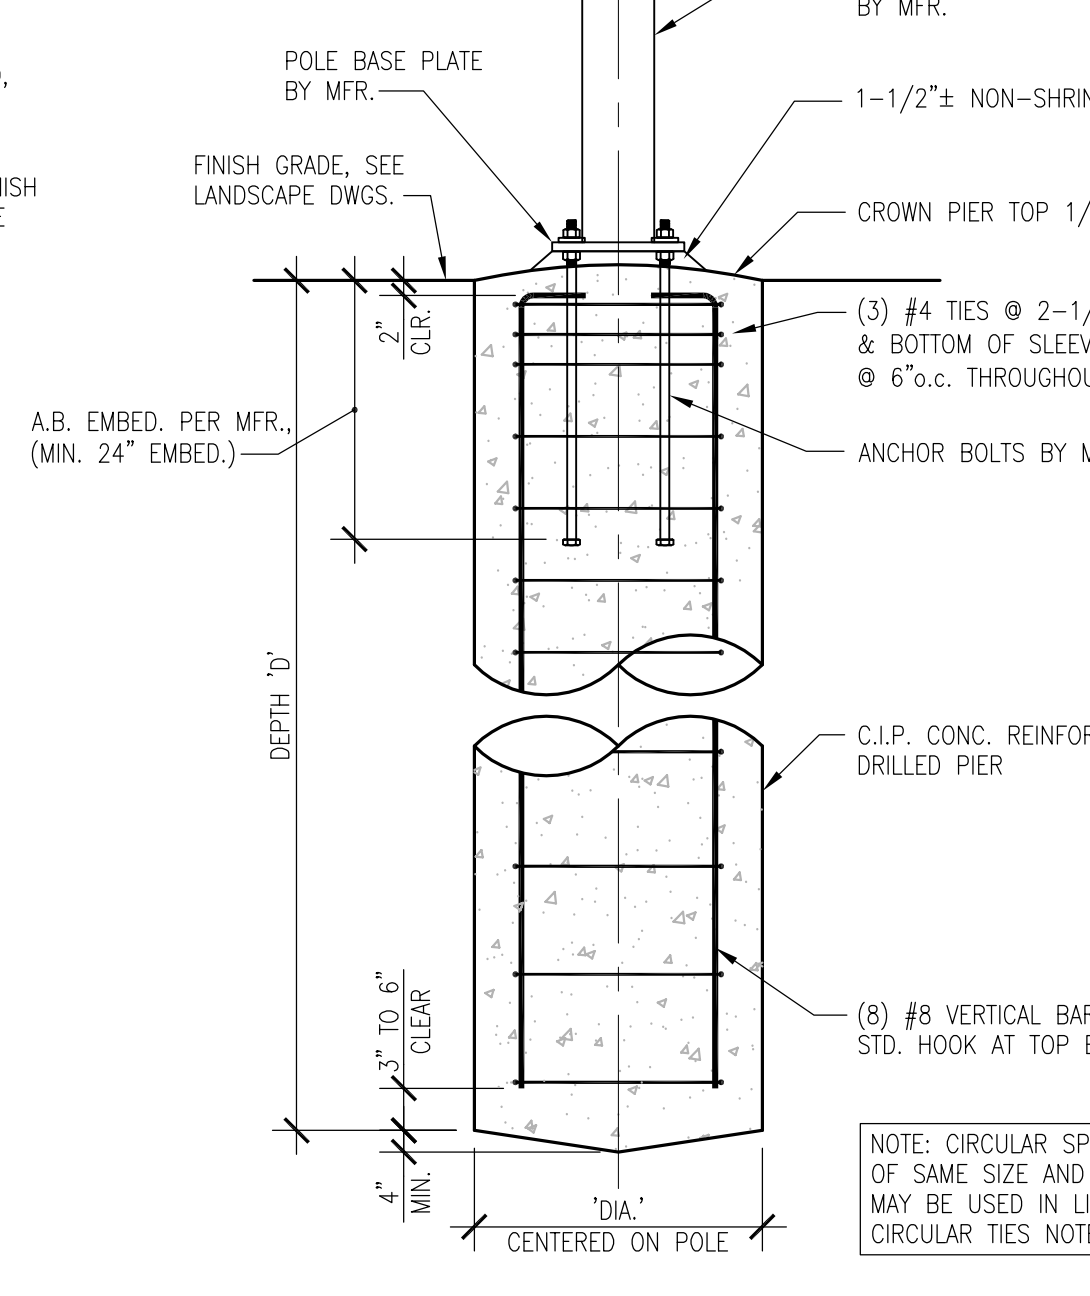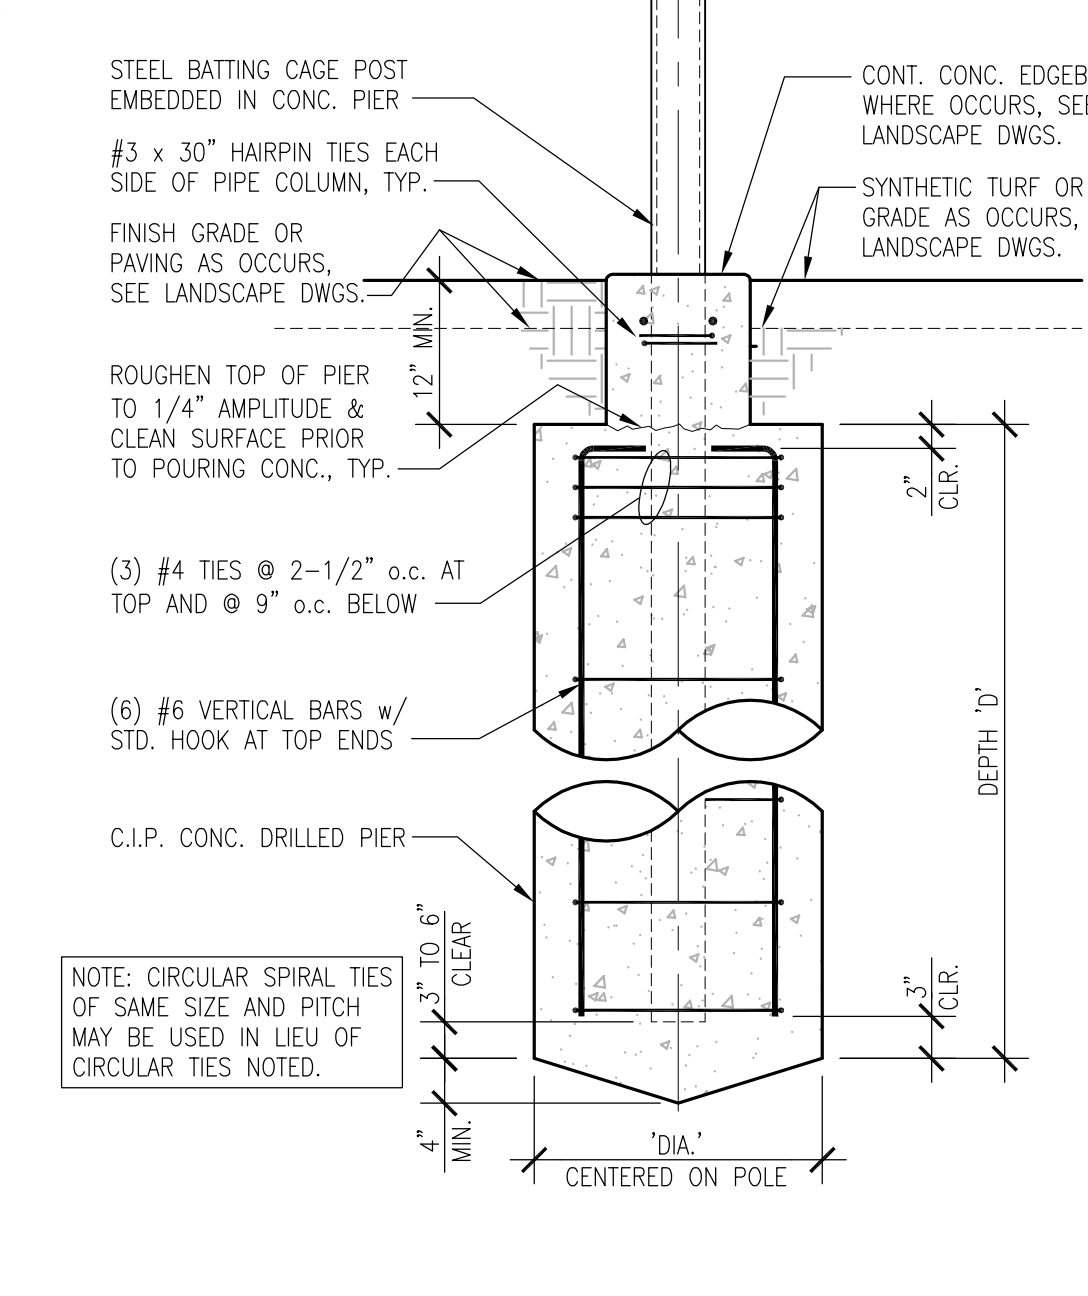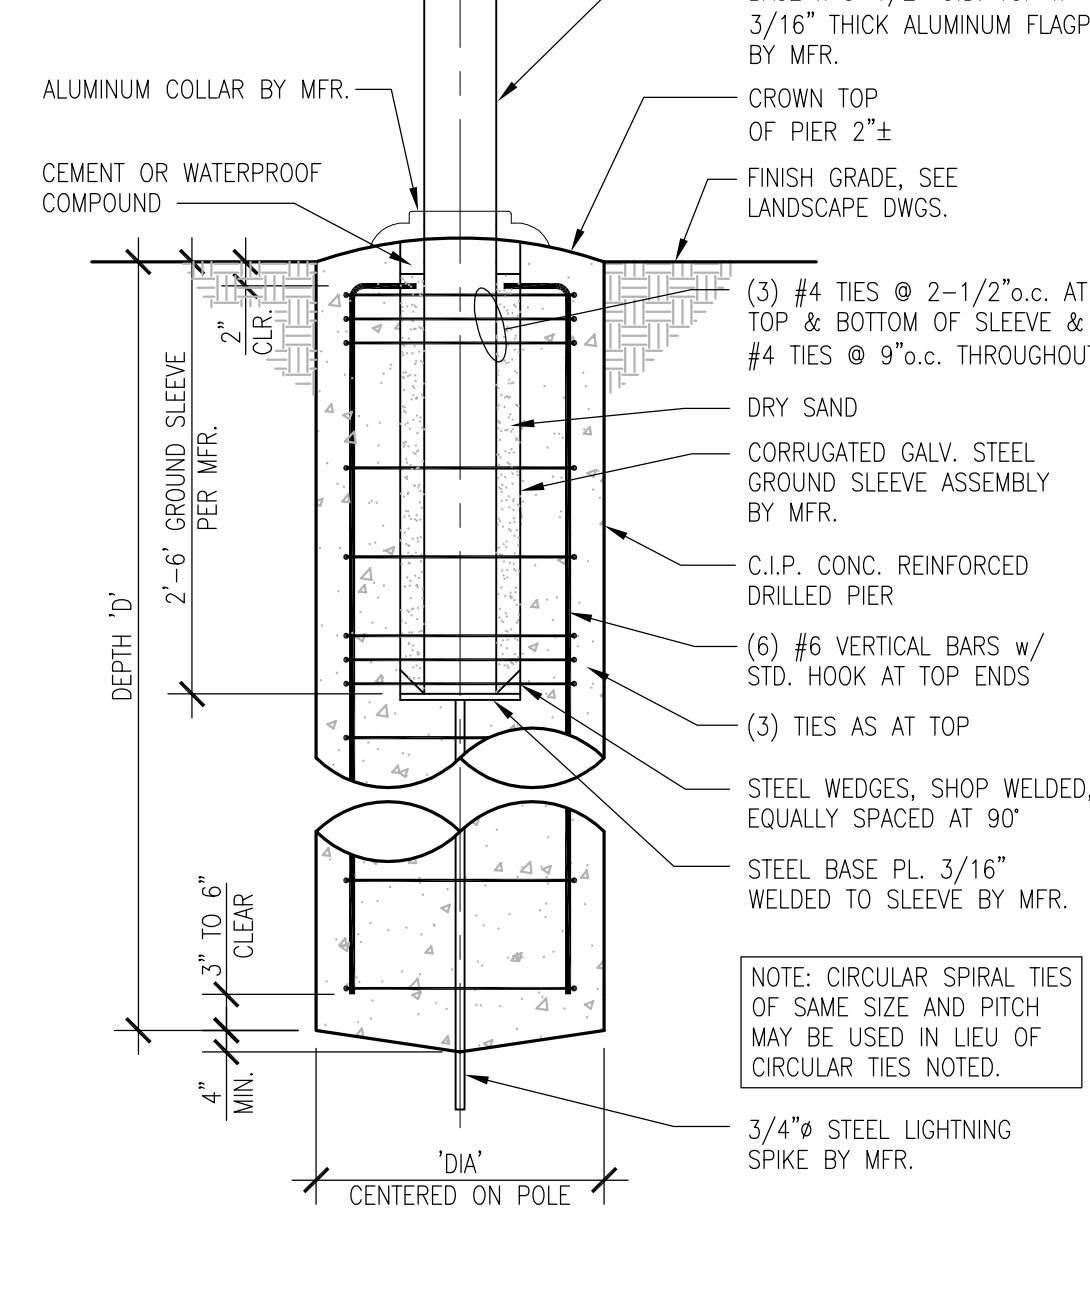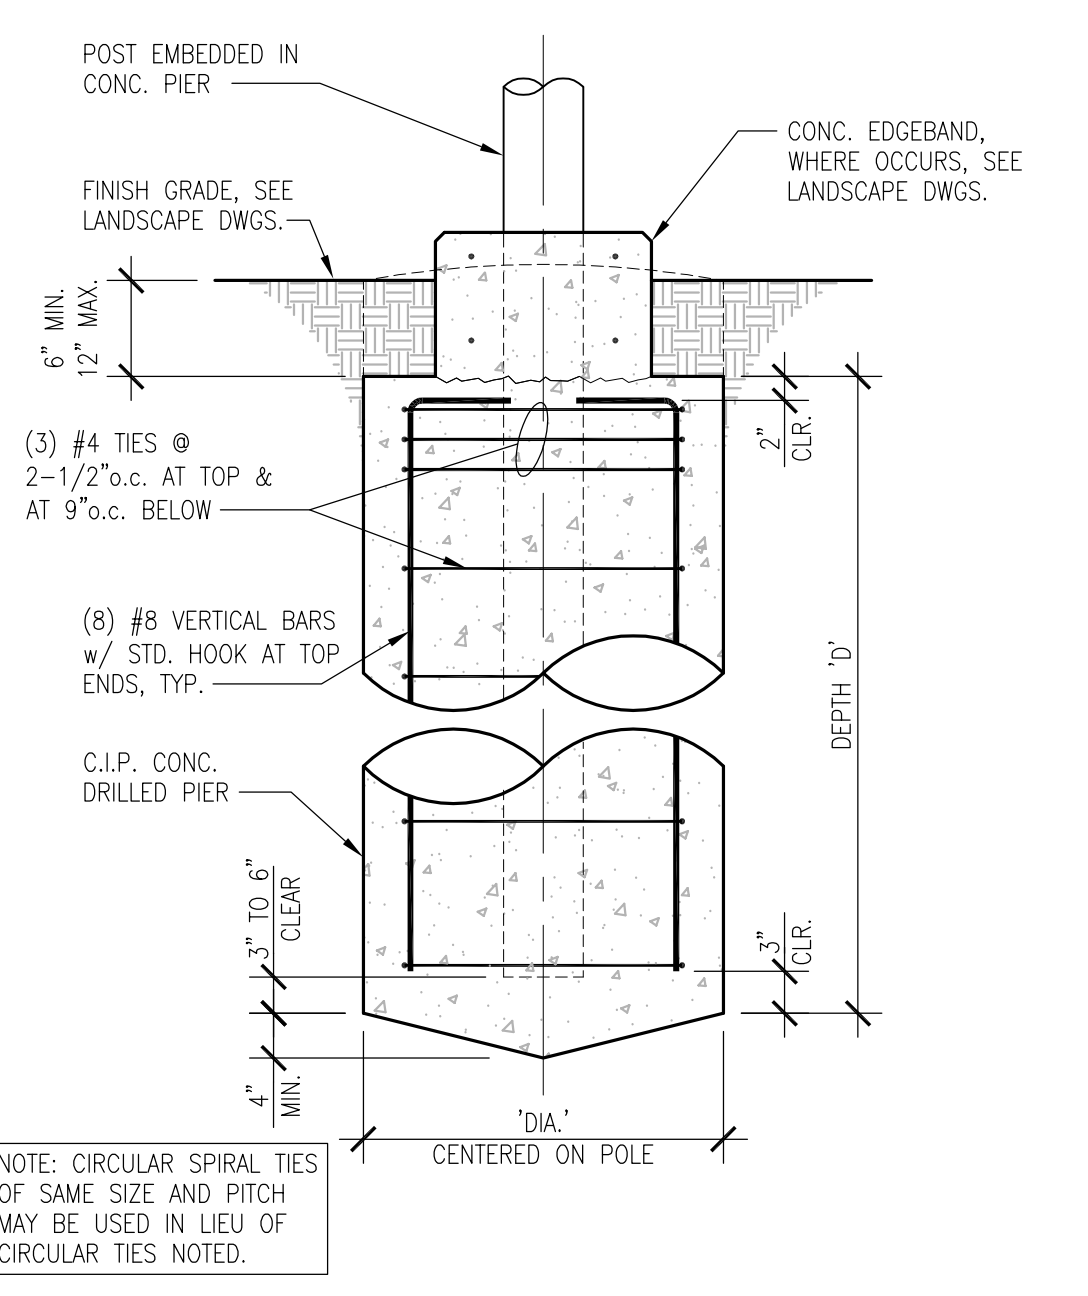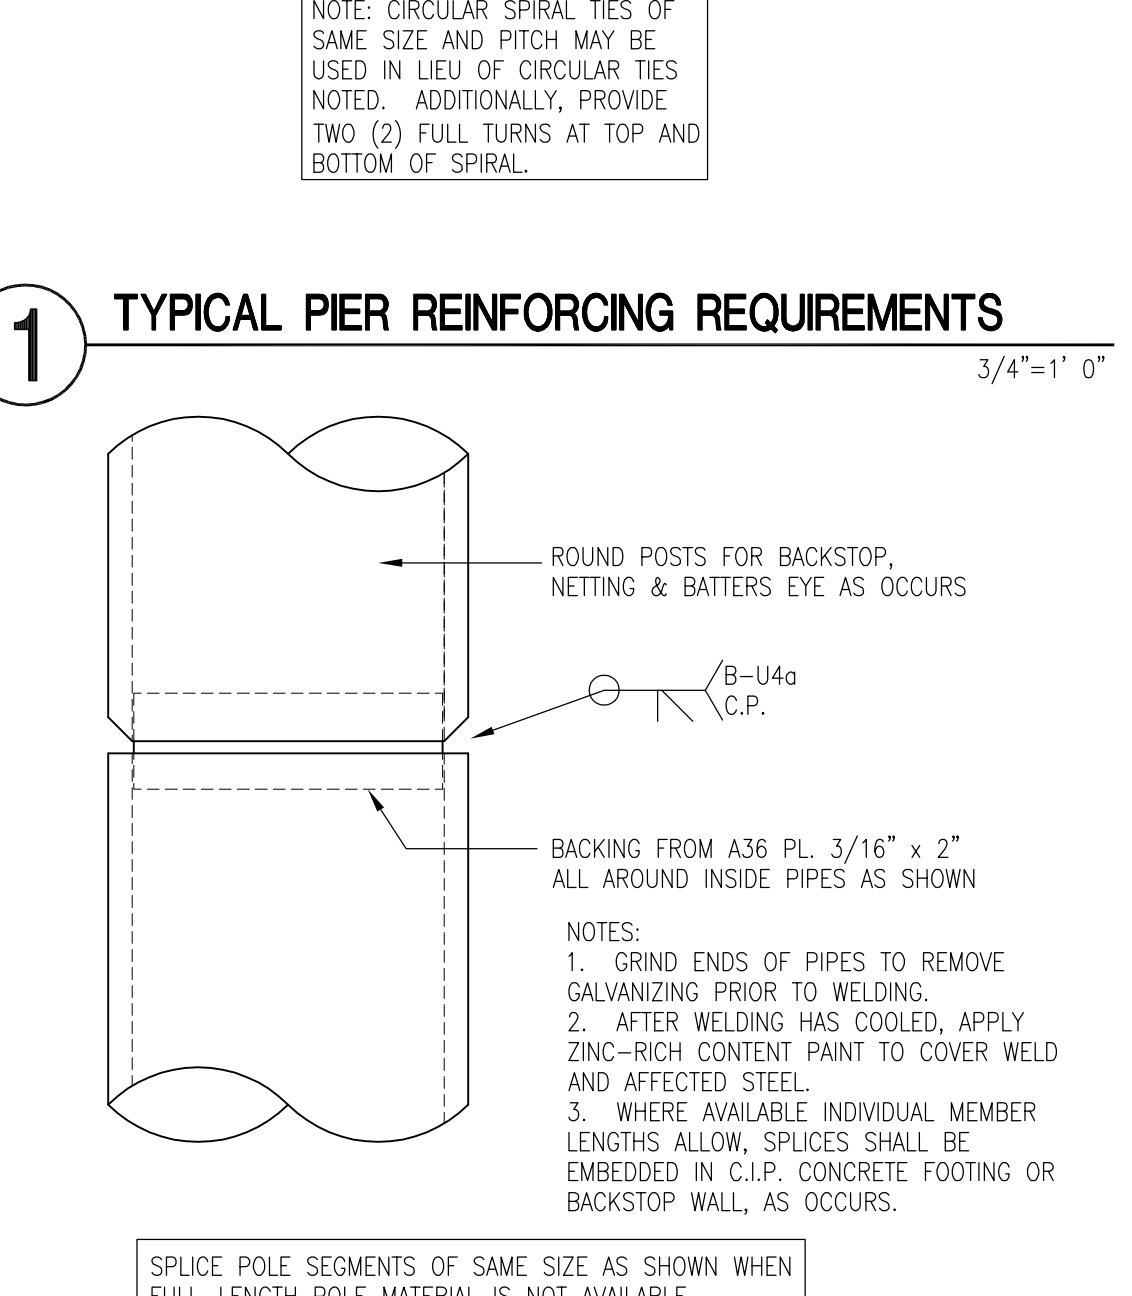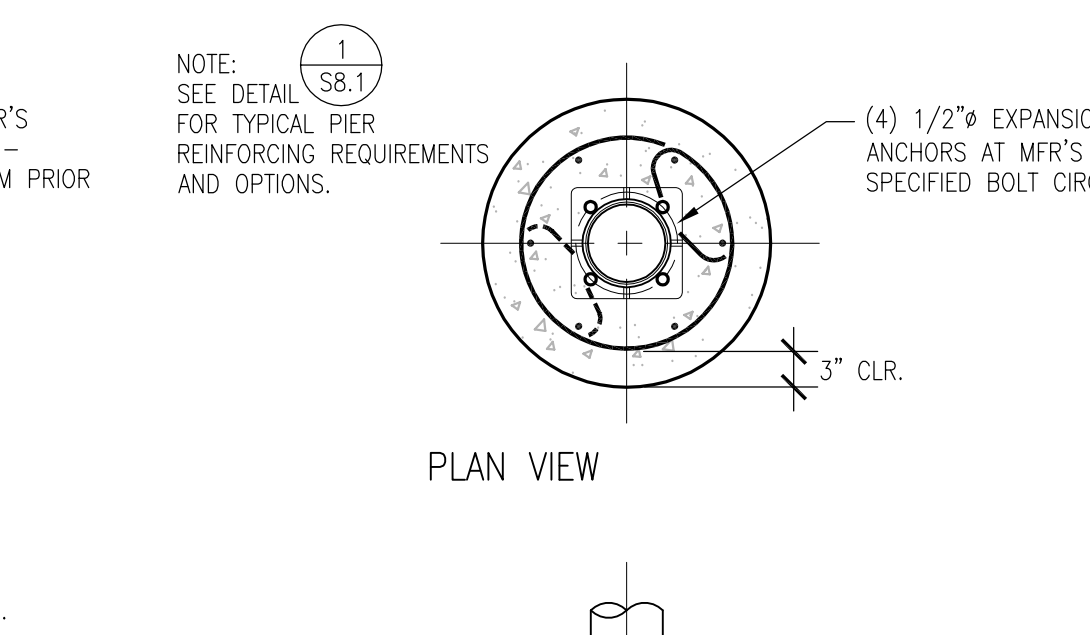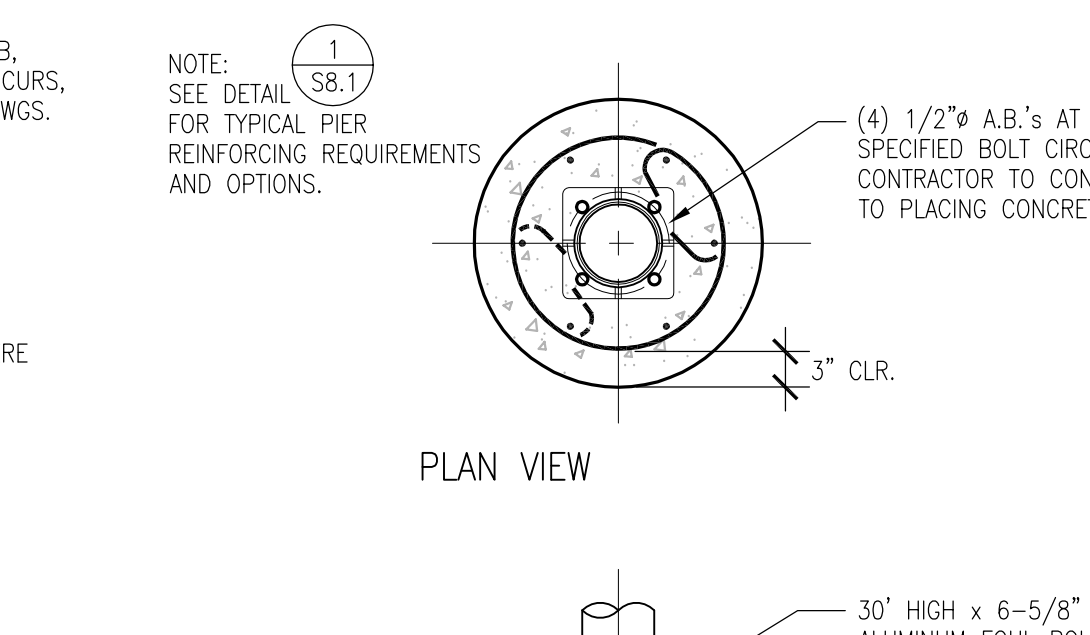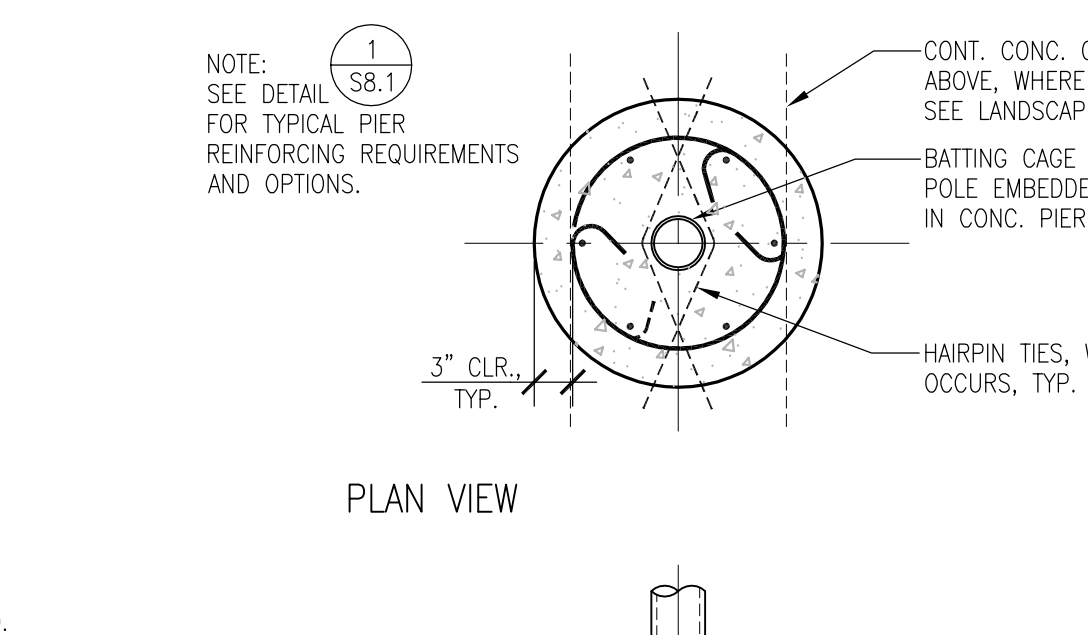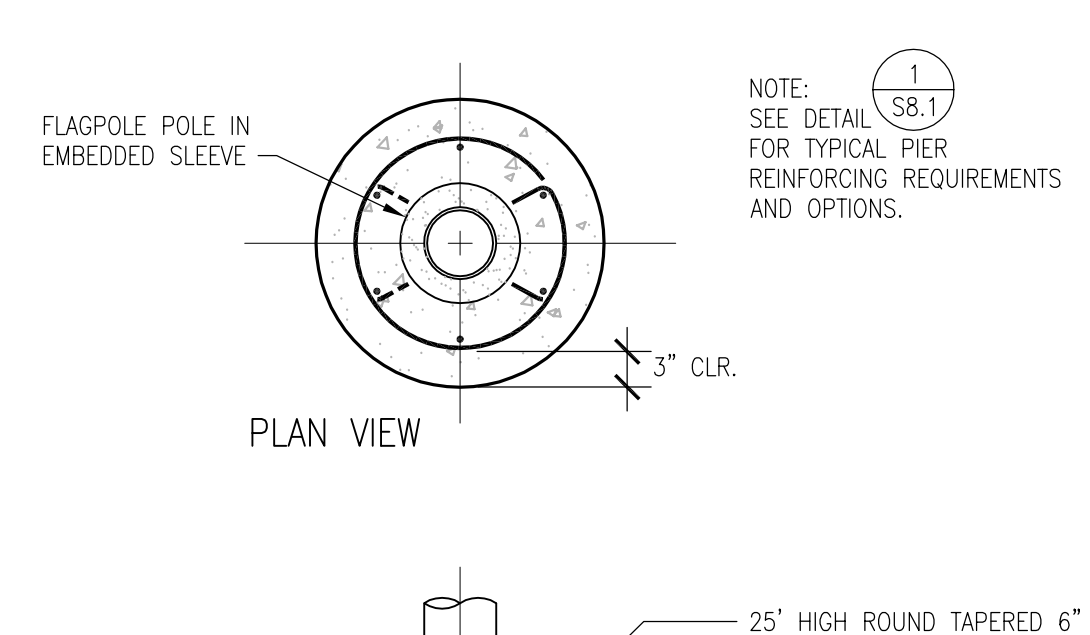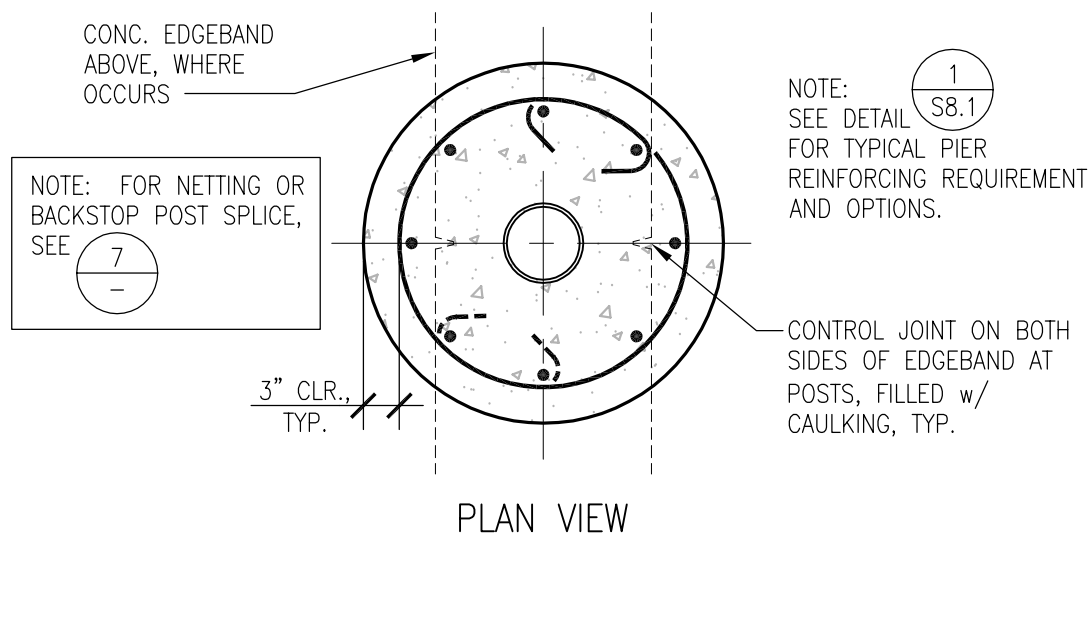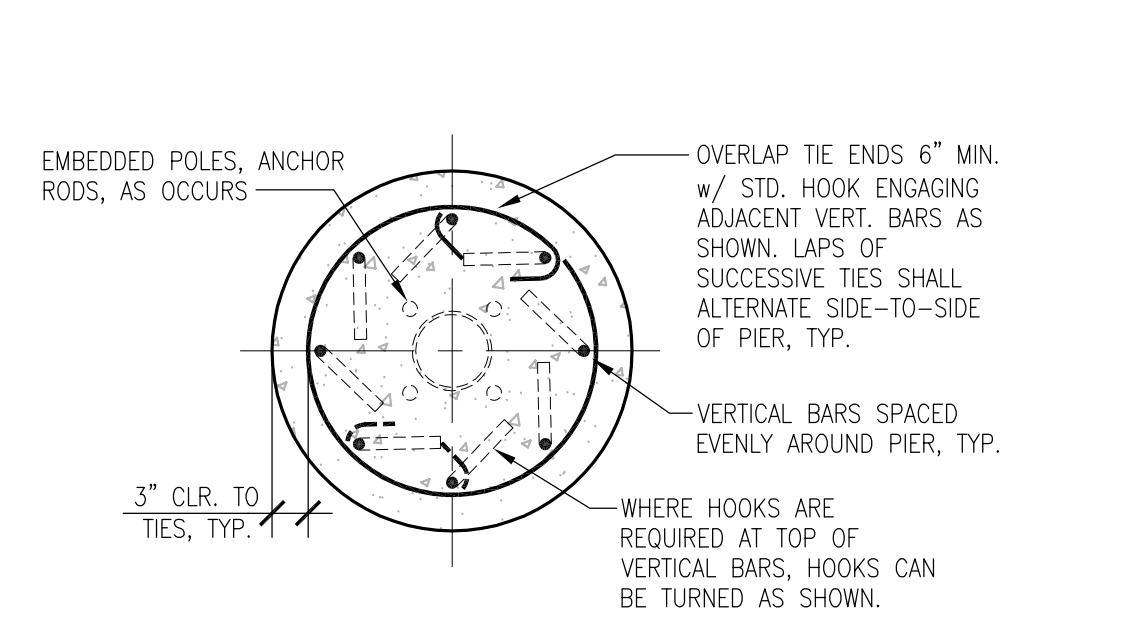

1 TYPICAL PIER REINFORCING REQUIREMENTS 3/4"=1' 0"

7 TYPICAL POLE/POST SPLICE NO SCALE















8 BACKSTOP & NETTING FOOTING 3/4"=1' 0"

9 FLAG POLE FOOTING 3/4"=1' 0"

10 BATING CAGE FOOTING SIM. AT GOLF DRIVING RANGE 3/4"=1' 0"

11 FOUL POLE FOOTING BASEBALL FIELD 3/4"=1' 0"

12 FOUL POLE FOOTING SOFTBALL FIELD 3/4"=1' 0"

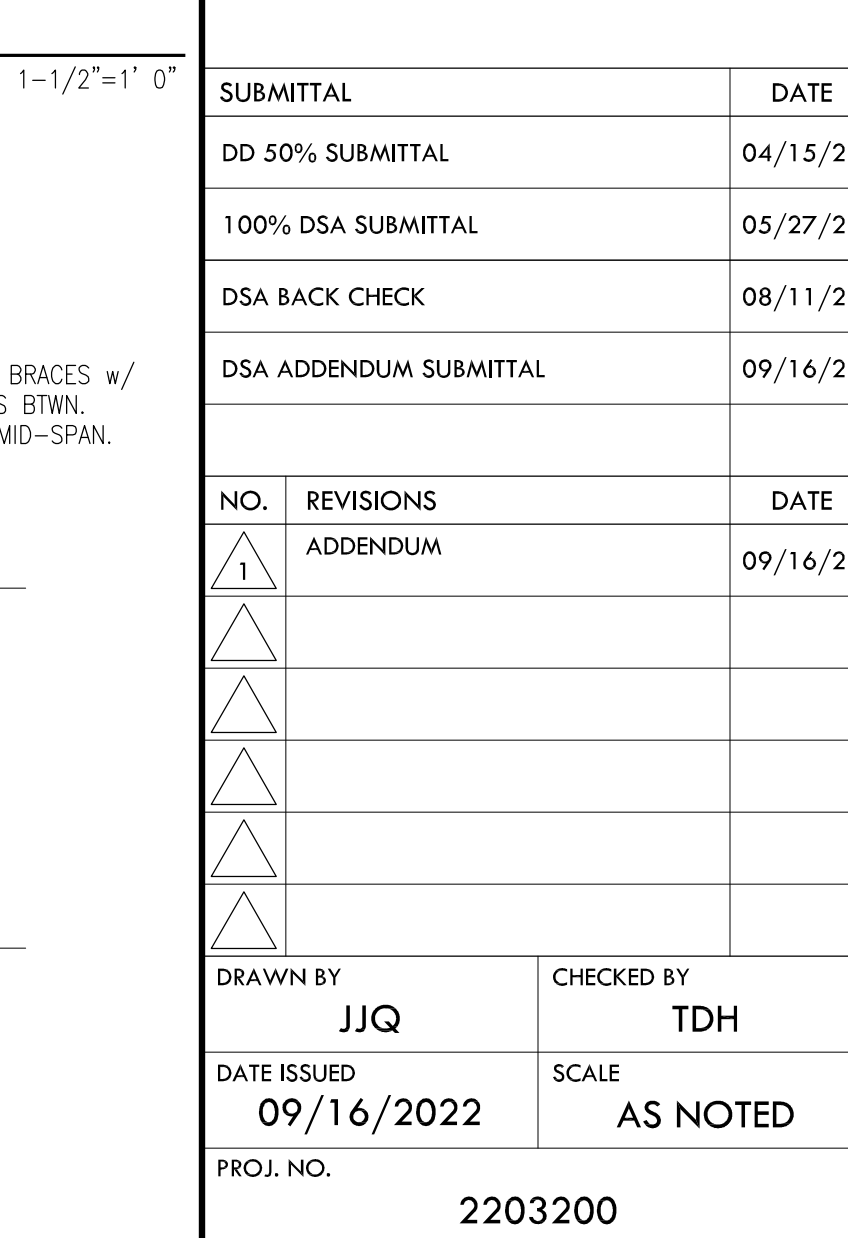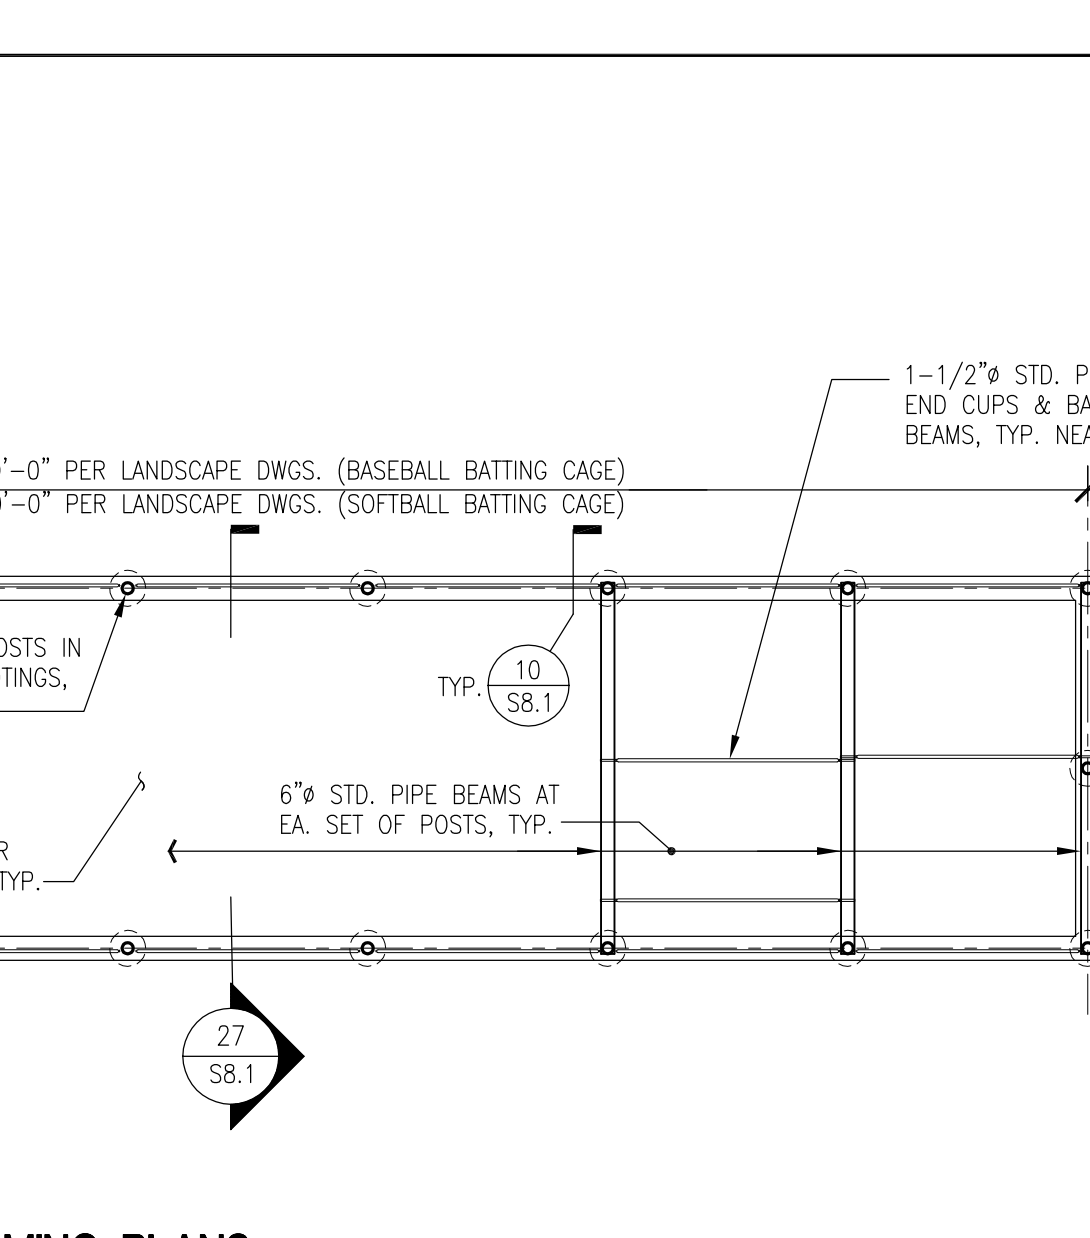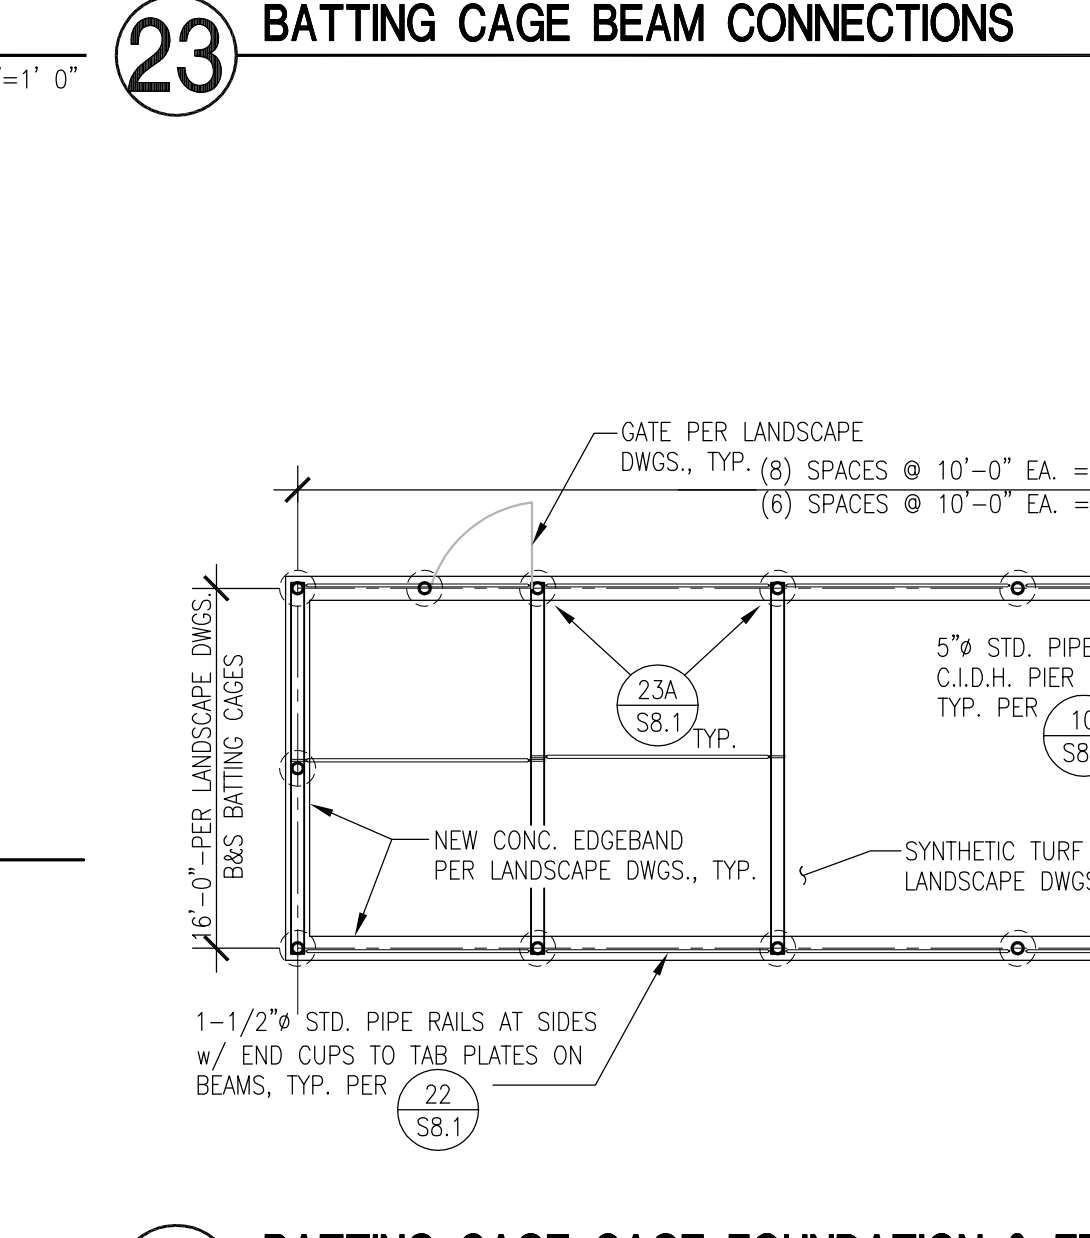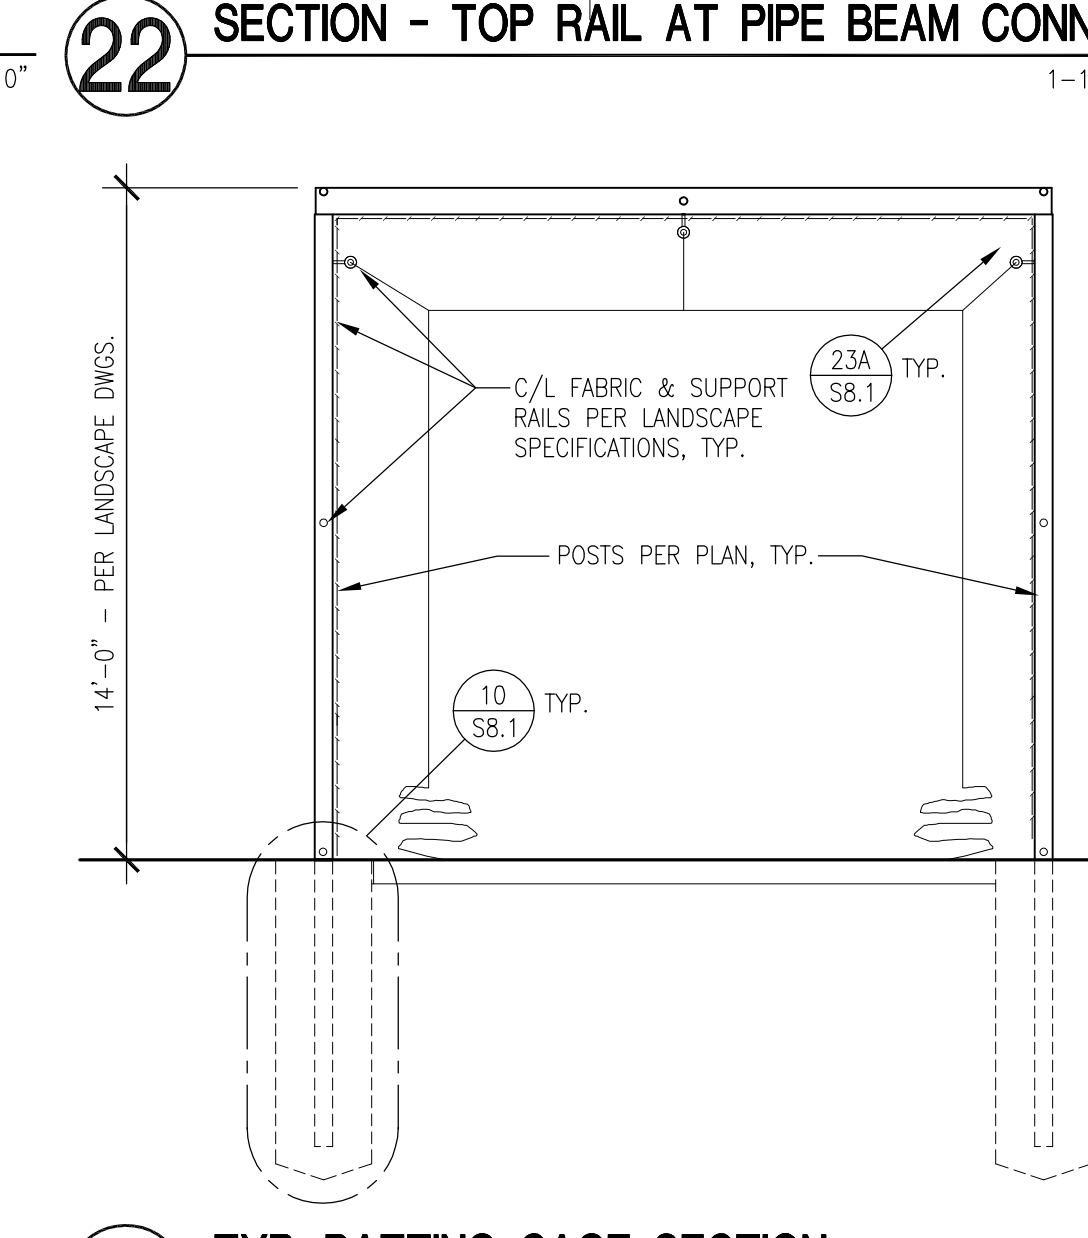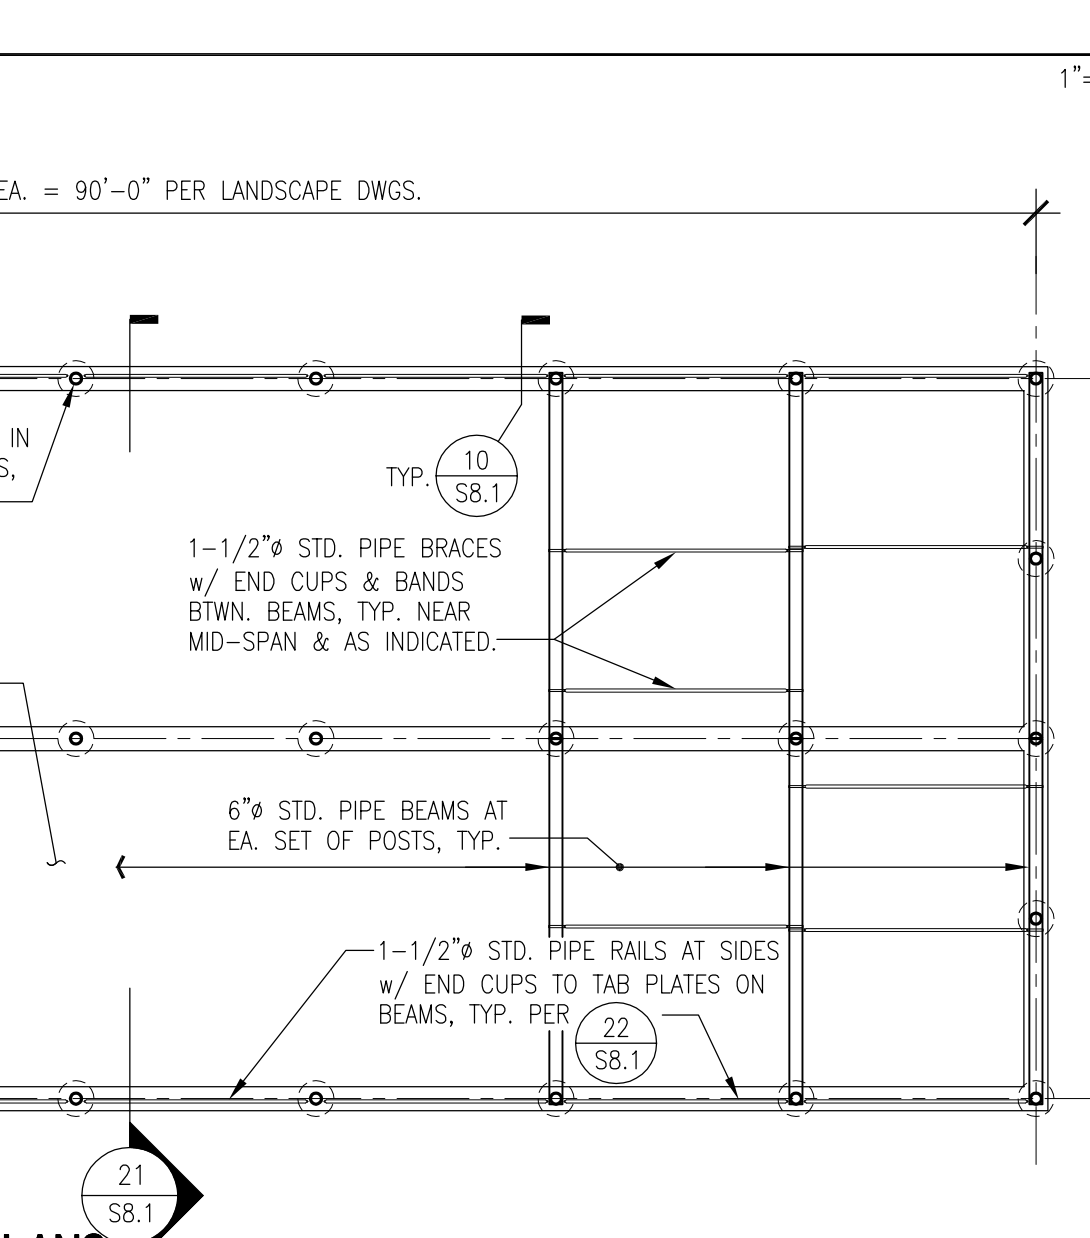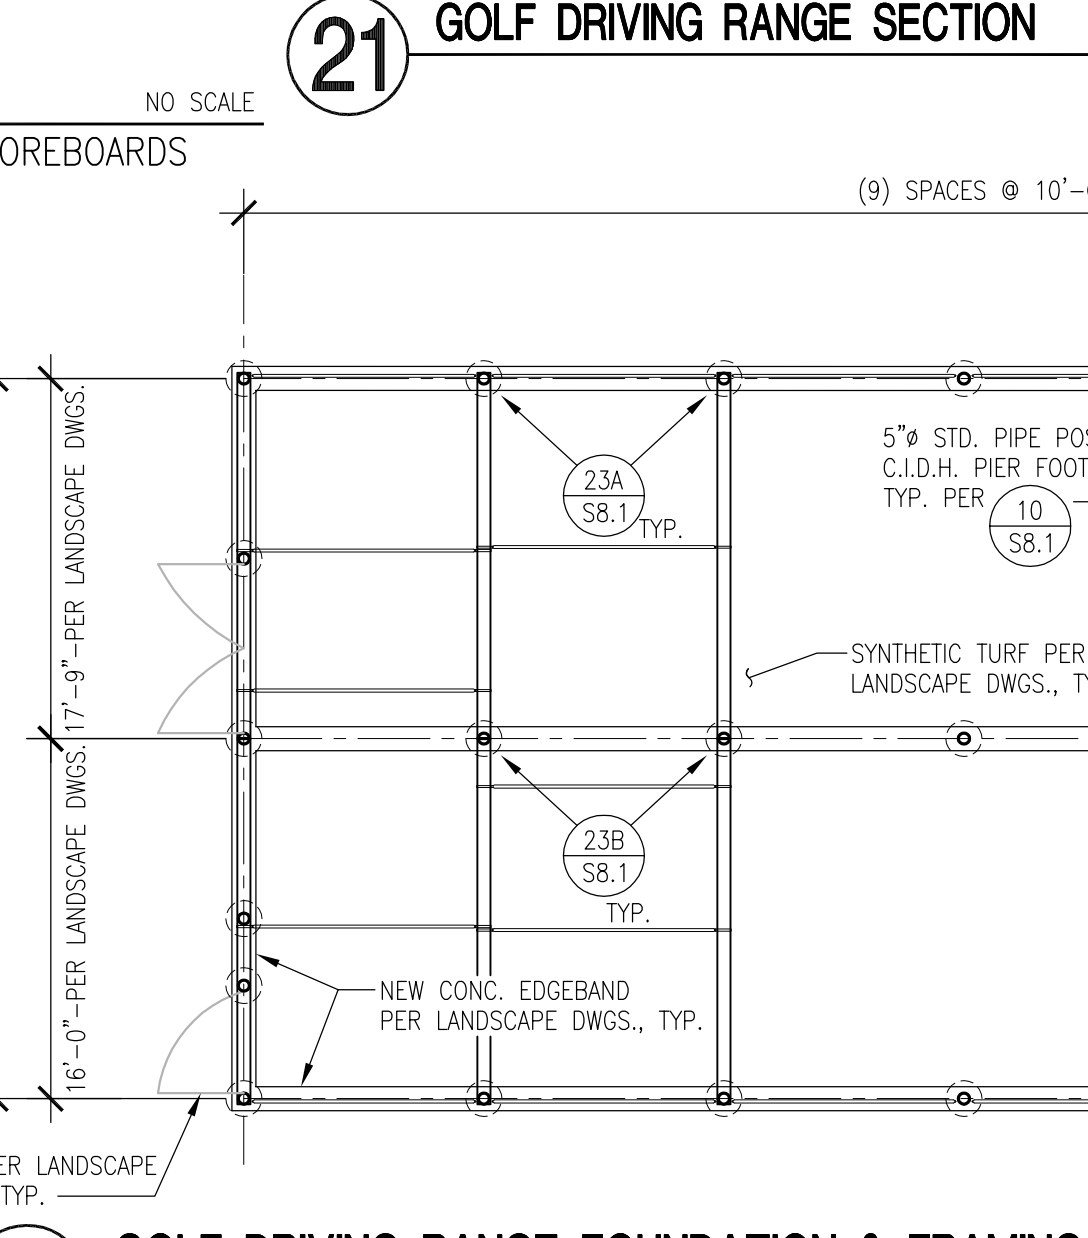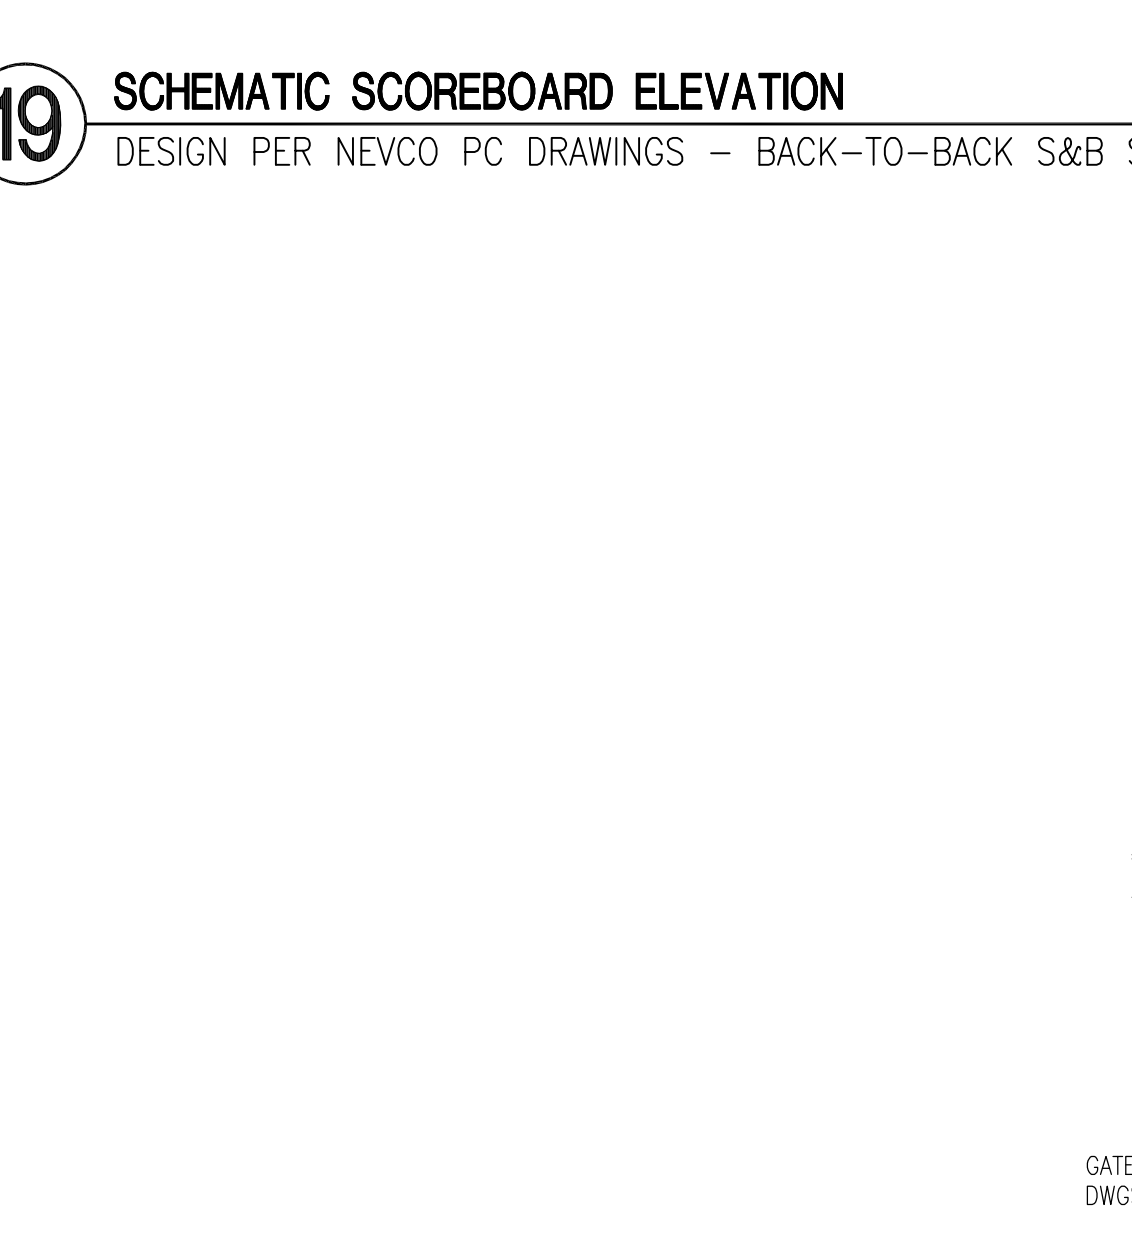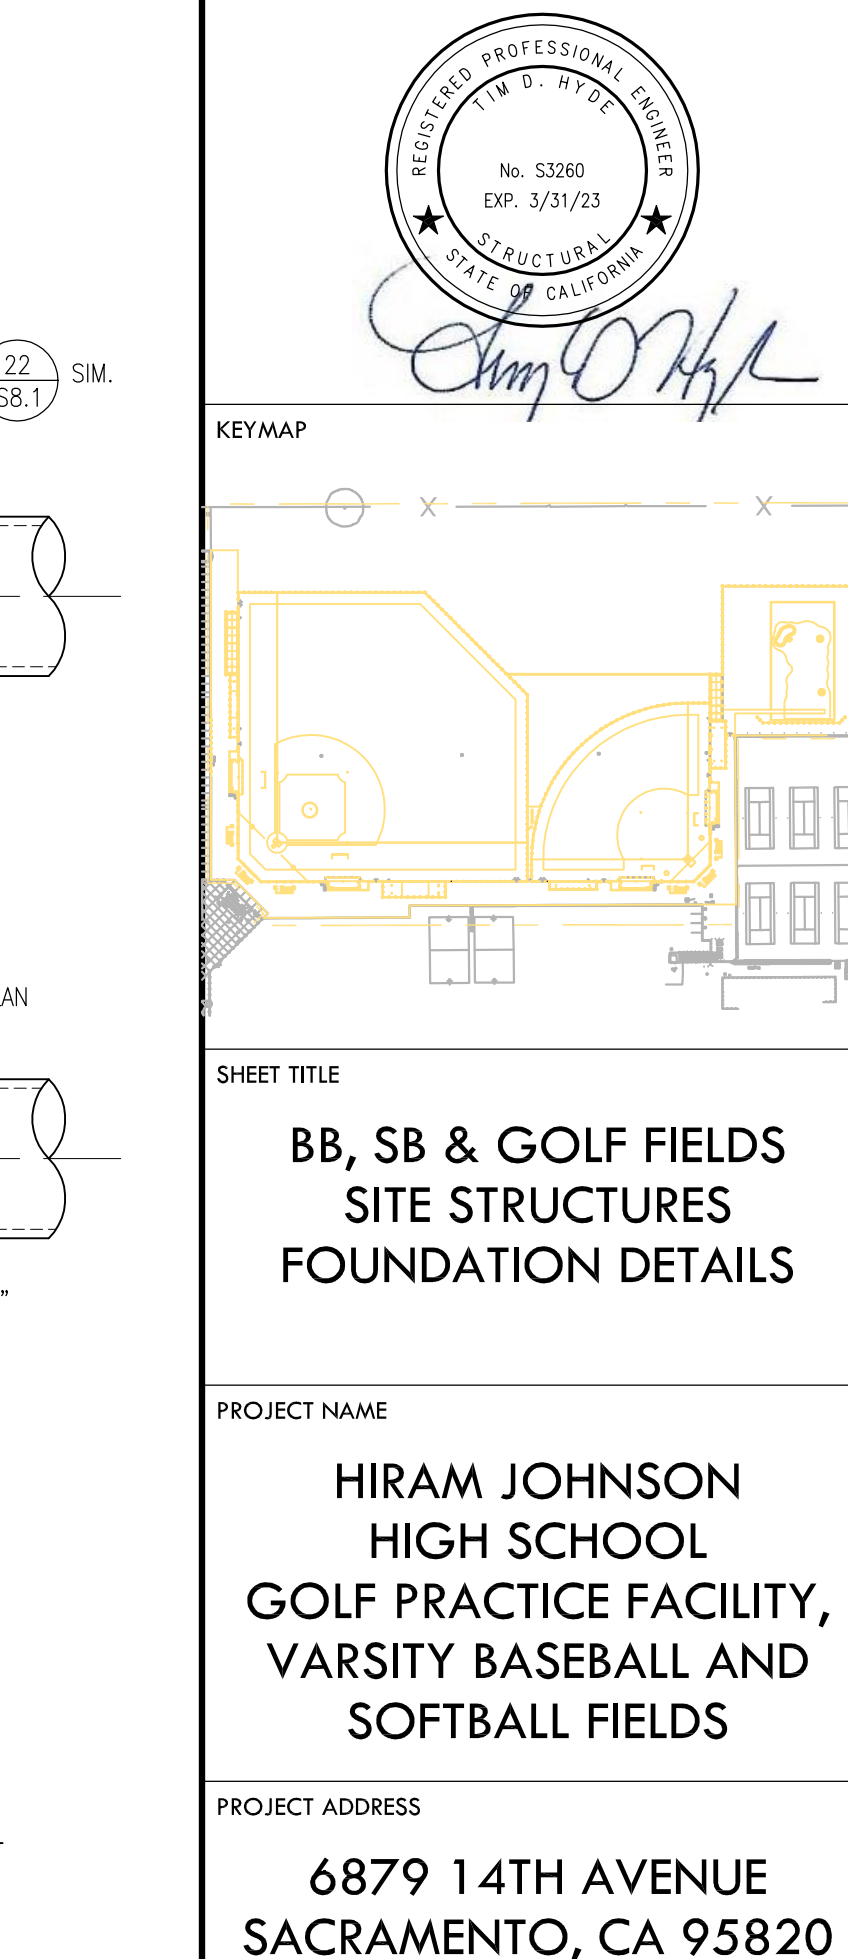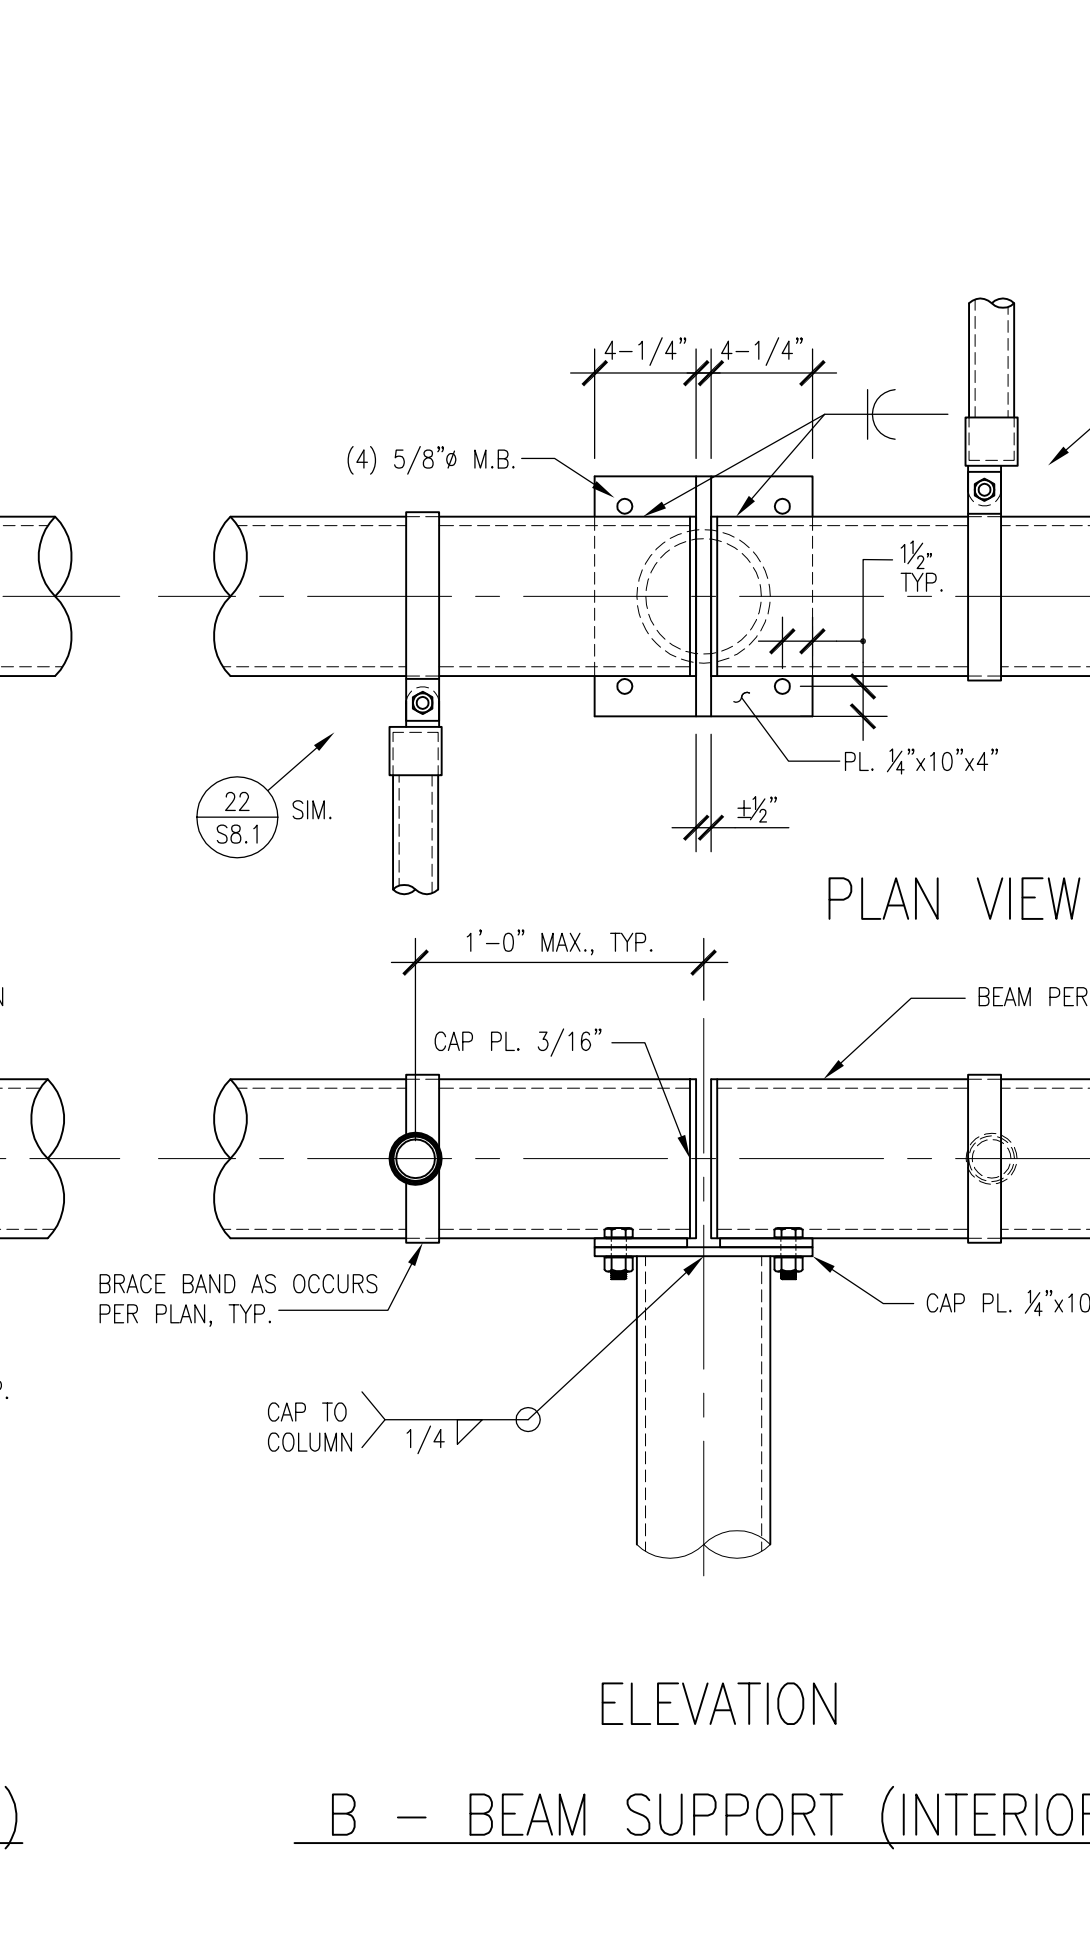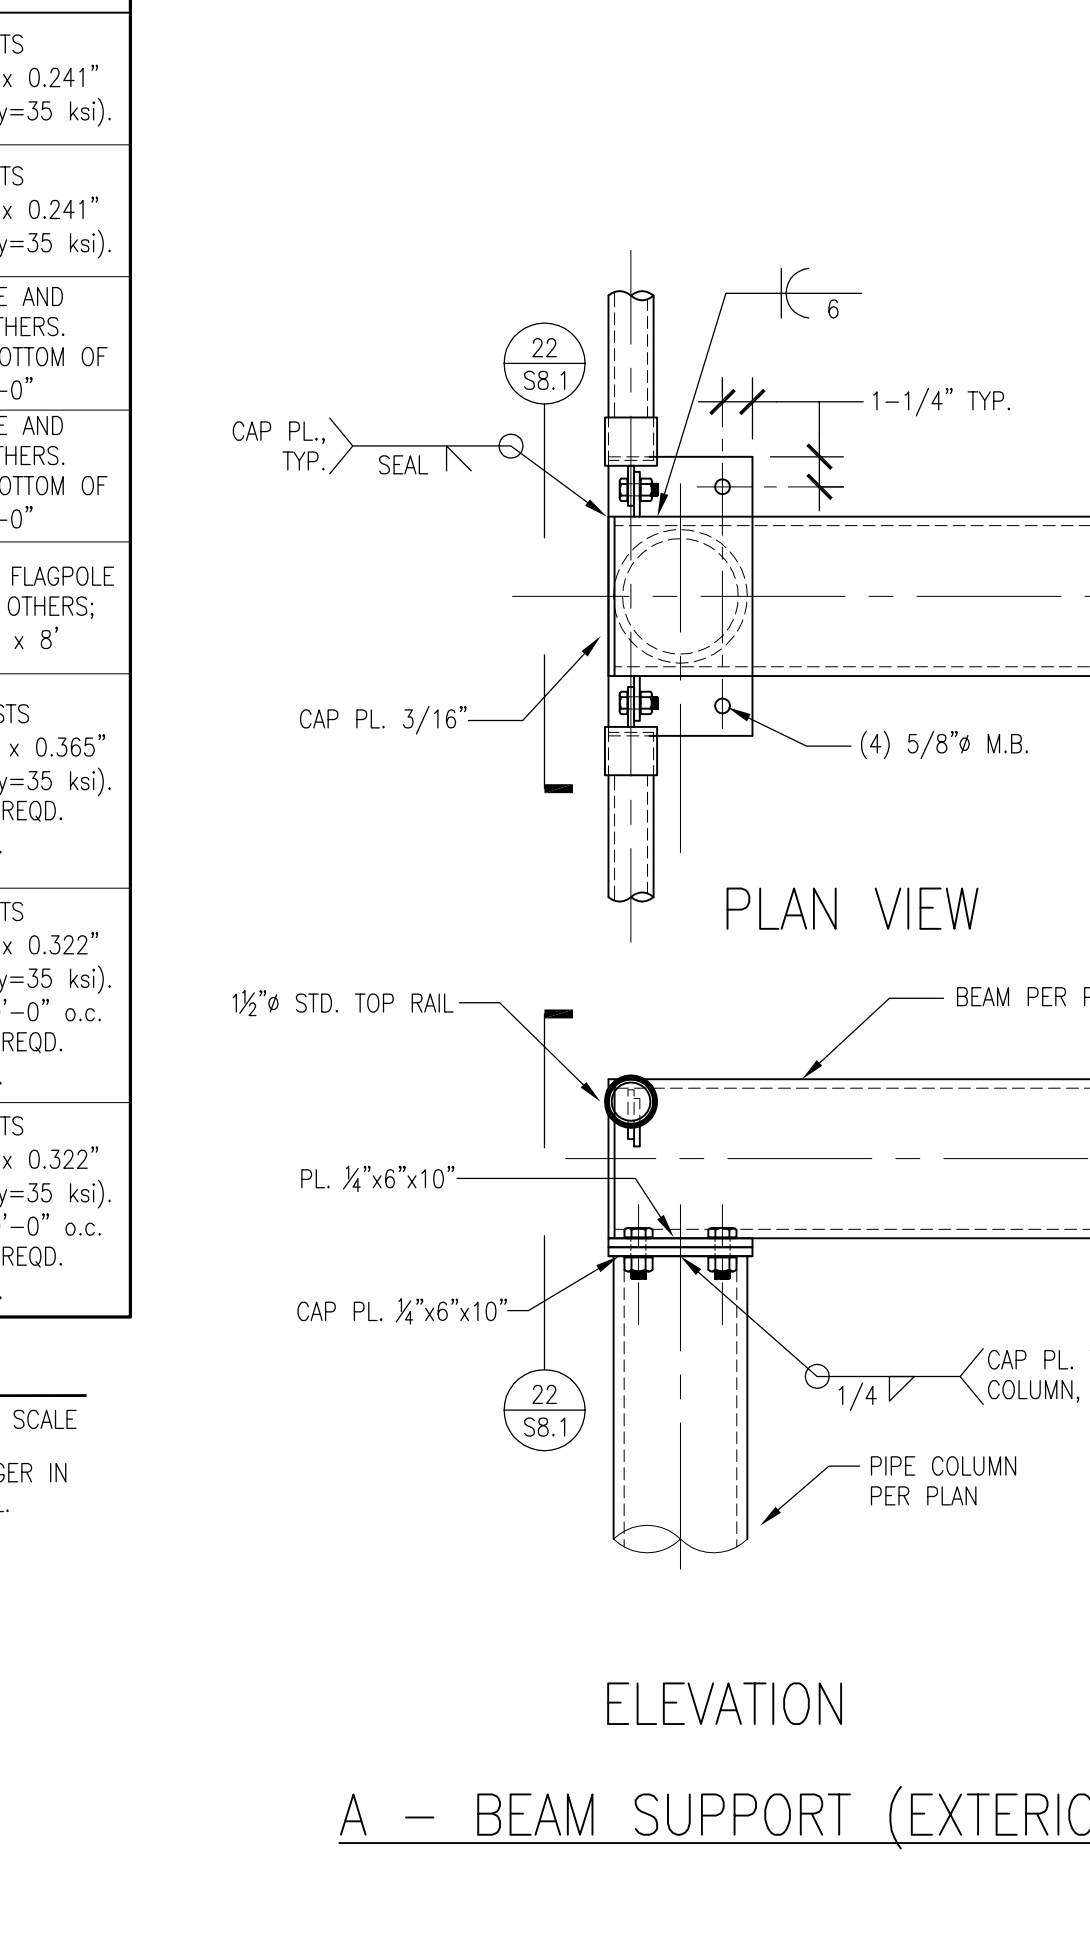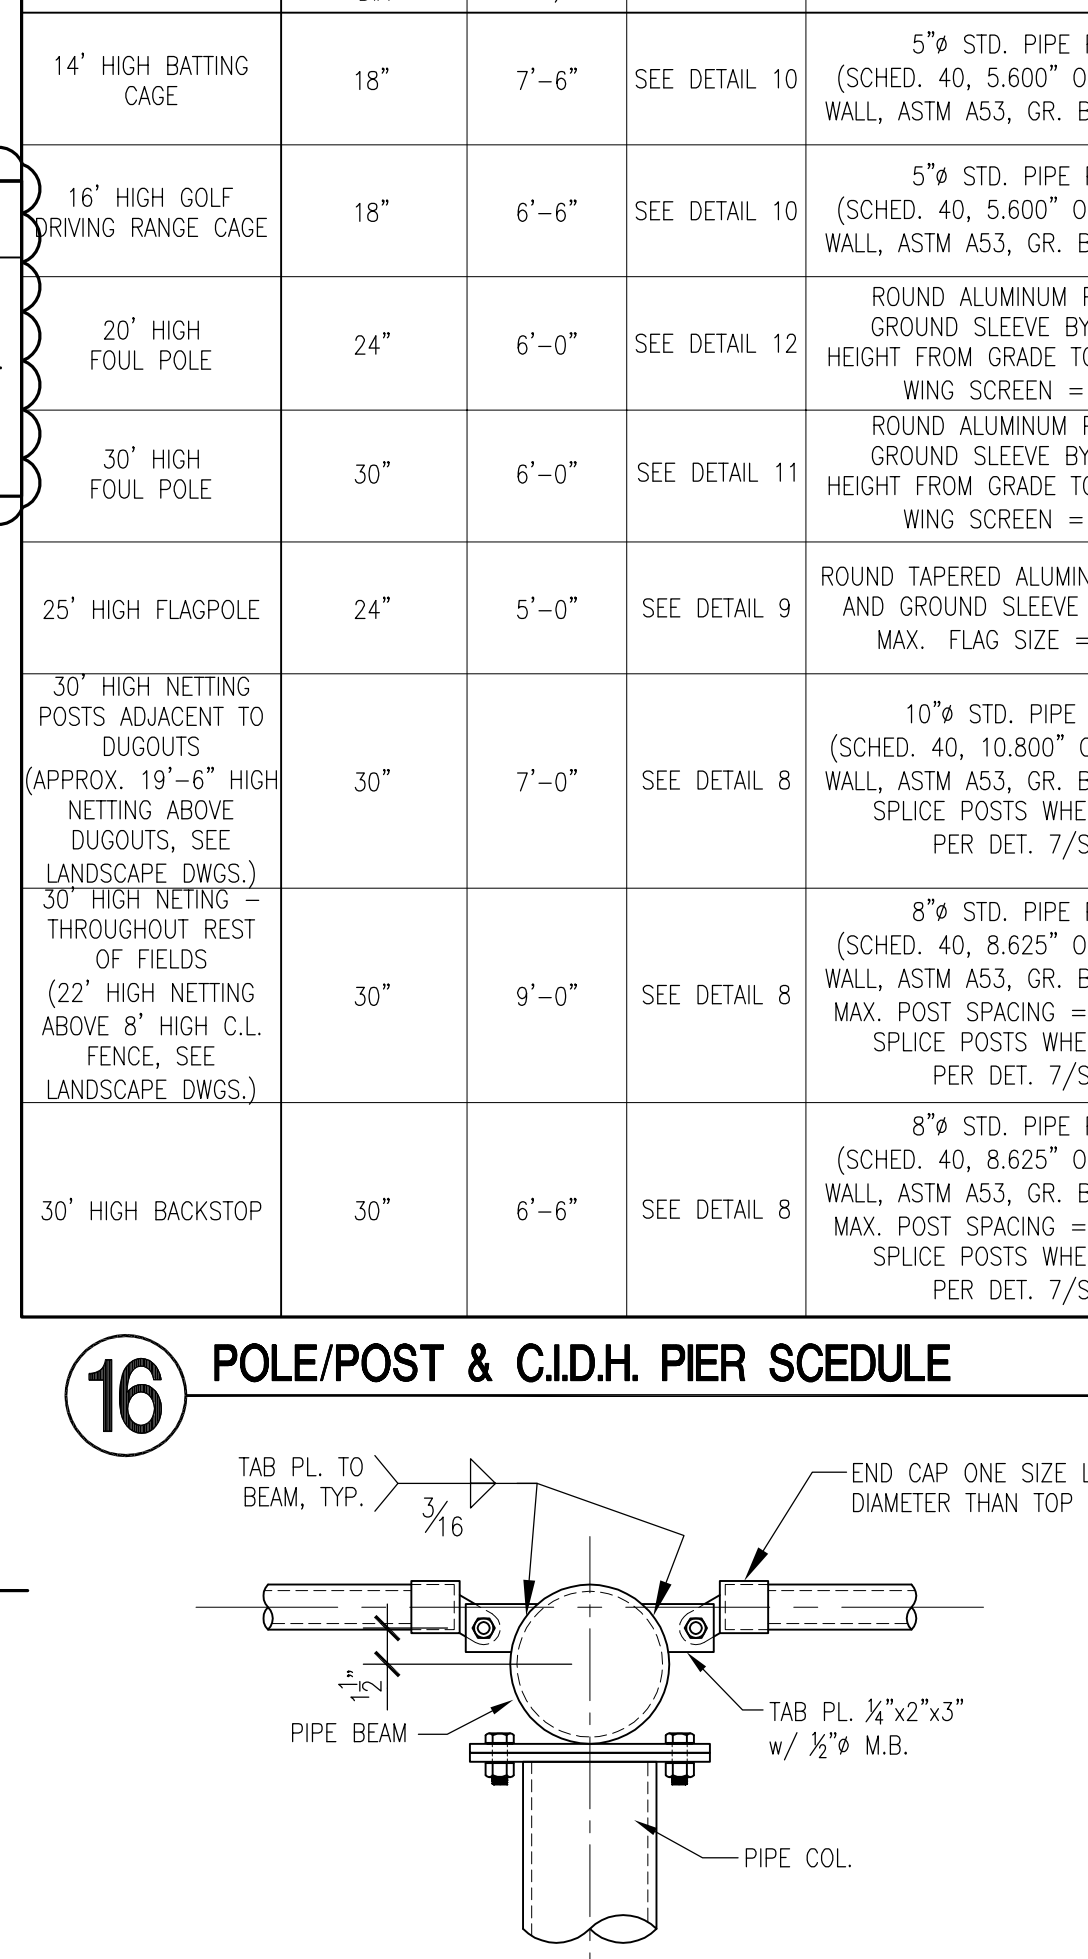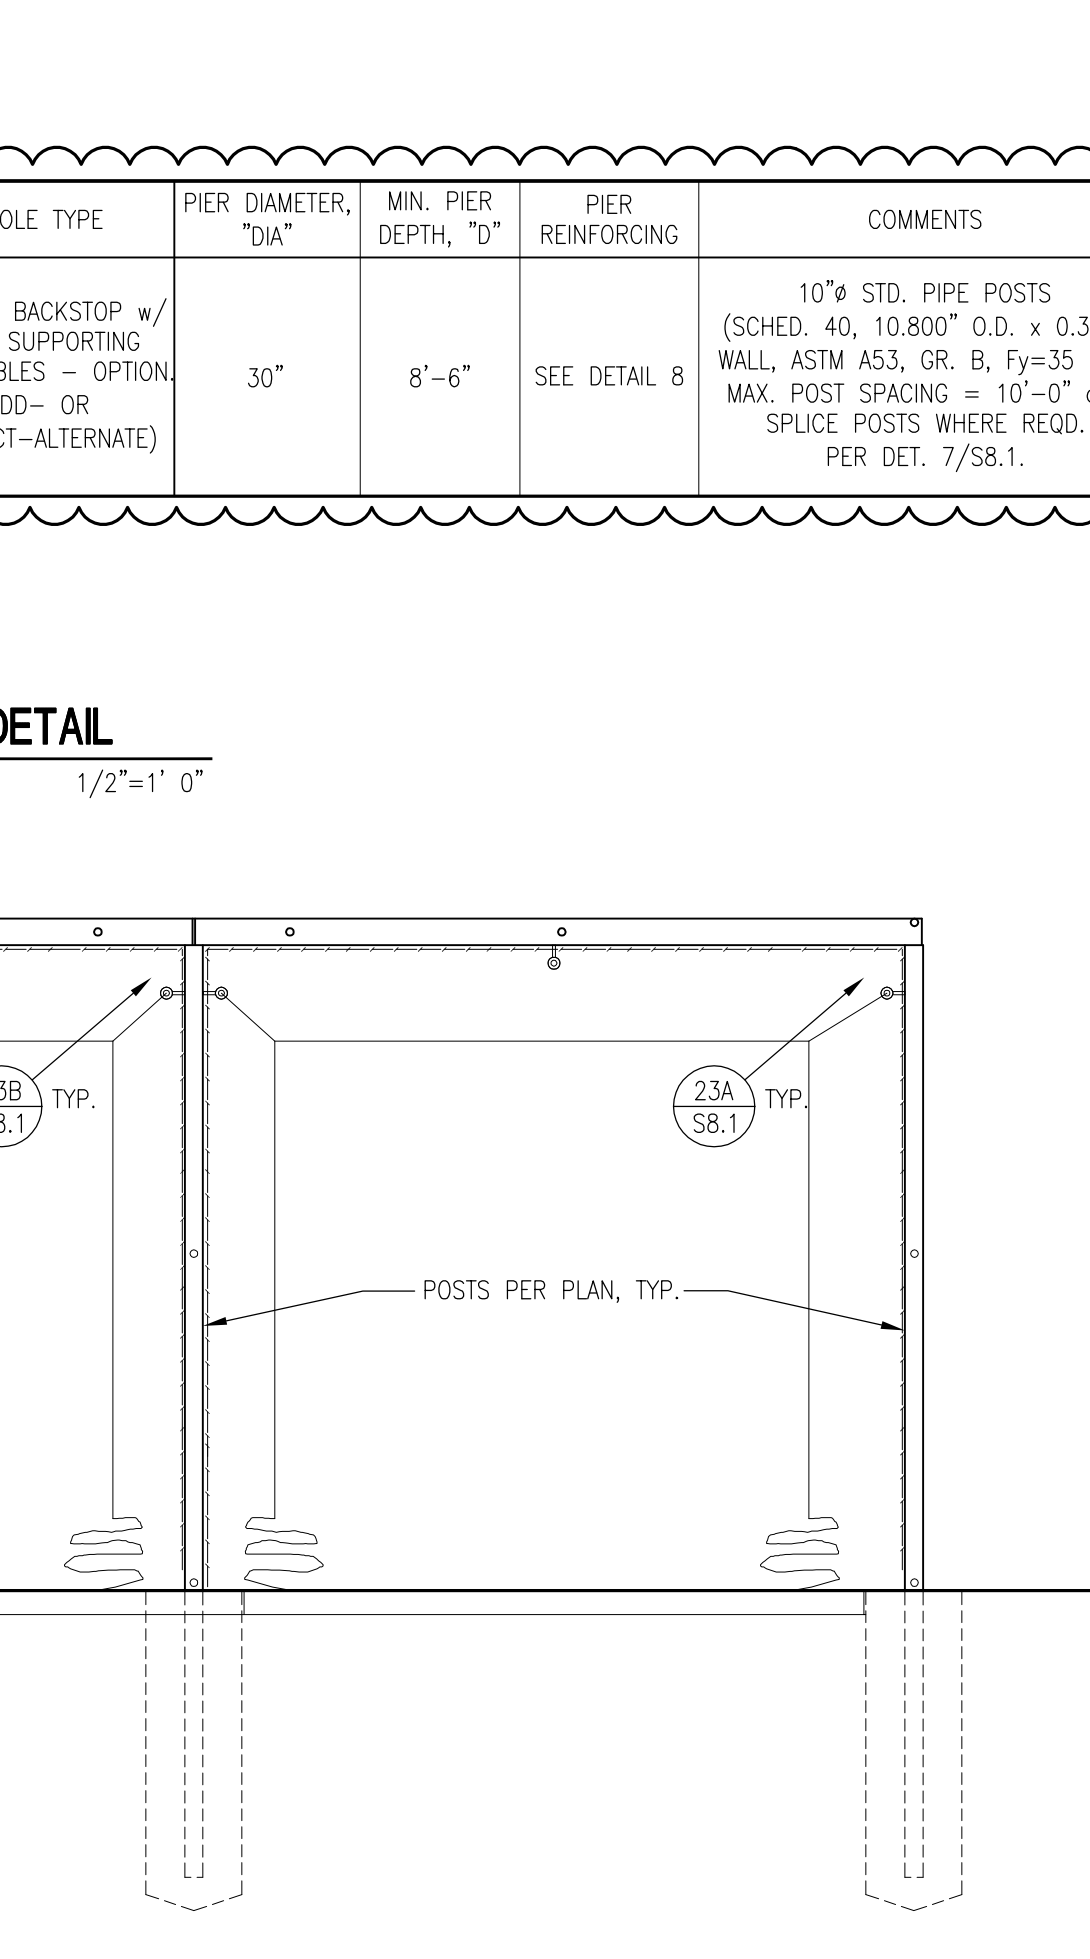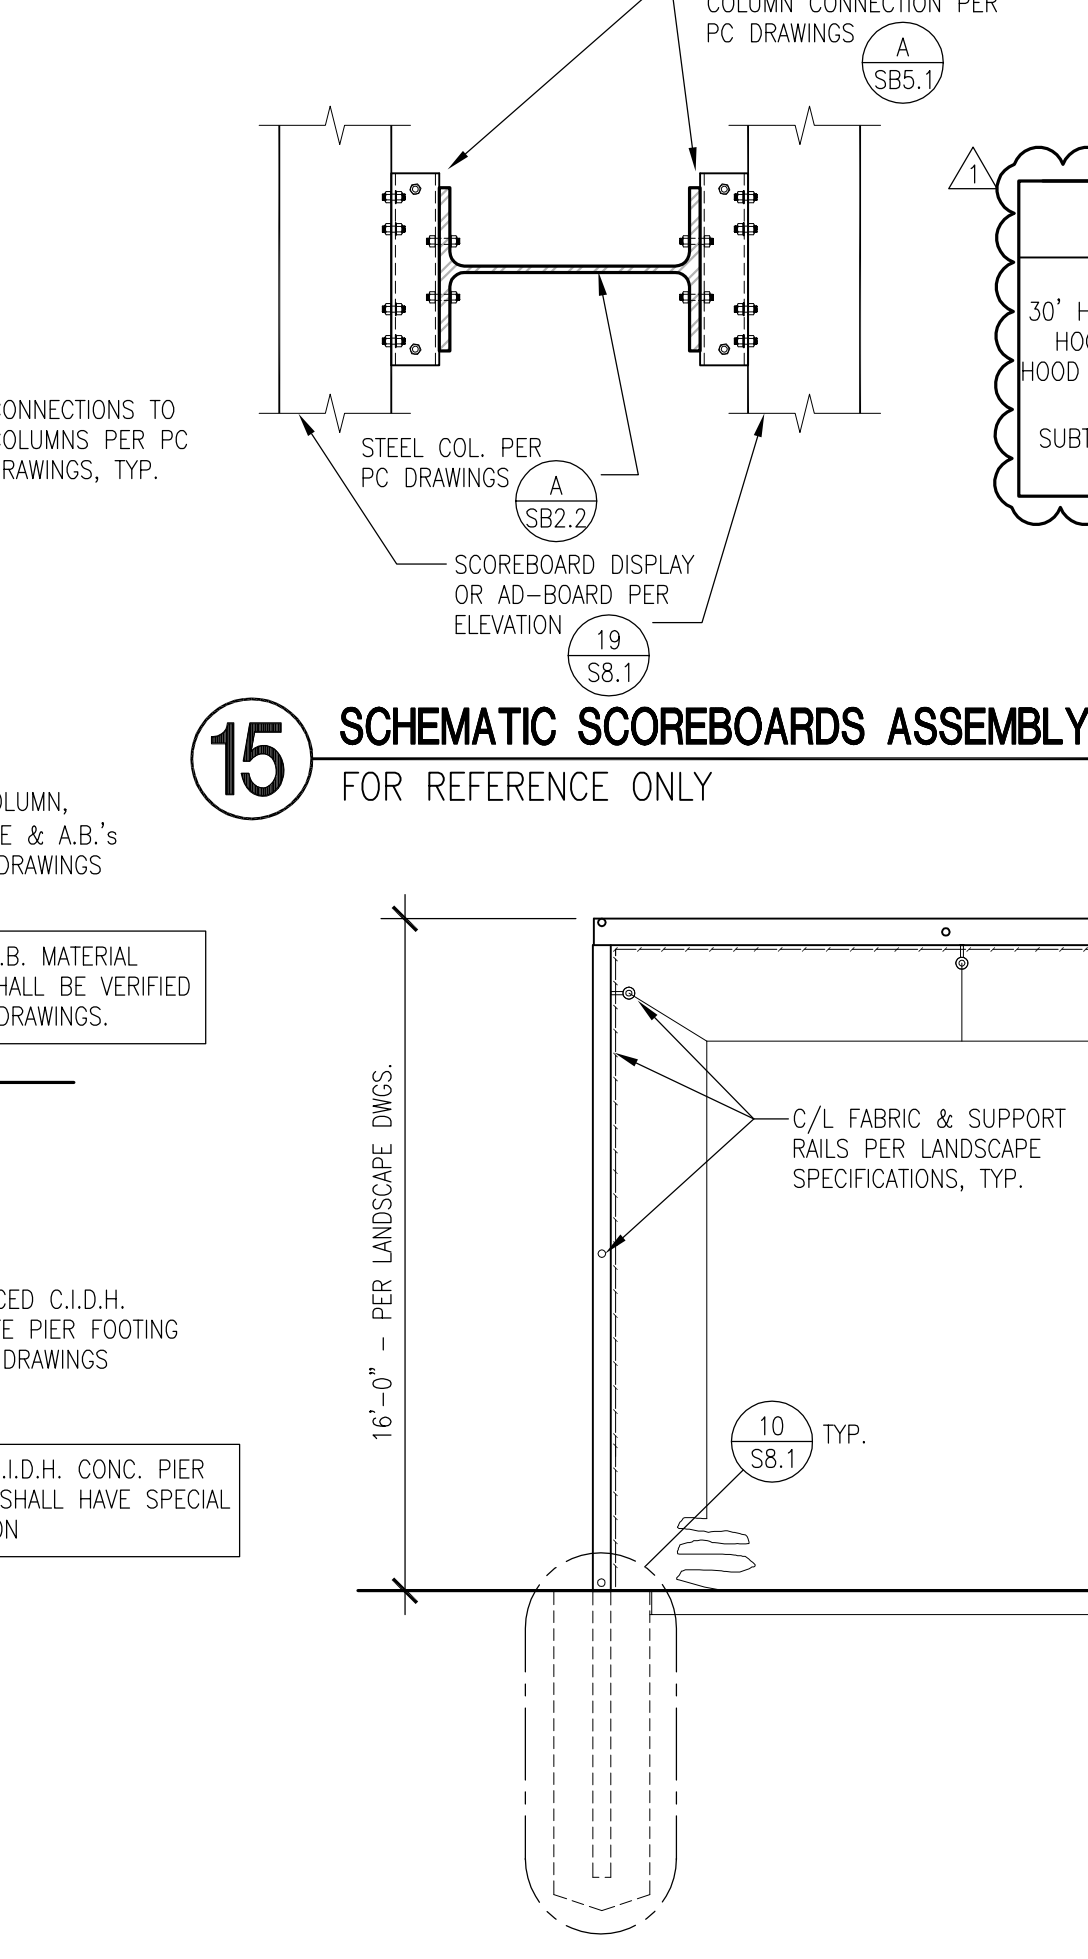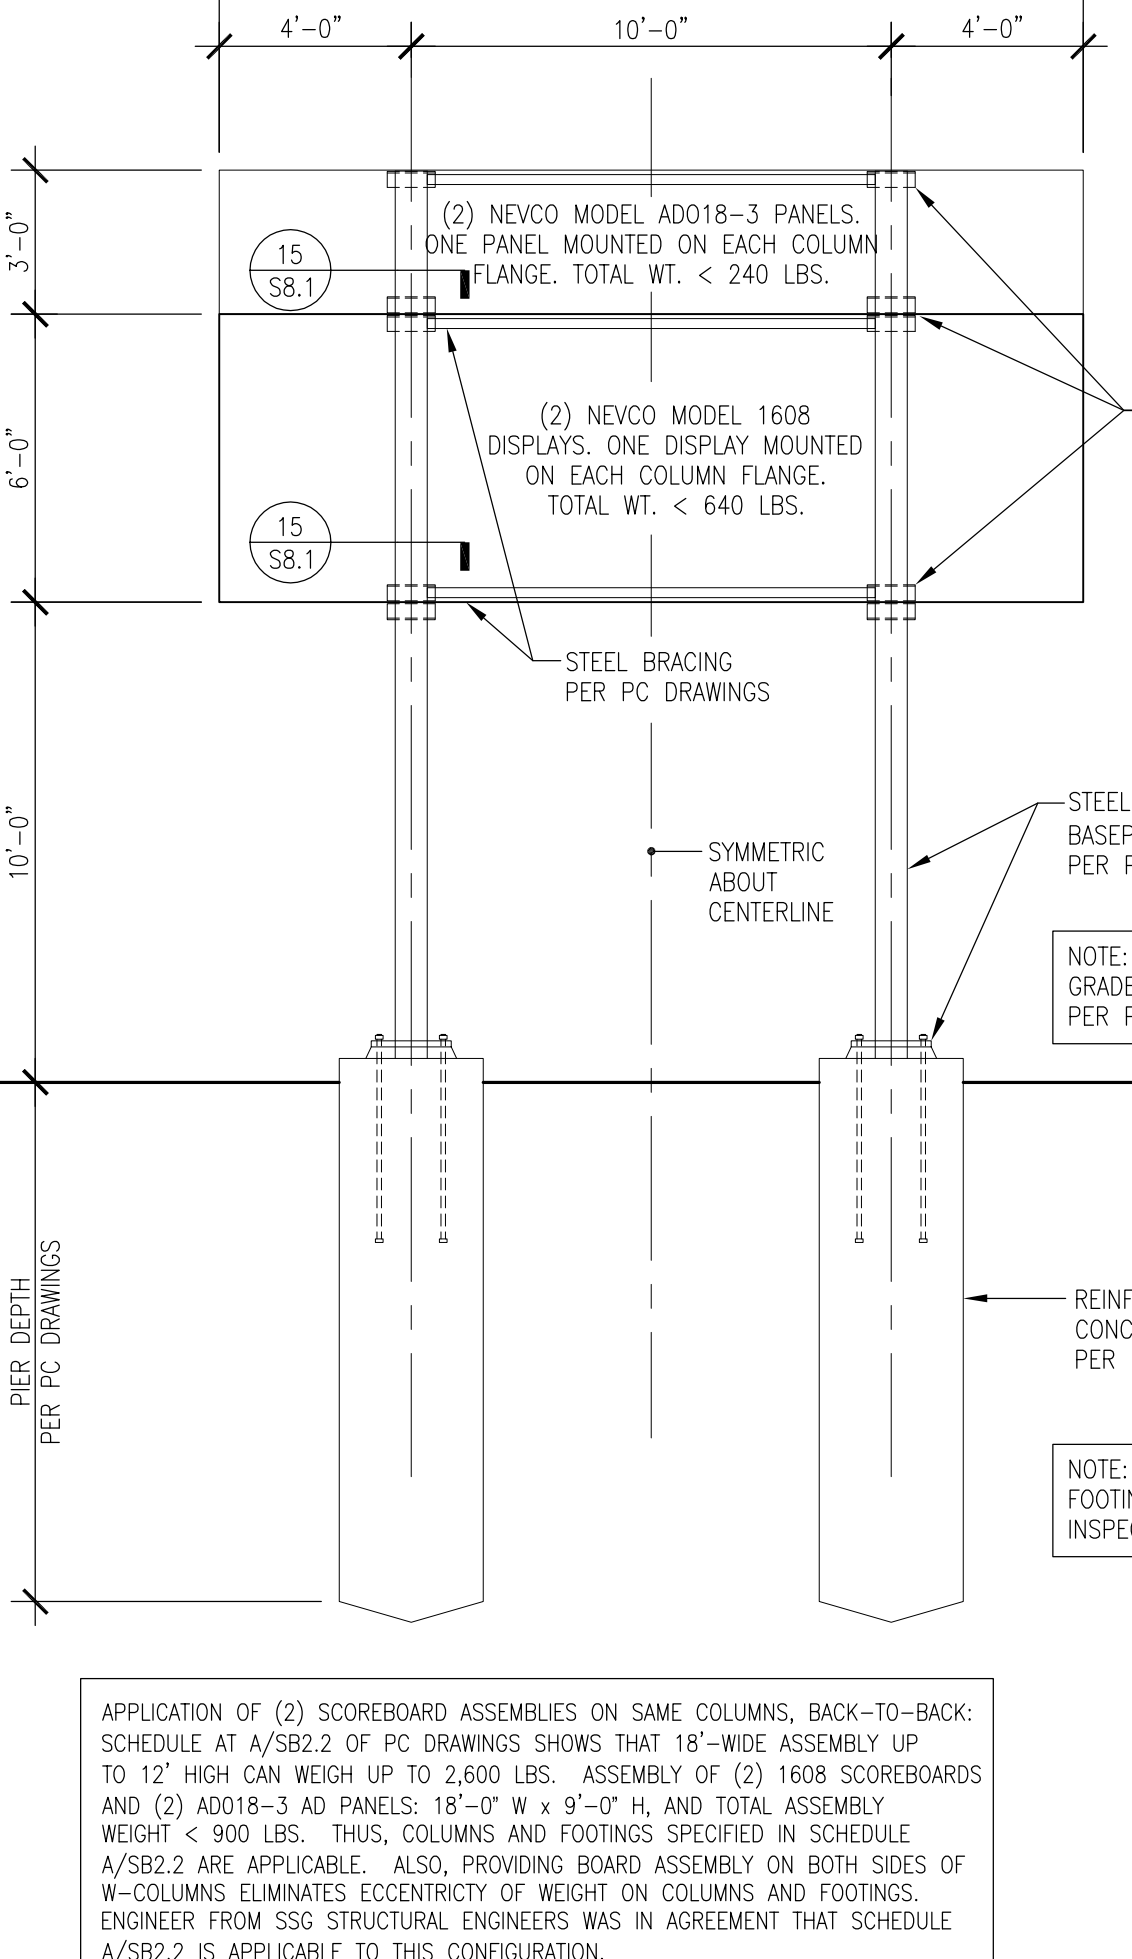

19 SCHEMATIC SCOREBOARD ELEVATION NO SCALE

21 GOLF DRIVING RANGE SECTION 1"=1' 0"

22 SECTION - TOP RAIL AT PIPE BEAM CONN. 1-1/2"=1' 0"

27 TYP. BATING CAGE SECTION 1"=1' 0"

29 BATING CAGE CAGE FOUNDATION & FRAMING PLANS 1/8"=1' 0"


29 BATING CAGE CAGE FOUNDATION & FRAMING PLANS 1/8"=1' 0"

29 BATING CAGE CAGE FOUNDATION & FRAMING PLANS 1/8"=1' 0"

VERDE DESIGN
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 web: AKHSE.com

PROFESSIONAL ENGINEER
 No. 52960
 Exp. 3/31/23
 STATE OF CALIFORNIA
 CIVIL ENGINEERING
 Jimmy O'Hara

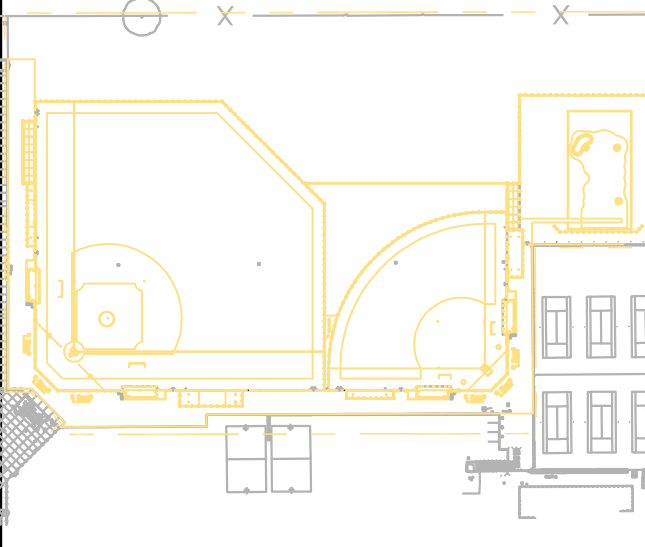

SHEET TITLE
**BB, SB & GOLF FIELDS
 SITE STRUCTURES
 FOUNDATION DETAILS**

PROJECT NAME
**HIRAM JOHNSON
 HIGH SCHOOL
 GOLF PRACTICE FACILITY,
 VARSITY BASEBALL AND
 SOFTBALL FIELDS**

PROJECT ADDRESS
**6879 14TH AVENUE
 SACRAMENTO, CA 95820**

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


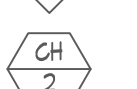















SHEET NO. **S8.1**
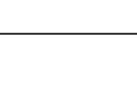
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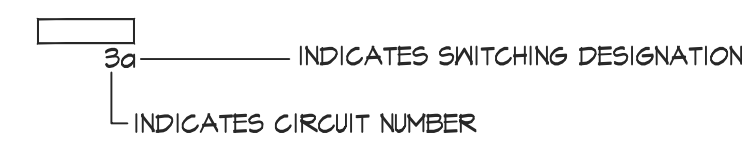
GENERAL NOTES:

- READ THE COMPLETE SPECIFICATIONS, CONTRACT DOCUMENTS AND COMPLY WITH EACH REQUIREMENTS.
- THE COMPLETE ELECTRICAL INSTALLATIONS SHALL BE IN ACCORDANCE WITH THE CURRENT EDITION OF THE N.E.C., AND ALL APPLICABLE STATE AND LOCAL CODES ISSUED BY AUTHORITIES HAVING JURISDICTION.
- THE CONTRACTOR SHALL BE LICENSED BY THE STATE OF CALIFORNIA C-10 AND SHALL COMPLY WITH ALL APPLICABLE CODES AND REGULATIONS. MATERIALS AND EQUIPMENT SHALL BE LISTED AND LABELED FOR THE APPLICATION.
- THE CONTRACTOR SHALL OBTAIN AND PAY FOR ALL PERMITS, LICENSES AND INSPECTION FEES REQUIRED BY THIS CONTRACT WORK.
- PRIOR TO SUBMITTING A BID THE CONTRACTOR SHALL VISIT THE SITE, REVIEW THE EXISTING CONDITIONS AND ALLOW FOR LABOR, MATERIAL AND COORDINATION THAT IS NECESSARY TO PROVIDE A COMPLETE INSTALLATION OF EACH SYSTEM. THE CONTRACTOR SHALL OBTAIN AND BE FAMILIAR WITH ALL OTHER TRADES. THE CONTRACTOR SHALL BE RESPONSIBLE FOR ALL ELECTRICAL WORK NOTED AND CALLED OUT ON ALL CONTRACT DOCUMENTS. THE CONTRACTOR SHALL BE RESPONSIBLE FOR COORDINATION BETWEEN OTHER TRADES ON PROJECT.
- THE CONTRACTOR SHALL BE RESPONSIBLE FOR THE SAFETY OF PERSONS AND PROPERTY AND SHALL PROVIDE INSURANCE COVERAGE AS NECESSARY FOR LIABILITY, PERSONAL, PROPERTY DAMAGE, TO FULLY PROTECT THE OWNER, ARCHITECT AND ENGINEER FROM ANY AND ALL CLAIMS RESULTING FROM THIS WORK.
- THE CONTRACTOR SHALL MAINTAIN RECORD DRAWINGS AT THE PROJECT SITE INDICATING ALL MODIFICATIONS TO ELECTRICAL SYSTEMS. THE CONTRACTOR SHALL AT THE CONCLUSION OF THE PROJECT PROVIDE ACCURATE "AS-BUILT" DRAWINGS. "AS-BUILT" DRAWINGS SHALL SHOW ACTUAL CHANGES TO ORIGINAL ELECTRICAL DRAWINGS, SHOW LOCATIONS OF PULLBOXES, CONDUIT RUNS AND WIRING CHANGES.
- ALL MATERIALS PROVIDED TO THE PROJECT SHALL BE IL OR CSA LISTED AND SHALL BE NEW. THE CONTRACTOR SHALL BE RESPONSIBLE TO PROVIDE AND INSTALL ALL INCIDENTAL MATERIALS REQUIRED FOR A COMPLETE INSTALLATION.
- THE CONTRACTOR SHALL PROVIDE ALL REQUIRED CUTTING, PATCHING, EXCAVATION, BACKFILL AND REPAIRS NECESSARY TO RESTORE DAMAGED SURFACES TO EQUAL OR BETTER THAN EXISTING CONDITIONS AT START OF WORK. THE CONTRACTOR SHALL CONTACT "UNDERGROUND SERVICES ALERT" FOR LOCATION OF EXISTING UTILITIES PRIOR TO COMMENCEMENT OF UNDERGROUND WORK.
- THE CONTRACTOR SHALL BE RESPONSIBLE FOR PAINTING ALL EXPOSED CONDUITS AND ELECTRICAL EQUIPMENT. REFER TO ARCHITECTS PAINTING SECTION FOR REQUIREMENTS.
- ALL ELECTRICAL EQUIPMENT INSTALLED OUTDOORS SHALL BE WEATHERPROOF. EXTERIOR CONDUITS RUN INTO BUILDINGS SHALL BE INSTALLED WITH FLASHING, CAULKED AND SEALED. CONDUITS FOR ELECTRICAL DEVICES SHALL BE RUN INSIDE BUILDINGS UNLESS OTHERWISE NOTED ON DRAWINGS. ALL EXTERIOR CONDUITS SHALL BE "RGS" UNLESS OTHERWISE NOTED ON DRAWINGS.
- ALL CONDUITS UNLESS OTHERWISE NOTED ON DRAWINGS SHALL HAVE AS A MINIMUM TWO (2) #12S WITH ONE (1) #12 GROUND. "TICK" MARKS SHOWN ON CIRCUITRY ARE FOR "ROUGH" ESTIMATING ONLY. THE CONTRACTOR SHALL BE RESPONSIBLE FOR ALL WIRES AND WIRE SIZES REQUIRED BY LATEST CODE.
- COORDINATE ALL CONDUIT RUNS, ELECTRICAL EQUIPMENT AND PANELS WITH ALL OTHER WORK TO AVOID CONFLICTS.
- ELECTRICAL EQUIPMENT SHOWN ON THIS DRAWING HAS BEEN SELECTED BASED ON DIMENSIONS TO FIT THE SPACE. THE CONTRACTOR SHALL VERIFY ALL EQUIPMENT DIMENSIONS PRIOR TO ORDERING OF THE EQUIPMENT.
- CONTRACTOR SHALL REVIEW EQUIPMENT REQUIREMENTS OF OTHER TRADES AND PROVIDE POWER CIRCUITS AND CONNECTIONS TO ELECTRICALLY OPERATED EQUIPMENT.
- CONTRACTOR SHALL DETERMINE EXACT LOCATION OF UNDERGROUND POWER AND TELEPHONE SERVICES FROM SERVING UTILITIES. FIELD ADJUSTMENTS MAY BE REQUIRED IN INDIVIDUAL SERVICE LOCATIONS.
- THE CONTRACTOR SHALL CONTACT "UNDERGROUND SERVICES ALERT" FOR LOCATION OF EXISTING UTILITIES PRIOR TO COMMENCEMENT OF UNDERGROUND WORK.
- NEW DUCT ROUTES ARE APPROXIMATE ONLY AND MAY BE ADJUSTED IN THE FIELD TO CLEAR OTHER UNDERGROUND UTILITIES. PROVIDE AS-BUILT DRAWINGS TO INDICATE ACTUAL LOCATION OF CONDUIT ROUTING.
- EFFECTIVELY BOND ELECTRICAL CABINETS, ENCLOSURES AND CONDUIT RACEWAYS TO CODE APPROVED GROUND AS PART OF THE CONTINUOUS GROUNDING SYSTEM.
- FROM ALL NEW PANELS, THE CONTRACTOR SHALL STUB UP INTO ACCESSIBLE CEILING SPACE A MINIMUM OF FOUR (4) 3/4" CONDUITS FOR FUTURE USE.
- UTILITY SERVICE WORK SHALL BE IN ACCORDANCE WITH THE SERVING UTILITY COMPANY'S RULES, REGULATIONS AND STANDARDS. AND SHALL BE VERIFIED WITH UTILITY COMPANY'S ENGINEERING DRAWINGS AND FIELD SUPERVISOR PRIOR TO COMMENCEMENT OF WORK. THE CONTRACTOR SHALL DETERMINE EXACT LOCATION OF UNDERGROUND POWER, GATV AND TELEPHONE SERVICES FROM SERVING UTILITIES. FIELD ADJUSTMENTS MAY BE REQUIRED IN INDIVIDUAL SERVICE LOCATIONS. THE CONTRACTOR SHALL REMAIN IN CONTACT WITH UTILITY COMPANY ENGINEERING DEPARTMENTS THROUGHOUT PROJECT TO INSURE COORDINATION AND SCHEDULING OF WORK.
- THE CONTRACTOR SHALL PROVIDE IN EVERY CONDUIT A DRAM STRINGS FOR USE IN FUTURE CONSTRUCTION. STRINGS SHALL BE NYLON PULLSTRINGS ROPE/STRINGS.
- POWER FEEDERS MAY NOT BE SHOWN ON THE DRAWINGS, REFER TO THE SINGLE LINE DIAGRAM FOR CONDUIT AND FEEDER INFORMATION. ALL DRAWINGS ARE DIAGRAMMATIC INDICATING LOCATION OR POSITION OF EQUIPMENT. FIELD VERIFY CONDITIONS PRIOR TO INSTALLATION OF ANY WORK.
- MANUFACTURER'S RECOMMENDATIONS FOR CONDUCTOR SIZING, CIRCUIT BREAKER OR FUSE PROTECTION OF ELECTRICALLY OPERATED EQUIPMENT MAY DIFFER FROM THOSE INDICATED ON DRAWINGS. CONTRACTOR SHALL CONFIRM RATINGS PRIOR TO ORDERING EQUIPMENT. PROVIDE ELECTRICAL PROTECTION TO EQUIPMENT IN ACCORDANCE TO MANUFACTURER'S SPECIFICATIONS AND PER NATIONAL ELECTRICAL CODE REQUIREMENTS.
- PROVIDE SEISMIC BRACING FOR ALL PENDANT LIGHT FIXTURES, FREESTANDING ELECTRICAL DISTRIBUTION EQUIPMENT, MOTOR CONTROL CENTERS ETC. AND CONDUIT RACKS PER SEISMIC CRITERIA 2014 CBC REQUIREMENTS INCLUDING ENGINEERED LOAD CALCULATIONS COMPLETE WITH SNAY BRACING CRITERIA.
- DO NOT SUBSTITUTE SPECIFIED MATERIAL OR EQUIPMENT WITHOUT FIRST OBTAINING APPROVAL FROM THE OWNER OR HIS REPRESENTATIVE.
- ALL SPACES ON PANELS OR SWITCHBOARDS SHALL BE COMPLETE WITH HARDWARES AND BUSHING FOR FUTURE BREAKER OR SWITCH.
- ALL ELECTRICAL WORK SHALL COMPLY WITH THE 2017 NATIONAL ELECTRICAL CODE AS AMENDED BY THE 2014 CALIFORNIA ELECTRICAL CODE.
- SPLICE GROUND WIRE INSIDE ALL METAL ELECTRICAL PULL BOXES AND BOND TO METAL COVER WITH #6 CU GND.

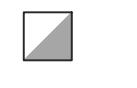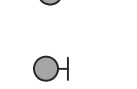SYMBOL LIST:

-  PLAN, DETAIL OR SECTION DESIGNATION.
-  ROOM NUMBER.
-  SHEET REFERENCE SYMBOL - SEE ASSOCIATED NOTE ON SAME SHEET.
-  FEEDER SCHEDULE SYMBOL.
-  MECHANICAL EQUIPMENT TAG.
-  INDICATES FIXTURE TYPE.
- LUMINAIRE SYMBOLS**
 -  LUMINAIRE - SEE SCHEDULE.
 -  LUMINAIRE - SEE SCHEDULE.
 -  LUMINAIRE - SEE SCHEDULE.
 -  LUMINAIRE - SEE SCHEDULE.
 -  LUMINAIRE MALL MOUNTED-SEE SCHEDULE.
 -  EMERGENCY LUMINAIRE - PROVIDE EMERGENCY BATTERY BALLAST
 -  EMERGENCY LUMINAIRE - PROVIDE EMERGENCY BATTERY BALLAST
 -  EMERGENCY LUMINAIRE - PROVIDE EMERGENCY BATTERY BALLAST
 -  EXIT LIGHT SINGLE FACE - SEE SCHEDULE.
 -  EXIT LIGHT SINGLE FACE (WITH ARROW)- SEE SCHEDULE.
 -  EXIT LIGHT (DOUBLE FACED WITH ARROW)- SEE SCHEDULE.
 -  COMBO EMERGENCY LIGHT/ EXIT LIGHT SINGLE FACE - SEE SCHEDULE.
 -  EMERGENCY BATTERY PACK EXIT LIGHT INSTALL AS DIRECTED.

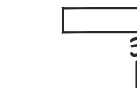TYPICAL LUMINAIRE NOMENCLATURE



SWITCH SYMBOLS

- \$ SINGLE POLE SWITCH, + 48" AFF UON.
- \$o SINGLE POLE SWITCH, + 48" AFF UON, o = CIRCUIT CONTROLLED.
- \$3 THREE WAY SWITCH + 48" AFF UON.
- \$4 FOUR WAY SWITCH + 48" AFF UON.
- \$ MOTOR RATED SWITCH
- @ OCCUPANCY SENSOR
- OCCUPANCY SENSOR POWER PACK

RECEPTACLE SYMBOLS

- CONVENIENCE RECEPTACLE - DUPLEX AT + 18" AFF UON.
- 6PFC CONVENIENCE RECEPTACLE - DUPLEX.
- RECEPTACLE DOUBLE DUPLEX AT + 18" AFF UON.
- SINGLE RECEPTACLE - NEMA 5-20R UON, AT + 18" AFF UON.
- SINGLE RECEPTACLE - NEMA L21 - 208 VOLT, THREE PHASE, 5 WIRE AT + 18" AFF UON.
- FLOOR BOX WITH CONVENIENCE RECEPTACLE, TELEPHONE AND DATA OUTLET.
- FLUSH FLOOR BOX WITH SINGLE CONVENIENCE RECEPTACLE.
- WIRE RACEWAY, INSTALL AT + 36" AFF UON.

POWER DISTRIBUTION SYMBOLS

- PANELBOARD - SURFACE OR FLUSH MOUNTED.
- JUNCTION BOX - CEILING OR WALL MOUNTED, SIZE TO CODE, TAPE AND TAG WIRES. PROVIDE FLEX AND/OR RECEPTACLE AS REQUIRED TO CONNECT EQUIPMENT.
- DISTRIBUTION PANEL
- MOTOR
- COMBINATION MAGNETIC STARTER FUSED DISCONNECT SWITCH. RATINGS AS INDICATED.
- UNFUSED DISCONNECT SWITCH - RATINGS AS INDICATED.
- FUSED DISCONNECT SWITCH - SIZE FUSES PER MOTOR MANUFACTURER'S RECOMMENDATIONS. RATINGS AS INDICATED.
- MAGNETIC STARTER - NEMA SIZE INDICATED.
- TRANSFORMER - SEE SINGLE LINE FOR SIZE.
- GROUND ROD.

WIRING & CONDUIT RUN SYMBOLS

- CONDUIT - CONCEALED IN WALLS OR CEILING.
- - - CONDUIT - EXPOSED.
- - - CONDUIT - IN OR BELOW FLOOR, 3/4" MIN.
- ⤵ CONDUIT - HOME RUN TO PANEL, TERMINAL CABINET, ETC., RUNS MARKED WITH CROSSSHATCHES INDICATE NUMBER OF #12 AWG WIRES. CROSSSHATCH WITH SUBSCRIPT 'G' INDICATES GREEN GROUND WIRE. SIZE CONDUIT ACCORDING TO SPECIFICATIONS AND APPLICABLE CODE. CROSSSHATCHES WITH "#10" INDICATES WIRE SIZE OTHER THAN #12S.
- FLEX CONDUIT WITH CONNECTION.
- CONDUIT - STUB UP.
- CONDUIT - STUB DOWN.
- CONDUIT EMERGENCY SYSTEM.
- CAPPED CONDUIT.
- CONDUIT CONTINUATION.

POWER DISTRIBUTION SINGLE LINE SYMBOLS

- CIRCUIT BREAKER.
- "P64E" METER W/ CURRENT TRANSFORMER.
- TRANSFORMER.

IN-GRADE PULL BOXES

- IN-GRADE PULL BOX IDENTIFIED WITH 'L' HAS A LID LABELED 'LIGHTINGS'.
- IN-GRADE PULL BOX IDENTIFIED WITH 'S' HAS A LID LABELED 'SIGNAL'.
- IN-GRADE PULL BOX IDENTIFIED WITH 'P' HAS A LID LABELED 'ELECTRICAL'.

ABBREVIATIONS:

- A AMPERE
- ABV ABOVE
- AF AMP FRAME OR AMP FUSE
- AF1 ABOVE FINISHED FLOOR
- ARCH ARCHITECTURAL
- AS AMP SWITCH
- AT AMP TRIP
- ATS AUTOMATIC TRANSFER SWITCH
- BKR BREAKER
- BLDG BUILDING
- C CONDUIT
- GATV CABLE TELEVISION
- CB CIRCUIT BREAKER
- CD CANDELAB
- CKT CIRCUIT
- CL CENTER LINE
- CLS CEILING
- CO CONDUIT ONLY
- CTR CENTER
- D DENOISH
- DET DETAIL
- DIM DIMENSION
- DISTR DISTRIBUTION
- DWS DRAWING
- EJ EXISTING
- EM EMERGENCY
- EQPT EQUIPMENT
- FA FIRE ALARM
- FACP FIRE ALARM CONTROL PANEL
- (F) FUTURE
- FIN FINISH
- FL FLOOR
- G, GND GROUND
- HST HEIGHT
- HP HORSEPOWER
- IC INTERCOM
- IFP INTERMEDIATE DISTRIBUTION FRAME
- JB JUNCTION BOX
- KAIC KILOAMPERE INTERRUPTING CAPACITY
- KV KILOVOLT
- KVA KILOVOLT AMPERES
- KW KILOWATT
- LTS LIGHTING
- MDM THOUSAND CIRCULAR MILS
- MDF MAIN DISTRIBUTION FRAME
- MECH MECHANICAL
- MH MANHOLE
- MT MOUNTED
- MTG MOUNTING
- NV NORMALLY CLOSED
- NIC NOT IN CONTRACT
- NI NOT IN ELECTRICAL CONTRACT
- NO NORMALLY OPEN
- NTS NOT TO SCALE
- O.C. ON CENTER
- P POLE CIRCUIT BREAKER
- PA PUBLIC ADDRESS
- PB PULL BOX
- PF POWER FACTOR
- PH PHASE
- PNL PANEL
- (R) EXISTING TO BE RELOCATED
- REQD REQUIRED
- REQT REQUIREMENTS
- RM ROOM
- RSG RIGID STEEL CONDUIT
- SHT SHEET
- SK SWITCH
- SVBD SWITCHBOARD
- TC TERMINAL CABINET
- TEL TELEPHONE
- TYP TYPICAL
- UON UNLESS OTHERWISE NOTED
- V VOLT
- M MATT
- HP WEATHERPROOF
- XFMR TRANSFORMER

GENERAL ANCHORAGE NOTES:

MEP COMPONENT ANCHORAGE NOTE. REVISED: FEBRUARY 14, 2022

ALL MECHANICAL, PLUMBING AND ELECTRICAL COMPONENTS SHALL BE ANCHORED AND INSTALLED PER THE DETAILS ON THE DSA APPROVED CONSTRUCTION DOCUMENTS. THE FOLLOWING COMPONENTS SHALL BE ANCHORED OR BRACED TO MEET THE FORCE AND DISPLACEMENT REQUIREMENTS PRESCRIBED IN THE 2014 CBC, SECTIONS 1611A.18 THROUGH 1611A.26 AND ASCE 116 CHAPTER 13, 26 AND 30.

- ALL PERMANENT EQUIPMENT AND COMPONENTS.
- TEMPORARY, MOVABLE OR MOBILE EQUIPMENT THAT IS PERMANENTLY ATTACHED (e.g. HARD WIRED) TO THE BUILDING UTILITY SERVICES SUCH AS ELECTRICITY, GAS OR WATER, PERMANENTLY ATTACHED SHALL INCLUDE ALL ELECTRICAL CONNECTIONS EXPECT FLUGS FOR 100/220 VOLT RECEPTACLES HAVE A FLEXIBLE CABLE.
- TEMPORARY, MOVABLE OR MOBILE EQUIPMENT WHICH IS HEAVIER THAN 400 POUNDS OR HAS A CENTER OF MASS LOCATED 4 FEET OR MORE ABOVE THE ADJACENT FLOOR OR ROOF LEVEL THAT DIRECTLY SUPPORT THE COMPONENT IS REQUIRED TO BE RESTRAINED IN A MANNER APPROVED BY DSA.

THE FOLLOWING MECHANICAL AND ELECTRICAL COMPONENTS SHALL BE POSITIVELY ATTACHED TO THE STRUCTURE BUT NEED NOT DEMONSTRATE DESIGN COMPLIANCE WITH THE REFERENCES NOTED ABOVE. THESE COMPONENTS SHALL HAVE FLEXIBLE CONNECTIONS PROVIDED BETWEEN THE COMPONENT AND ASSOCIATED DUCTWORK, PIPING AND CONDUIT. FLEXIBLE CONNECTIONS MUST ALLOW MOVEMENT IN BOTH TRANSVERSE AND LONGITUDINAL DIRECTIONS.

- COMPONENTS WEIGHING LESS THAN 400 POUNDS AND HAVING A CENTER OF MASS LOCATED 4 FEET OR LESS ABOVE THE ADJACENT FLOOR OR ROOF LEVEL THAT DIRECTLY SUPPORT THE COMPONENT.
- COMPONENTS WEIGHING LESS THAN 20 POUNDS, OR IN THE CASE OF DISTRIBUTED SYSTEMS, LESS THAN 5 POUNDS PER FOOT, WHICH ARE SUSPENDED FROM A ROOF OR FLOOR OR HANG FROM A WALL.

THE ANCHORAGE OF ALL MECHANICAL, ELECTRICAL AND PLUMBING COMPONENTS SHALL BE SUBJECT TO THE APPROVAL OF THE DESIGN PROFESSIONAL. IN GENERAL, RESPONSIBLE CHARGE OR STRUCTURAL ENGINEER DELEGATED RESPONSIBILITY AND ACCEPTANCE BY DSA. THE PROJECT INSPECTOR WILL VERIFY THAT ALL COMPONENTS AND EQUIPMENT HAVE BEEN ANCHORED IN ACCORDANCE WITH THE ABOVE REQUIREMENTS.

PIPING, DUCTWORK AND ELECTRICAL DISTRIBUTION SYSTEM BRACING NOTE.

PIPING, DUCTWORK AND ELECTRICAL DISTRIBUTION SYSTEMS SHALL BE BRACED TO COMPLY WITH THE FORCES AND DISPLACEMENTS PRESCRIBED IN ASCE 1-16 SECTIONS 19.3 AS DEFINED IN ASCE 1-16 SECTION 19.6.5, 19.6.6, 19.6.7, 19.6.8 AND 2014 CBC, SECTION 1611A.124, 1611A.125 AND 1611A.126.

THE METHOD OF SHOWING BRACINGS AND ATTACHMENTS TO THE STRUCTURE FOR THE IDENTIFIED DISTRIBUTION SYSTEM ARE AS NOTED BELOW WHEN BRACINGS AND ATTACHMENTS ARE BASED ON A PRE-APPROVED INSTALLATION GUIDE (E.G. OSHPD OPM FOR 2018 CBC OR LATER). COPIES OF THE BRACING SYSTEM INSTALLATION GUIDE OR MANUAL SHALL BE AVAILABLE ON THE JOBSITE PRIOR TO THE START OF AND DURING THE HANGING AND BRACING OF THE DISTRIBUTION SYSTEM. THE STRUCTURAL ENGINEER OF RECORD SHALL VERIFY THE ADEQUACY OF THE STRUCTURE TO SUPPORT THE HANGER AND BRACE LOADS.

THE METHOD OF SHOWING BRACINGS AND ATTACHMENTS TO THE STRUCTURE FOR THE IDENTIFIED DISTRIBUTION SYSTEM ARE AS NOTED BELOW WHEN BRACINGS AND ATTACHMENTS ARE BASED ON A PRE-APPROVED INSTALLATION GUIDE (E.G. OSHPD OPM). COPIES OF THE BRACING SYSTEM INSTALLATION GUIDE OR MANUAL SHALL BE AVAILABLE ON THE JOBSITE PRIOR TO THE START OF AND DURING THE HANGING AND BRACING OF THE DISTRIBUTION SYSTEM. THE STRUCTURAL ENGINEER OF RECORD SHALL VERIFY THE ADEQUACY OF THE STRUCTURE TO SUPPORT THE HANGER AND BRACE LOADS.

MECHANICAL PIPING (MP), MECHANICAL DUCTS (MD), PLUMBING PIPING (PP), ELECTRICAL DISTRIBUTION SYSTEMS (E).

- MP □ MD □ PP □ E □ - OPTION 1: DETAILED ON THE APPROVED DRAWINGS WITH PROJECT SPECIFIC NOTES AND DETAILS.
- MP □ MD □ PP □ E □ - OPTION 2: SHALL COMPLY WITH THE APPLICABLE OSHPD PRE-APPROVED (OPM #) # _____

DRAWING INDEX

SHEET NO.	SHEET TITLE
E01	ELECTRICAL SYMBOLS, ABBREVIATIONS, NOTES AND SCHEDULES
E10	ELECTRICAL CAMPUS OVERALL SITE PLAN
E21	ENLARGED BASEBALL AND SOFTBALL FIELD - ELECTRICAL NEW SITE PLAN
E31	ELECTRICAL FLOOR PLAN - DISCOUTS (SOFTBALL)
E32	ELECTRICAL FLOOR PLAN - DISCOUTS (BASEBALL)
E33	ELECTRICAL PLAN - BATTING CAGE (BASEBALL AND SOFTBALL)
E51	ELECTRICAL SINGLE LINE DIAGRAM
E71	ELECTRICAL DETAILS
E74	ELECTRICAL DETAILS
E75	ELECTRICAL DETAILS

THE CONTRACTOR SHALL BE RESPONSIBLE FOR SITE LOCATING ALL EXISTING UNDERGROUND SYSTEMS IN AREA OF NEW TRENCHING. THE CONTRACTOR SHALL BE RESPONSIBLE FOR REPAIRING ALL DAMAGED SYSTEMS TO OWNERS SATISFACTION. EXTREME CARE SHALL BE MAINTAINED DURING TRENCHING AS EXISTING SYSTEMS ARE KNOWN TO EXIST IN AREA. MODIFICATIONS TO EXISTING SYSTEMS MAY BE REQUIRED TO ACCOMMODATE NEW SYSTEM CONFIGURATION AND SHALL BE MADE BY THE CONTRACTOR WITHOUT EXTRA EXPENSE TO THE OWNER. THE DRAWINGS AND SPECIFICATIONS ARE FOR THE ASSISTANCE AND GUIDANCE OF THE CONTRACTOR. EXACT LOCATIONS, DISTANCES AND ELEVATIONS WILL BE GOVERNED BY ACTUAL CONDITIONS. THE CONTRACTOR SHALL EXAMINE THE CONTRACT DOCUMENTS AND FIELD CONDITIONS TO DETERMINE EXACT ROUTING AND FINAL TERMINATIONS FOR ALL NEW WORK.

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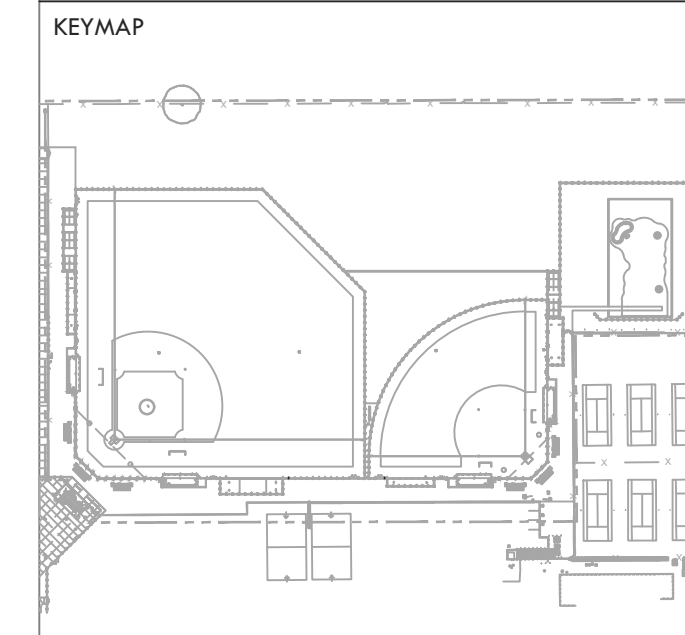
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ELECTRICAL SYMBOLS, ABBREVIATIONS, NOTES AND SCHEDULE

PROJECT NAME

HIRAM JOHNSON HIGH SCHOOL GOLF PRACTICE FACILITY, VARSITY BASEBALL AND SOFTBALL FIELDS

PROJECT ADDRESS

6879 14TH AVENUE SACRAMENTO, CA 95820

SUBMITTAL	DATE
DD 50% SUBMITTAL	04/15/22
100% DSA SUBMITTAL	05/27/22
DSA BACK CHECK	08/11/22
DSA ADDENDUM SUBMITTAL	09/16/22


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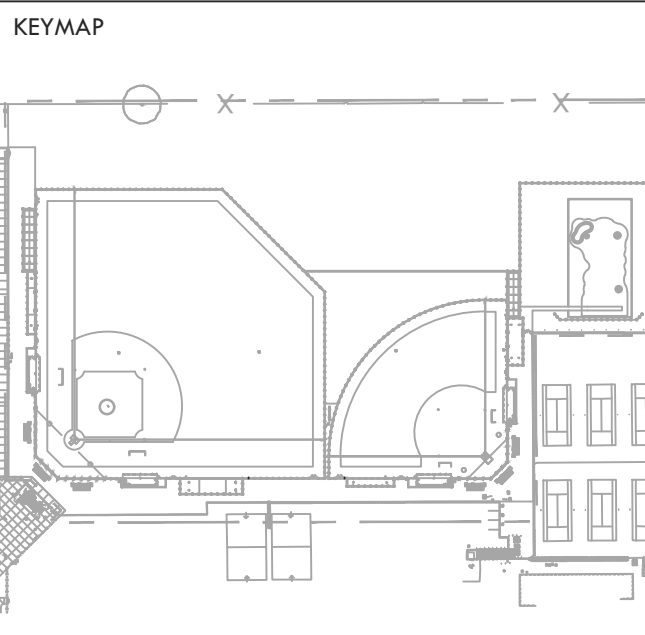
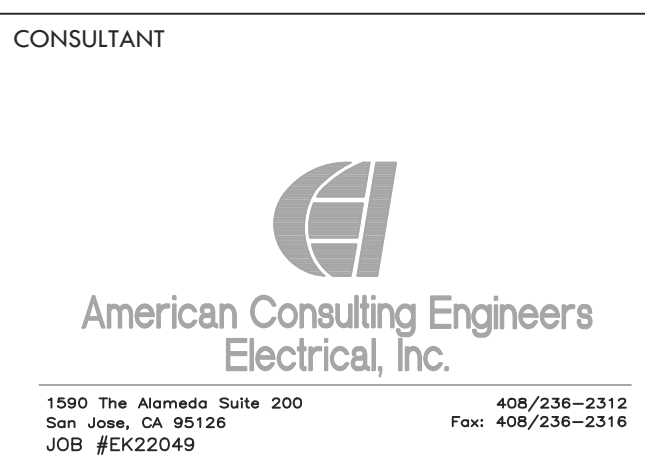
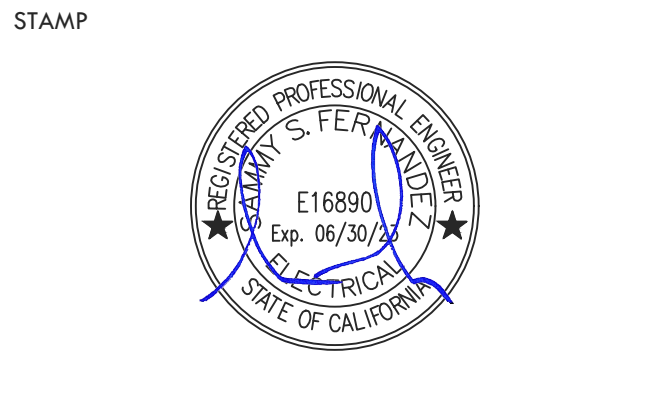


GENERAL NOTES:

- CONTRACTOR SHALL COORDINATE UNDERGROUND REQUIREMENTS WITH ALL OTHER TRADES TO AVOID CONFLICT.
- CONTRACTOR TO SITE SURVEY EXISTING CONDITIONS AND LOCATIONS OF EXISTING UNDERGROUND SYSTEMS, WHERE (N) TRENCHWORK OCCURS PRIOR TO BIDDING. CONTRACTOR SHALL TAKE PROPER PRECAUTIONS TO ENSURE (E) UNDERGROUND SYSTEMS/CONDUIT/PIPES ARE NOT DAMAGED DURING INSTALLATION. CONTRACTOR IS RESPONSIBLE FOR ANY REPAIRS REQUIRED IN THE EVENT THE (E) UNDERGROUND SYSTEMS ARE DAMAGED AS A RESULT OF THE (N) ELECTRICAL TRENCHWORK.
- SEE SINGLE LINE DIAGRAM FOR WIRE SIZES AND CONDUIT REQUIREMENTS.
- CONTRACTOR TO COORDINATE SITE PLAN TO COMBINE ALL UNDERGROUND CONDUIT IN COMMON TRENCH AS NECESSARY.
- ALL EMPTY CONDUIT SHALL BE PROVIDED WITH NYLON PULL CORD AS NOTED IN THE SPECIFICATIONS.
- ALL ELECTRICAL WORK SHALL BE INSTALLED PER 2014 CEC.
- PRIOR TO ALL (N) TRENCHES CONTRACTOR TO USA ALL (E) ELECTRICAL CONDUITS AND OTHER UTILITIES TO FAMILIARIZE THEMSELVES WITH THE FIELD CONDITIONS AND ADJUST (N) TRENCHES ACCORDINGLY.
- IN-GRADE PULL BOX IDENTIFIED WITH 'P' SHALL HAVE LID LABELED 'ELECTRICAL'.
- IN-GRADE PULL BOX IDENTIFIED WITH 'S' SHALL HAVE LID LABELED 'SIGNAL'.
- CONTRACTOR SHALL BE RESPONSIBLE FOR ANY SAW CUTTING AND REMOVAL OF EXISTING SURFACES TO FACILITATE UNDERGROUND SYSTEMS. THE CONTRACTOR SHALL PATCH AND REPAIR ALL DAMAGED AND CUT SURFACES TO MATCH ADJACENT.
- CONTRACTOR SHALL COORDINATE FINAL LOCATION OF ALL IN-GRADE PULL BOX WITH LANDSCAPE ARCHITECT. THE INTENT IS TO VOID RELOCATING PULL BOXES.
- ALL POWER SYSTEM CONDUITS STUB IN "ELECTRICAL" PULL BOX AND ALL COMMUNICATION SYSTEMS CONDUIT IN "SIGNAL" BOXES AS REQUIRED BY CODE.

CONDUIT SCHEDULE:

- POWER SYSTEMS**
- 1 (E) (6) 3"CO - SPARE
 - 2 (E) (4) 4"CO - SPARE
 - 3 (N) 4"CO - POWER
- COMMUNICATION SYSTEM**
- 11 (E) 2"CO - DATA
 - (E) (2) 2"CO - SPARE
 - 12 (N) 2"CO - DATA

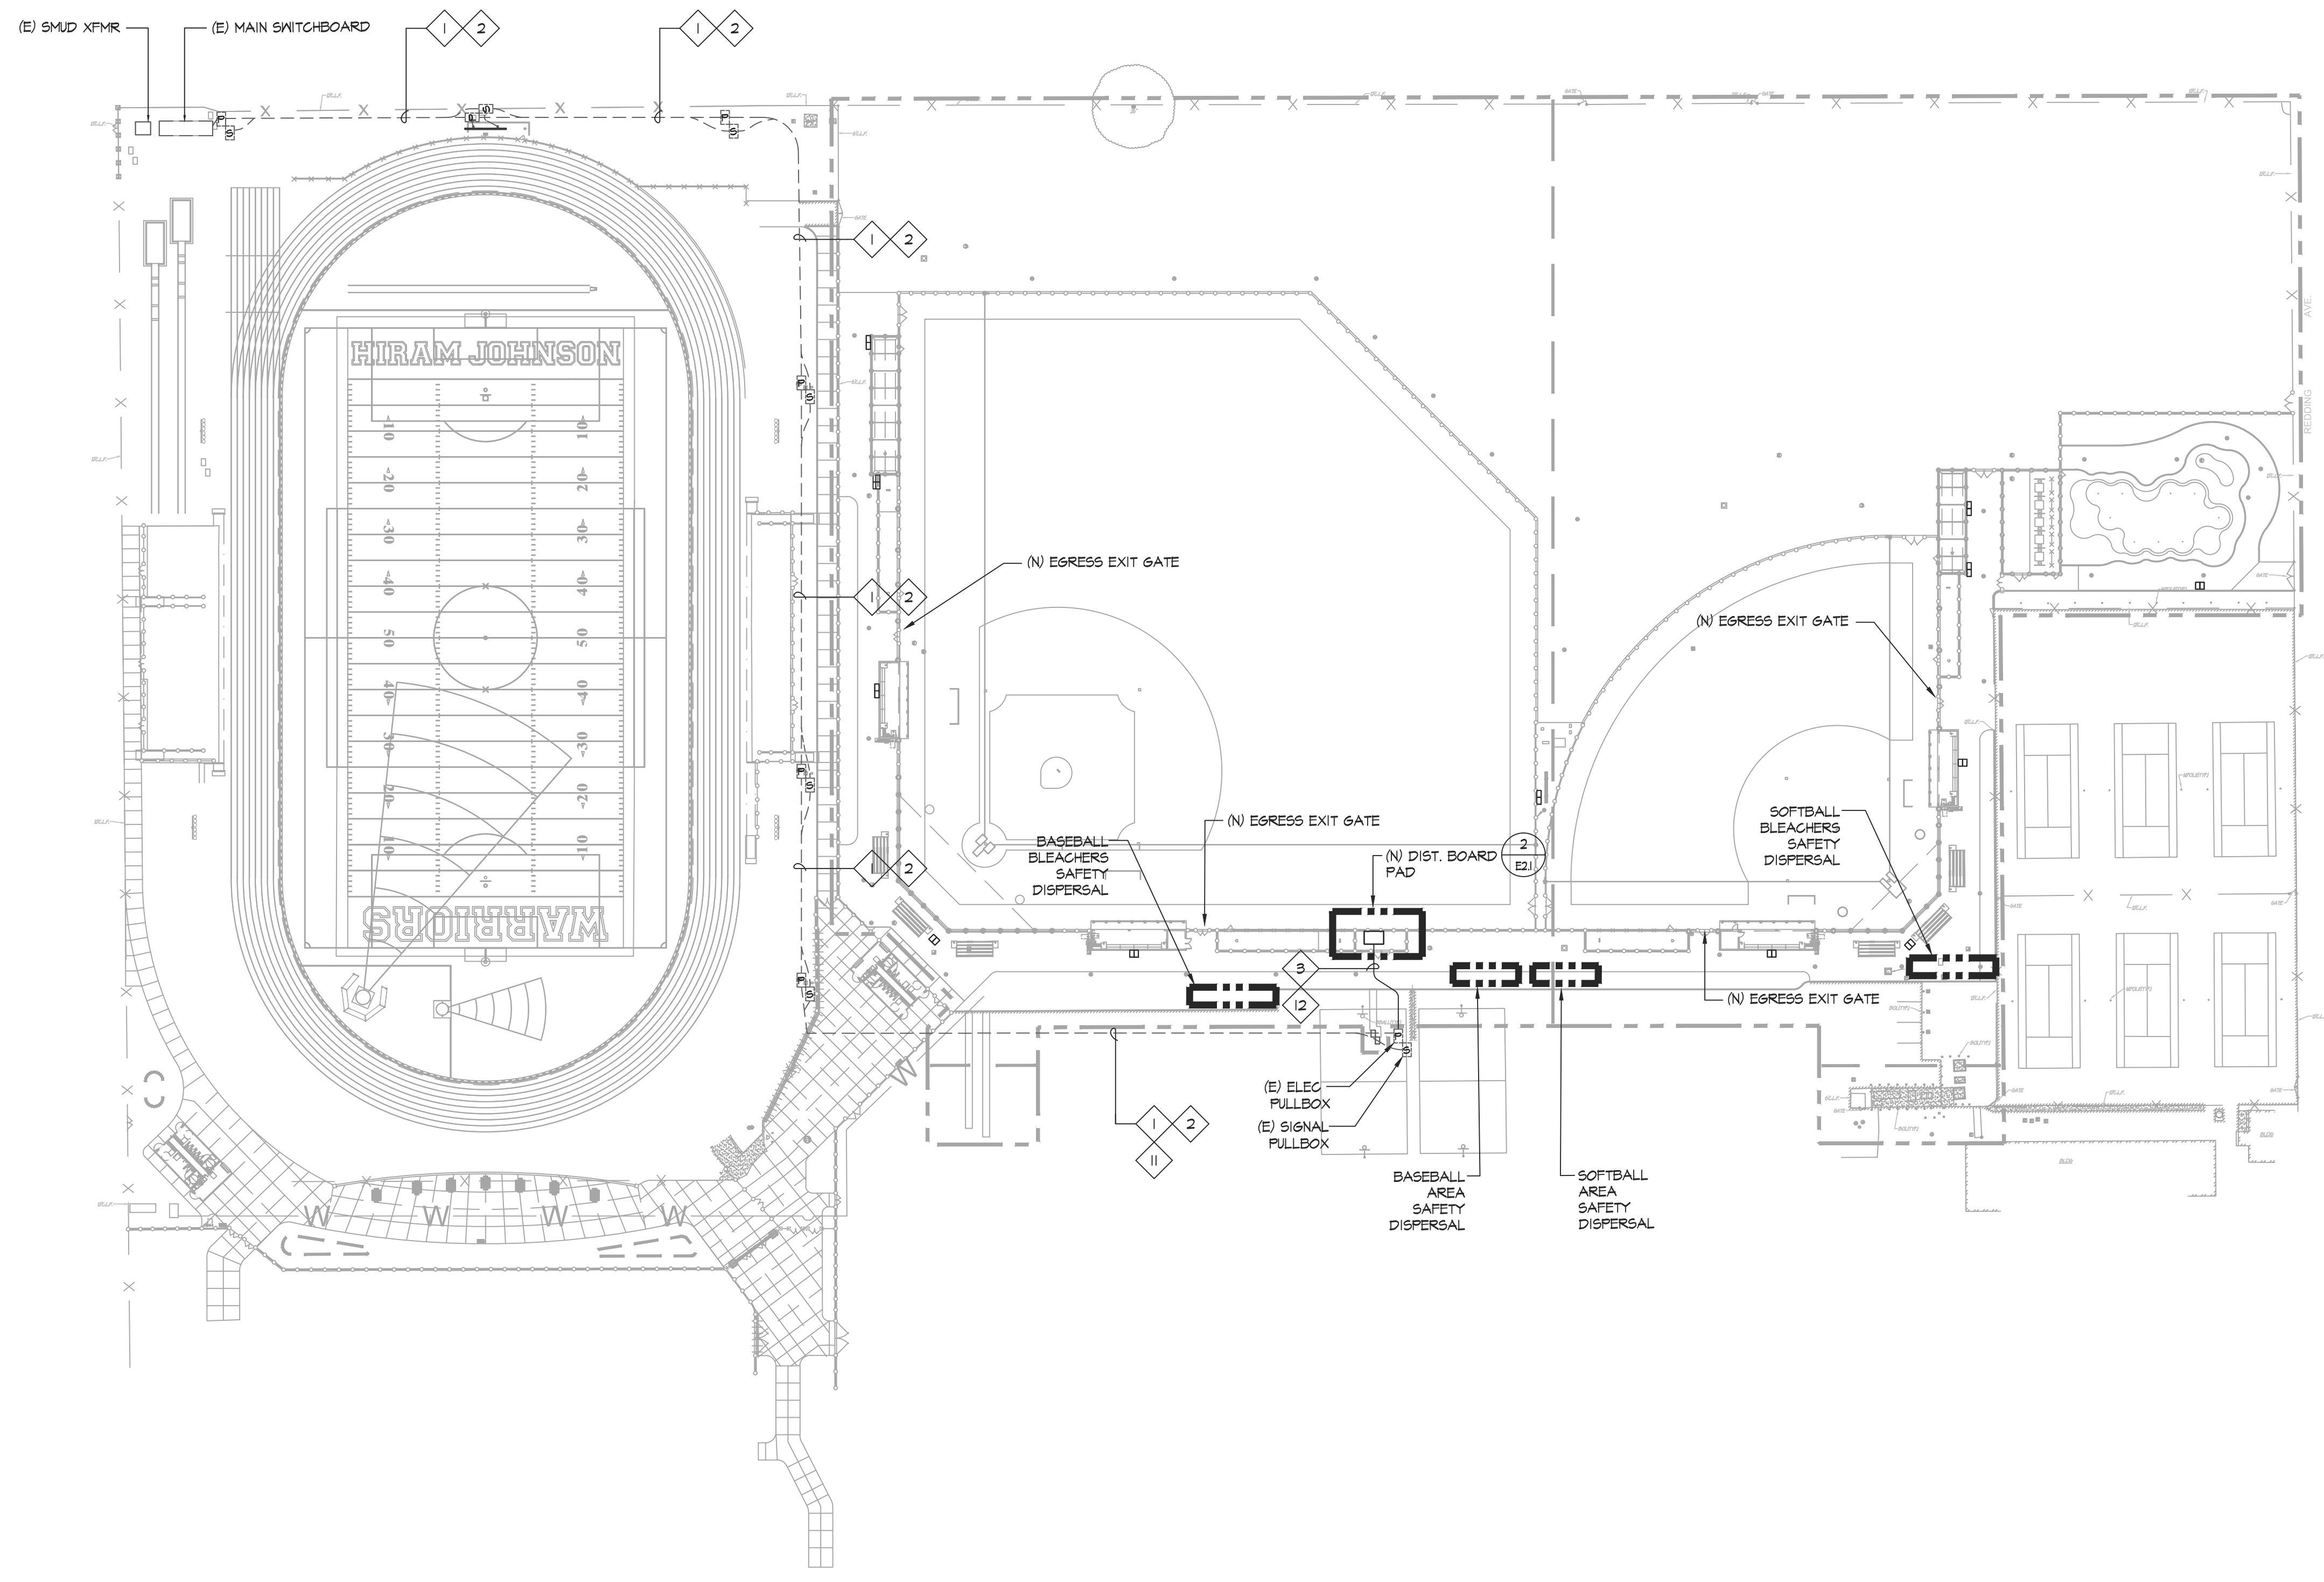

SHEET TITLE
**ELECTRICAL CAMPUS
OVERALL SITE PLAN**

PROJECT NAME
**HIRAM JOHNSON
HIGH SCHOOL
GOLF PRACTICE FACILITY,
VARSITY BASEBALL AND
SOFTBALL FIELDS**


PROJECT ADDRESS
**6879 14TH AVENUE
SACRAMENTO, CA 95820**

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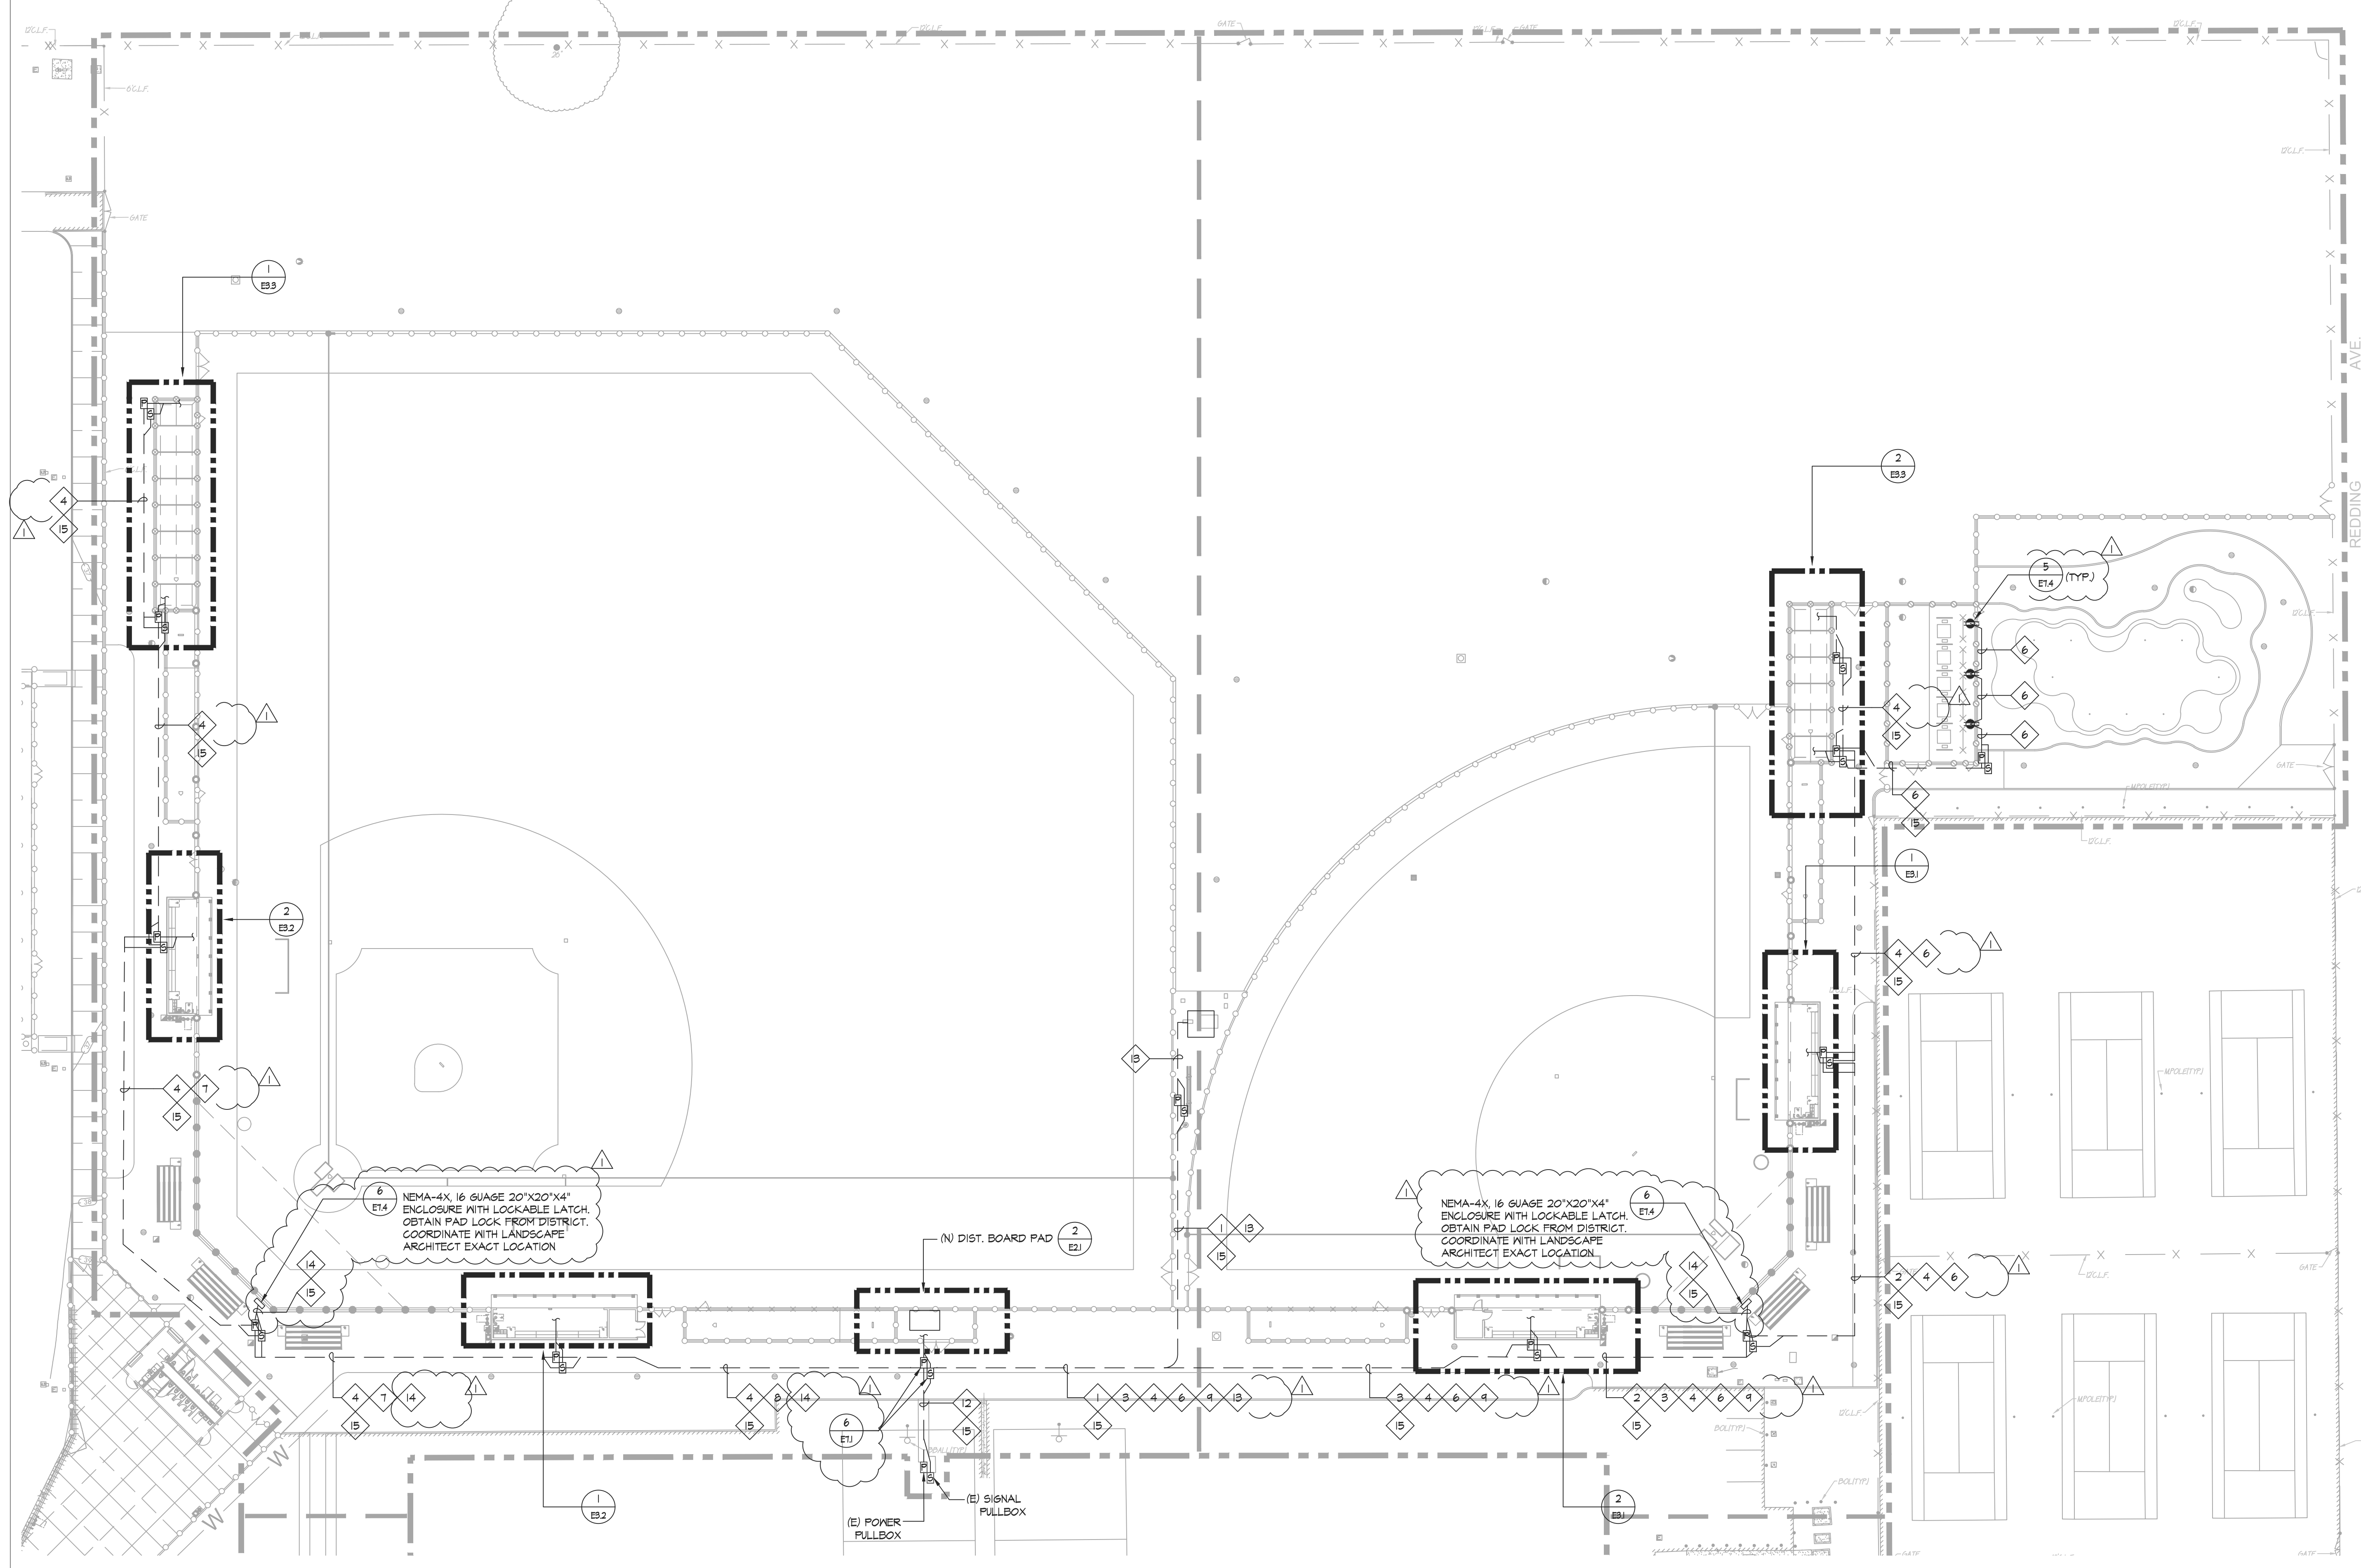
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SHEET NO. E1.0	OF

1
E1.0 SCALE: 1" = 60'-0"



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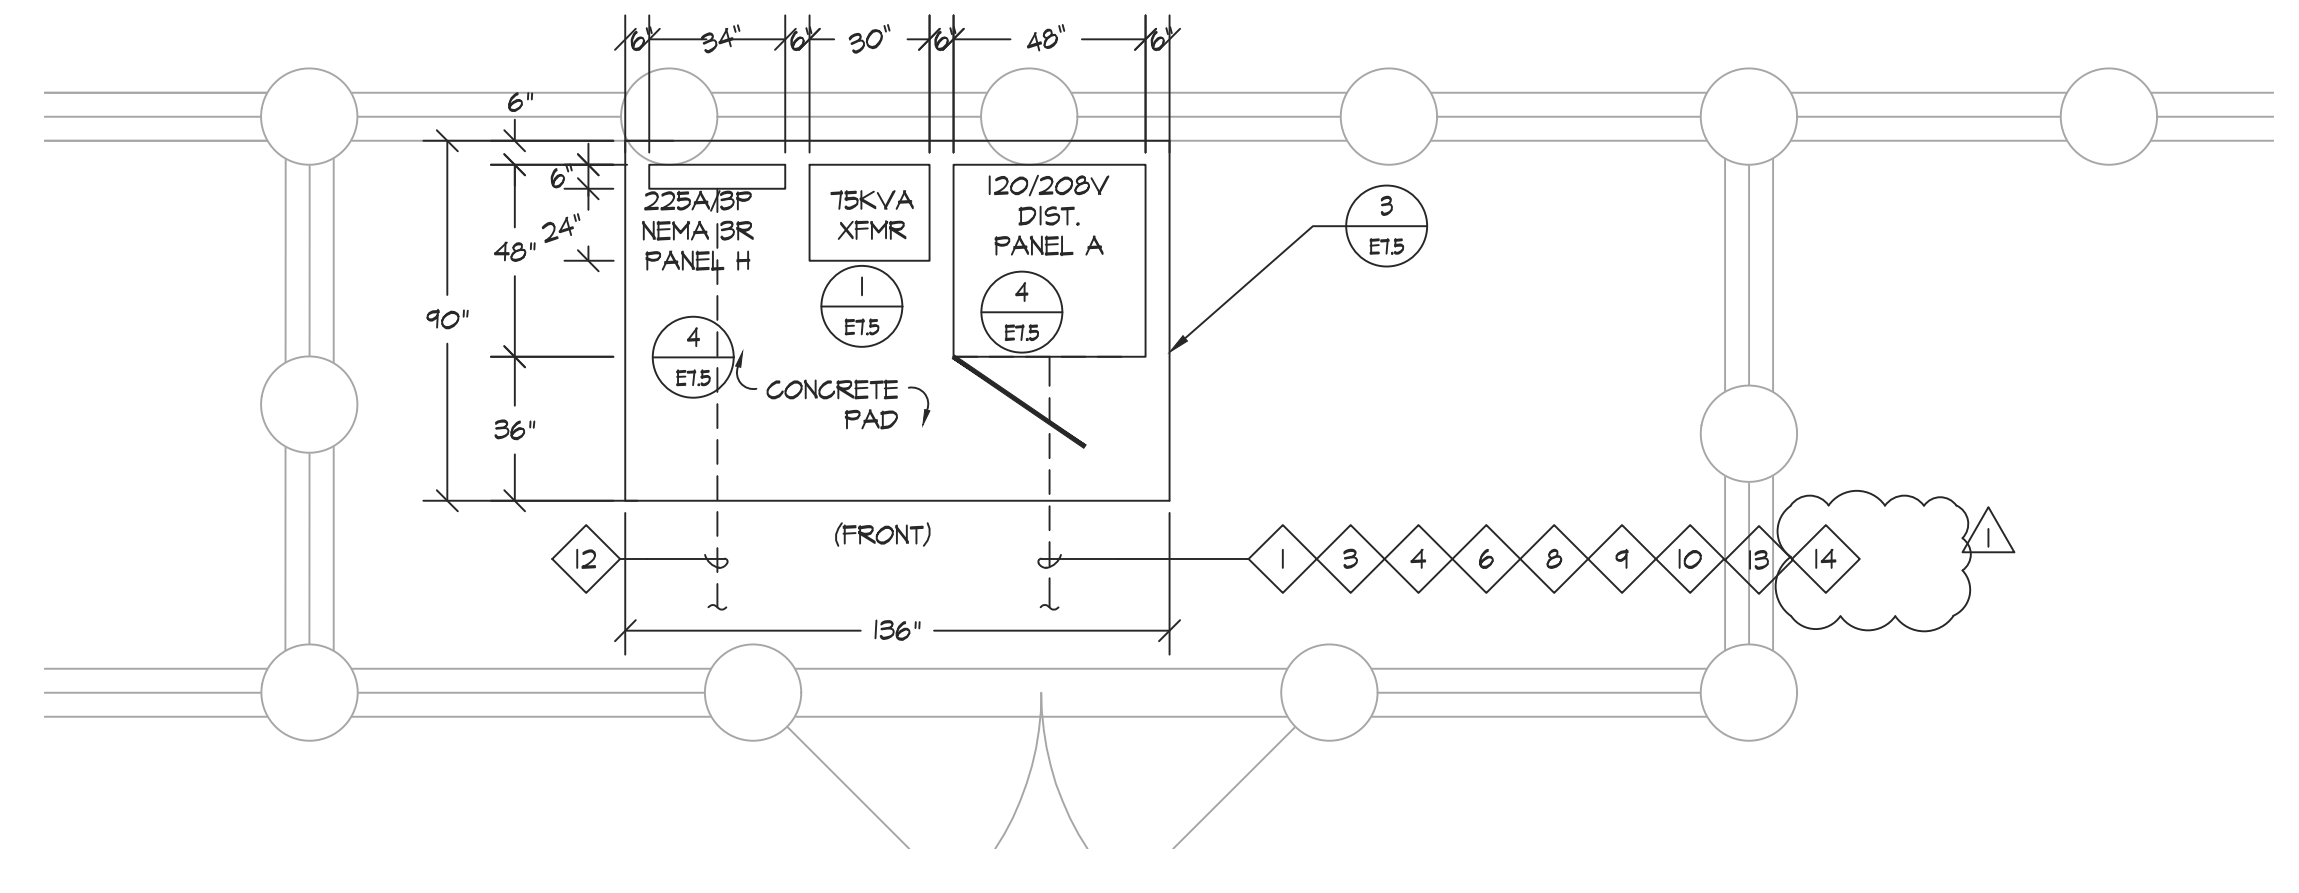
GENERAL NOTES:

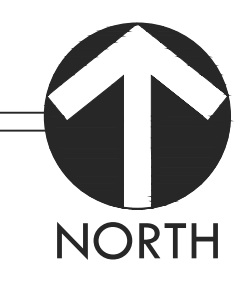- CONTRACTOR SHALL COORDINATE UNDERGROUND REQUIREMENTS WITH ALL OTHER TRADES TO AVOID CONFLICT.
- CONTRACTOR TO SITE SURVEY EXISTING CONDITIONS AND LOCATIONS OF EXISTING UNDERGROUND SYSTEMS. WHERE (N) TRENCHWORK OCCURS PRIOR TO BIDDING, CONTRACTOR SHALL TAKE PROPER PRECAUTIONS TO ENSURE (E) UNDERGROUND SYSTEMS/CONDUITS/PIPES ARE NOT DAMAGED DURING INSTALLATION. CONTRACTOR IS RESPONSIBLE FOR ANY REPAIRS REQUIRED IN THE EVENT THE (E) UNDERGROUND SYSTEMS ARE DAMAGED AS A RESULT OF THE (N) ELECTRICAL TRENCHWORK.
- SEE SINGLE LINE DIAGRAM FOR WIRE SIZES AND CONDUIT REQUIREMENTS.
- CONTRACTOR TO COORDINATE SITE PLAN TO COMBINE ALL UNDERGROUND CONDUIT IN COMMON TRENCH AS NECESSARY.
- ALL EMPTY CONDUIT SHALL BE PROVIDED WITH NYLON PULL CORD AS NOTED IN THE SPECIFICATIONS.
- ALL ELECTRICAL WORK SHALL BE INSTALLED PER 2019 CEC.
- PRIOR TO ALL (N) TRENCHES, CONTRACTOR TO USE ALL (E) ELECTRICAL CONDUITS AND OTHER UTILITIES TO FAMILIARIZE THEMSELVES WITH THE FIELD CONDITIONS AND ADJUST (N) TRENCHES ACCORDINGLY.
- IN-GRADE PULL BOX IDENTIFIED WITH 'P' SHALL HAVE LID LABELED 'ELECTRICAL'.
- IN-GRADE PULL BOX IDENTIFIED WITH 'S' SHALL HAVE LID LABELED 'SIGNAL'.
- CONTRACTOR SHALL BE RESPONSIBLE FOR ANY SAW CUTTING AND REMOVAL OF EXISTING SURFACES TO FACILITATE UNDERGROUND SYSTEMS. THE CONTRACTOR SHALL PATCH AND REPAIR ALL DAMAGED AND CUT SURFACES TO MATCH ADJACENT.
- CONTRACTOR SHALL COORDINATE FINAL LOCATION OF ALL IN-GRADE PULL BOX WITH LANDSCAPE ARCHITECT. THE INTENT IS TO VOID RELOCATING PULL BOXES.
- ALL POWER SYSTEM CONDUITS STUB IN 'ELECTRICAL' PULL BOX AND ALL COMMUNICATION SYSTEMS CONDUIT IN 'SIGNAL' BOXES AS REQUIRED BY CODE.
- ALL PULL BOXES SHALL BE TRAFFIC RATED B2486 UNLESS OTHERWISE NOTED. SEE DETAIL FOR SPECIFICS.
- COORDINATE PULL BOX ORIENTATION WITH LANDSCAPE ARCHITECT TO BE SQUARE WITH SURFACE CURB, CONCRETE WALKWAY, DRAINAGE, ETC.
- IN-GRADE PULL BOX IDENTIFIED WITH 'L' SHALL HAVE LID LABELED 'LIGHTING'.

CONDUIT SCHEDULE:

POWER SYSTEMS	
1	(N) (2) 2" C - POWER - SCOREBOARD
2	(N) 2" C - POWER - SOFTBALL DUSOUT
3	(N) (2) 2" C - POWER - SOFTBALL DUSOUT
4	(N) 2" C - POWER - BATTING CAGE
5	NOT USED
6	(N) 2" C - POWER - GOLF AREA
7	(N) 2" C - POWER - BASEBALL DUSOUT
8	(N) (2) 2" C - POWER - BASEBALL DUSOUT
9	(N) 2" C - POWER - SOFTBALL BACKSTOP
10	(N) (2) 2" C - POWER - BATTING CAGE
11	NOT USED
12	(N) 4" C - POWER
13	(N) 2" C - IRRIGATION PUMP
14	(N) 2" C - BASEBALL BACKSTOP
COMMUNICATION SYSTEMS	
15	(N) 2" C - SIGNAL

1 ENLARGED BASEBALL AND SOFTBALL FIELD - ELECTRICAL NEW SITE PLAN
E2.1 SCALE: 1" = 30'-0"




2 DISTRIBUTION PANEL CONDUIT ROUTING
E2.1 SCALE: 1/4" = 1' - 0"

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1590 The Ardenia Suite 200 San Jose, CA 95128 408/236-2312
JOB #022049



ENLARGED BASEBALL AND SOFTBALL FIELD ELECTRICAL NEW SITE PLAN

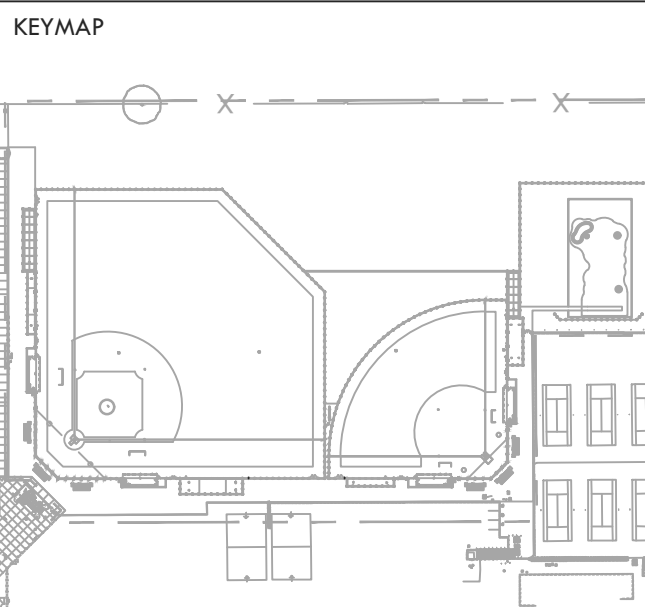PROJECT NAME
**HIRAM JOHNSON
HIGH SCHOOL
GOLF PRACTICE FACILITY,
VARSITY BASEBALL AND
SOFTBALL FIELDS**

PROJECT ADDRESS
**6879 14TH AVENUE
SACRAMENTO, CA 95820**


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100% DSA SUBMITTAL	05/27/22
DSA BACK CHECK	08/11/22
DSA ADDENDUM SUBMITTAL	09/16/22

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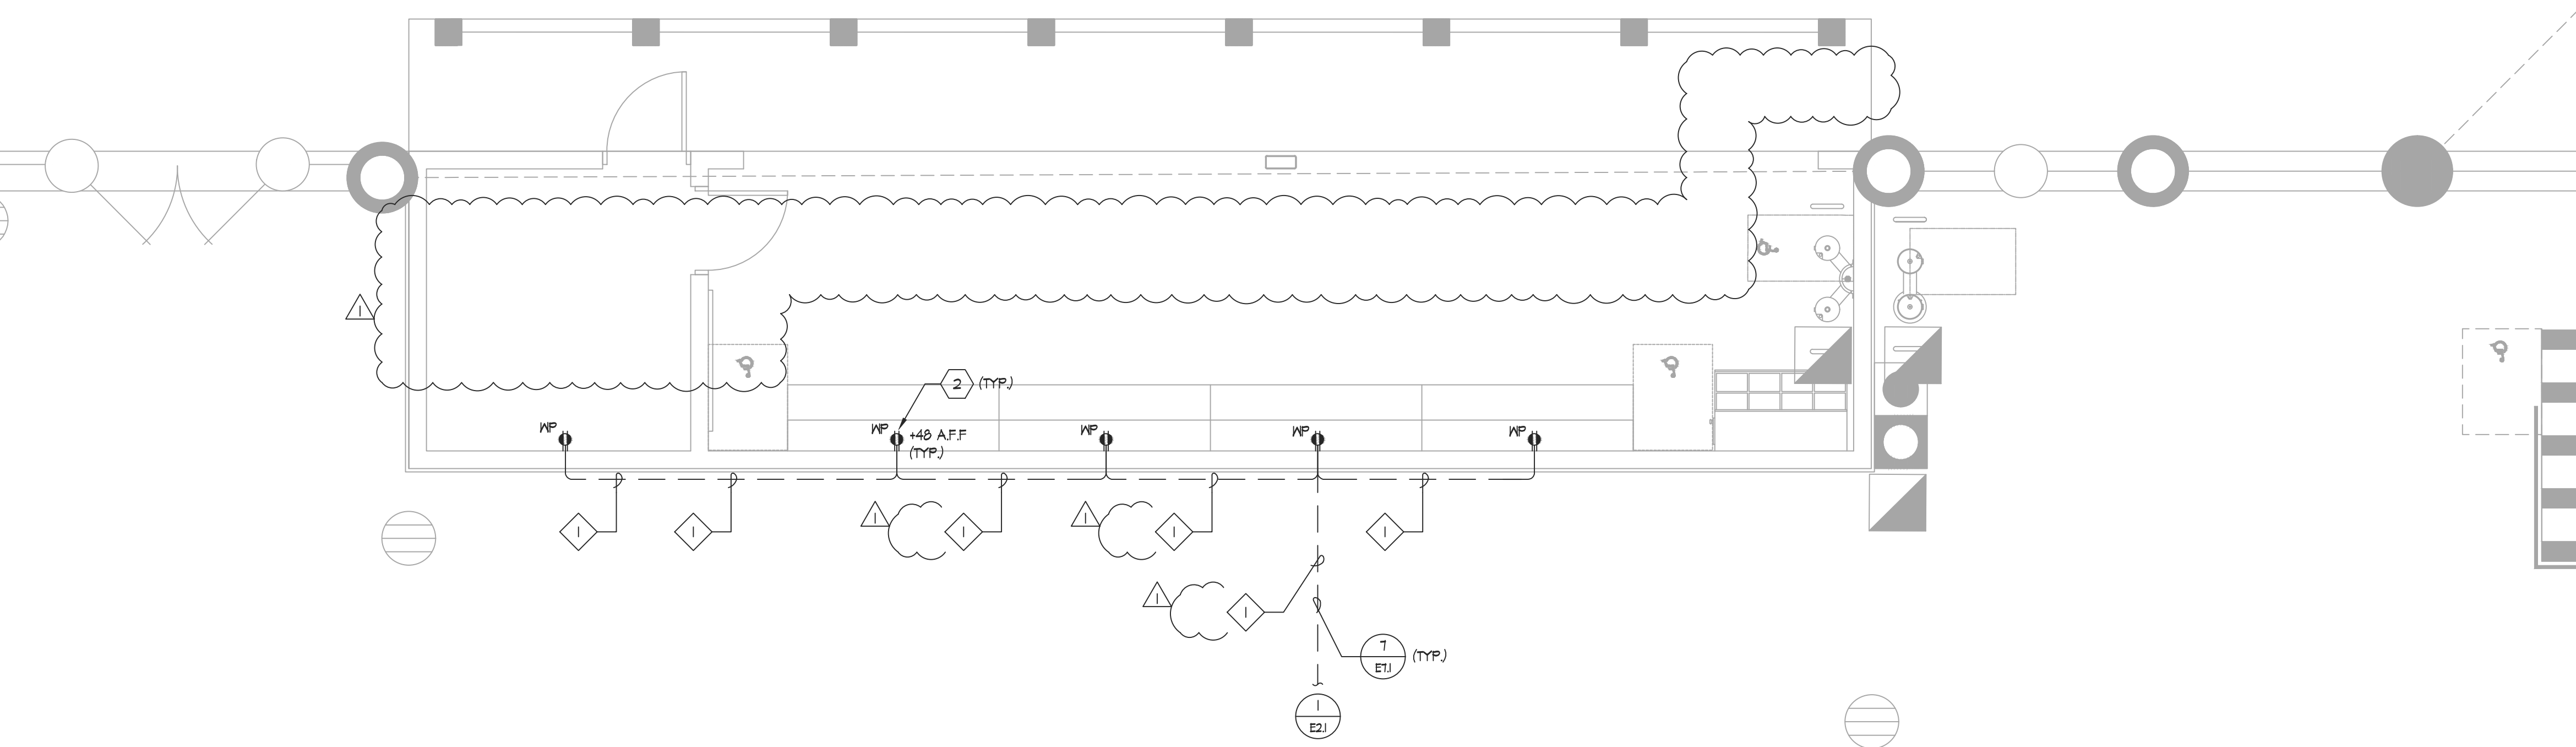


1 ELECTRICAL FLOOR PLAN - FIRST BASE DUGOUT (SOFTBALL)
 E3.1 SCALE: 1/4" = 1'-0"

- GENERAL NOTES:**
- CONTRACTOR SHALL COORDINATE UNDERGROUND REQUIREMENTS WITH ALL OTHER TRADES TO AVOID CONFLICT.
 - CONTRACTOR TO SITE SURVEY EXISTING CONDITIONS AND LOCATIONS OF EXISTING UNDERGROUND SYSTEMS, WHERE (N) TRENCHWORK OCCURS PRIOR TO BIDDING. CONTRACTOR SHALL TAKE PROPER PRECAUTIONS TO ENSURE (E) UNDERGROUND SYSTEMS/CONDUIT/PIPES ARE NOT DAMAGED DURING INSTALLATION. CONTRACTOR IS RESPONSIBLE FOR ANY REPAIRS REQUIRED IN THE EVENT THE (E) UNDERGROUND SYSTEMS ARE DAMAGED AS A RESULT OF THE (N) ELECTRICAL TRENCHWORK.
 - LIGHTING AND RECEPTACLE CONDUIT SHALL BE IN SAME TRENCH.
 - SEE SINGLE LINE DIAGRAM FOR WIRE SIZES AND CONDUIT REQUIREMENTS.
 - CONTRACTOR TO COORDINATE SITE PLAN TO COMBINE ALL UNDERGROUND CONDUIT IN COMMON TRENCH AS NECESSARY.
 - ALL EMPTY CONDUIT SHALL BE PROVIDED WITH NYLON FILL CORD AS NOTED IN THE SPECIFICATIONS.
 - SEE DETAIL (VET) AND (TET) FOR TRENCHING REQUIREMENTS.
 - CONTRACTOR TO PROVIDE ALL MATERIALS, EQUIPMENT, SPORT FIELD LIGHTS, CONTROL CABINETS, WIRING, CONDUITS, ETC TO SUCCESSFULLY INSTALL NEW SPORTFIELD LIGHTING.
 - ALL ELECTRICAL WORK SHALL BE INSTALLED PER 2019 CEC.
 - ALL CONDUITS FOR OUTLETS AND DATA SHALL BE CONCEALED IN WALL. CONTRACTOR SHALL BE RESPONSIBLE TO COORDINATE WITH DUGOUT CONTRACTOR IN ADVANCE TO ENSURE THEY ARE AWARE OF CONDUITS TO BE CONCEALED IN CMU WALL.

- SHEET NOTES:**
- NOT USED.
 - PROVIDE AND INSTALL WEATHERPROOF (GFCI) EXTERIOR OUTLET FOR DUGOUT. OUTLET SHALL BE PROVIDED WITH RAIN-TIGHT "WHILE-IN-USE" LOCKABLE COVER PER CEC REQUIREMENTS. OUTLET SHALL BE INSTALLED FLUSH IN CMU WALL. CONTRACTOR SHALL COORDINATE EXACT LOCATION WITH ARCHITECT.
 - NOT USED.

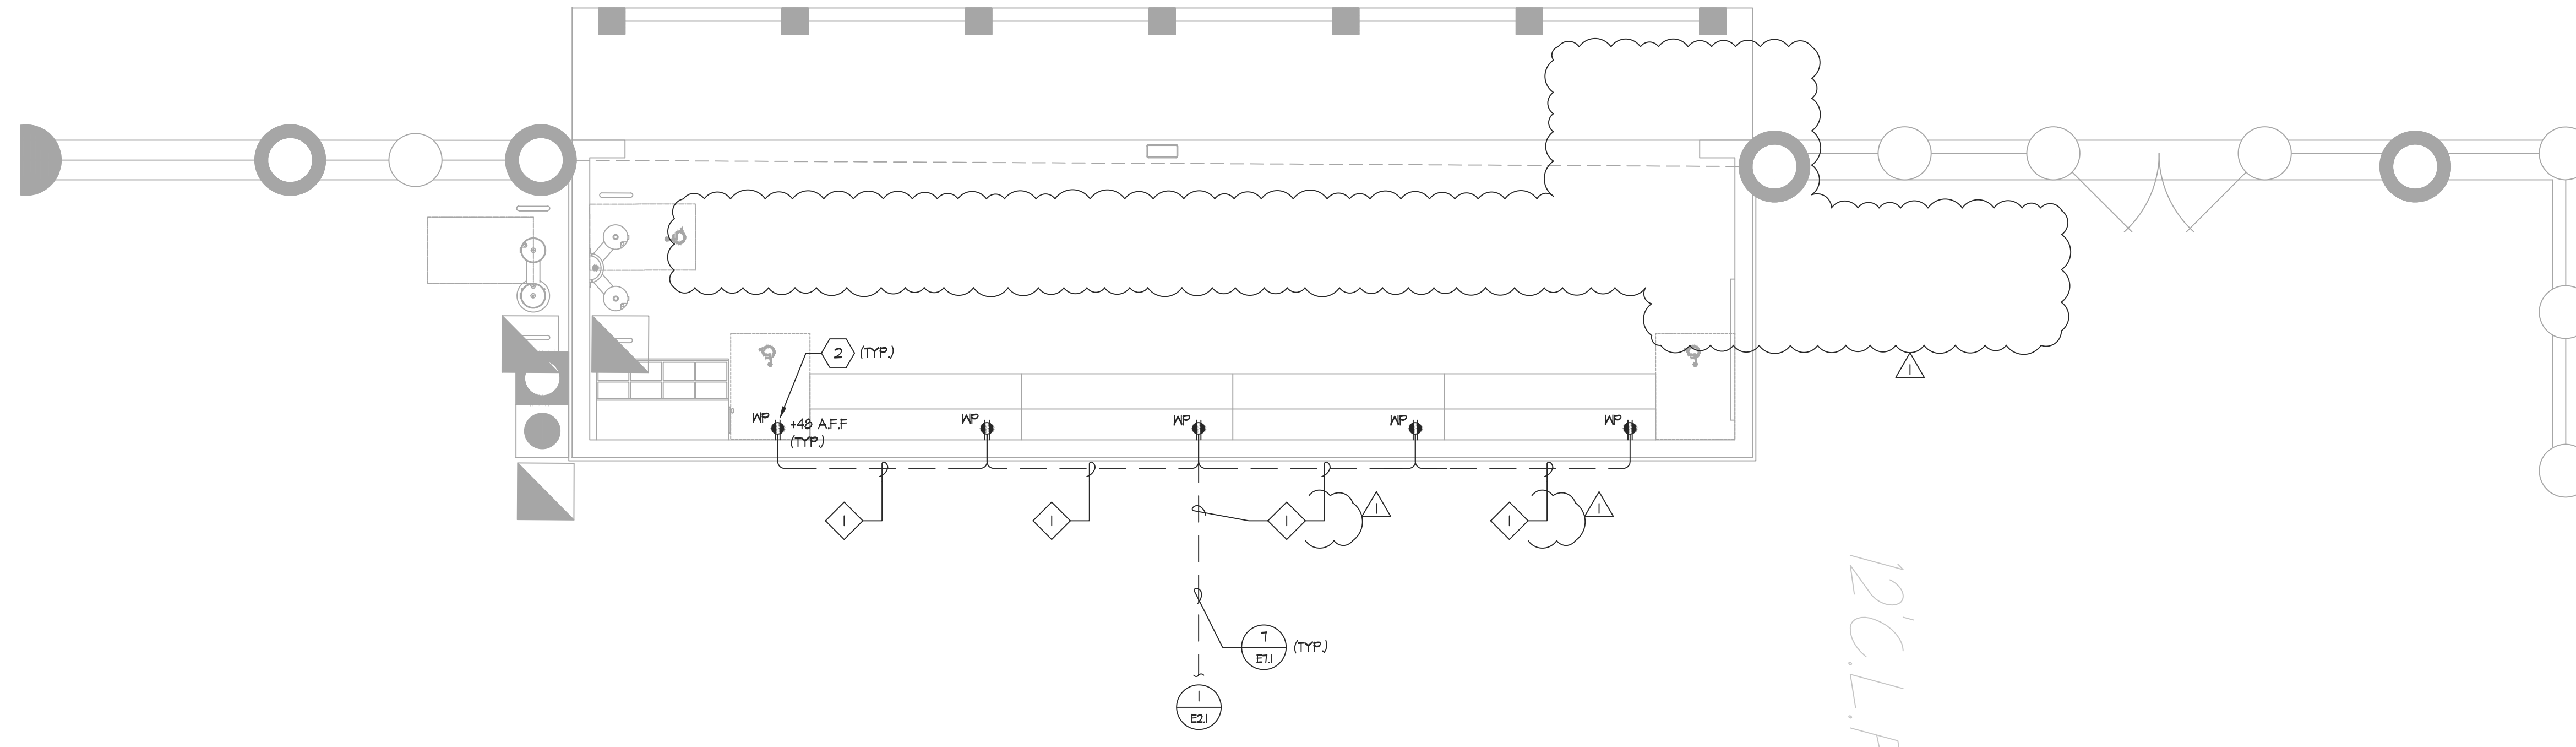- CONDUIT SCHEDULE:**
- (N) 1 1/2" - RECEPTACLE
 - NOT USED




2 ELECTRICAL FLOOR PLAN - THIRD BASE DUGOUT (SOFTBALL)
 E3.1 SCALE: 1/4" = 1'-0"



CONSULTANT

 American Consulting Engineers
 Electrical, Inc.
 1550 The Armada, Suite 200 San Jose, CA 95128 408/236-2312
 JOB #022049 Fax: 408/236-2316

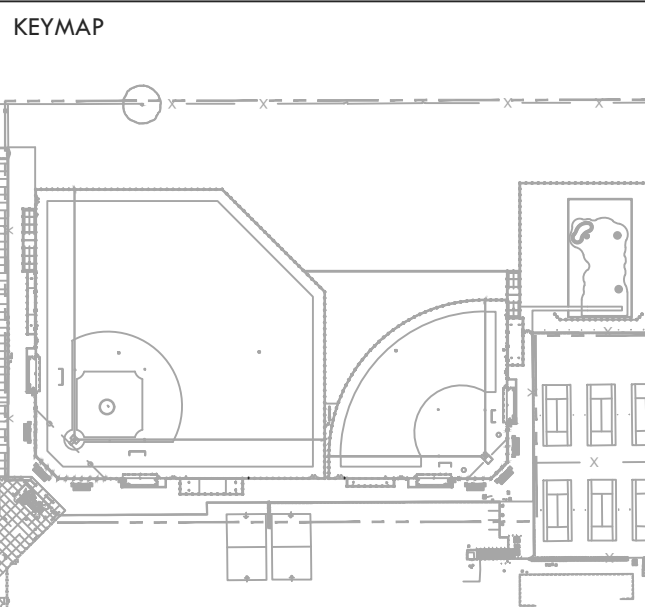

SHEET TITLE
 ELECTRICAL FLOOR PLAN - DUGOUTS (SOFTBALL)

PROJECT NAME
 HIRAM JOHNSON
 HIGH SCHOOL
 GOLF PRACTICE FACILITY,
 VARSITY BASEBALL AND
 SOFTBALL FIELDS


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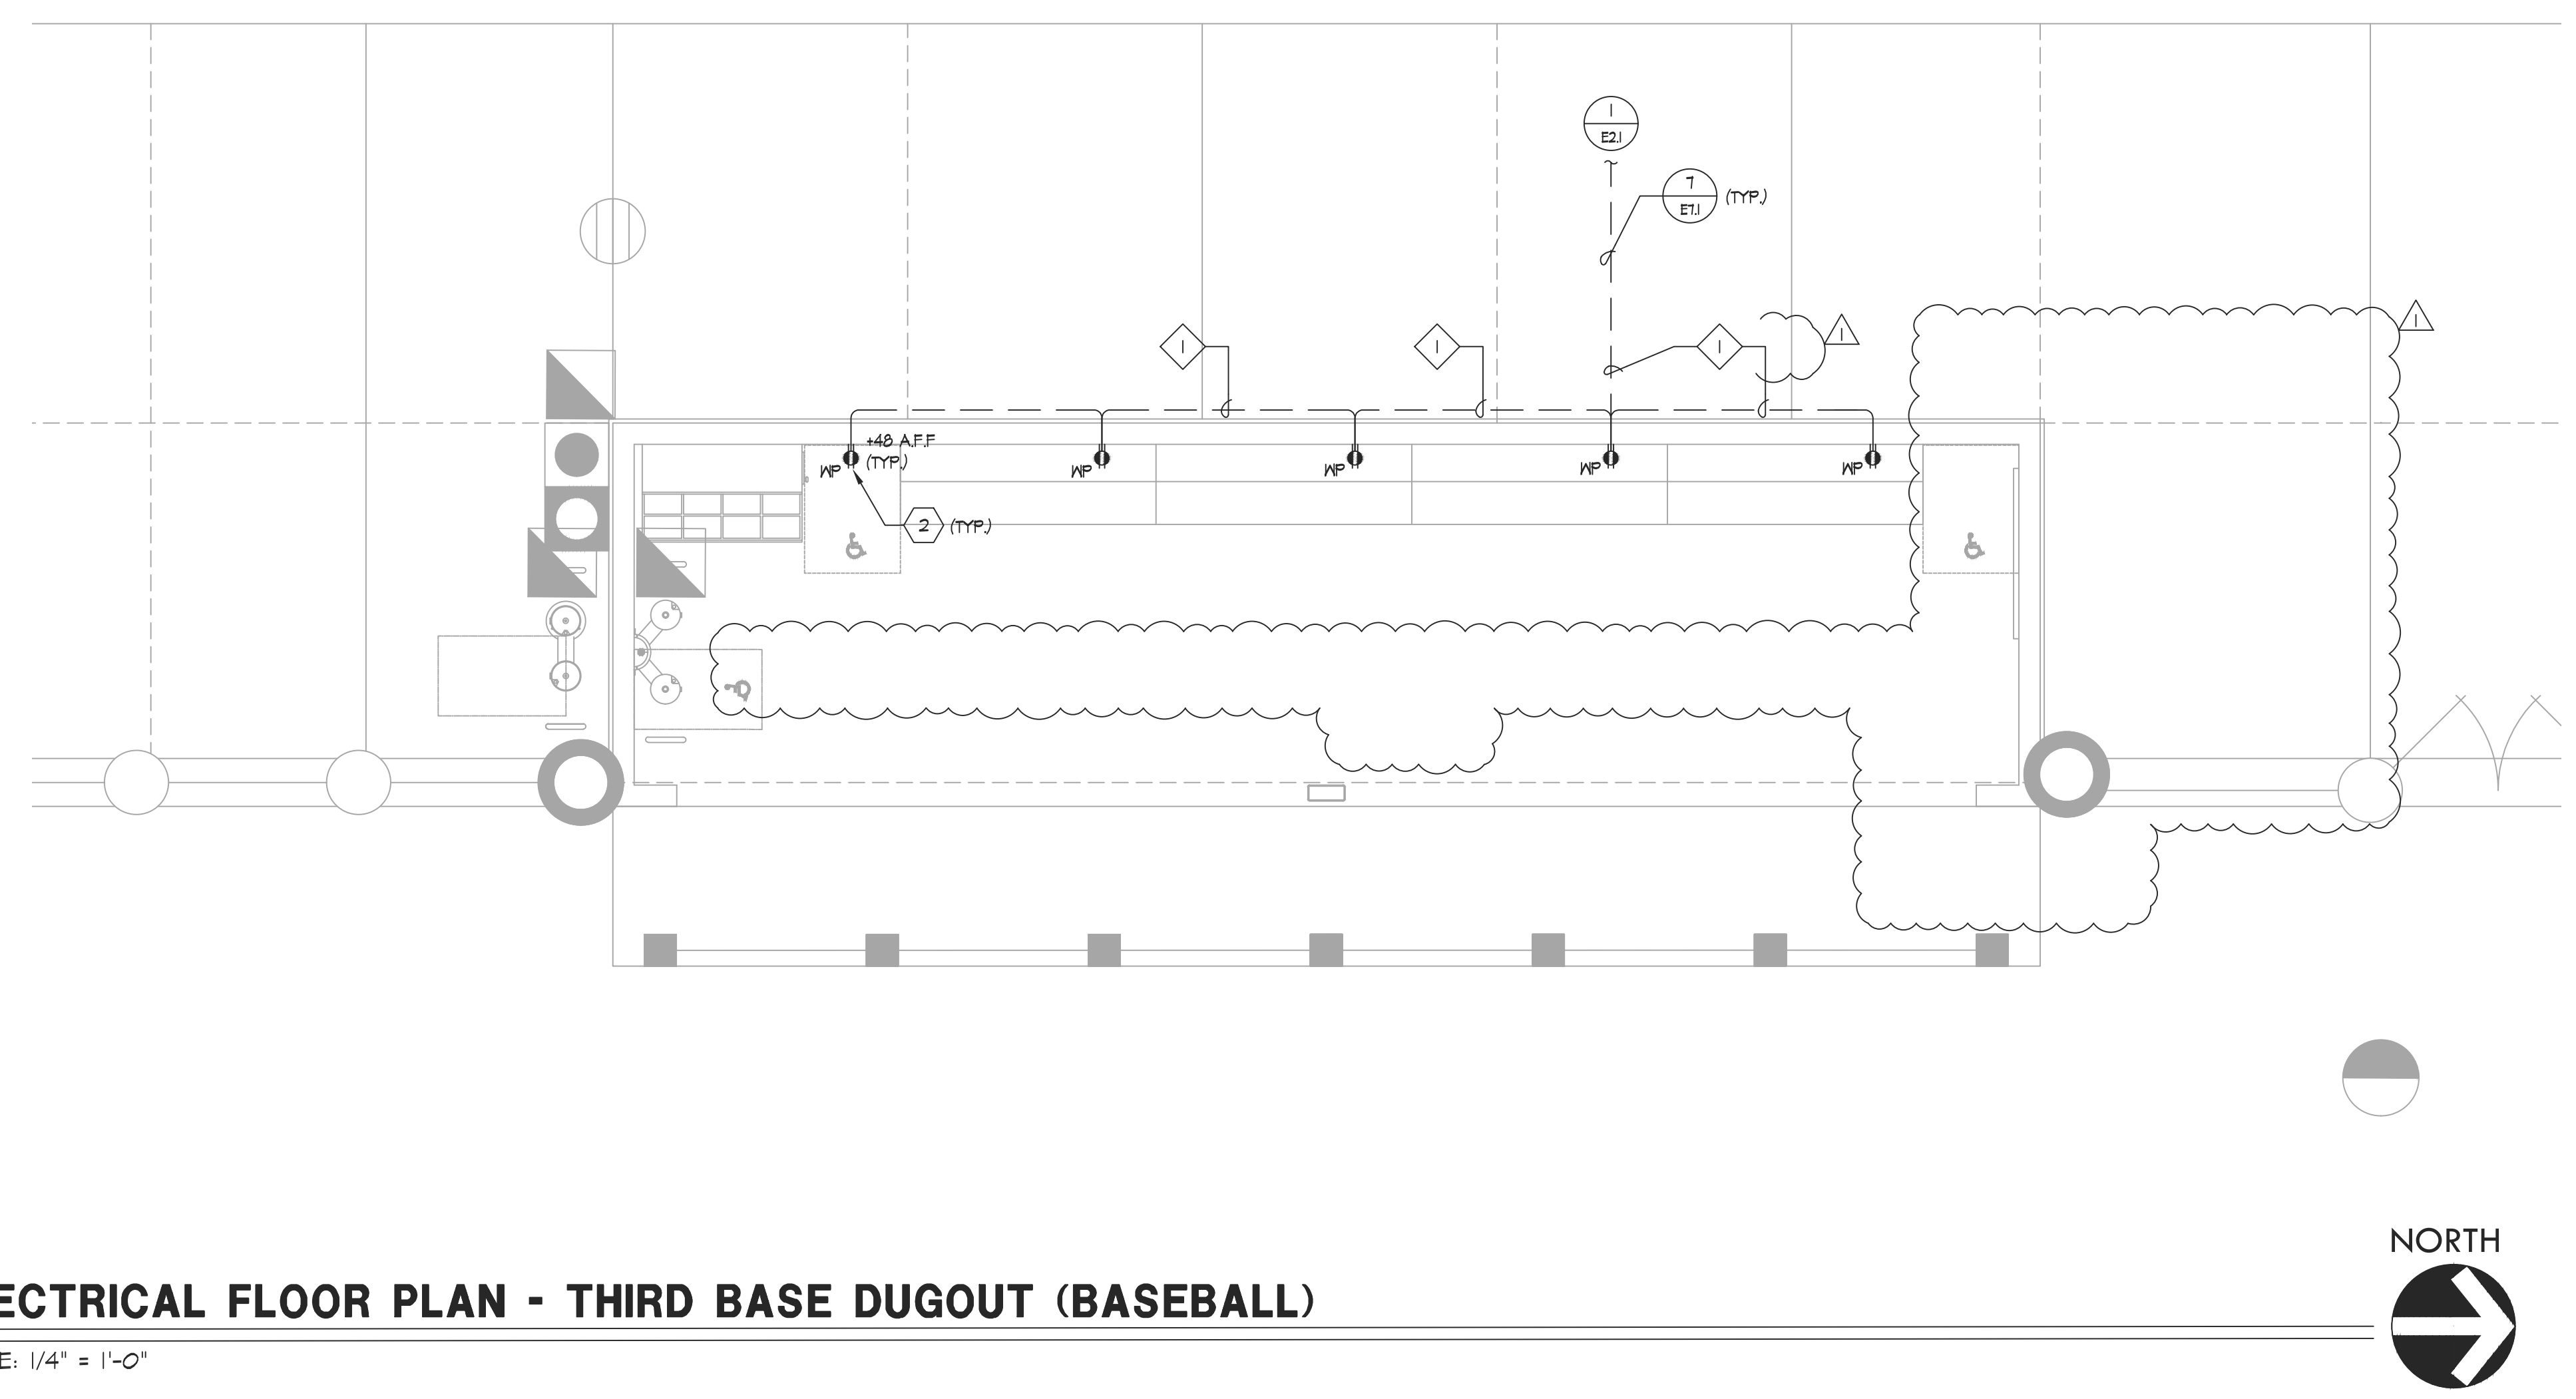
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1 ELECTRICAL FLOOR PLAN - FIRST BASE DUGOUT (BASEBALL)
 E3.2 SCALE: 1/4" = 1'-0"



2 ELECTRICAL FLOOR PLAN - THIRD BASE DUGOUT (BASEBALL)
 E3.2 SCALE: 1/4" = 1'-0"

GENERAL NOTES:

- CONTRACTOR SHALL COORDINATE UNDERGROUND REQUIREMENTS WITH ALL OTHER TRADES TO AVOID CONFLICT.
- CONTRACTOR TO SITE SURVEY EXISTING CONDITIONS AND LOCATIONS OF EXISTING UNDERGROUND SYSTEMS, WHERE (N) TRENCHWORK OCCURS PRIOR TO BIDDING. CONTRACTOR SHALL TAKE PROPER PRECAUTIONS TO ENSURE (E) UNDERGROUND SYSTEMS/CONDUIT/PIPES ARE NOT DAMAGED DURING INSTALLATION. CONTRACTOR IS RESPONSIBLE FOR ANY REPAIRS REQUIRED IN THE EVENT THE (E) UNDERGROUND SYSTEMS ARE DAMAGED AS A RESULT OF THE (N) ELECTRICAL TRENCHWORK.
- LIGHTING AND RECEPTACLE CONDUIT SHALL BE IN SAME TRENCH.
- SEE SINGLE LINE DIAGRAM FOR WIRE SIZES AND CONDUIT REQUIREMENTS.
- CONTRACTOR TO COORDINATE SITE PLAN TO COMBINE ALL UNDERGROUND CONDUIT IN COMMON TRENCH AS NECESSARY.
- ALL EMPTY CONDUIT SHALL BE PROVIDED WITH NYLON FULL CORD AS NOTED IN THE SPECIFICATIONS.
- SEE DETAIL (VET) AND (TET) FOR TRENCHING REQUIREMENTS.
- CONTRACTOR TO PROVIDE ALL MATERIALS, EQUIPMENT, SPORT FIELD LIGHTS, CONTROL CABINETS, WIRING, CONDUITS, ETC TO SUCCESSFULLY INSTALL NEW SPORTFIELD LIGHTING.
- ALL ELECTRICAL WORK SHALL BE INSTALLED PER 2019 CEC.
- ALL CONDUITS FOR OUTLETS AND DATA SHALL BE CONCEALED IN WALL. CONTRACTOR SHALL BE RESPONSIBLE TO COORDINATE WITH DUGOUT CONTRACTOR IN ADVANCE TO ENSURE THEY ARE AWARE OF CONDUITS TO BE CONCEALED IN CMU WALL.

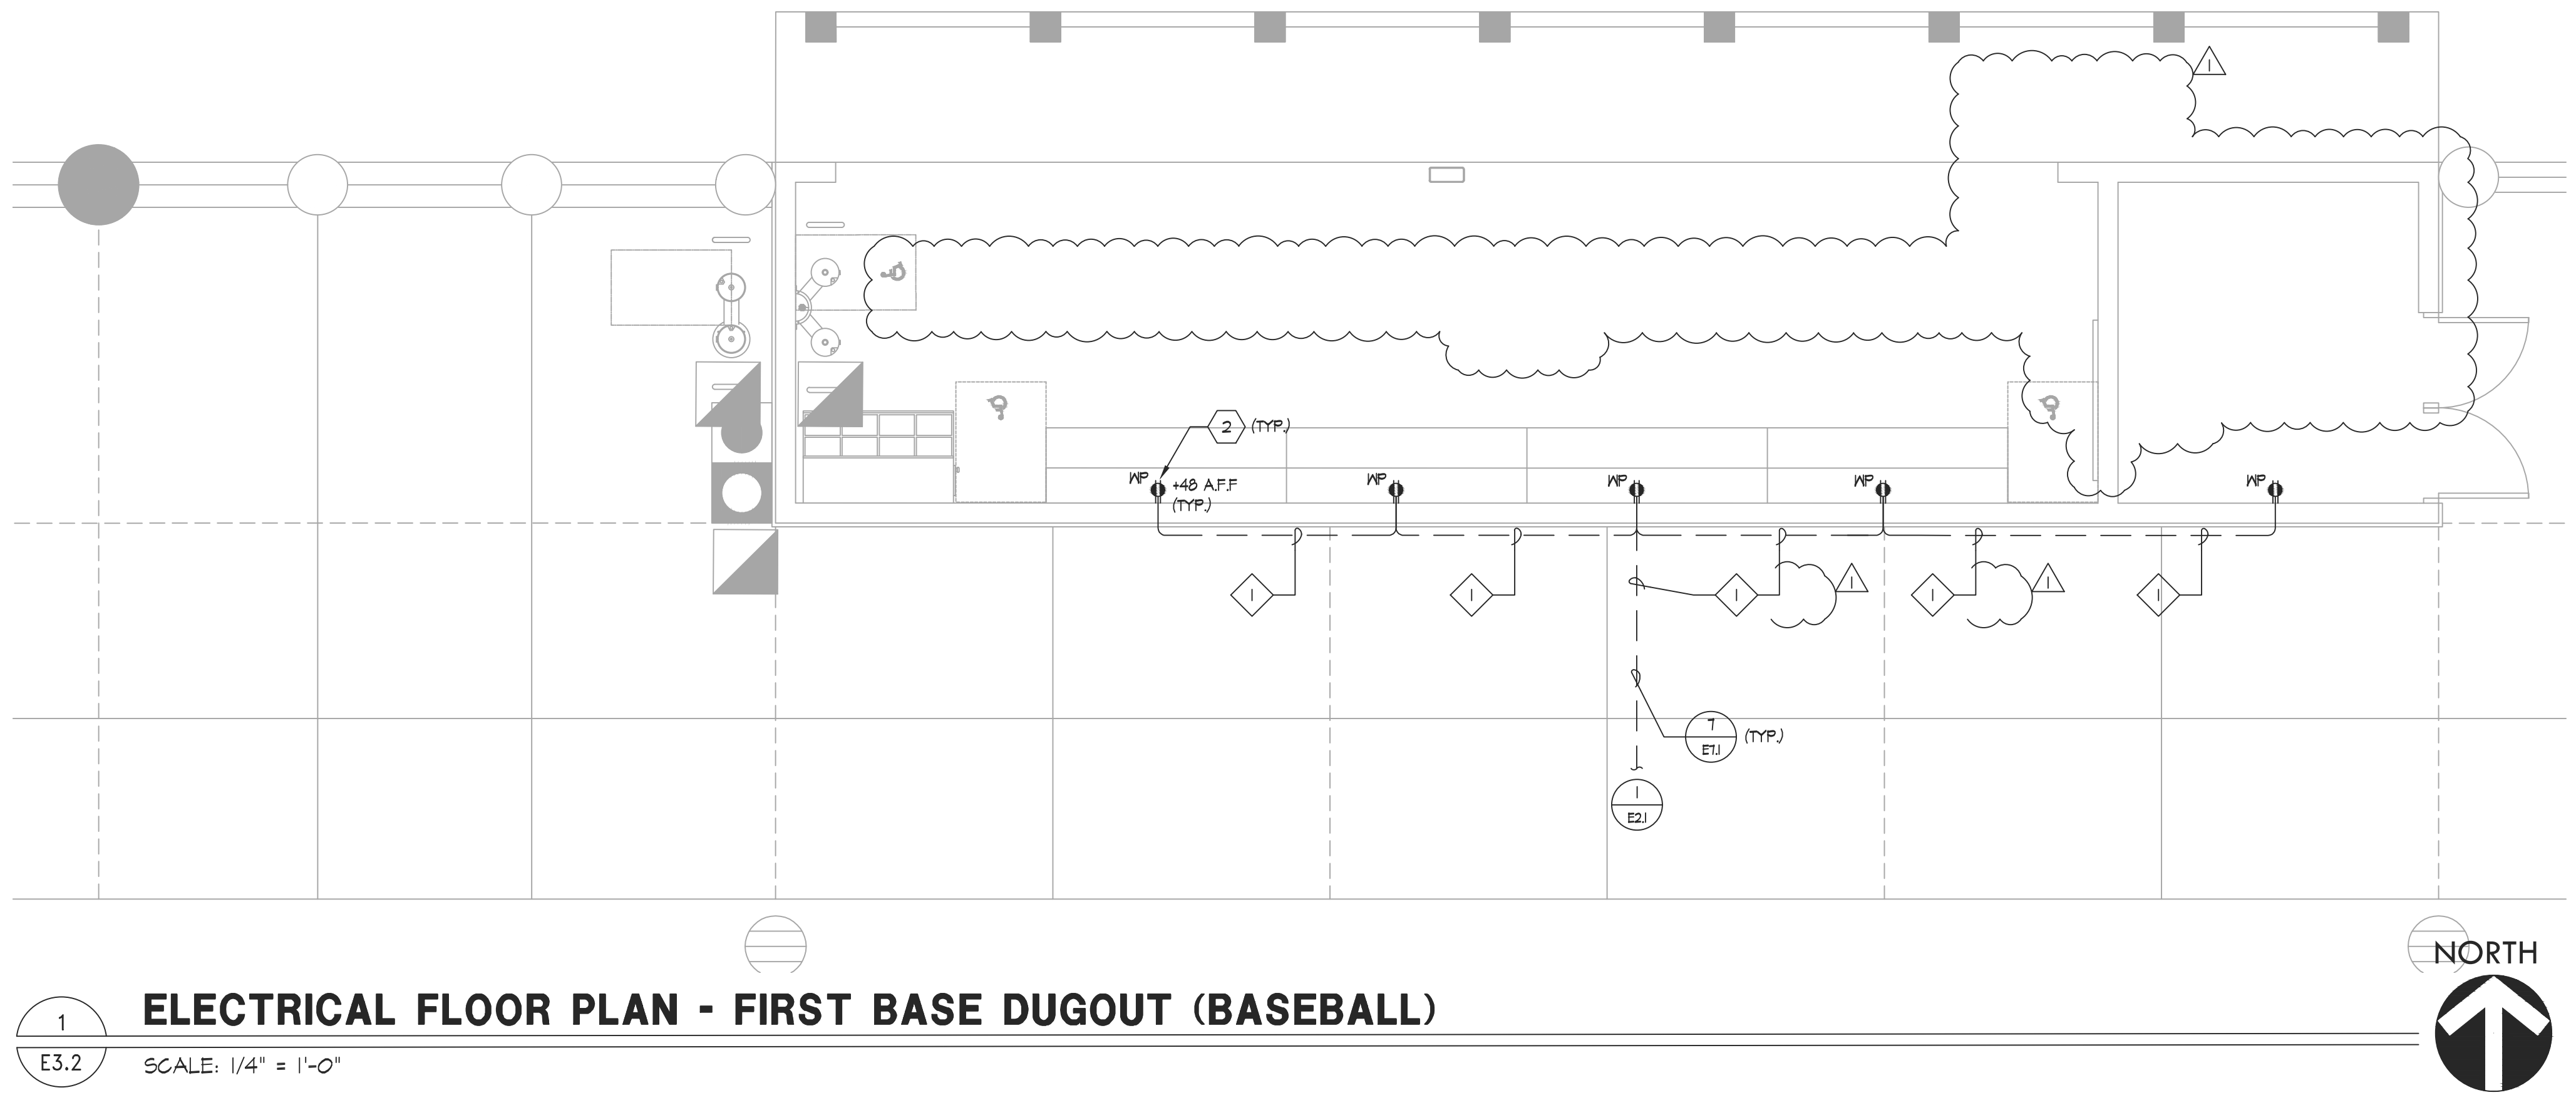SHEET NOTES:

- 1 NOT USED
- 2 PROVIDE AND INSTALL WEATHERPROOF, SFC, EXTERIOR OUTLET FOR DUGOUT. OUTLET SHALL BE PROVIDED WITH RAIN-TIGHT "WHILE-IN-USE" LOCKABLE COVER PER C.E.C. REQUIREMENTS. OUTLET SHALL BE INSTALLED FLUSH IN CMU WALL. CONTRACTOR SHALL COORDINATE EXACT LOCATION WITH ARCHITECT.
- 3 NOT USED

CONDUIT SCHEDULE:


- 1 (N) 1/2" - RECEPTACLE
- 2 NOT USED

VERDE DESIGN
 LANDSCAPE ARCHITECTURE
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 SPORT PLANNING & DESIGN
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CONSULTANT

**American Consulting Engineers
 Electrical, Inc.**
 1590 The Armetts Suite 200 San Jose, CA 95128 408/236-2316
 J09 #0022049 Fax: 408/236-2316



SHEET TITLE
**ELECTRICAL FLOOR PLAN -
 DUGOUTS (BASEBALL)**

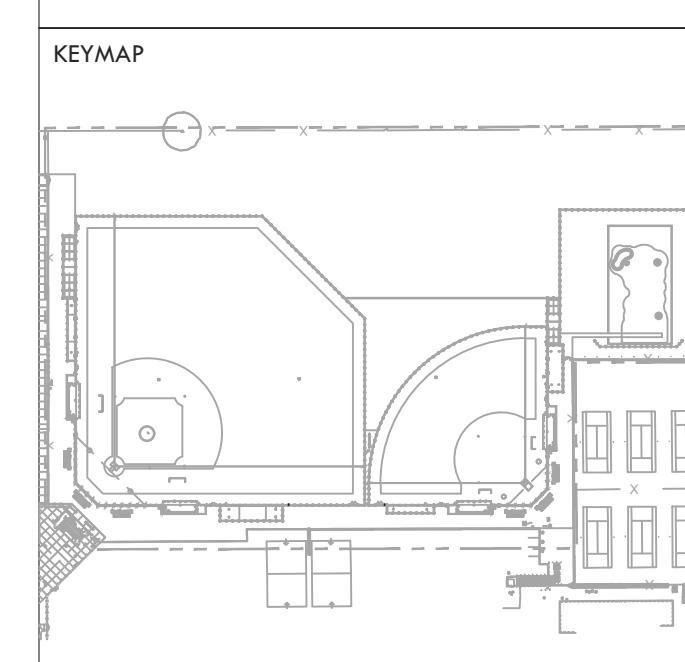
PROJECT NAME
**HIRAM JOHNSON
 HIGH SCHOOL
 GOLF PRACTICE FACILITY,
 VARSITY BASEBALL AND
 SOFTBALL FIELDS**

PROJECT ADDRESS
**6879 14TH AVENUE
 SACRAMENTO, CA 95820**


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DD 50% SUBMITTAL	04/15/22
100% DSA SUBMITTAL	05/27/22
DSA BACK CHECK	08/11/22
DSA ADDENDUM SUBMITTAL	09/16/22

NO.	REVISIONS	DATE
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SHEET NO.	E3.2 OF		

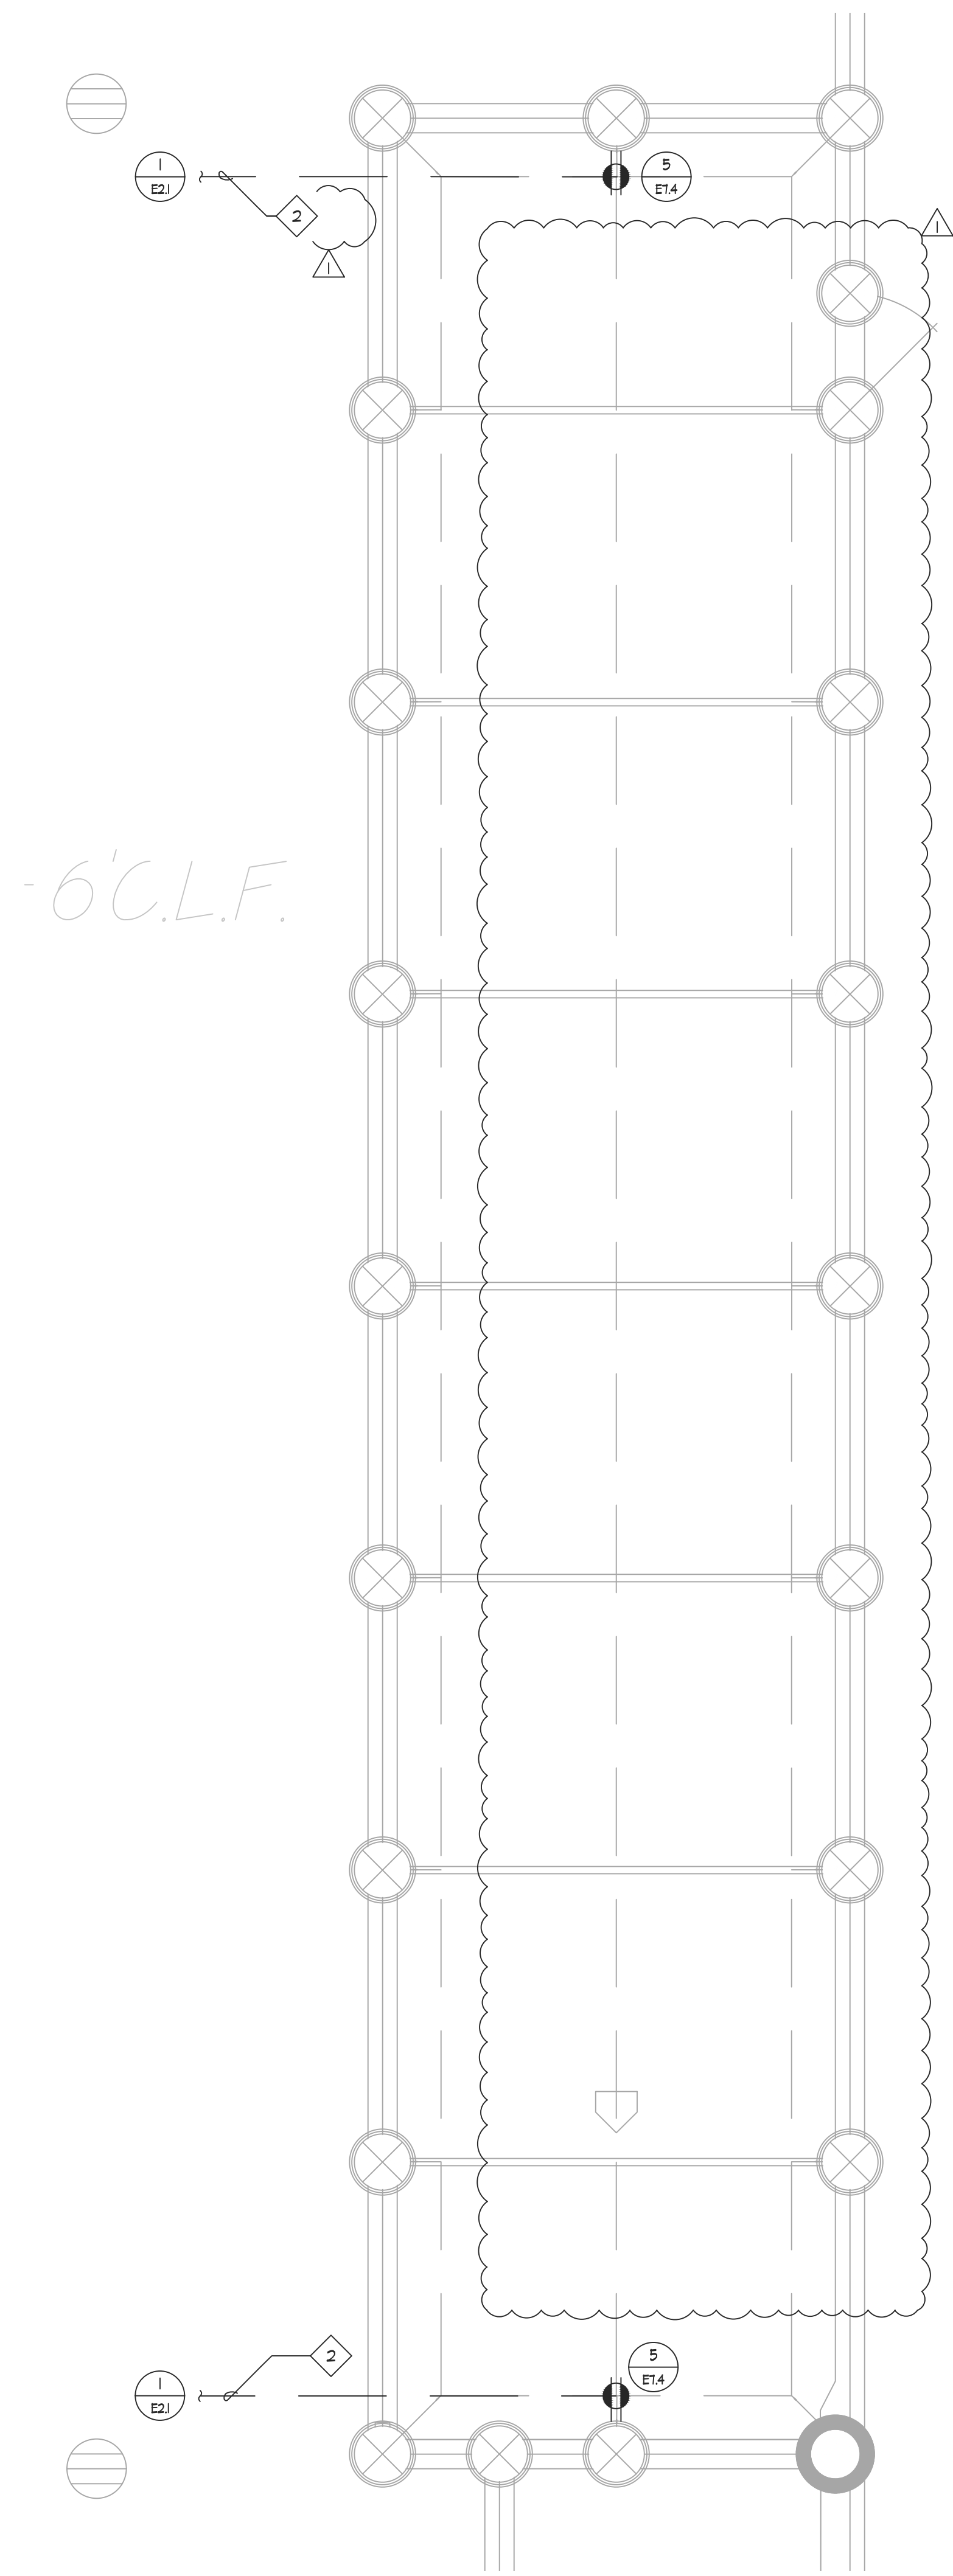

1 ENLARGED BATTING CAGE - ELECTRICAL SITE PLAN
E3.3 SCALE: 1/4" = 1' - 0"

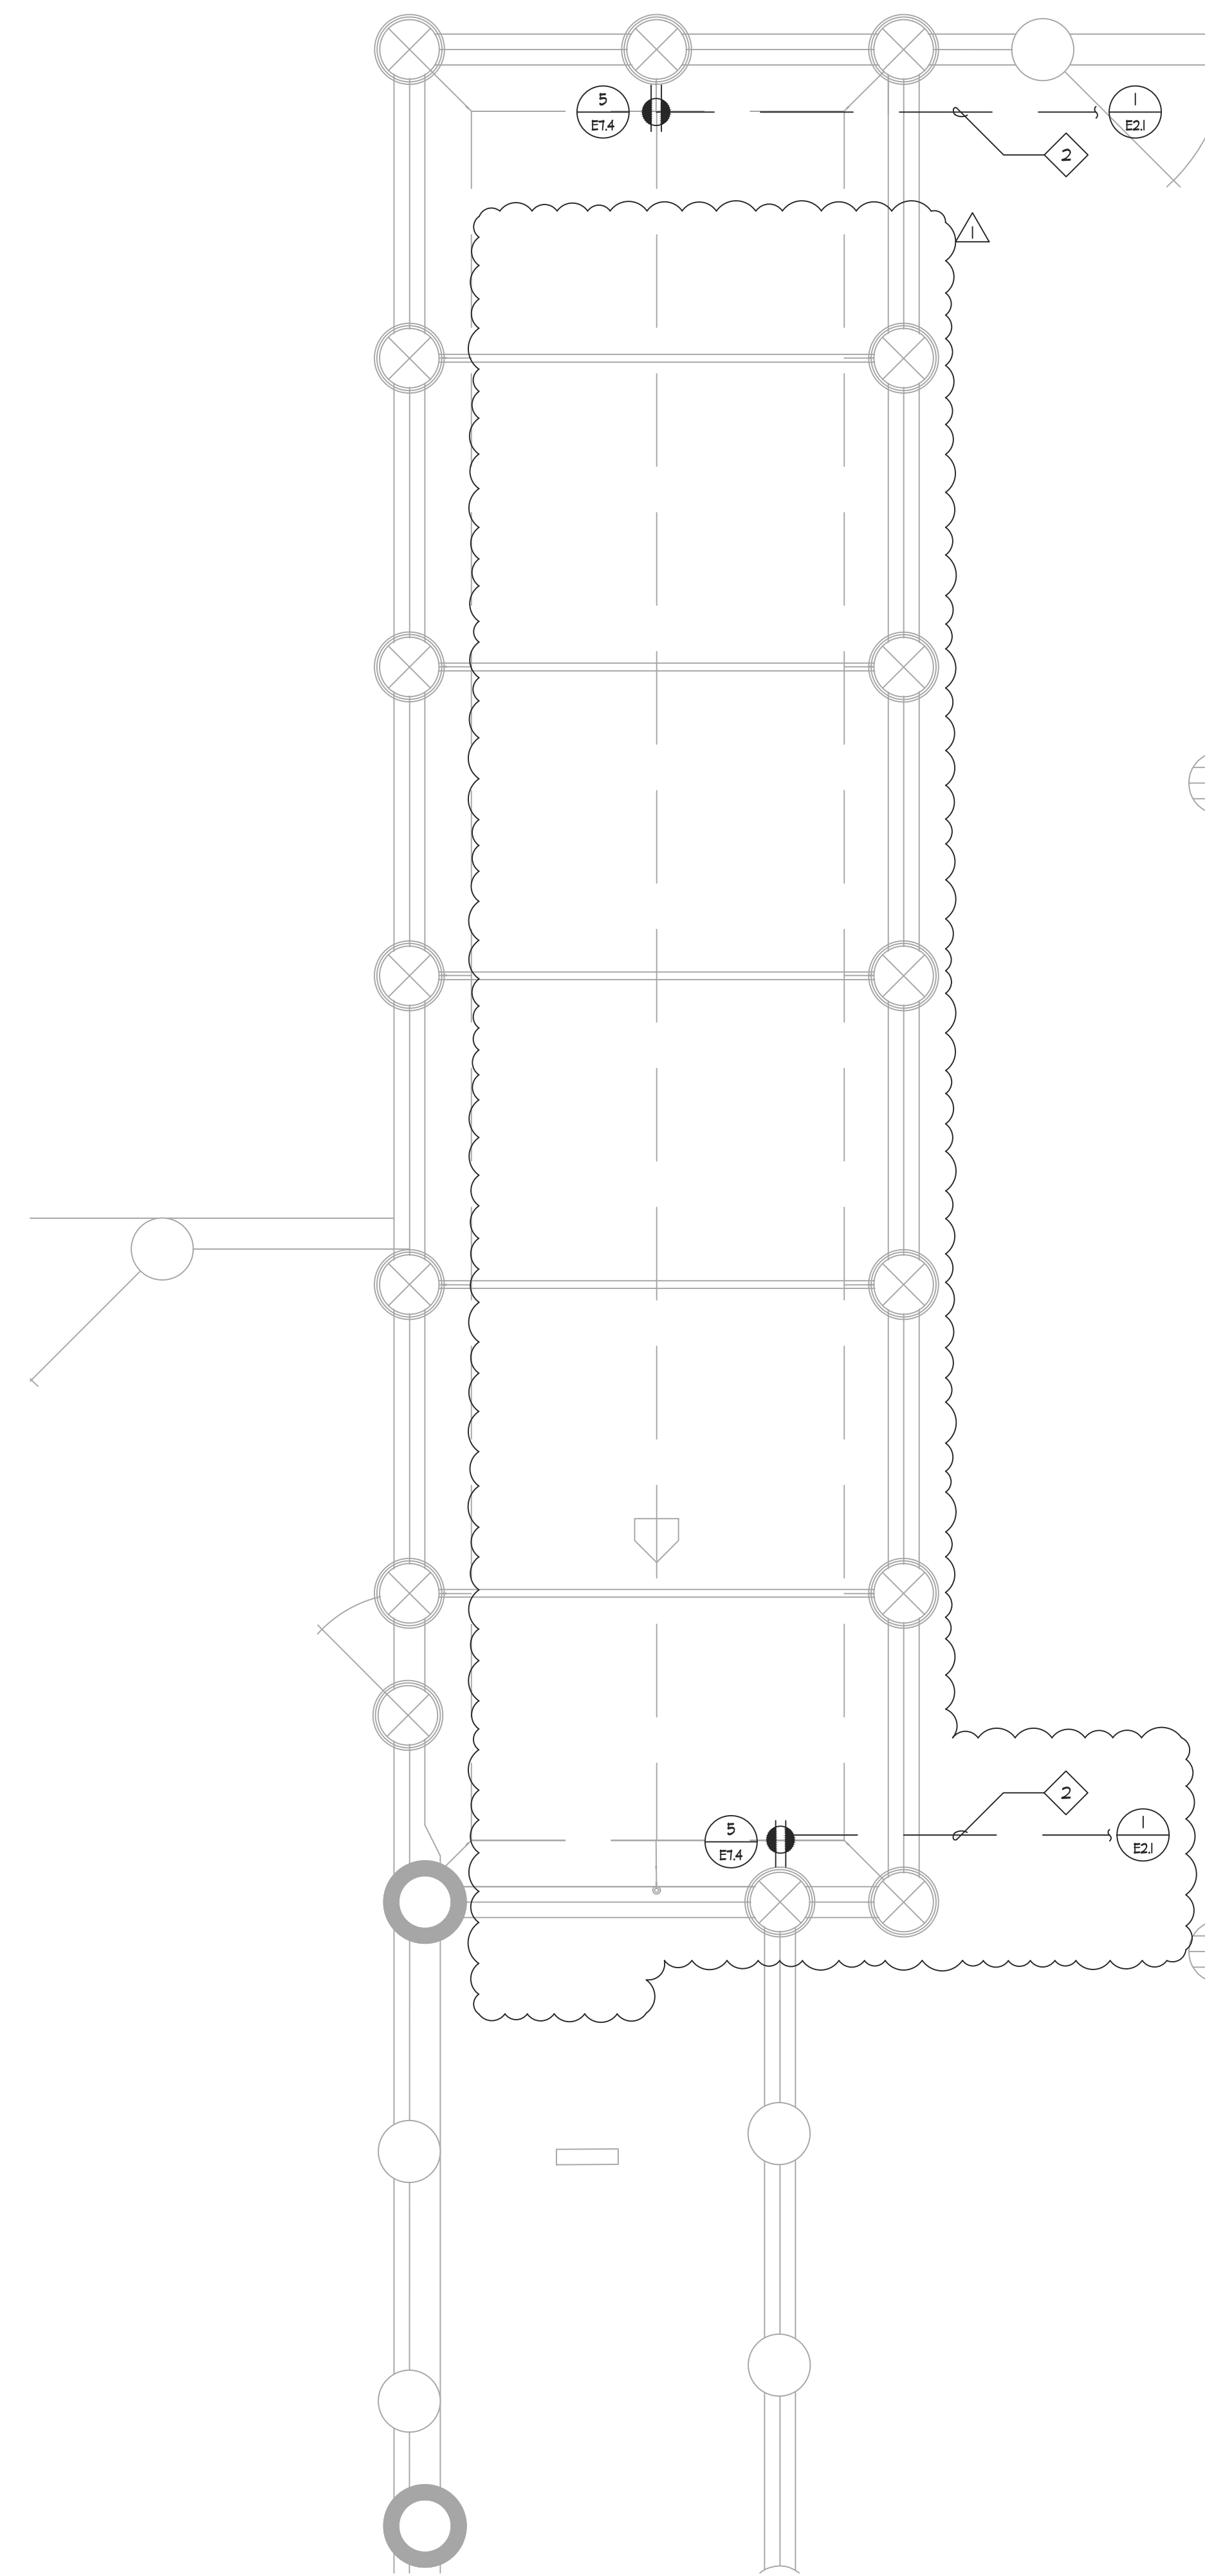


2 ENLARGED BATTING CAGE - ELECTRICAL SITE PLAN
E3.3 SCALE: 1/4" = 1' - 0"

GENERAL NOTES:

1. CONTRACTOR SHALL COORDINATE UNDERGROUND REQUIREMENTS WITH ALL OTHER TRADES TO AVOID CONFLICT.
2. CONTRACTOR TO SITE SURVEY EXISTING CONDITIONS AND LOCATIONS OF EXISTING UNDERGROUND SYSTEMS, WHERE (N) TRENCHWORK OCCURS PRIOR TO BIDDING. CONTRACTOR SHALL TAKE PROPER PRECAUTIONS TO ENSURE (E) UNDERGROUND SYSTEMS/CONDUIT/PIPES ARE NOT DAMAGED DURING INSTALLATION. CONTRACTOR IS RESPONSIBLE FOR ANY REPAIRS REQUIRED IN THE EVENT THE (E) UNDERGROUND SYSTEMS ARE DAMAGED AS A RESULT OF THE (N) ELECTRICAL TRENCHWORK.
3. LIGHTING AND RECEPTACLE CONDUIT SHALL BE IN SAME TRENCH.
4. SEE SINGLE LINE DIAGRAM FOR WIRE SIZES AND CONDUIT REQUIREMENTS.
5. CONTRACTOR TO COORDINATE SITE PLAN TO COMBINE ALL UNDERGROUND CONDUIT IN COMMON TRENCH AS NECESSARY.
6. ALL EMPTY CONDUIT SHALL BE PROVIDED WITH NYLON PULL CORD AS NOTED IN THE SPECIFICATIONS.
7. SEE DETAIL 7/E1 FOR TRENCHING REQUIREMENTS.
8. CONTRACTOR TO PROVIDE ALL MATERIALS, EQUIPMENT, SPORT FIELD LIGHTS, CONTROL CABINETS, WIRING, CONDUITS, ETC TO SUCCESSFULLY INSTALL NEM SPORTFIELD LIGHTING.
9. ALL ELECTRICAL WORK SHALL BE INSTALLED PER 2019 CEC.

CONDUIT SCHEDULE:


- 1 NOT USED
- 2 (N) 1/4" - RECEPTACLE - BATTING CAGE

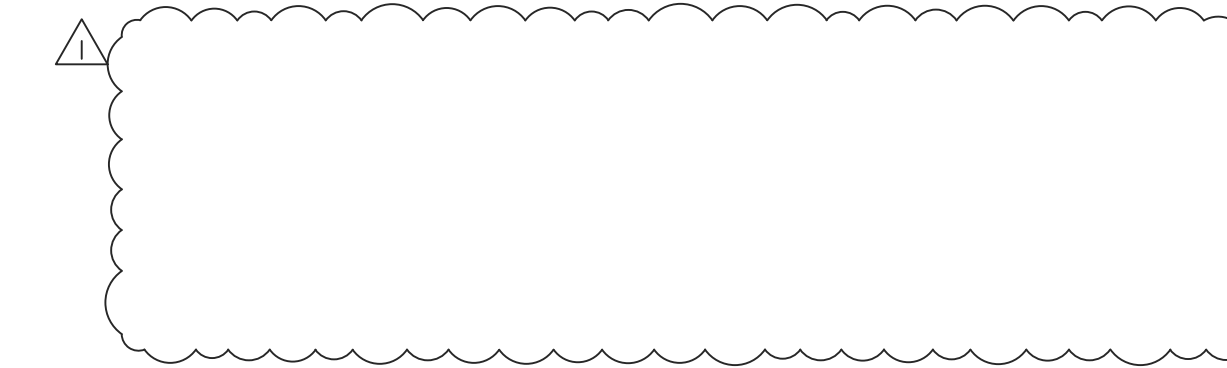

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JOB #0022049



SHEET TITLE
ELECTRICAL PLAN - BATTING CAGE (BASEBALL & SOFTBALL)

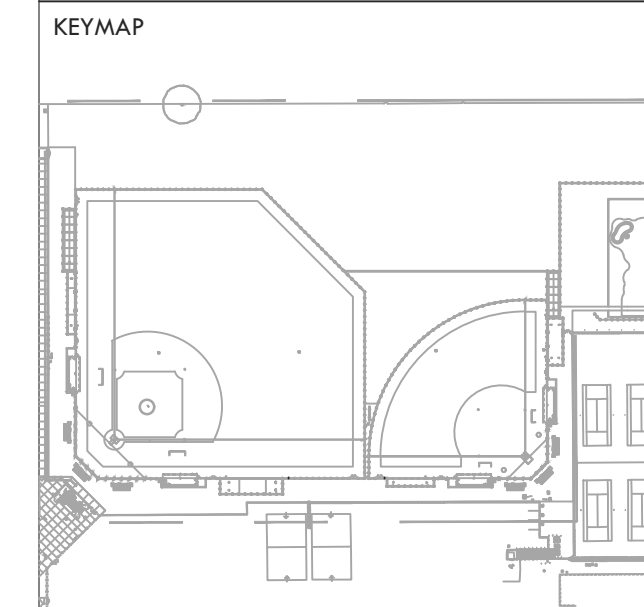PROJECT NAME
HIRAM JOHNSON HIGH SCHOOL GOLF PRACTICE FACILITY, VARSITY BASEBALL AND SOFTBALL FIELDS


PROJECT ADDRESS
6879 14TH AVENUE
SACRAMENTO, CA 95820

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100% DSA SUBMITTAL	05/27/22
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PROJ. NO. 2203200	
SHEET NO. E3.3 OF	

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GENERAL NOTES:

1. FEEDERS TO SPORT LIGHTS SHALL HAVE CONTINUOUS RUN, NO SPLICING ALLOWED.
2. ALL BREAKERS, PANELS, AND SWITCHBOARD SHALL BE SQUARE D OR APPROVED EQUAL.
3. ALL ELECTRICAL EQUIPMENT WITH EXPOSED (TO OUTDOOR ENVIRONMENT) SCREWS SHALL BE TREATED WITH ANTI-SIEZE.
4. ALL BREAKERS IN THE DISTRIBUTION SECTION SHALL BE PROVIDED WITH ENGRAVED NAMEPLATE TO IDENTIFY EQUIPMENT.

CONDUIT SCHEDULE

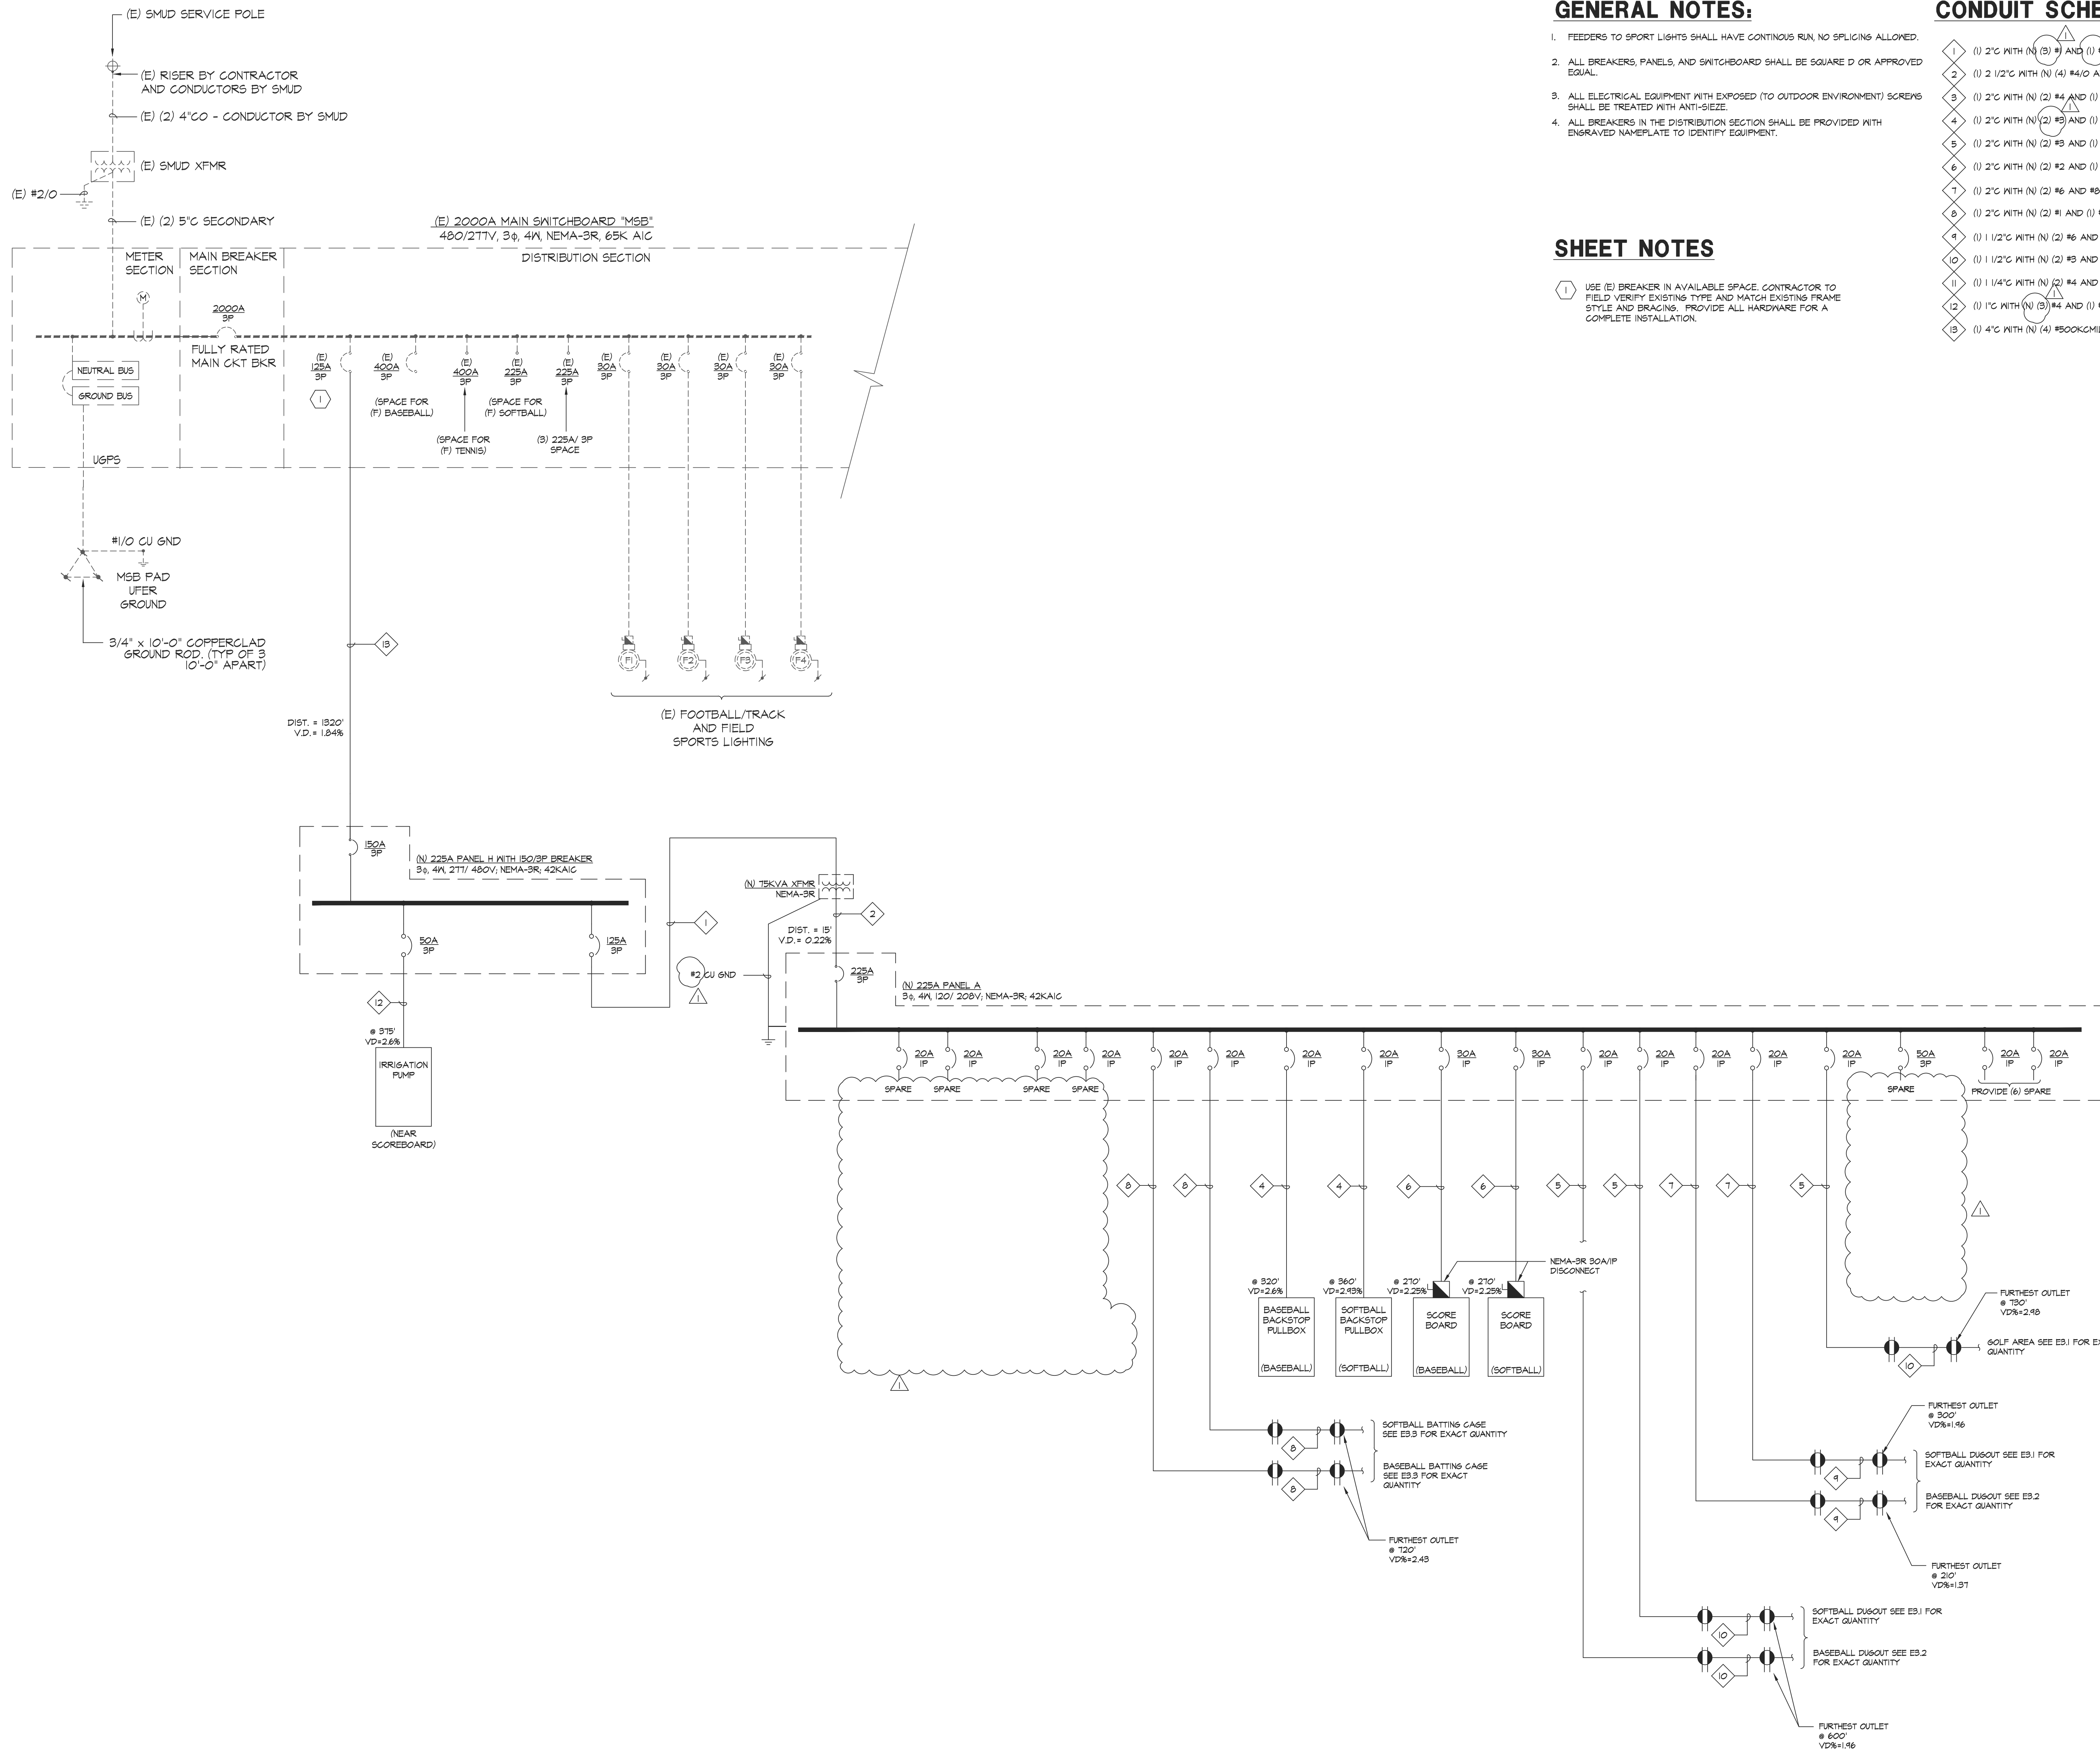- | | |
|----|--|
| 1 | (1) 2" WITH (N) (3) #4 AND (1) #2 CU GND. |
| 2 | (1) 2 1/2" WITH (N) (4) #4/O AND (1) #2 GND. |
| 3 | (1) 2" WITH (N) (2) #4 AND (1) #6 GND. |
| 4 | (1) 2" WITH (N) (2) #4 AND (1) #6 CU GND. |
| 5 | (1) 2" WITH (N) (2) #4 AND (1) #6 GND. |
| 6 | (1) 2" WITH (N) (2) #4 AND (1) #6 GND. |
| 7 | (1) 2" WITH (N) (2) #4 AND (1) #6 GND. |
| 8 | (1) 2" WITH (N) (2) #4 AND (1) #6 GND. |
| 9 | (1) 1 1/2" WITH (N) (2) #4 AND (1) #6 GND. |
| 10 | (1) 1 1/2" WITH (N) (2) #4 AND (1) #6 GND. |
| 11 | (1) 1 1/4" WITH (N) (2) #4 AND (1) #6 GND. |
| 12 | (1) 1" WITH (N) (2) #4 AND (1) #6 GND. |
| 13 | (1) 4" WITH (N) (4) #500KCMIL AND (1) #1/O CU GND. |


SHEET NOTES

1. USE (E) BREAKER IN AVAILABLE SPACE. CONTRACTOR TO FIELD VERIFY EXISTING TYPE AND MATCH EXISTING FRAME STYLE AND BRACING. PROVIDE ALL HARDWARE FOR A COMPLETE INSTALLATION.



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 JOB #2022049

KEYMAP

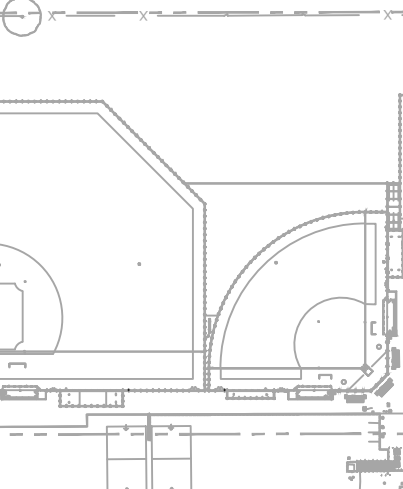

SHEET TITLE

ELECTRICAL SINGLE LINE DIAGRAM

PROJECT NAME

HIRAM JOHNSON HIGH SCHOOL GOLF PRACTICE FACILITY, VARSITY BASEBALL AND SOFTBALL FIELDS

PROJECT ADDRESS

6879 14TH AVENUE SACRAMENTO, CA 95820

SUBMITTAL

SUBMITTAL	DATE
DD 50% SUBMITTAL	04/15/22
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DATE ISSUED

09/16/2022

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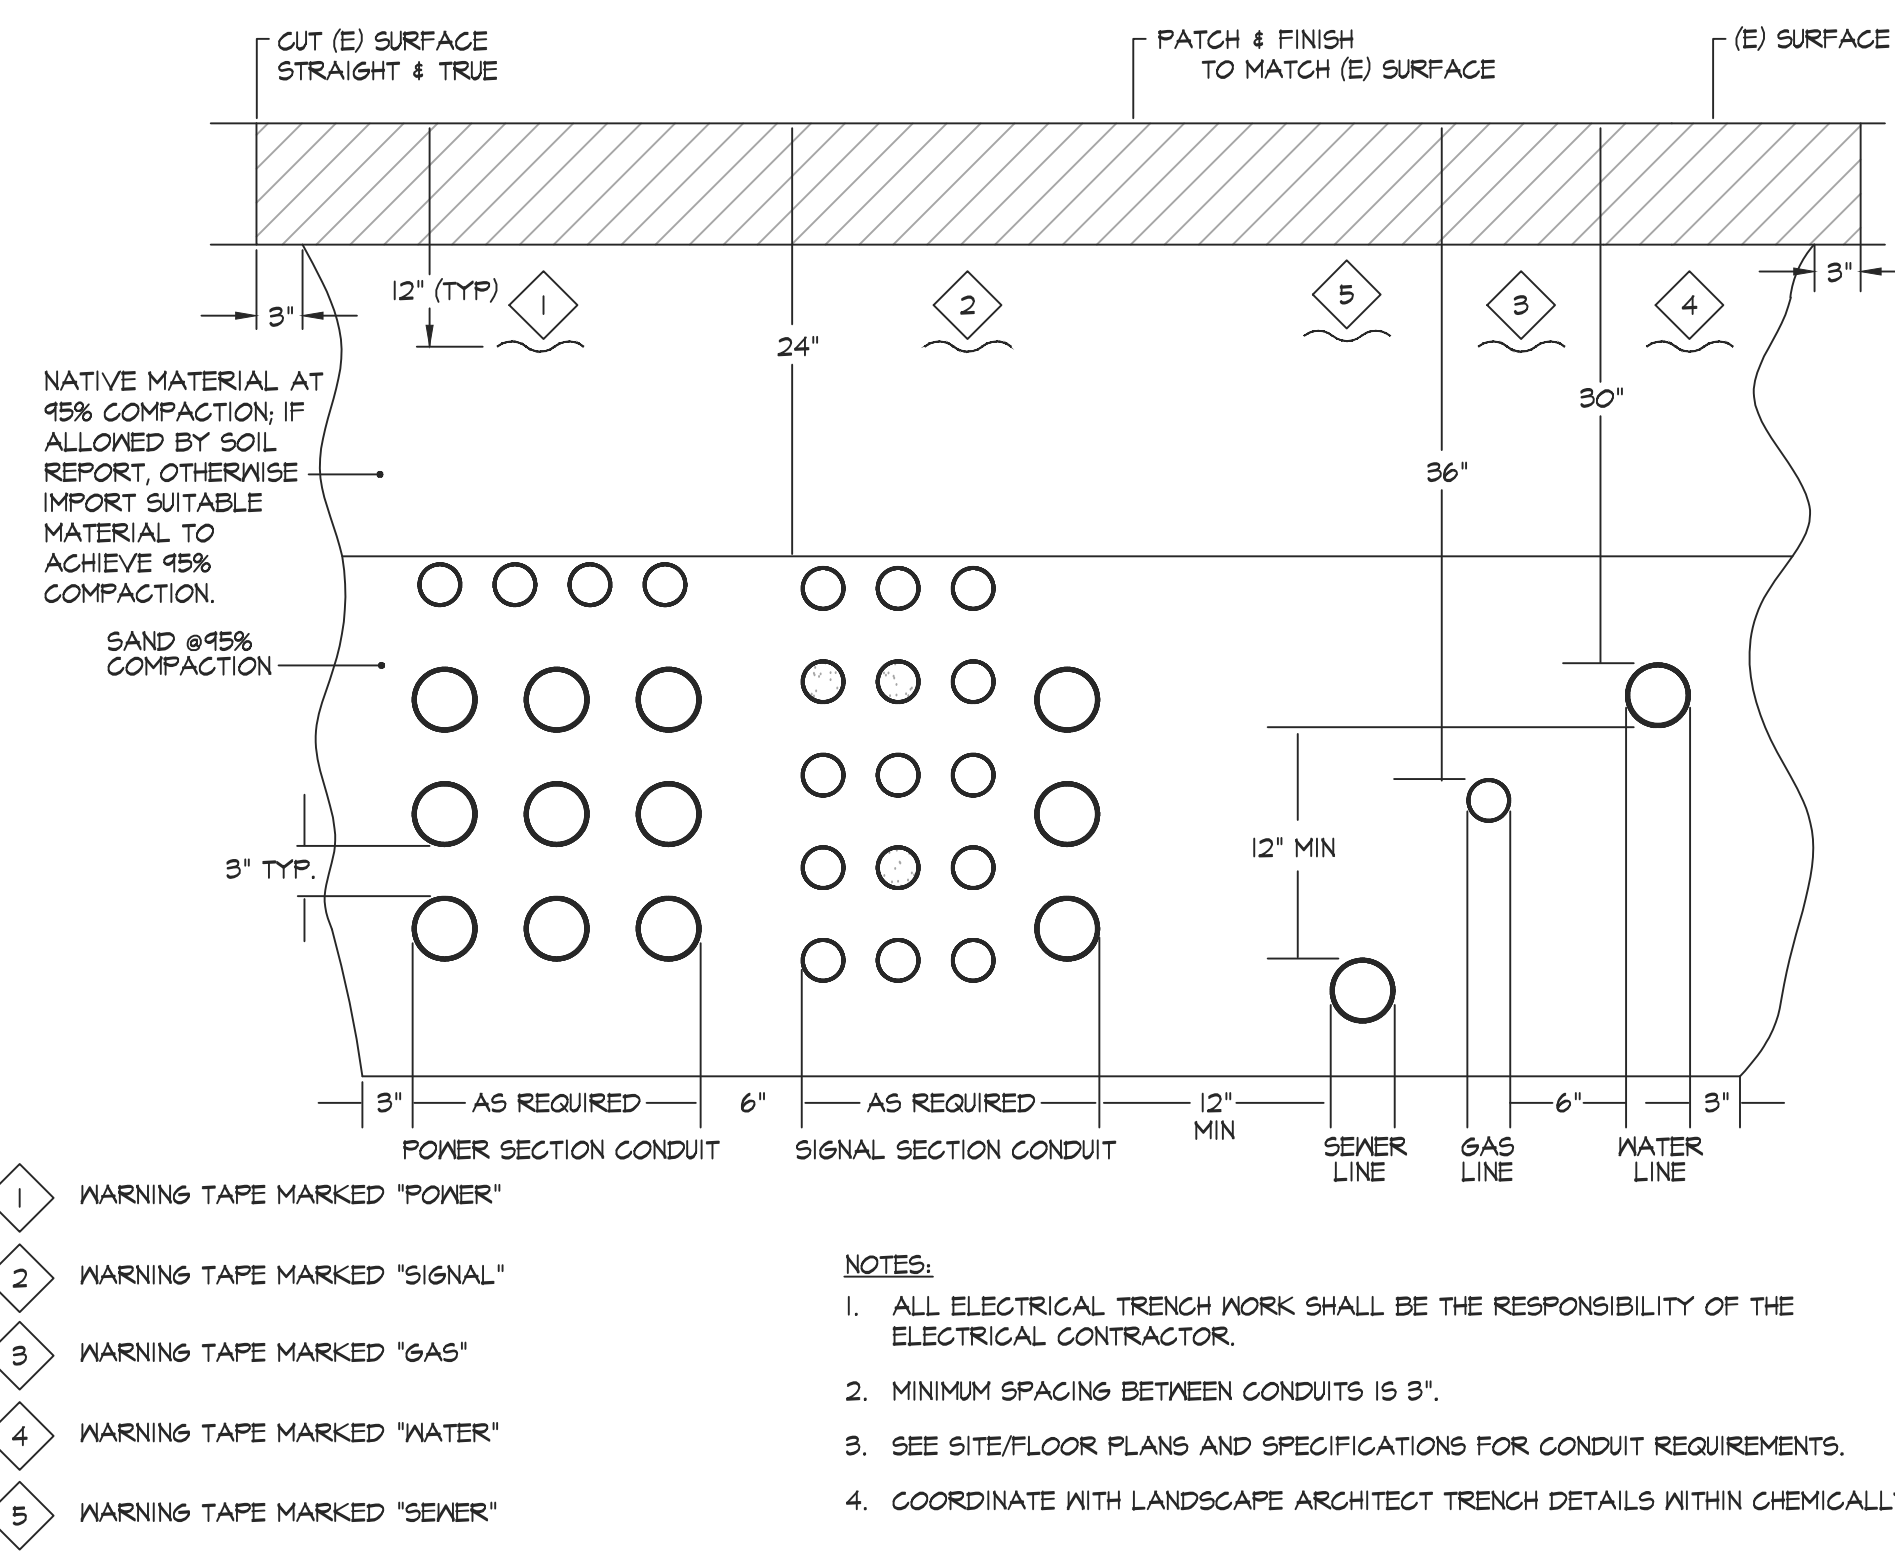
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SHEET NO.


E5.1 OF

ELECTRICAL SINGLE LINE DIAGRAM

1 ELECTRICAL SINGLE LINE DIAGRAM - SOFTBALL AND POOL
 ES.1 NOT TO SCALE




1 **TYPICAL JOINT TRENCH & DUCT BANK DETAIL**
 E7.1 NOT TO SCALE

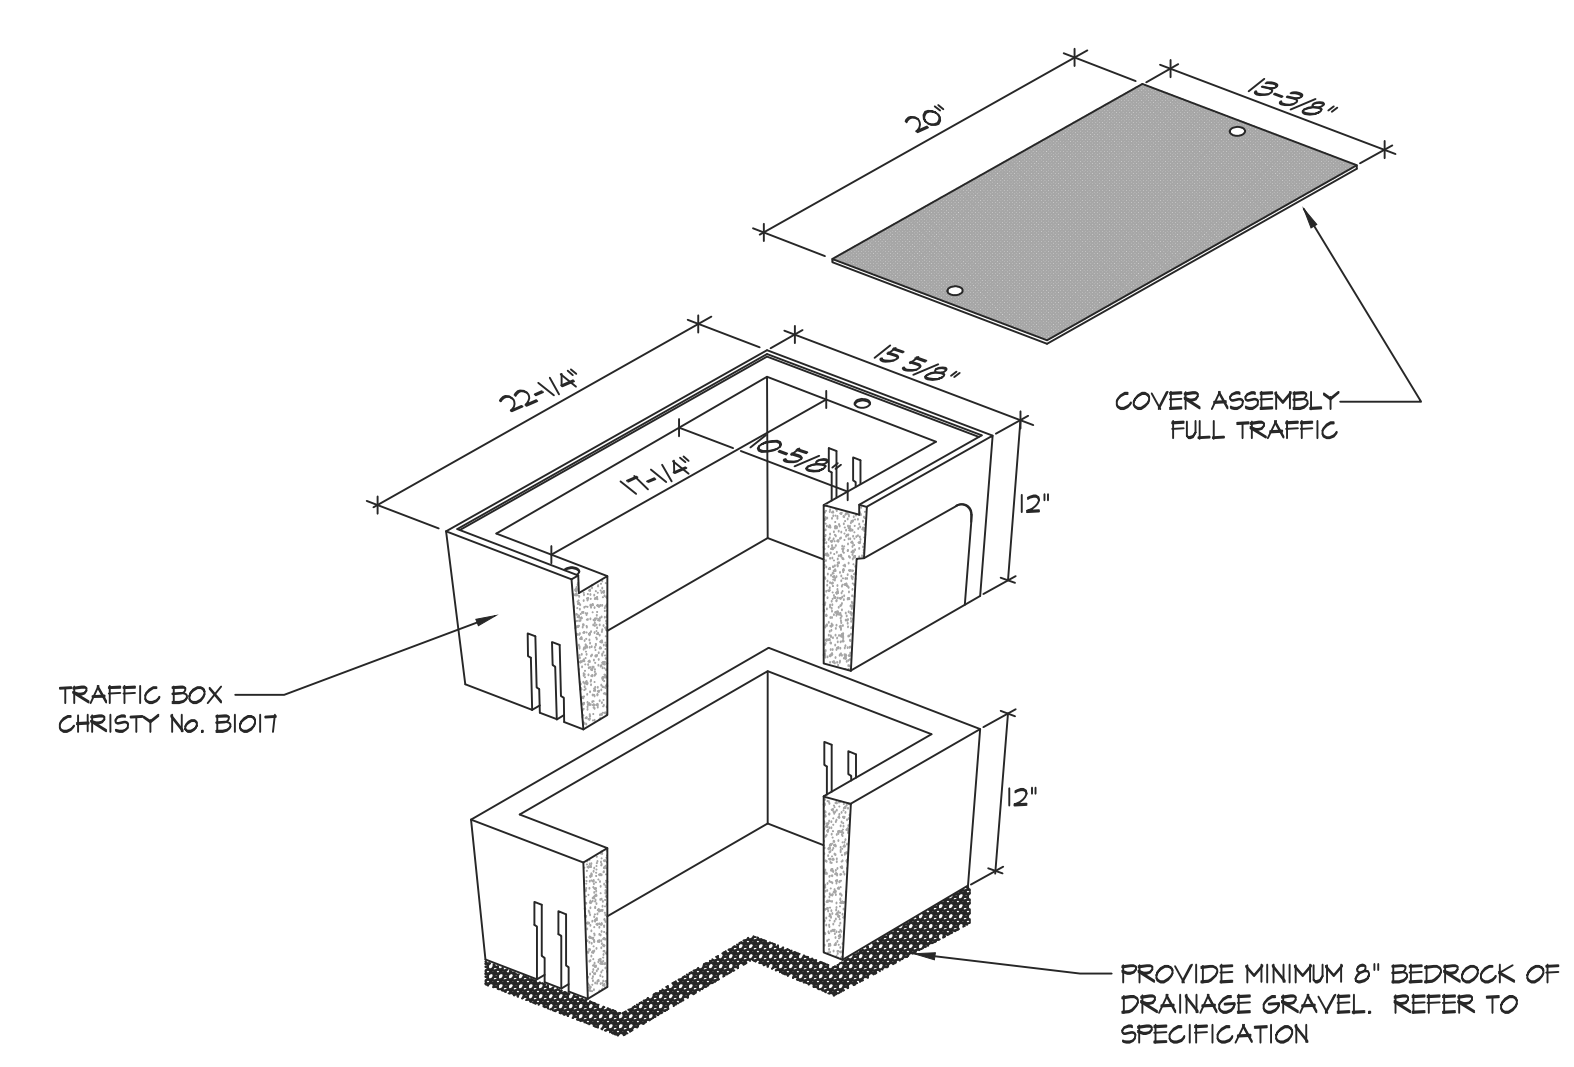


NOTES:
 1. HIGH DENSITY REINFORCED CONCRETE BOX WITH NON-SETTING SHOULDERS POSITIONED TO MAINTAIN GRADE AND FACILITATE BACK FILLING. APPROXIMATE DIMENSIONS SHOWN.
 2. ALL CONDUITS SHALL ENTER FROM SIDES OF FULL BOX. CONTRACTOR SHALL PROVIDE FULL BOX EXTENSION AS REQUIRED. NO CONDUITS SHALL BE ALLOWED FROM THE BOTTOM OF THE FULL BOX.
 3. CONTRACTOR SHALL STACK CONDUITS AS REQUIRED TO MEET THE NEC CODE REQUIREMENTS.
 4. PROVIDE BELL ENDS ON ALL CONDUIT.
 5. ALL PENETRATIONS INTO BOXES SHALL BE SEALED WITH GROUT.
 6. PROVIDE 4" DRAIN HOLE WITH MINIMUM 8" CRUSHED ROCK BEDDING AT BOTTOM OF BOX FOR DRAINAGE.

2 **B1017 ELECTRICAL VAULT**
 E7.1 NOT TO SCALE (FULL TRAFFIC COVER)

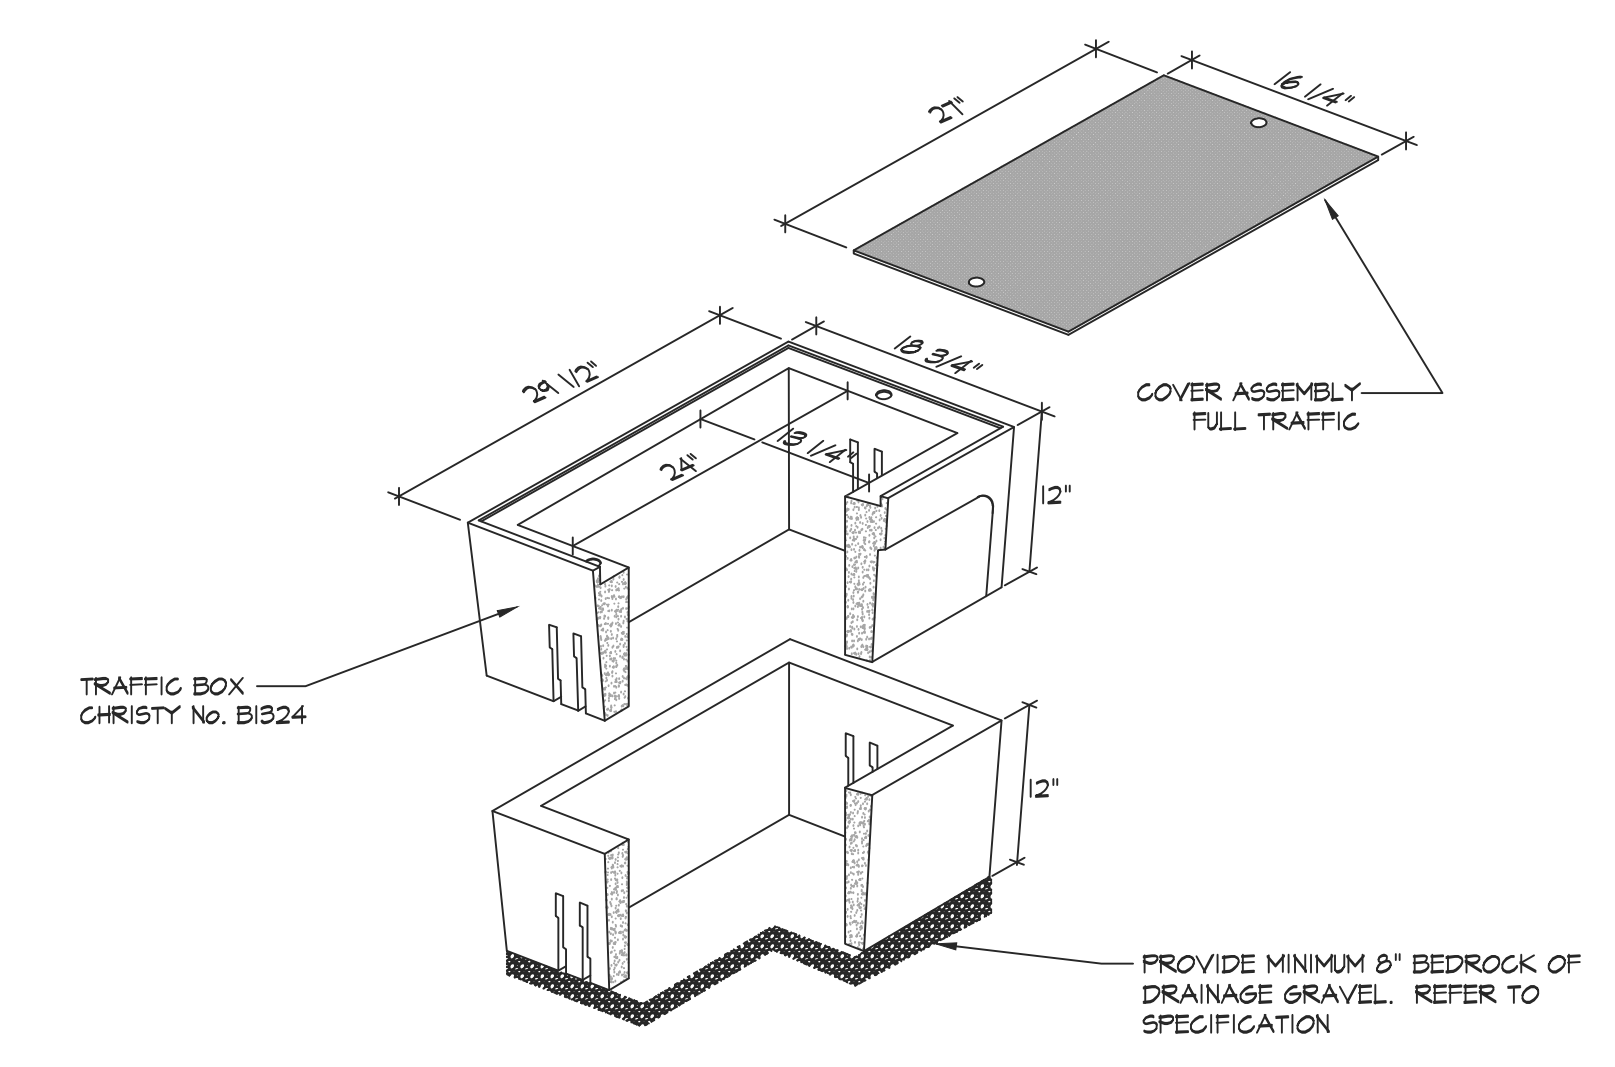

NOTES:
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 3. CONTRACTOR SHALL STACK CONDUITS AS REQUIRED TO MEET THE NEC CODE REQUIREMENTS.
 4. PROVIDE BELL ENDS ON ALL CONDUIT.
 5. ALL PENETRATIONS INTO BOXES SHALL BE SEALED WITH GROUT.
 6. PROVIDE 4" DRAIN HOLE WITH MINIMUM 8" CRUSHED ROCK BEDDING AT BOTTOM OF BOX FOR DRAINAGE.

3 **B1324 ELECTRICAL VAULT**
 E7.1 NOT TO SCALE (FULL TRAFFIC COVER)

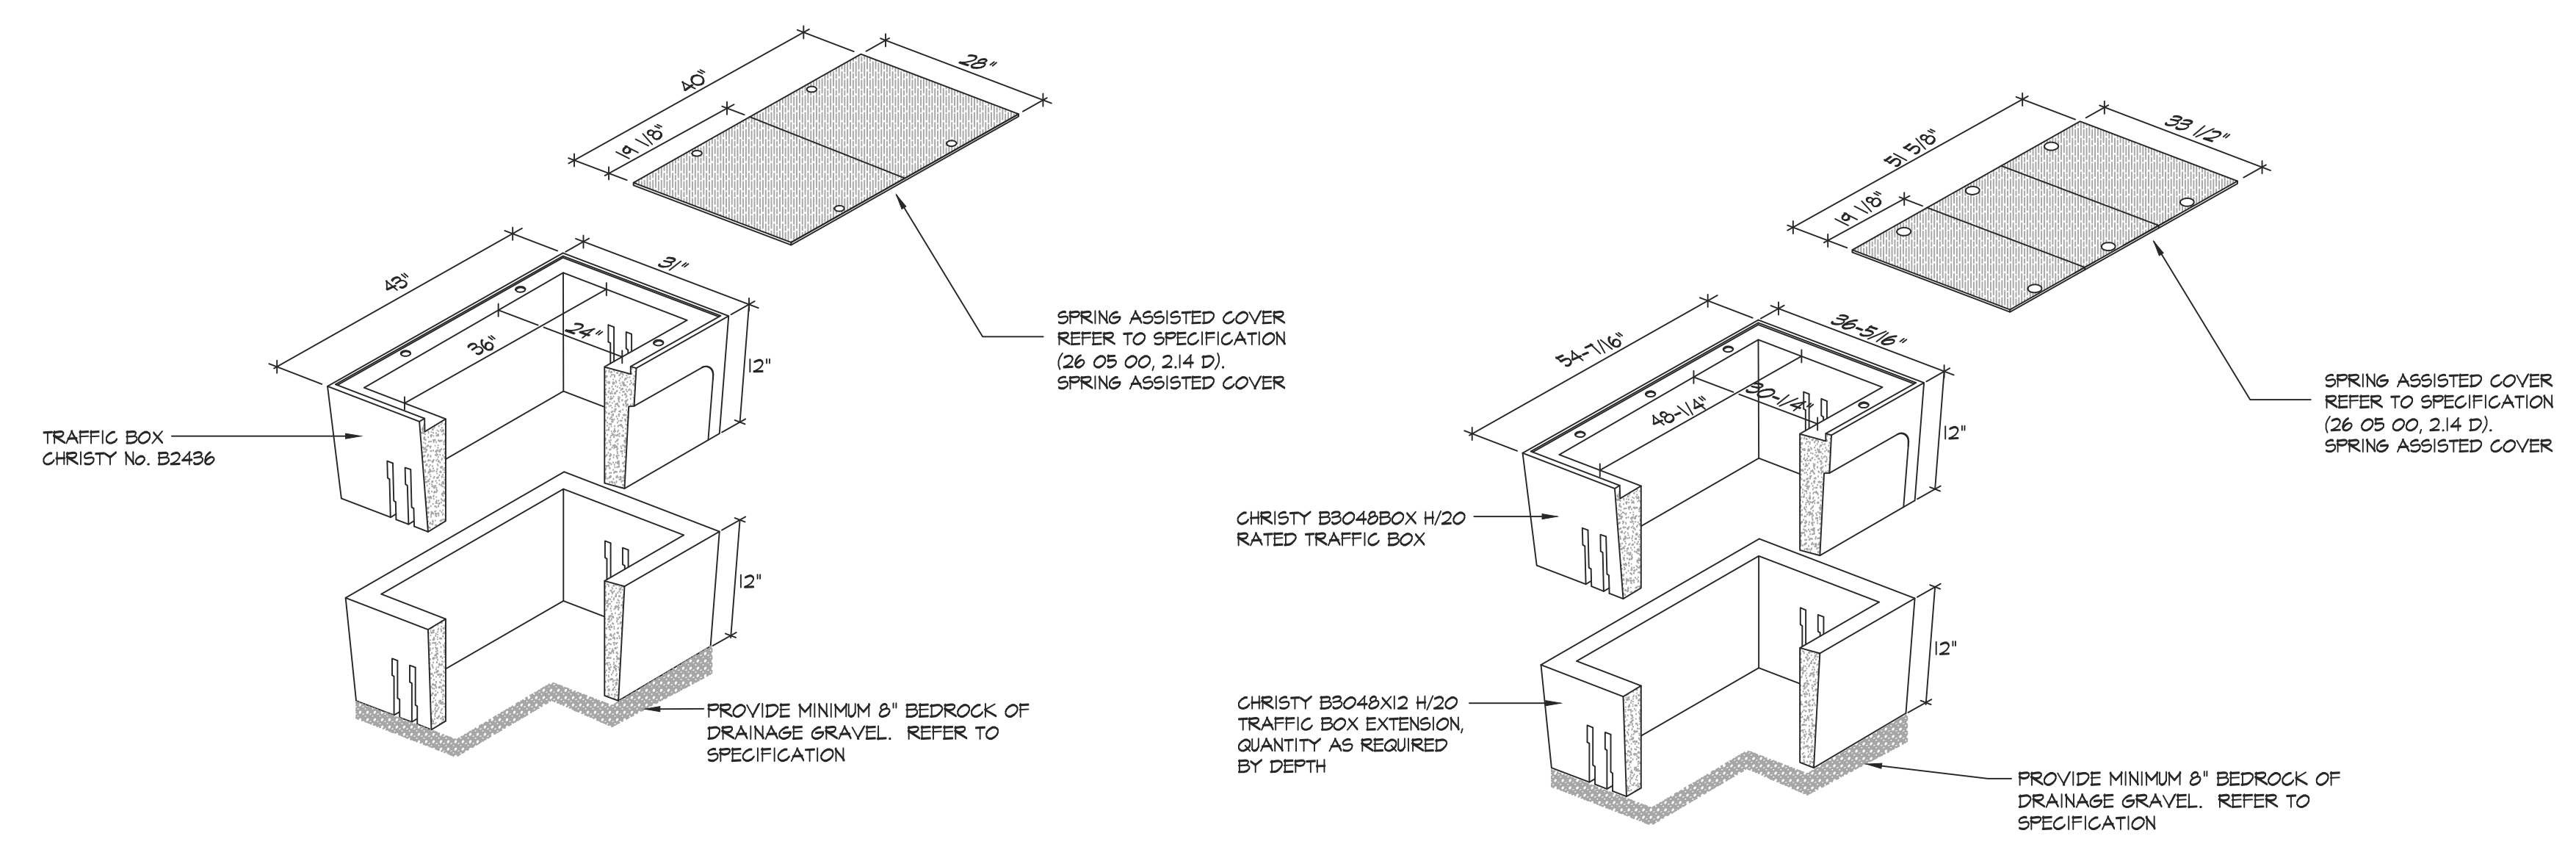


NOTES:
 1. HIGH DENSITY REINFORCED CONCRETE BOX WITH NON-SETTING SHOULDERS POSITIONED TO MAINTAIN GRADE AND FACILITATE BACK FILLING. APPROXIMATE DIMENSIONS SHOWN.
 2. ALL CONDUITS SHALL ENTER FROM SIDES OF FULL BOX. CONTRACTOR SHALL PROVIDE FULL BOX EXTENSION AS REQUIRED. NO CONDUITS SHALL BE ALLOWED FROM THE BOTTOM OF THE FULL BOX.
 3. CONTRACTOR SHALL STACK CONDUITS AS REQUIRED TO MEET THE NEC CODE REQUIREMENTS.
 4. PROVIDE BELL ENDS ON ALL CONDUIT.
 5. ALL PENETRATIONS INTO BOXES SHALL BE SEALED WITH GROUT.
 6. PROVIDE 4" DRAIN HOLE WITH MINIMUM 8" CRUSHED ROCK BEDDING AT BOTTOM OF BOX FOR DRAINAGE.

NOTES:
 1. HIGH DENSITY REINFORCED CONCRETE BOX WITH NON-SETTING SHOULDERS POSITIONED TO MAINTAIN GRADE AND FACILITATE BACK FILLING. APPROXIMATE DIMENSIONS SHOWN.
 2. ALL CONDUITS SHALL ENTER FROM SIDES OF FULL BOX. CONTRACTOR SHALL PROVIDE FULL BOX EXTENSION AS REQUIRED. NO CONDUITS SHALL BE ALLOWED FROM THE BOTTOM OF THE FULL BOX.
 3. CONTRACTOR SHALL STACK CONDUITS AS REQUIRED TO MEET THE NEC CODE REQUIREMENTS.
 4. PROVIDE BELL ENDS ON ALL CONDUIT.
 5. ALL PENETRATIONS INTO BOXES SHALL BE SEALED WITH GROUT.
 6. PROVIDE 4" DRAIN HOLE WITH MINIMUM 8" CRUSHED ROCK BEDDING AT BOTTOM OF BOX FOR DRAINAGE.


4 **B2436 ELECTRICAL VAULT**
 E7.1 NOT TO SCALE (FULL TRAFFIC COVER)

5 **B3048 TRAFFIC BOX DETAIL**
 E7.1 NOT TO SCALE (FULL TRAFFIC COVER)

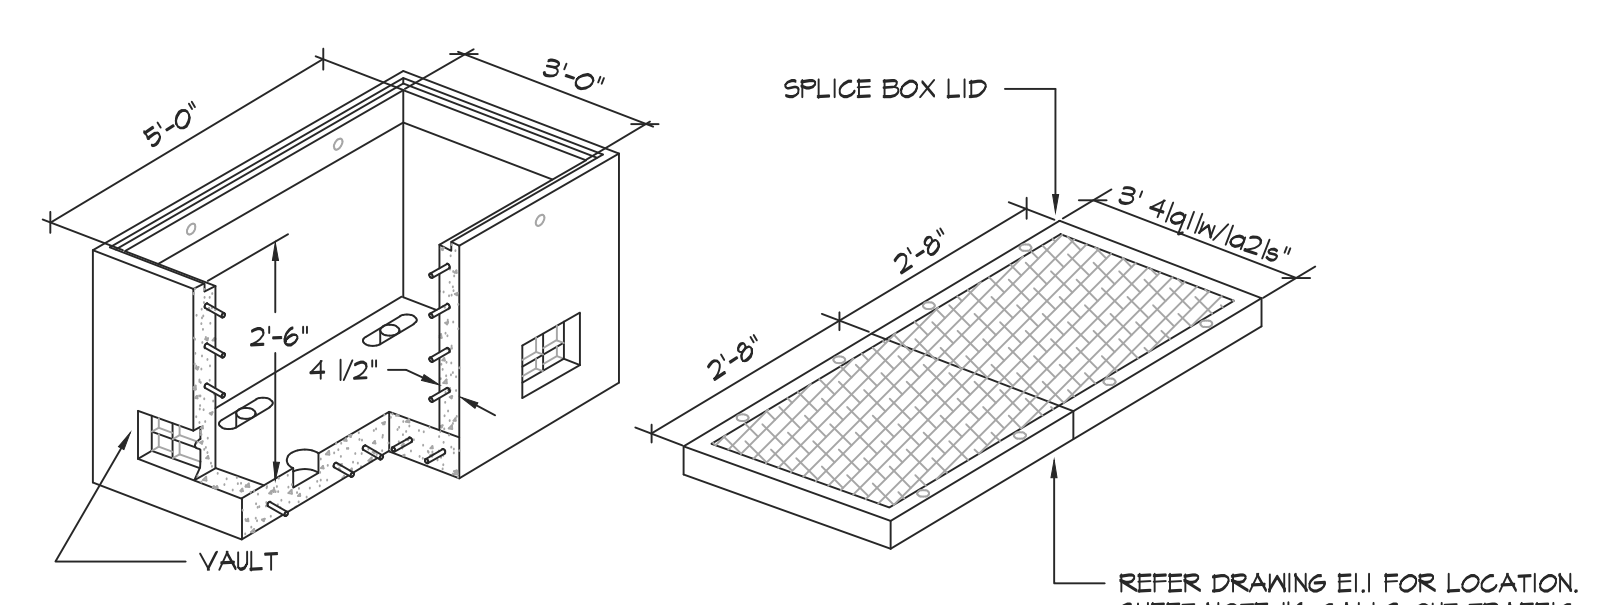


A HEAVY DUTY REINFORCED CONCRETE BOX WITH STANDARD KNOCKOUTS AND PULLING IRONS MADE IN CONFORMANCE WITH P & E REQUIREMENTS.

6 **3' X 5' ELECTRICAL VAULT**
 E7.1 NOT TO SCALE

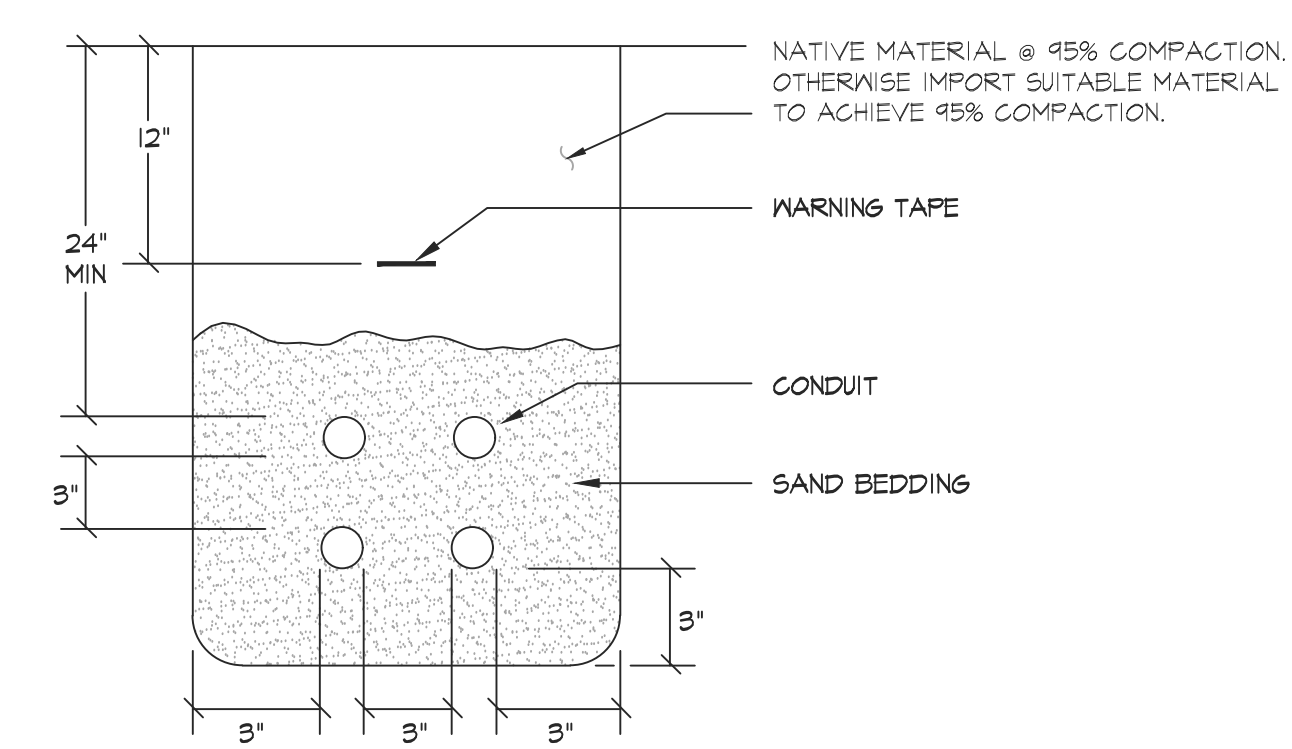

7 **TYPICAL TRENCH DETAIL**
 E7.1 NOT TO SCALE

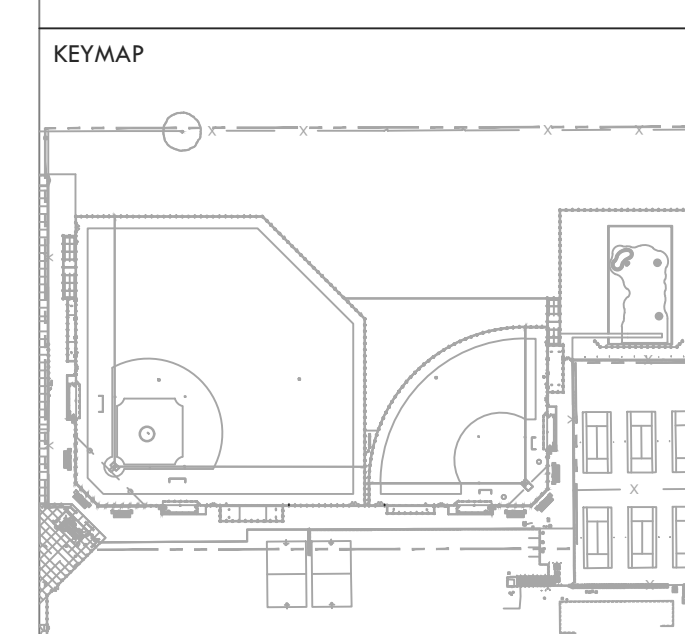

SHEET TITLE
ELECTRICAL DETAILS

PROJECT NAME
**HIRAM JOHNSON
 HIGH SCHOOL
 GOLF PRACTICE FACILITY,
 VARSITY BASEBALL AND
 SOFTBALL FIELDS**


PROJECT ADDRESS
**6879 14TH AVENUE
 SACRAMENTO, CA 95820**

SUBMITTAL	DATE
DD 50% SUBMITTAL	04/15/22
100% DSA SUBMITTAL	05/27/22
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PROJ. NO. 2203200	
SHEET NO. E7.1	OF


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- 1 SIZE OF CONDUCTORS SHALL COMPLY WITH NEC TABLE 250-66
- 2 BOND SEPARATE CONDUCTORS FROM GROUND ROD TO ELECTRICAL PANEL AND TO METAL BUILDING FRAME (NEC 250-50). IN ADDITION TO DETAIL ABOVE, BOND THE ELECTRICAL GROUND TO NEAREST METALLIC COLD WATER PIPE. (NEC 250-50)
- 3 CHECKS RESISTANCE TO GROUND, IF RESISTANCE EXCEEDS 25 OHMS, INSTALL ADDITIONAL GROUND RODS AS REQUIRED. (NEC 250-56)
- 4 ALL MODULES OF METAL FRAME BUILDINGS SHALL BE ELECTRICALLY BONDED TOGETHER. (BOLTING ONLY IS NOT ACCEPTABLE BONDING)

1 TYPICAL GROUND INSTALLATION


E7.4 NOT TO SCALE. NOTE: GROUNDING TEST MUST BE BY INDEPENDENT LICENSED ELECTRICAL CONTRACTOR OR TESTING LABORATORY.

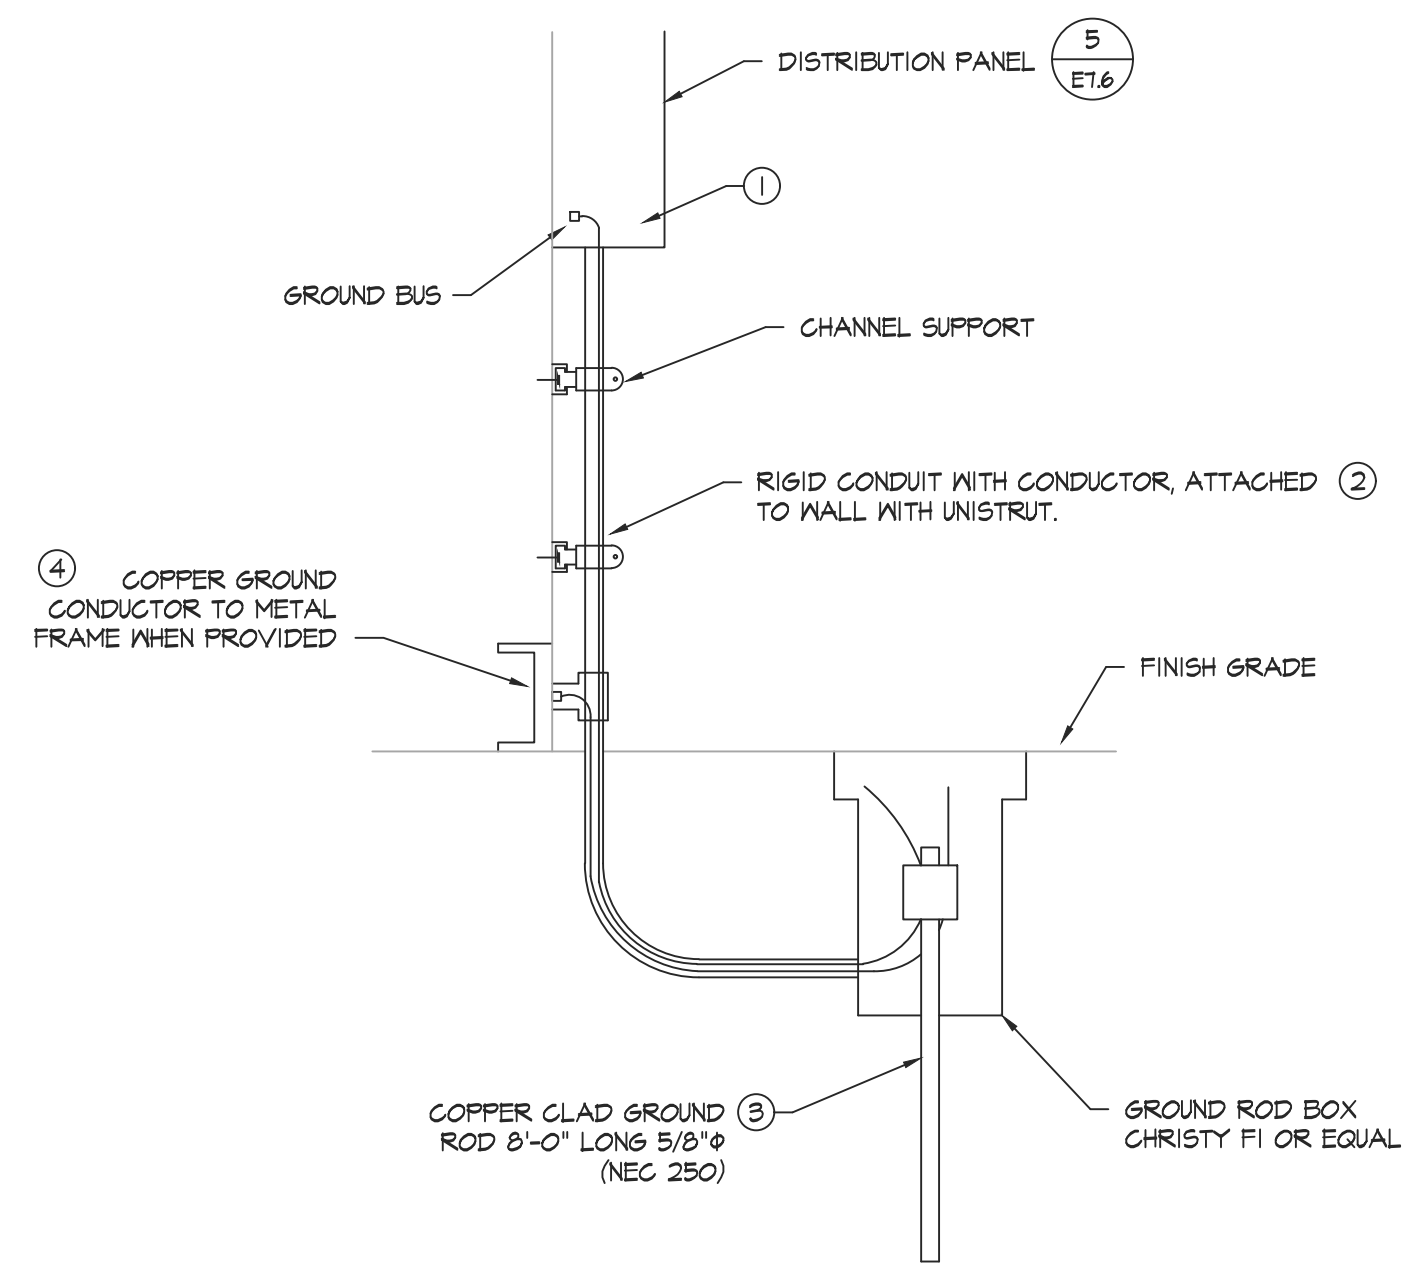

- NOTE:**
1. FOR WOOD STUD WALL: USE 3/8\"/>
 2. FOR CONCRETE WALL: 1/2\"/>

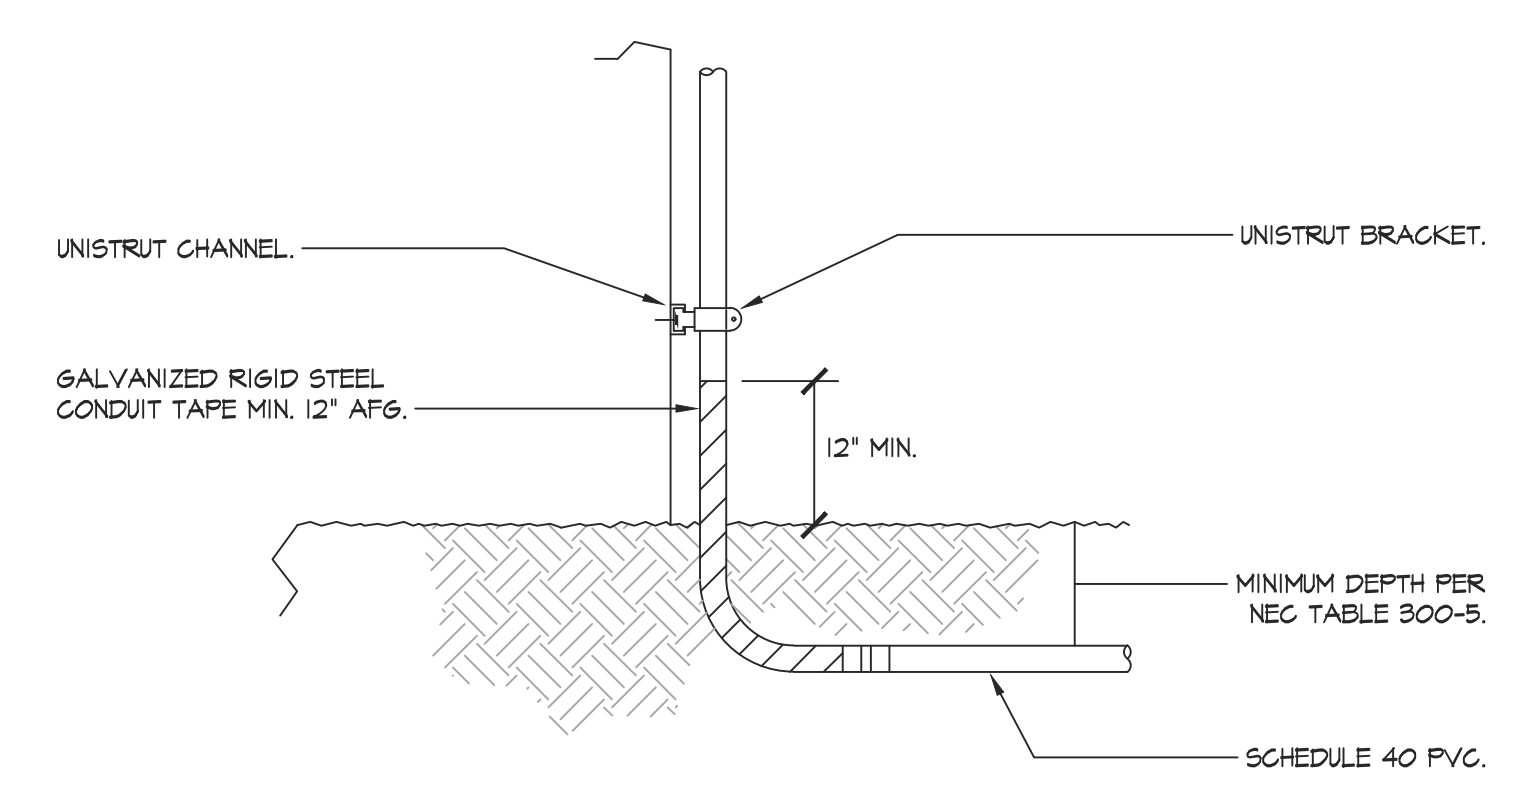2 UNDERGROUND CONDUIT RISER DETAIL


E7.4 NOT TO SCALE

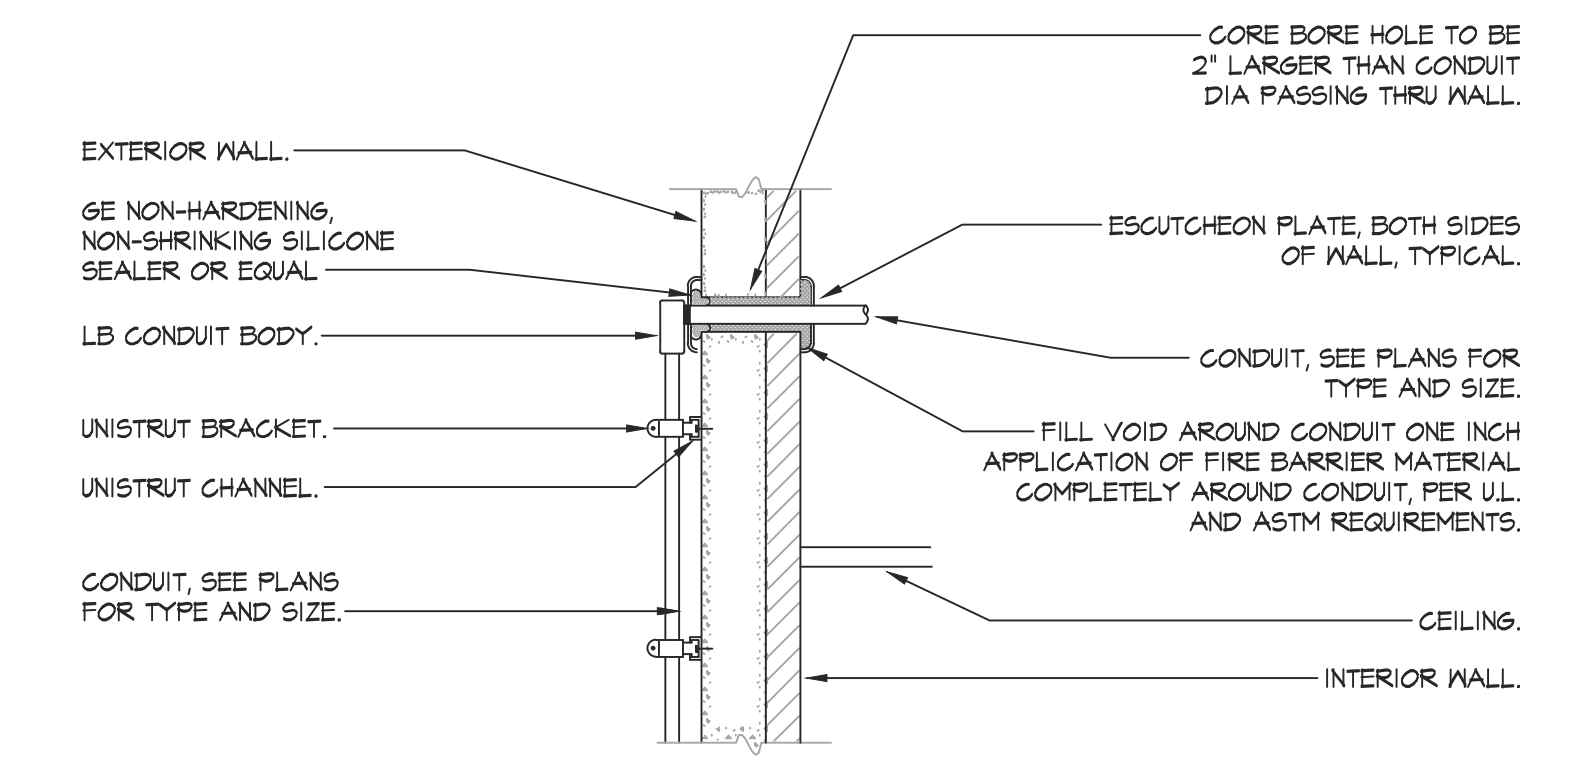

NOTE: PER U.L. FIRE RESISTANCE DIRECTORY SYSTEM #1002

3 CONDUIT WALL PENETRATION DETAIL


E7.4 NOT TO SCALE

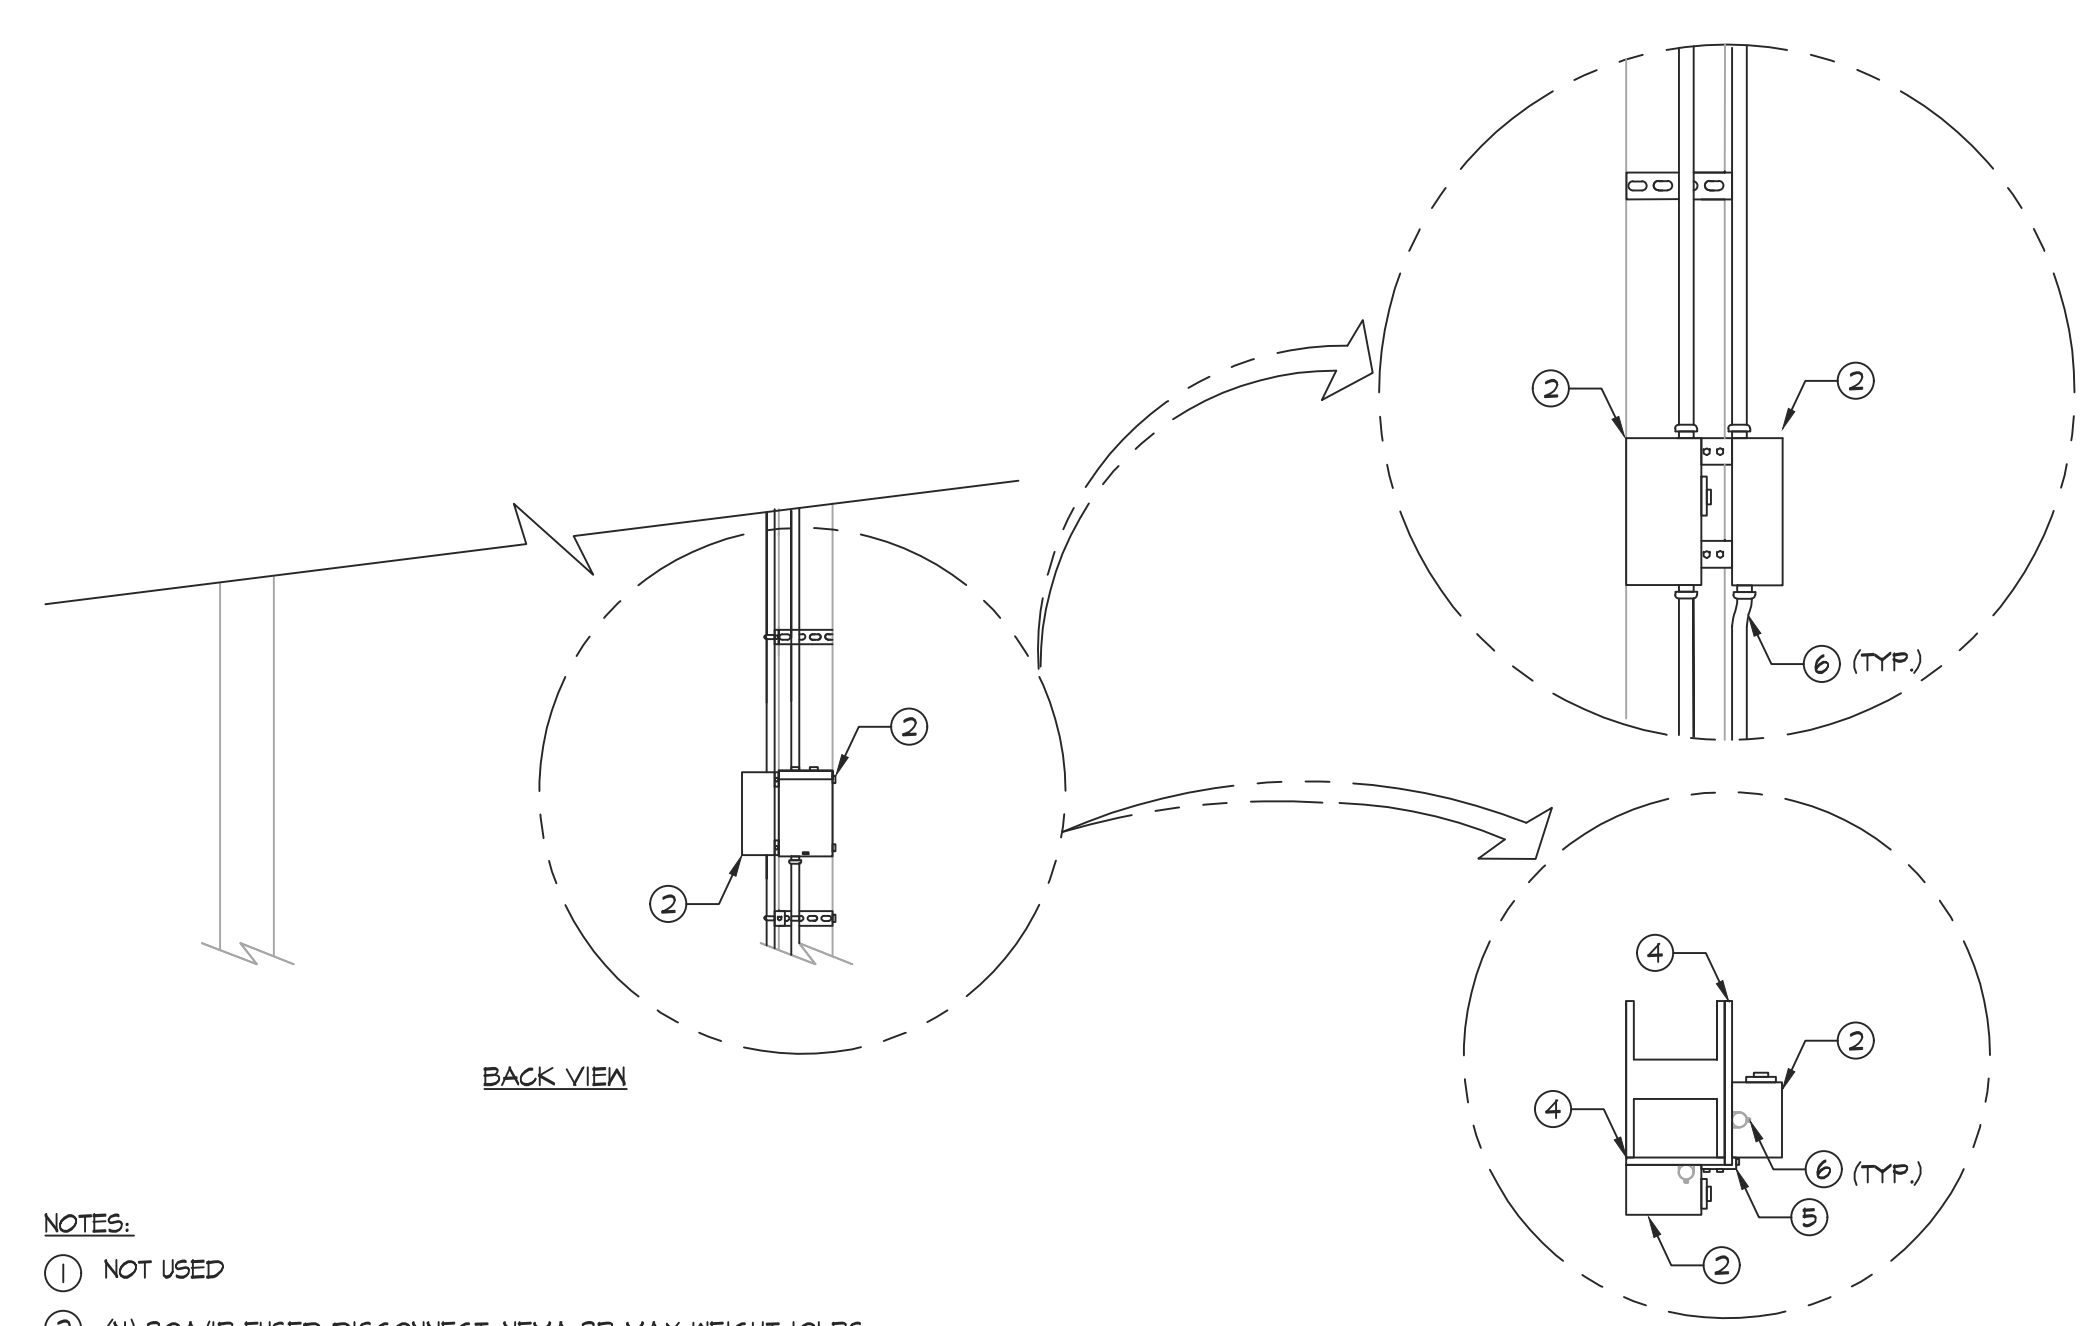

- NOTES:**
- 1 NOT USED
 - 2 (N) 30A/1P FUSED DISCONNECT, NEMA BR MAX WEIGHT 10LBS
 - 3 NOT USED
 - 4 (N) UNISTRUT MOUNTED ON H-BEAM
 - 5 (N) 3 HOLE FLUSH FITTING L - BRACKET
 - 6 (N) POWER CONDUIT


4 SCOREBOARD DISCONNECT PANEL MOUNTING

E7.4 NOT TO SCALE

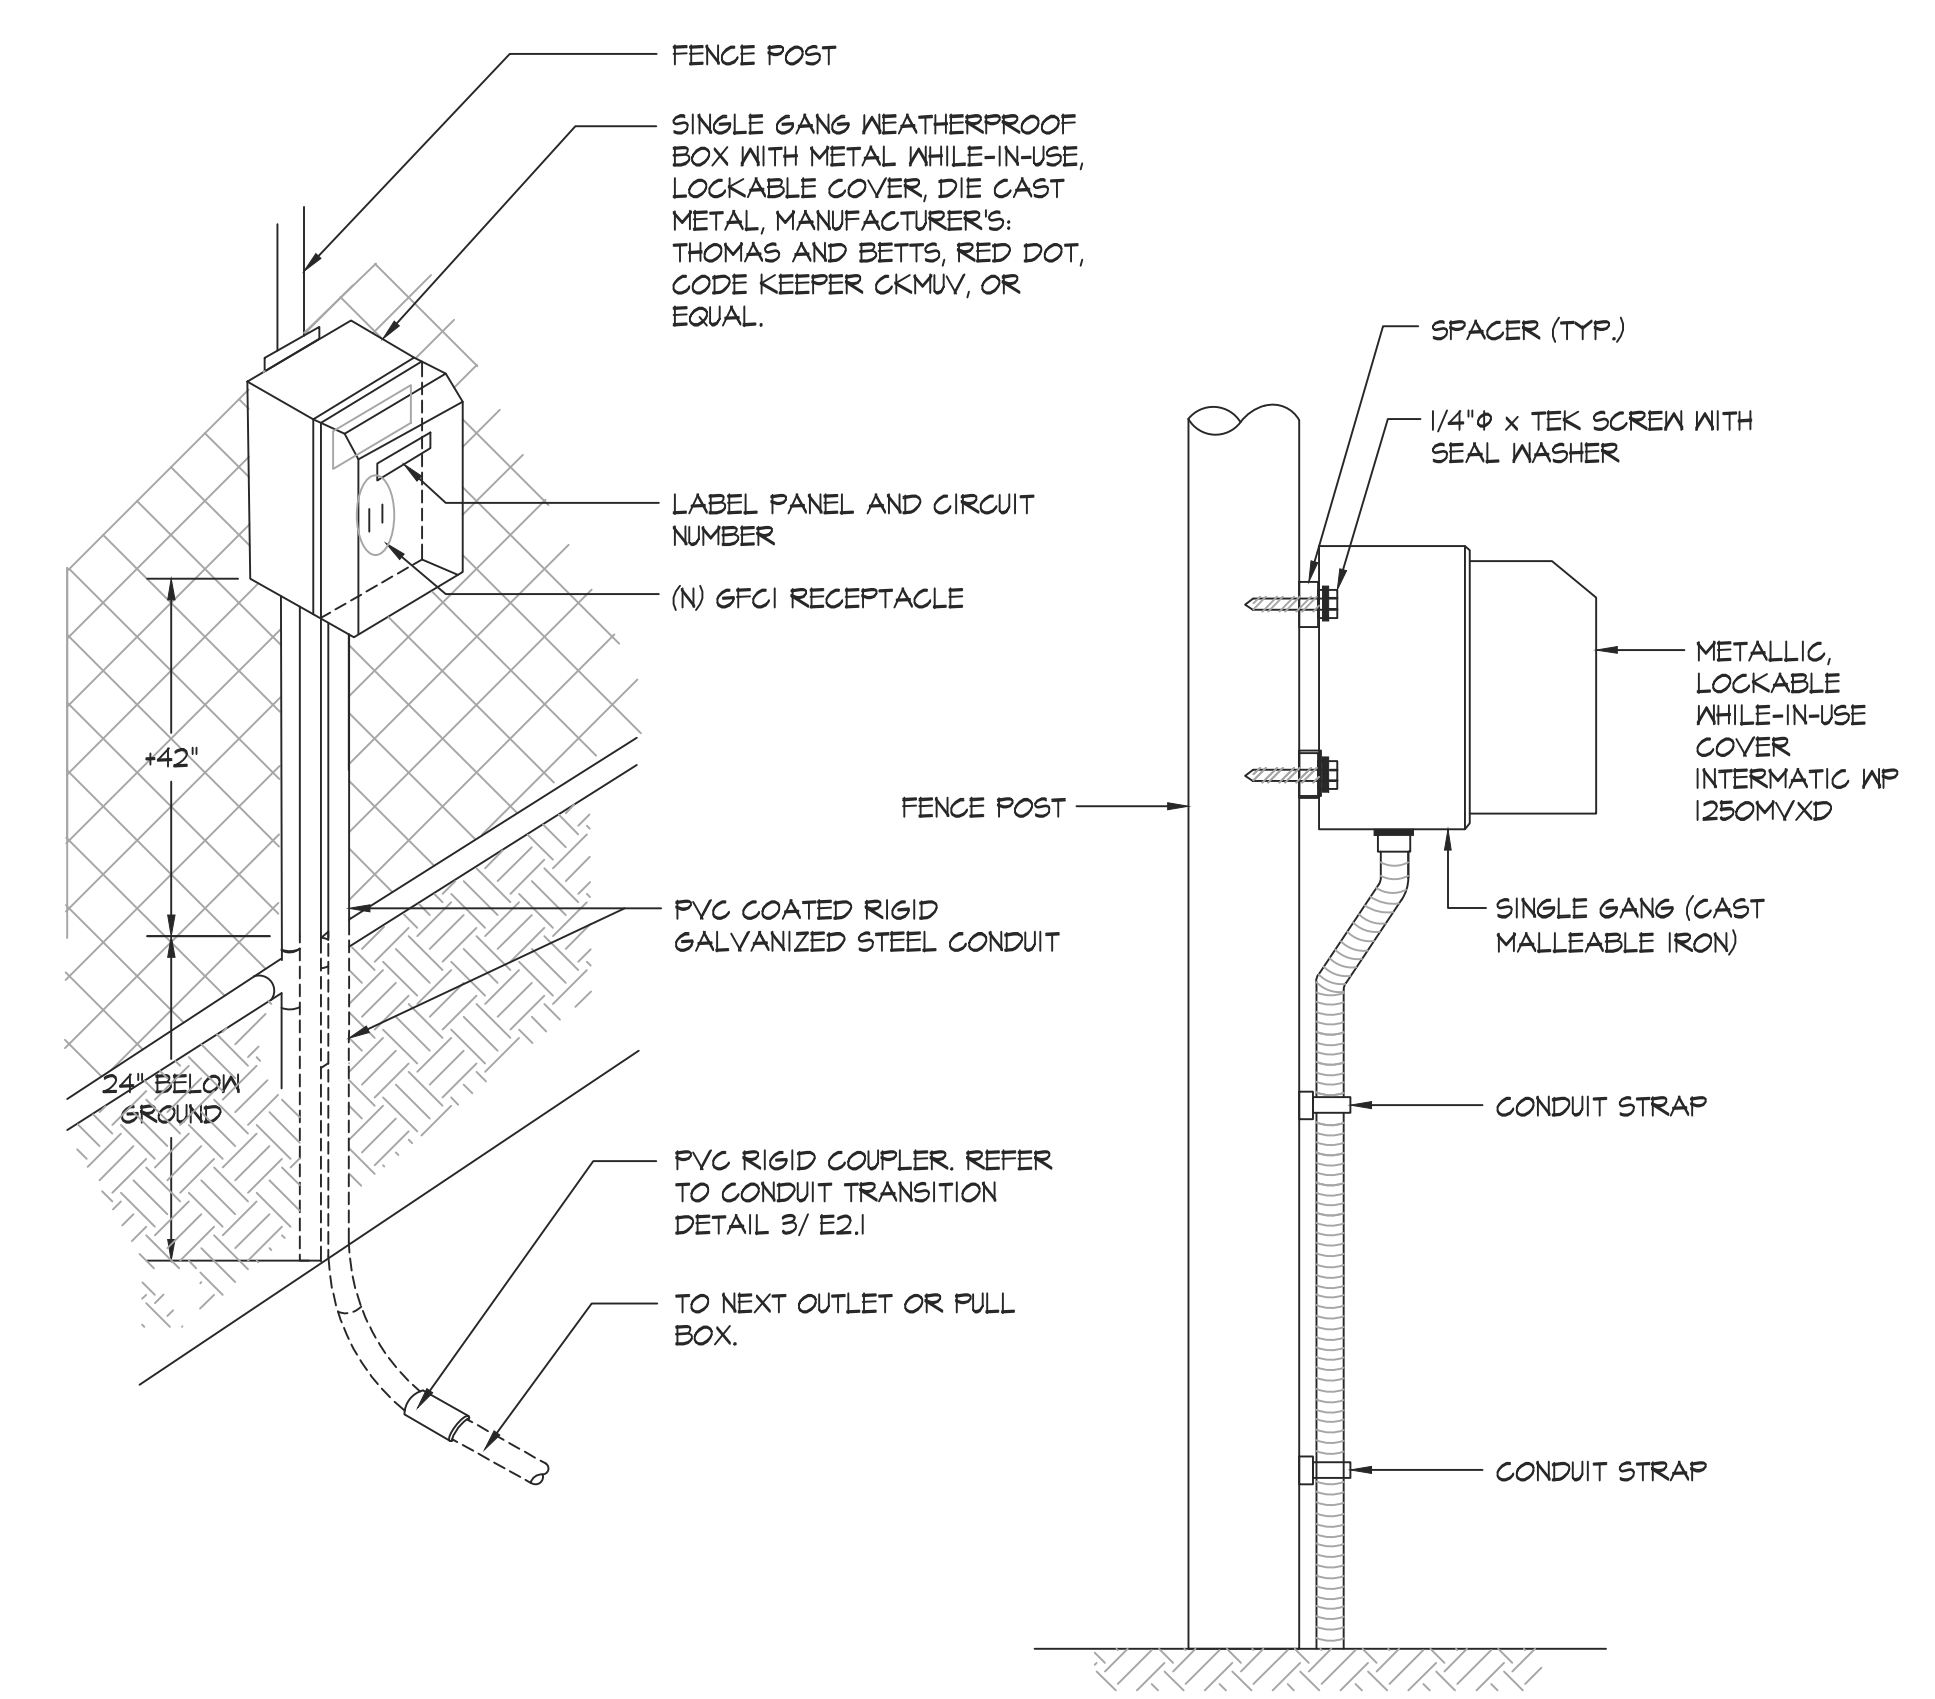

5 RECEPTACLE MOUNTING



E7.4 NOT TO SCALE

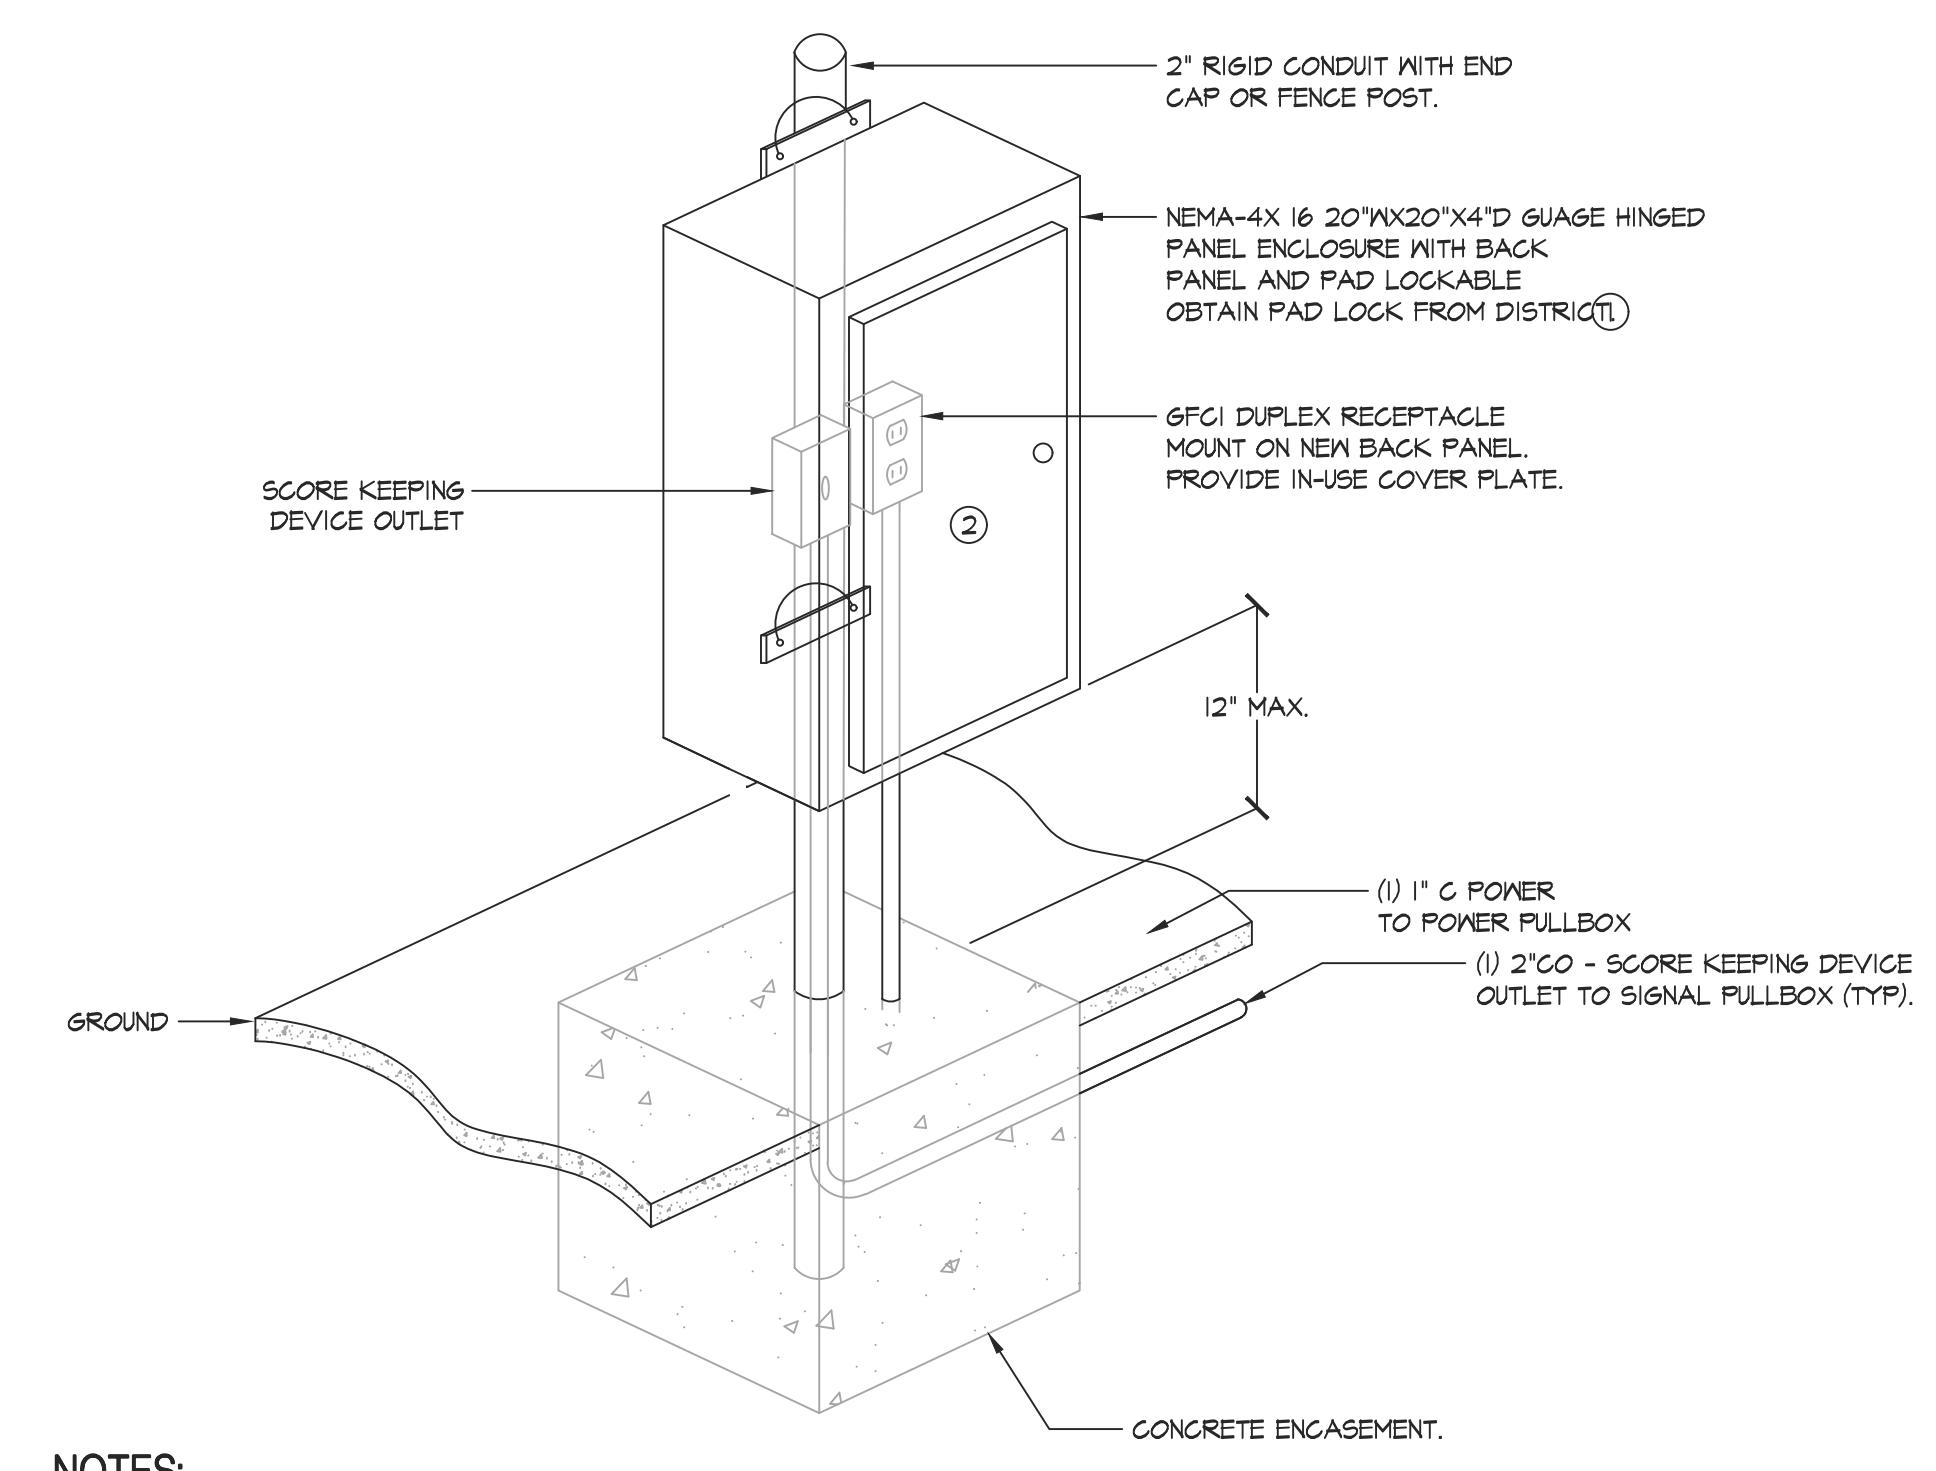

- NOTES:**
- 1 PULL GAN SHALL BE PROVIDED WITH SEPARATORS TO DIVIDE POWER & SIGNAL. PROVIDE AS REQUIRED TO COMPLY WITH N.E.C. NEMA-4X PULL GAN SHALL BE APPROVED U.L. LISTED.
 - 2 PROVIDE ENGRAVED NAME PLATE, IDENTIFY AS SCOREBOARD CONTROL. NAME PLATE SHALL BE PROVIDED PER SPECIFICATIONS.

6 METAL ENCLOSURE DETAIL

E7.4 NOT TO SCALE

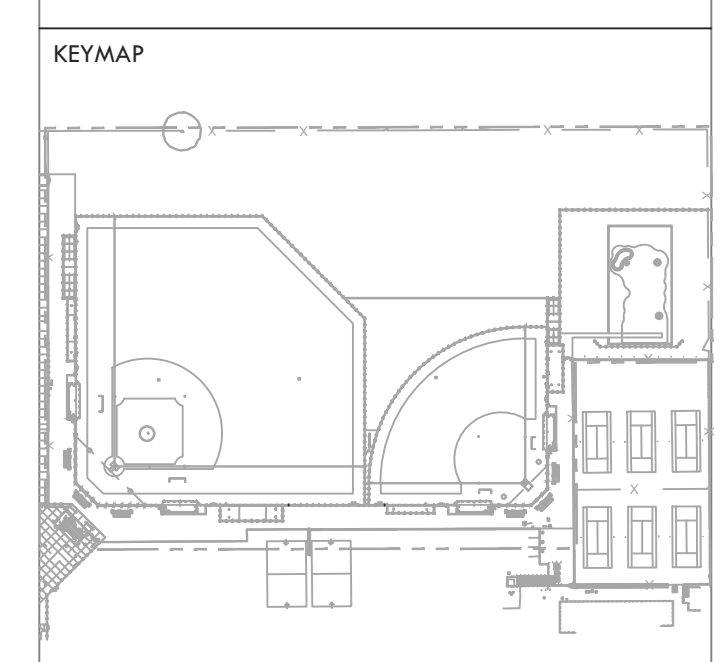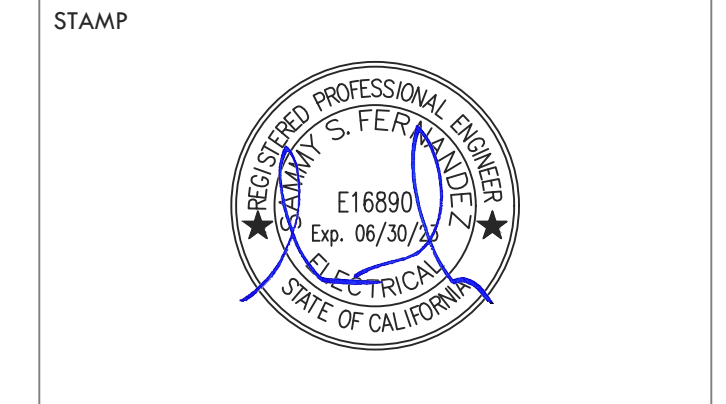

ELECTRICAL DETAILS

PROJECT NAME
 HIRAM JOHNSON HIGH SCHOOL GOLF PRACTICE FACILITY, VARSITY BASEBALL AND SOFTBALL FIELDS


PROJECT ADDRESS
 6879 14TH AVENUE SACRAMENTO, CA 95820

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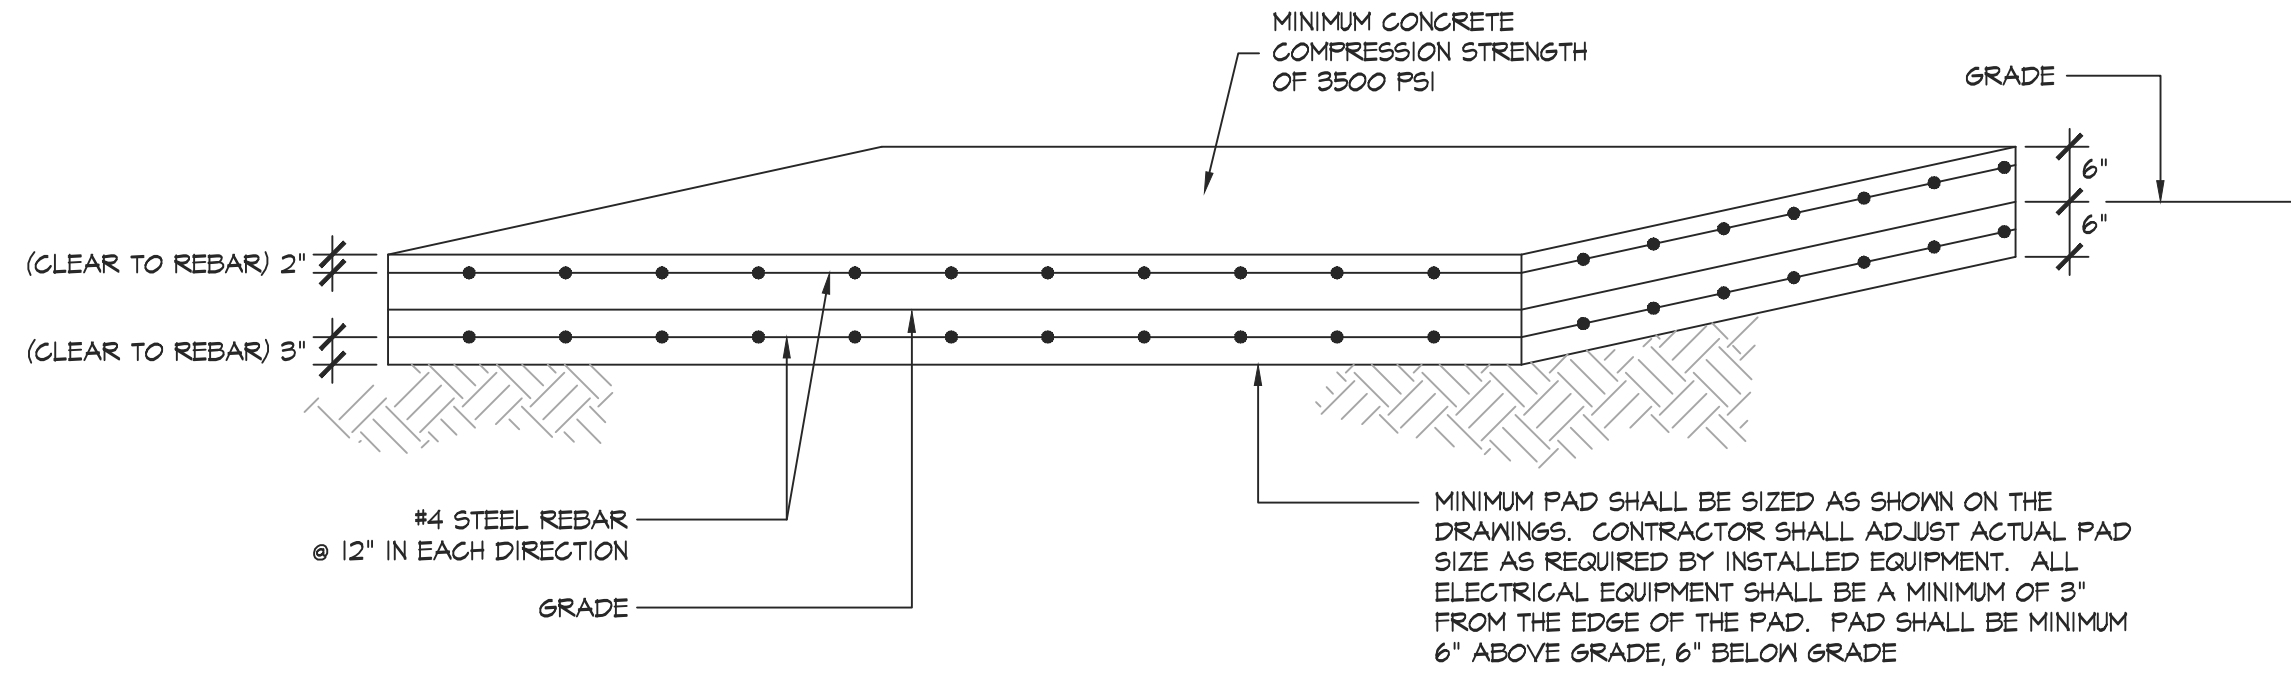
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PROJ. NO.	2203200		
SHEET NO.	E7.4 OF ELECTRICAL DETAILS		

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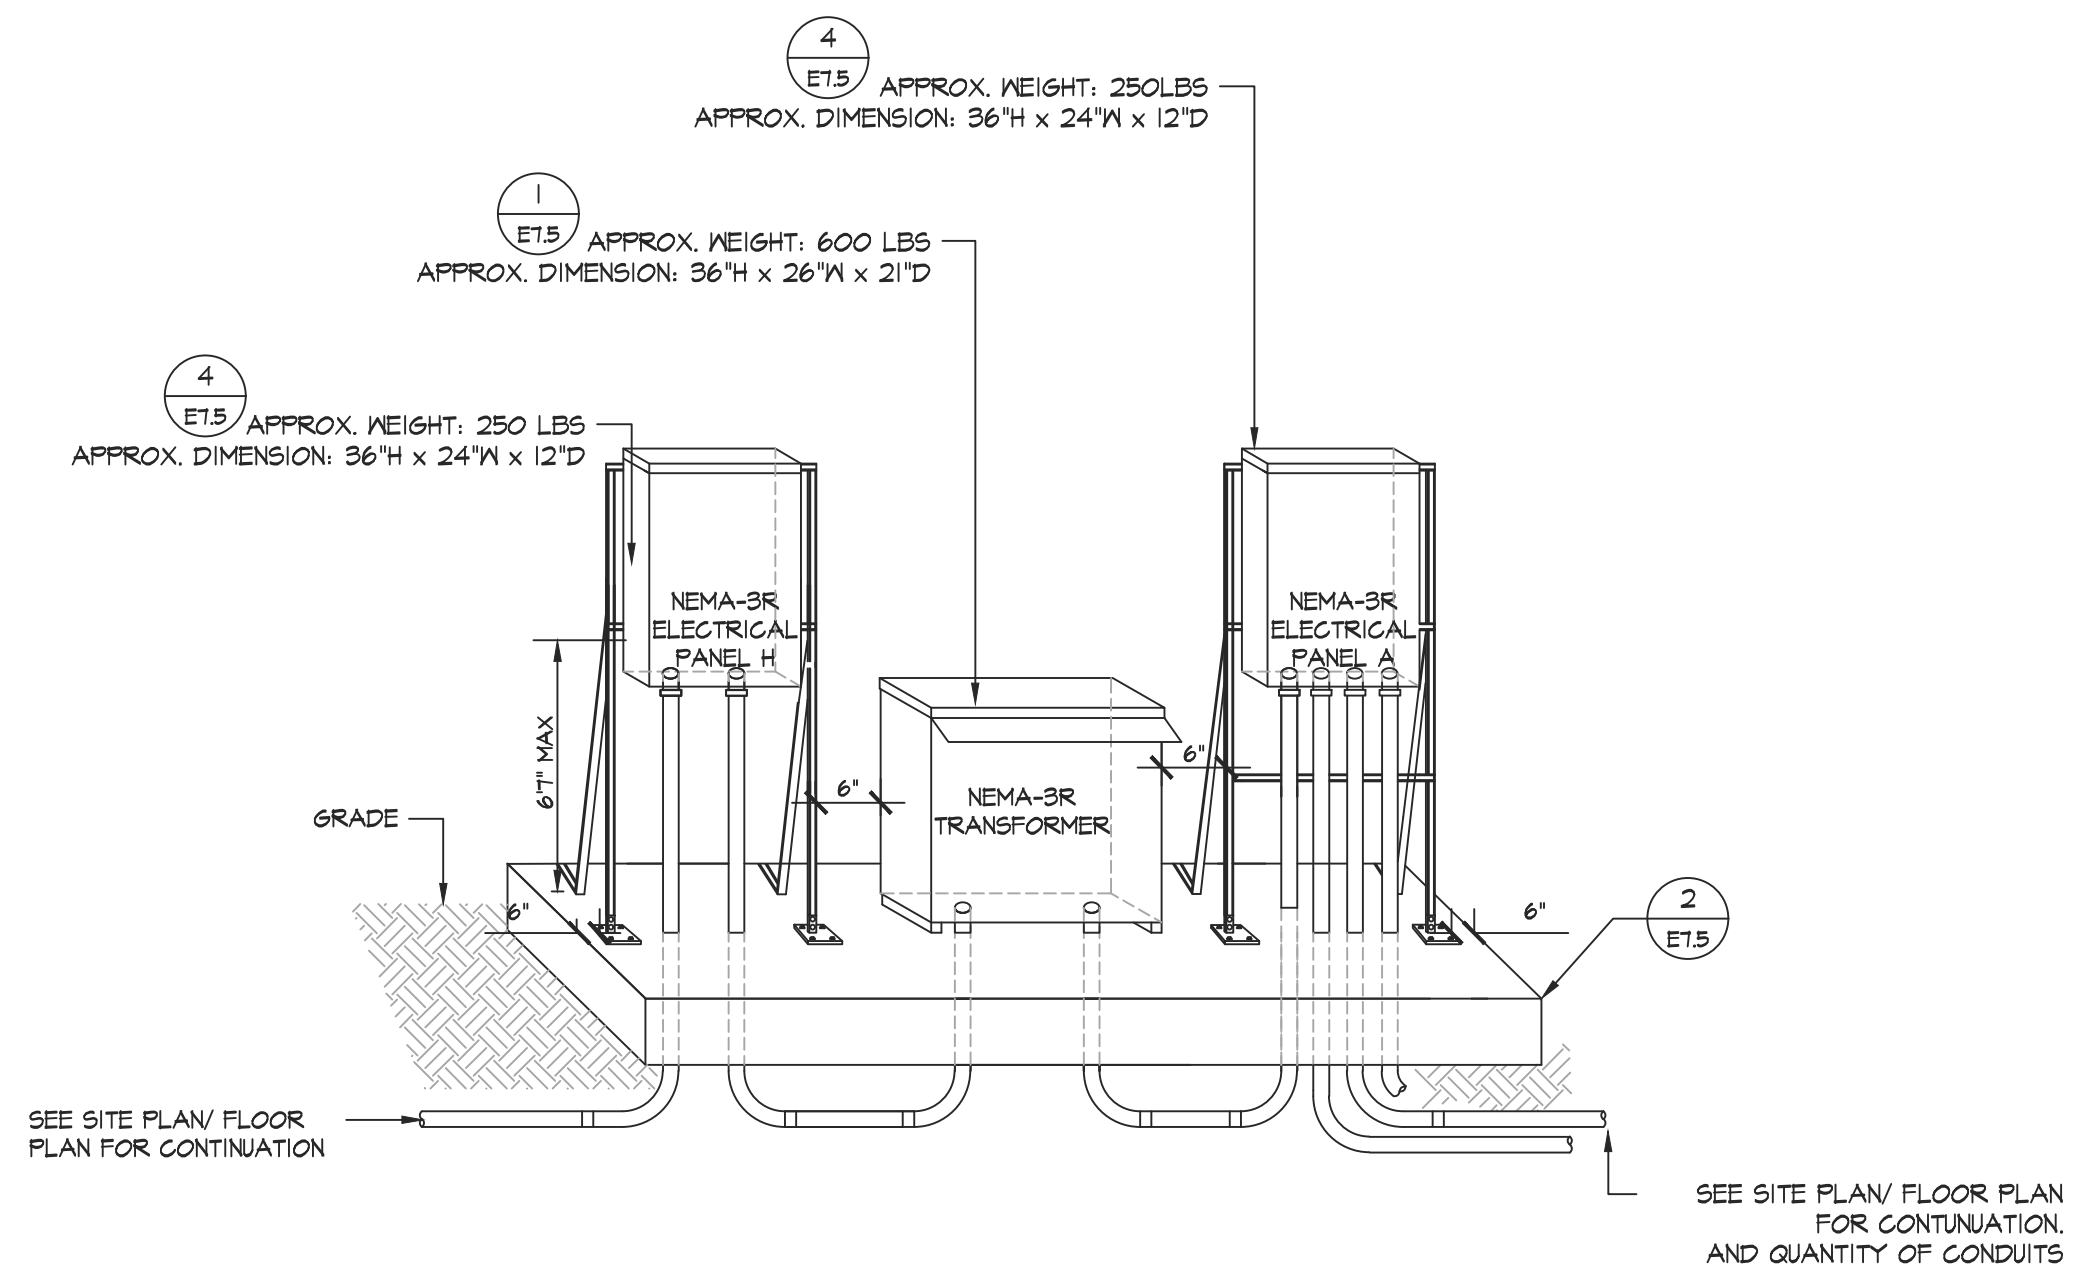
1 DISTRIBUTION TRANSFORMER INSTALLATION DETAIL

1
E7.5 NOT TO SCALE

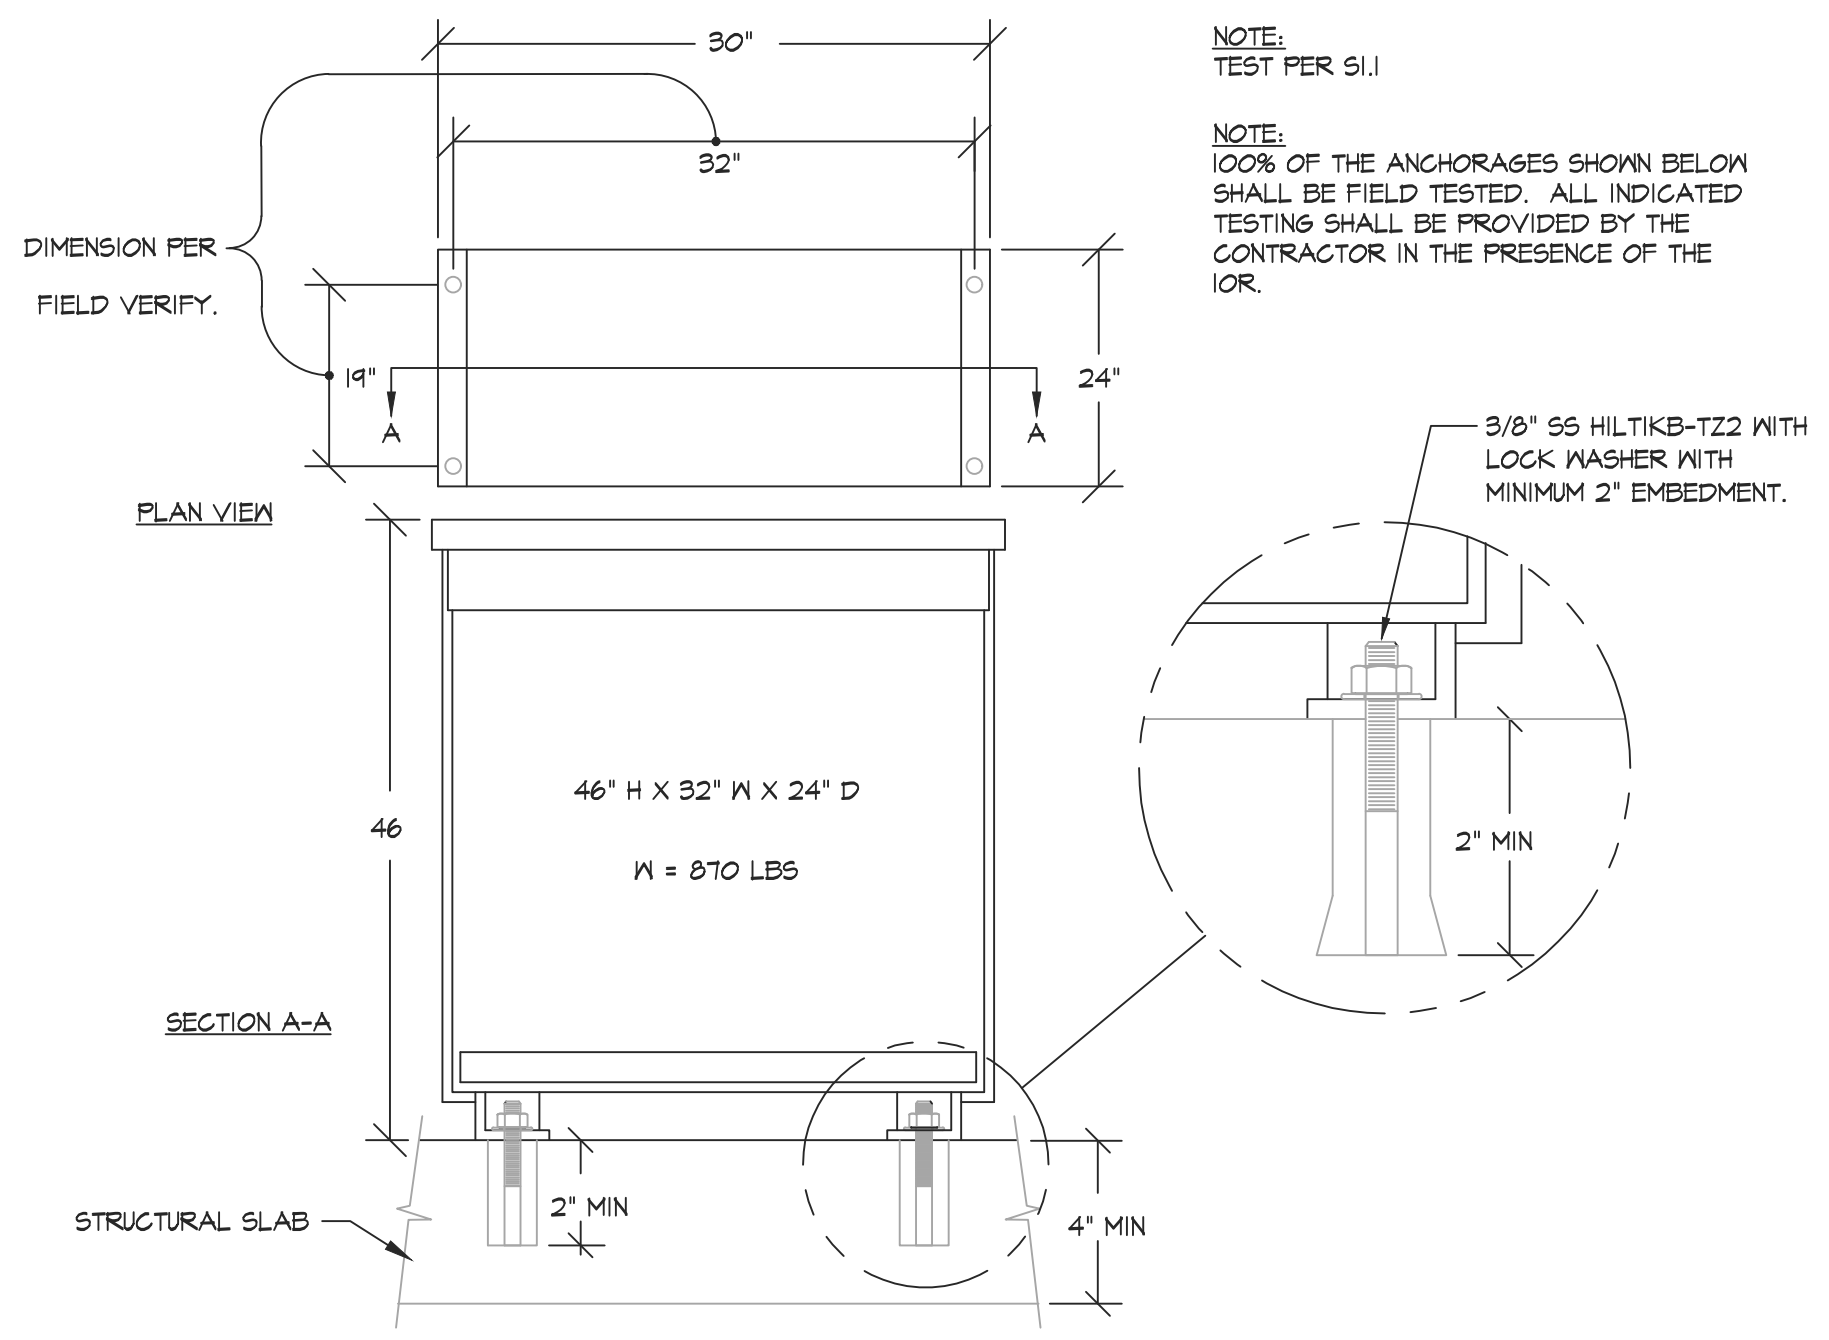


2 CONCRETE ELECTRICAL EQUIPMENT PAD

2
E7.5 NOT TO SCALE




3 NEMA 3R ELECTRICAL PANEL / TRANSFORMER / BREAKER ELEVATION DETAIL

3
E7.5 NOT TO SCALE

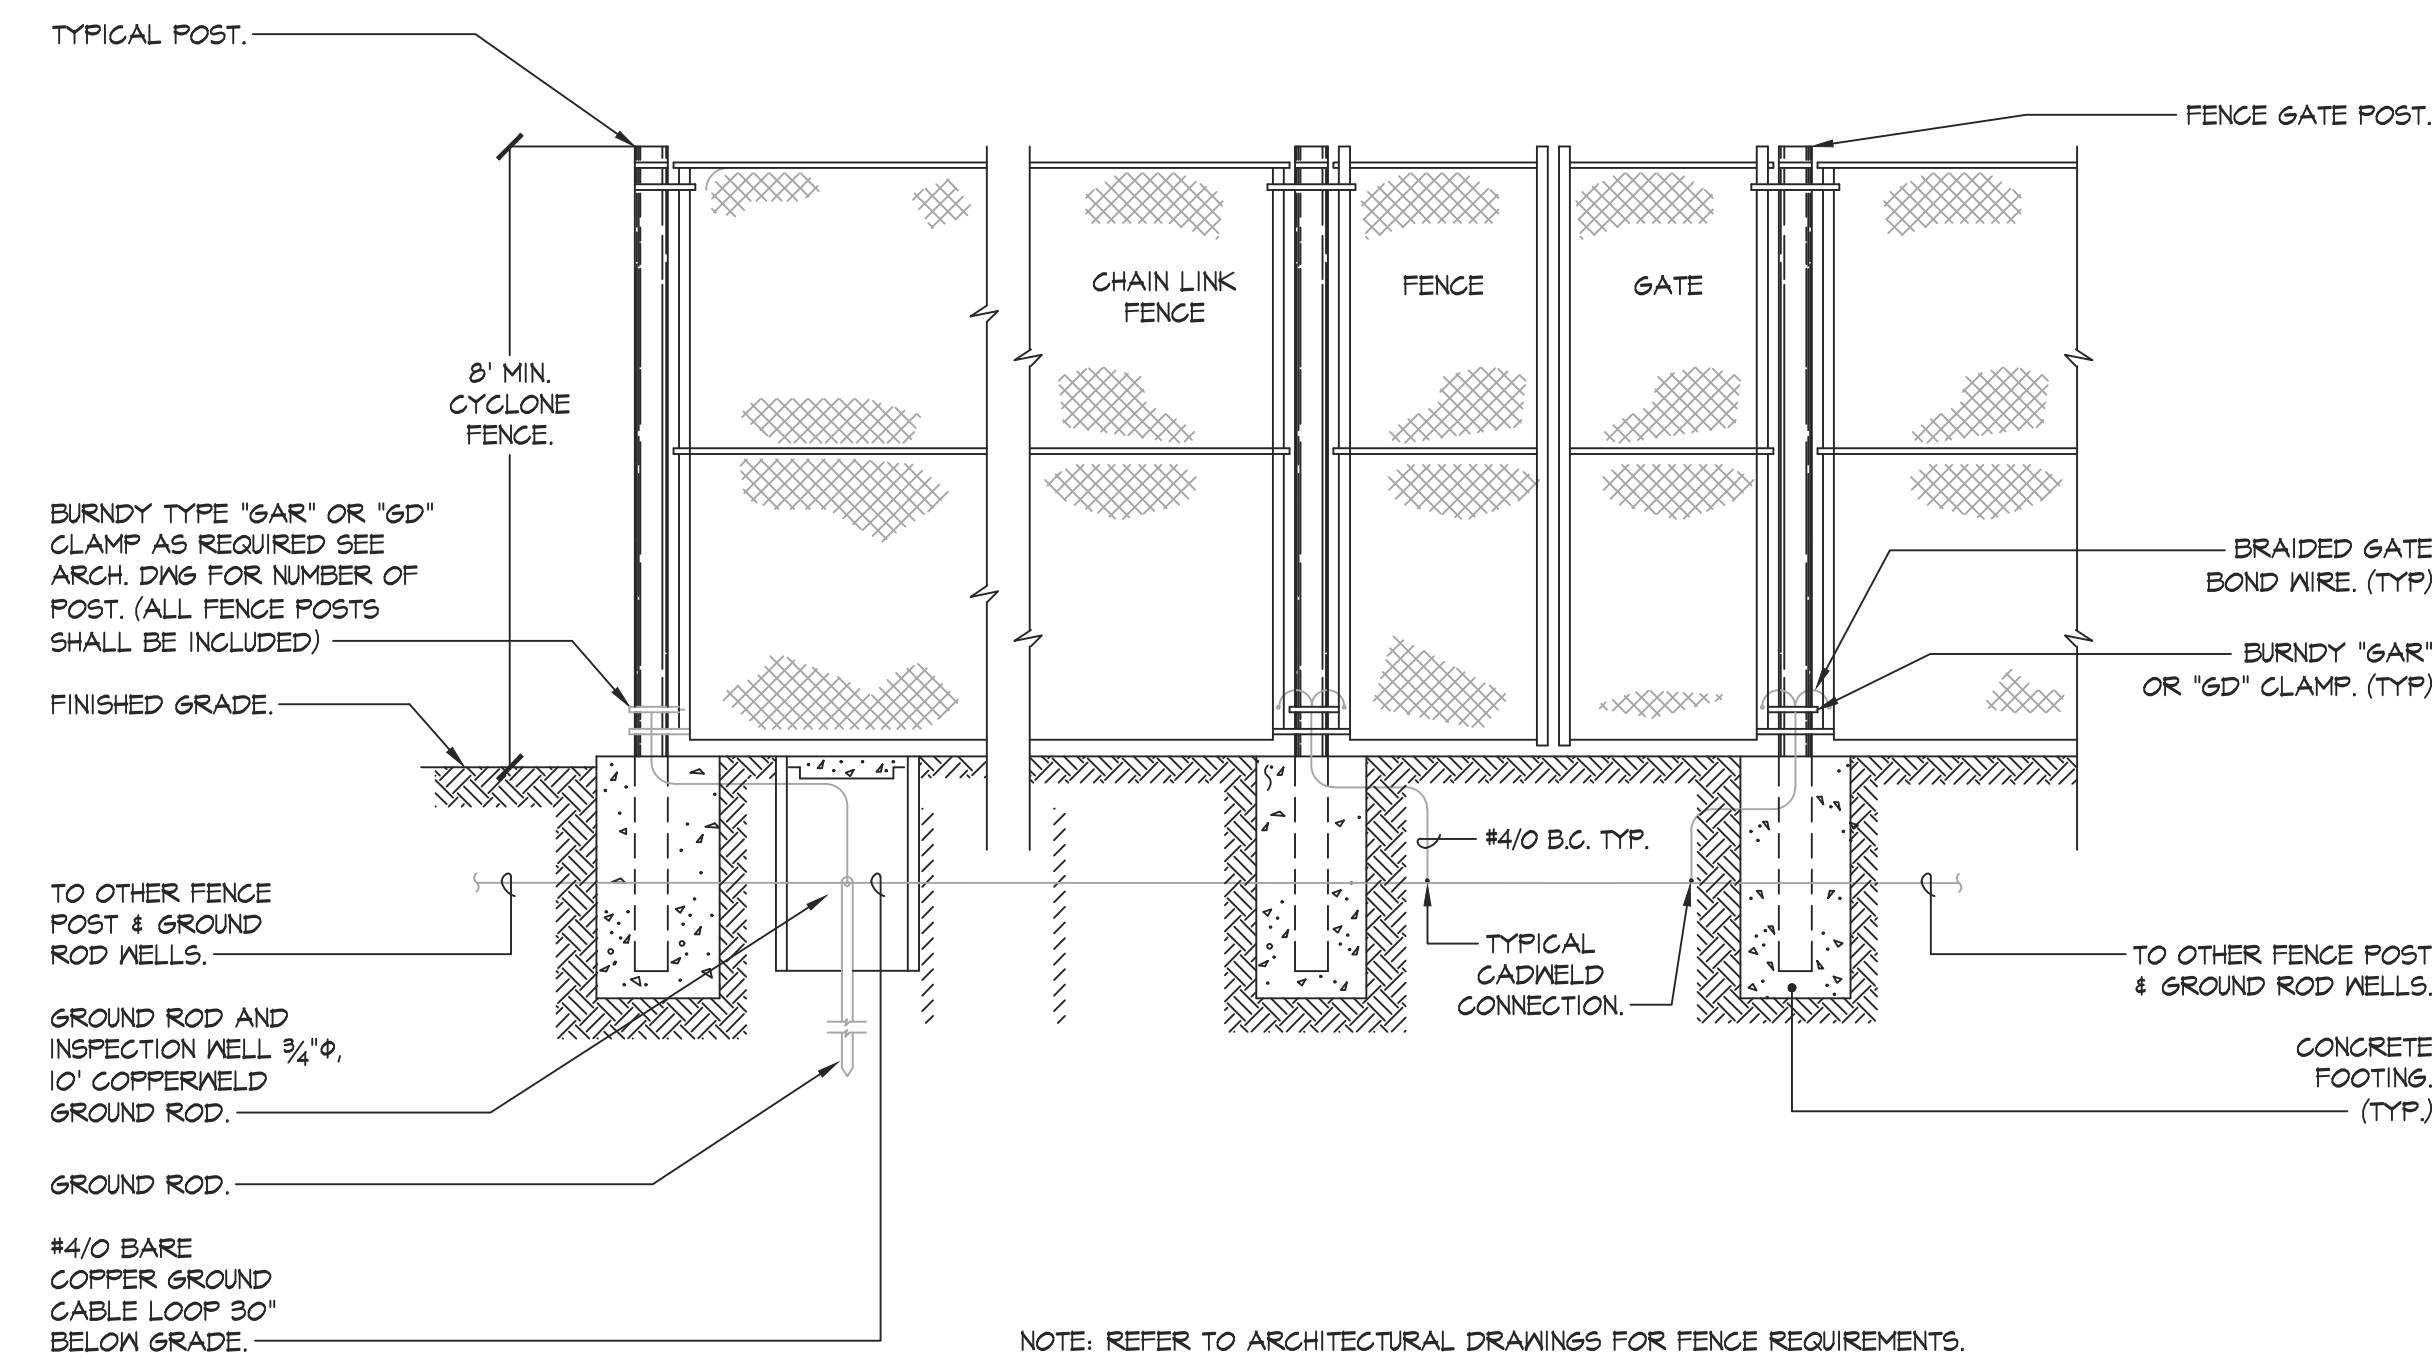


5 CHAIN LINK FENCE GROUNDING DETAIL

5
E7.5 NOT TO SCALE

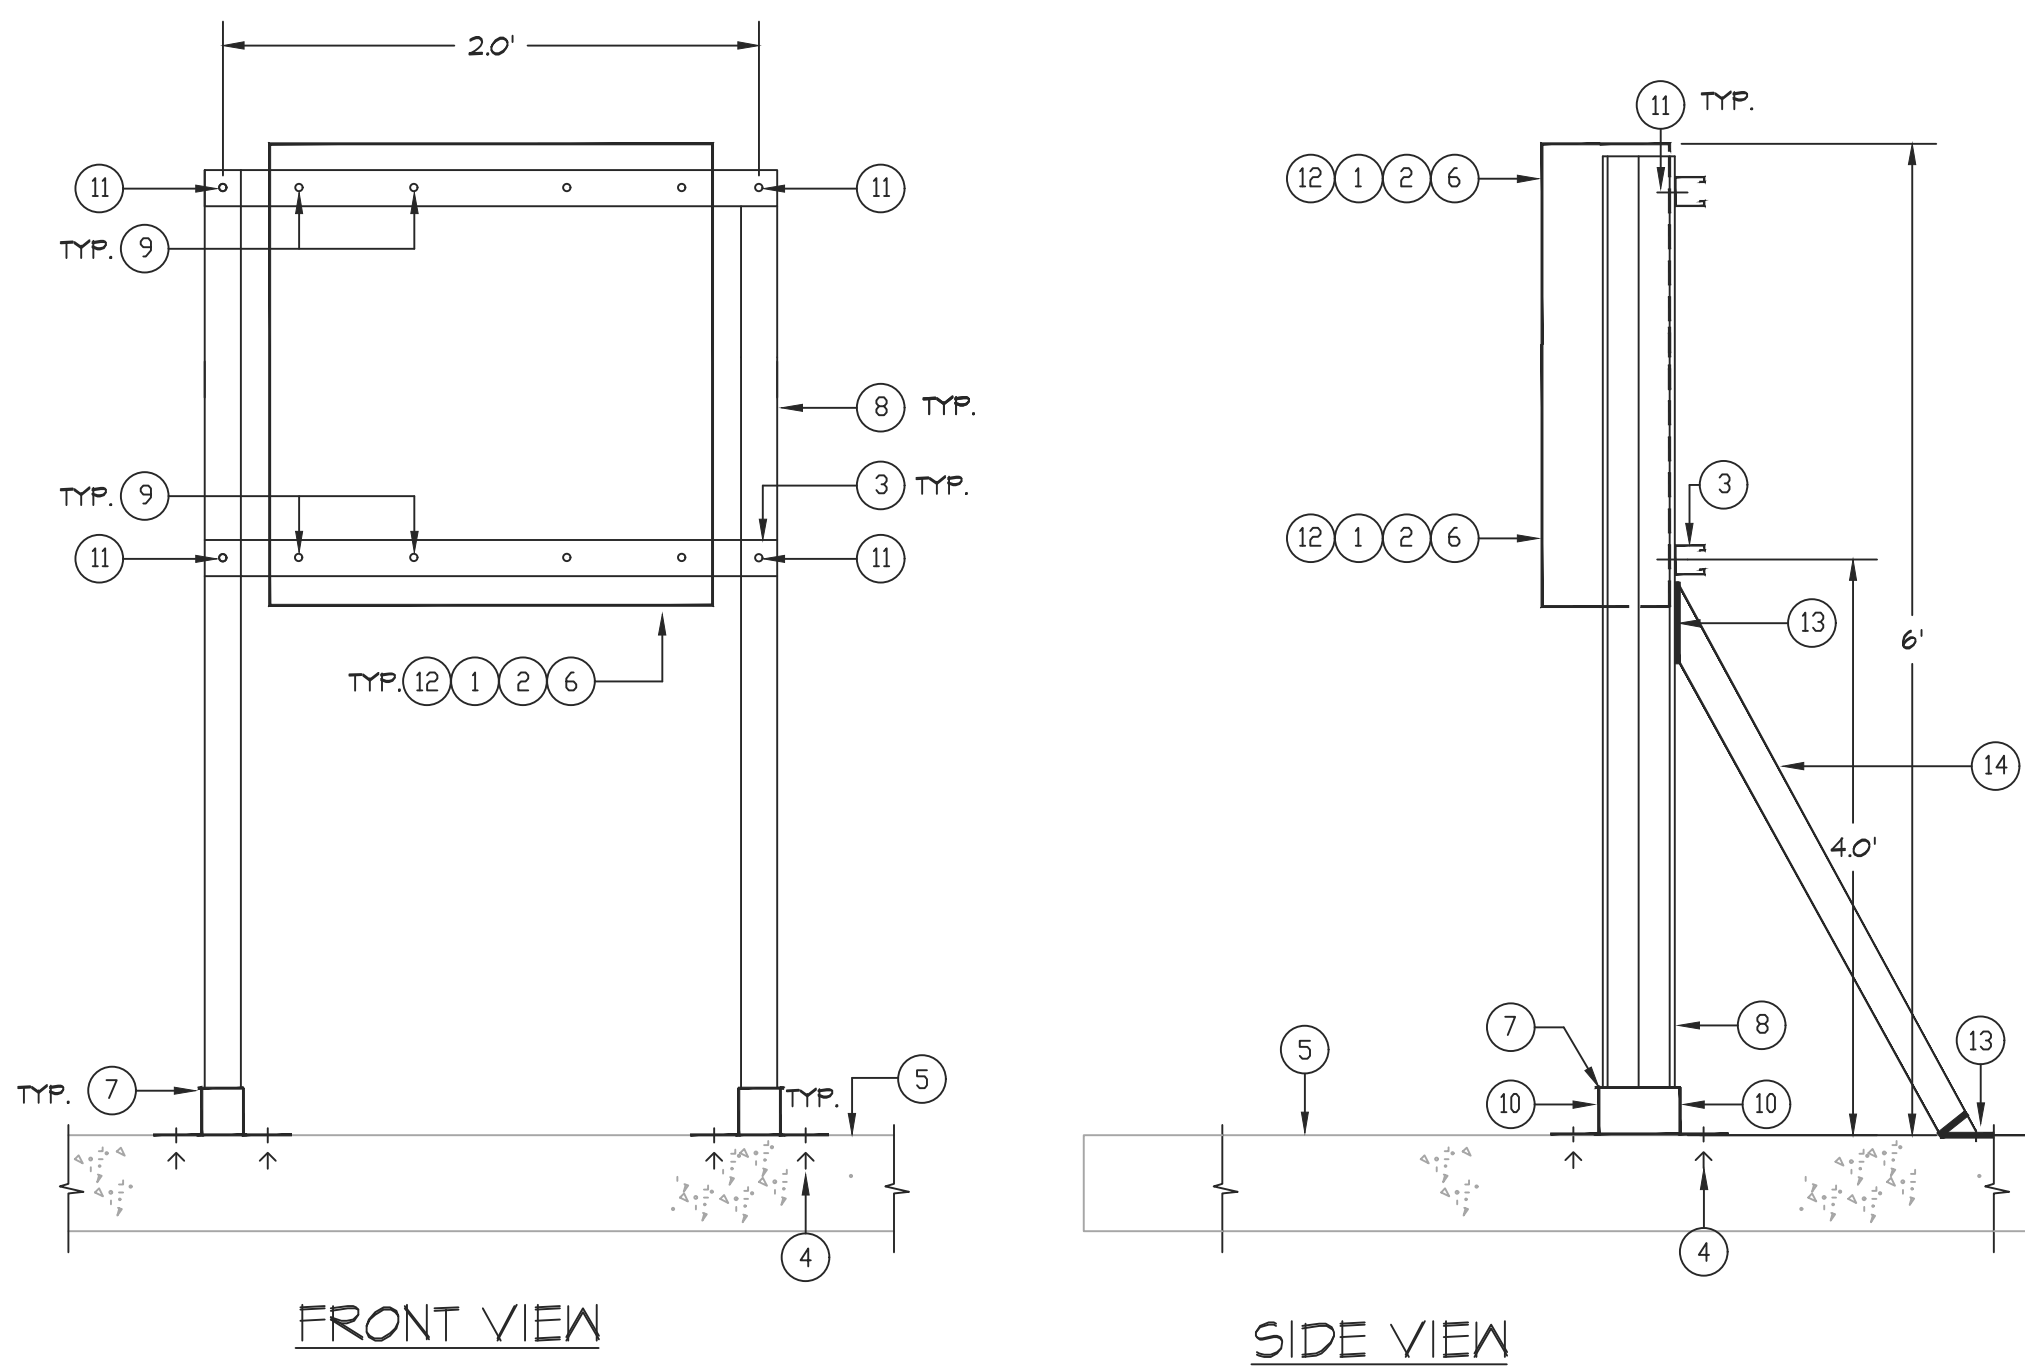

4 ENCLOSED CIRCUIT BREAKER AND PANEL INSTALLATION ON UNISTRUT DETAIL

4
E7.5 SCALE: NOT TO SCALE

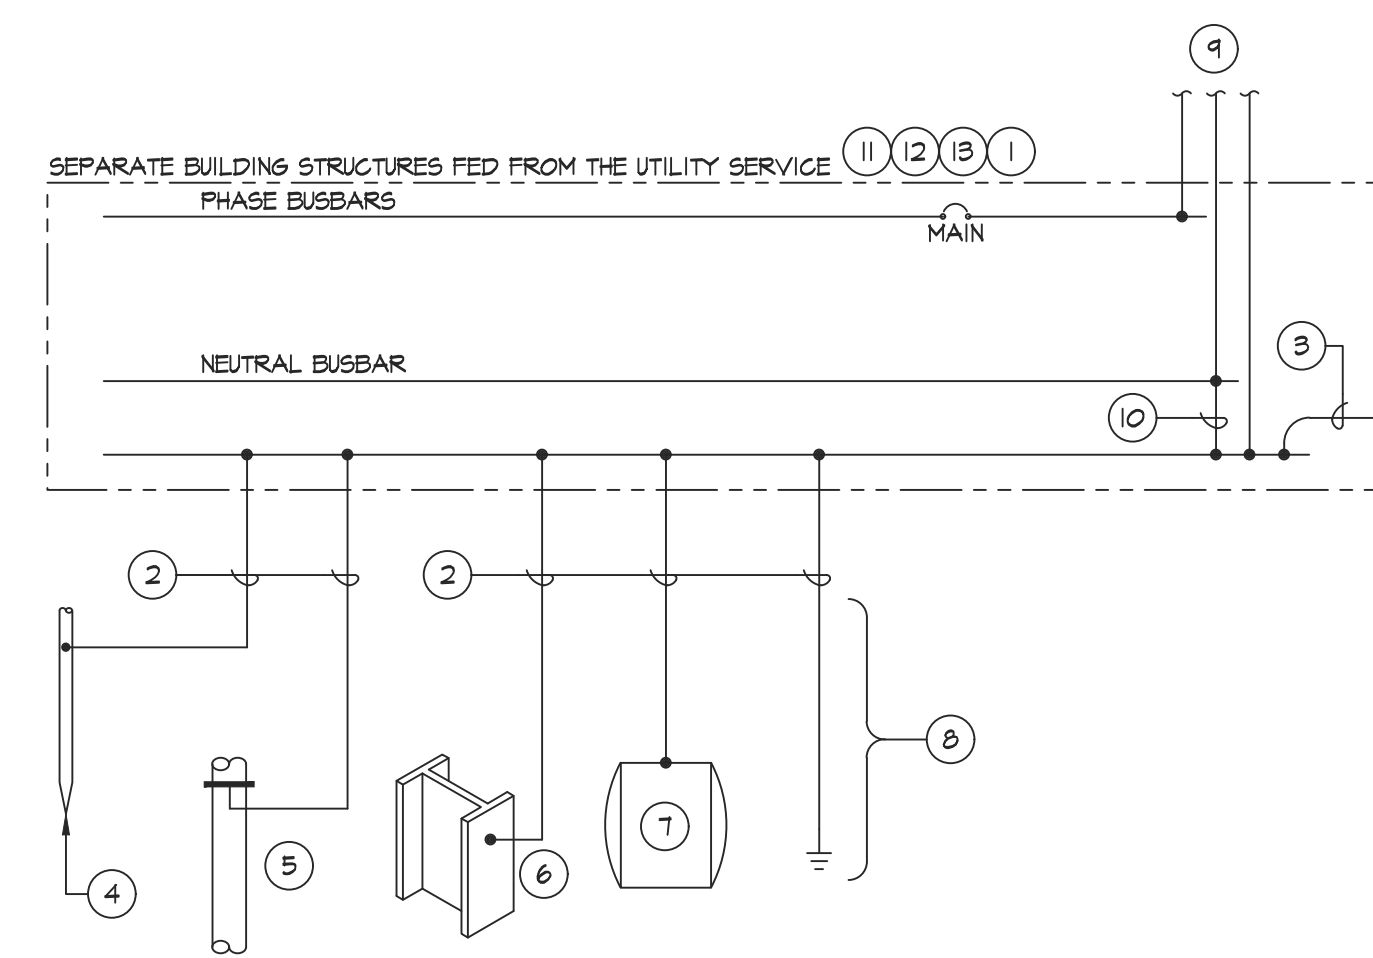

6 SEPARATE BUILDING STRUCTURES GROUNDING DETAIL FOR DISTRIBUTION BOARD


6
E7.5 NOT TO SCALE

- NOTES:**
- THE EQUIPMENT GROUNDING CONDUCTOR SHALL BE USED FOR GROUNDING OR BONDING OF EQUIPMENT STRUCTURES OR FRAMES REQUIRED TO BE GROUNDING OR BONDING (250.66). PROVIDE ALL OF THE CONNECTIONS BELOW AND BOND TO THE EQUIPMENT GROUNDING CONDUCTOR.
 - GROUNDING ELECTRODE CONDUCTOR SHALL BE BARE OR INSULATED COPPER AND SHALL BE SIZED PER TABLE 250.66.
 - EQUIPMENT BONDING JUMPER. EQUIPMENT BONDING JUMPER SHALL BE INSULATED COPPER AND SHALL BE SIZED PER TABLE 250.122.
 - PROVIDE A MINIMUM OF (1) GROUND ROD. GROUND ROD SHALL BE 10' LONG BY 3/4" DIAMETER COPPERCLAD. GROUNDING ELECTRODE CONDUCTOR SHALL BE BONDED TO THE GROUND ROD VIA EXOTHERMIC WELD. GROUND RODS SHALL BE INSTALLED IN A ROUND BOX. SEE DETAIL FOR BOX/INSTALLATION REQUIREMENTS. (PROVIDE FOR ALL NEW BUILDINGS. FOR EXISTING BUILDINGS PROVIDE WHEN ALL OTHER GROUNDING ELECTRODES ARE NOT AVAILABLE.)
 - PROVIDE GROUNDING ELECTRODE CONDUCTOR CONNECTION TO THE NEAREST UNDERGROUND WATER PIPE IN DIRECT CONTACT WITH EARTH FOR A MINIMUM OF 10 FEET. WATER PIPE SHALL BE ELECTRICALLY CONTINUOUS TO POINTS OF CONNECTION OF THE GROUNDING ELECTRODE CONDUCTOR. CONNECTION POINT SHALL NOT BE GREATER THAN 3' FROM THE POINT OF ENTRANCE OF THE UNDERGROUND WATER PIPE. (PROVIDE FOR ALL NEW AND EXISTING BUILDINGS WHERE UNDERGROUND WATER PIPE IS AVAILABLE.)
 - PROVIDE GROUNDING ELECTRODE CONDUCTOR CONNECTION TO THE NEAREST METAL FRAME OR STRUCTURAL STEEL. (PROVIDE FOR ALL NEW AND EXISTING BUILDINGS WHERE METAL FRAME OR STRUCTURAL STEEL IS AVAILABLE.)
 - PROVIDE GROUNDING ELECTRODE CONDUCTOR CONNECTION TO ALL OTHER LOCAL METAL UNDERGROUND SYSTEMS OR STRUCTURES, AS REQUIRED WHEN AVAILABLE.
 - PROVIDE A CONCRETE ENCASED ELECTRODE (FER) IN AND NEAR THE BOTTOM OF THE STRUCTURAL FOOTING OR SLAB ON GRADE THAT IS IN DIRECT CONTACT WITH EARTH. THE ELECTRODE SHALL BE A MINIMUM OF 20 FEET LONG INSIDE THE PAD, FOOTING OR SLAB. THE ELECTRODE CONDUCTOR SHALL BE BARE COPPER AND SIZED PER TABLE 250.66 BUT SHALL NOT BE LESS THAN #4AWG. (PROVIDE ONLY FOR NEW BUILDINGS)
 - INCOMING SERVICE FROM THE UTILITY SERVICE. SEE SINGLE LINE DIAGRAM FOR PHASE, NEUTRAL AND EQUIPMENT GROUNDING CONDUCTOR SIZES.
 - MAIN BONDING JUMPER.
 - PROVIDE GROUNDING ELECTRODE CONDUCTOR CONNECTION TO THE SECONDARY SIDE OF ALL WYE CONNECTED BUILDING TRANSFORMERS. GROUNDING ELECTRODE CONDUCTOR MAY BE CONNECTED TO THE NEAREST STRUCTURAL STEEL OR THE MAIN SERVICE GROUNDING ELECTRODE ONLY. SEE TRANSFORMER GROUNDING DETAIL FOR ADDITIONAL REQUIREMENTS.
 - THE CONTRACTOR SHALL BE RESPONSIBLE FOR PROVIDING ALL GROUNDING AND BONDING AS REQUIRED PER THE CEC.
 - SEE SPECIFICATIONS FOR ADDITIONAL REQUIREMENTS.

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JOB #0022049



ELECTRICAL DETAILS

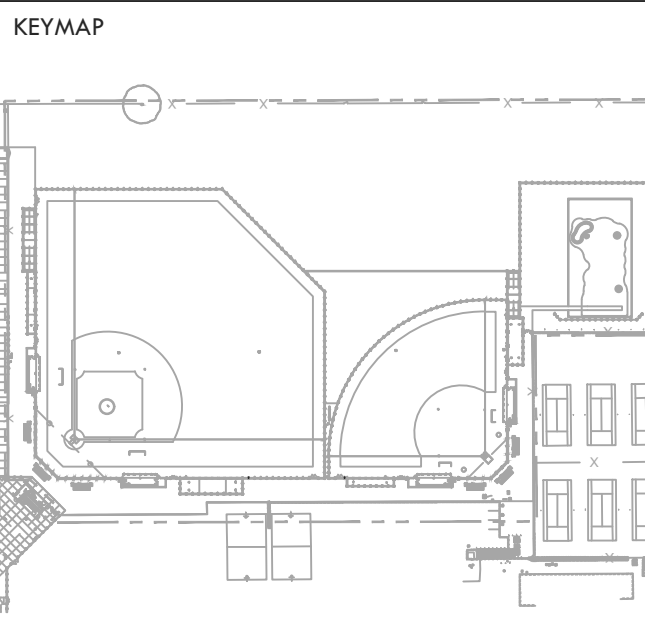HIRAM JOHNSON HIGH SCHOOL GOLF PRACTICE FACILITY, VARSITY BASEBALL AND SOFTBALL FIELDS

6879 14TH AVENUE SACRAMENTO, CA 95820

SUBMITTAL	DATE
DD 50% SUBMITTAL	04/15/22
100% DSA SUBMITTAL	05/27/22
DSA BACK CHECK	08/11/22
DSA ADDENDUM SUBMITTAL	09/16/22

NO.	REVISIONS	DATE
▲	ADDENDUM	09/16/22
▲		
▲		
▲		

DRAWN BY: CN
CHECKED BY: AA/SF
DATE ISSUED: 09/16/2022
SCALE: AS NOTED

PROJ. NO.: 2203200
SHEET NO.: **E7.5** OF ELECTRICAL DETAILS

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STRUCTURAL NOTES

GENERAL NOTES

- The following notes, typical details and schedules shall apply to all phases of this project unless otherwise shown or noted.
- Specific notes and details shall take precedence over general notes and typical details.
- All materials and workmanship shall conform to the minimum standards of the 2019 edition Title 24 of the California Building Code (CBC) and such other regulating agencies exercising authority over any portion of the work. The contractor shall have a current copy of the CBC on the job site.
- The "Contract or Construction Documents" shall consist of these notes, details, schedules, plans, and drawings.
- All specifications, including but not limited to materials and products, shall be those put forth in the "Contract or Construction Documents". No substitutions shall be permitted to be used or assumed to be used in the bidding or construction process without written approval by the Structural Engineer of Record.
- The contractor shall examine the "Contract or Construction Documents" and shall notify the Architect or Structural Engineer of Record of any discrepancies he may find before proceeding with the work.
- All information on existing conditions shown on drawings are based on best present knowledge available, but without guarantee of accuracy. The Contractor shall verify and be responsible for all dimensions and conditions at the site and shall notify the Architect or Structural Engineer of Record of any discrepancies between actual site conditions and information shown on or in the "Contract or Construction Documents" before proceeding with work.
- The Contractor shall immediately notify the Architect or Structural Engineer of Record of any condition which in his opinion might endanger the stability of the structure or cause distress of the structure.
- All work shall conform to the best practice prevailing in the various trades comprising work. The Contractor shall be responsible for coordinating the work of all trades.
- These "Contract or Construction Documents" represent the finished structure, and do not indicate the method of construction. The Contractor shall supervise and direct the work and shall be solely responsible for construction means, methods, techniques, sequences and procedures.
- Inspection and approval for fabricator's shops used for fabrication of structural load bearing members, components, materials or assemblies shall conform to CBC Section 1704A.2.5.
 - Labeling (as required or specified) shall be provided in accordance with CBC Section 1703A.5.
 - Evaluation and follow-up inspection services (as required or specified), shall conform to CBC Section 1703A.6.
- The Contractor shall provide temporary bracing and shoring for all structural members as required for structural stability of the structure during all phases of construction.
- The Contractor shall take all steps necessary to ensure proper alignment of the structure after the installation of all structural and finish materials. This shall include any necessary regrading of the structure to determine final position of the completed work.
- Observation visits to the project site by field representatives of Architect and/or Structural Engineer of Record (support services) shall not include inspections of safety or protective measures, nor construction procedures, techniques or methods. Any support services performed by Architect or Structural Engineer of Record during any phase of construction, shall be distinguished from continuous and detailed inspection services (as required by any regulating governmental agency, e.g. the Authority Having Jurisdiction) provided by others. These support services, whether of material or work, are performed solely for the purpose of assisting in quality control and in achieving conformance with contract documents, but do not guarantee Contractor's performance and shall not be construed as supervision of construction.
- These notes, details, drawings and specifications (Contract or Construction Documents) do not carry necessary provisions for construction safety. These documents and all phases of construction hereby contemplated are to be governed, at all times, by applicable provisions of the current California Occupational Safety and Health Act.
- Where any conflict occurs between the requirements of federal, state and local laws, codes, ordinances, rules and regulations, the most stringent shall govern.
- Written dimensions shall have precedence over scaled dimensions.
- Drawings (notes, schedules, details and plans) shall have precedence over Structural Calculations.
- In the event that certain features of the construction are not fully shown on the drawings or called for in the General Notes or Specifications, then their construction shall be of the same character as for similar conditions that are shown or called for.
- ASTM designation and all standards refer to the latest amendments.
- These structural "Contract or Construction Documents" shall not be modified without prior written approval of the Structural Engineer of Record.
- Only structural working drawings approved by the Authority Having Jurisdiction are permitted to be used for construction on this project. All other drawings or documents are obsolete and are not permitted on the job site, nor shall they be used for any construction purposes. Contractors using unapproved drawings or documents are solely responsible for all work not performed in accordance with the "approved" drawings.
- A Division of the State Architect certified project inspector employed by the District (Owner) and approved by the Division of the State Architect shall provide continuous inspection of the work. The duties of the inspector are defined in Section 4-342, Part 1, Title 24 California Code of Regulations.

FOUNDATION NOTES

- Basis: See Structural Design Values Chart, Sheet SB0.1 Table B
- Unexpected soil conditions: Allowable values and foundation design are based upon the minimum values provided in Table 1806A.2 of the 2019 California Building Code. See SB0.1 for values
- Excavate to required depths and dimensions (as indicated in drawings), cut square and smooth with firm level bottoms. Care shall be taken not to over-excavate foundation at lower elevation and prevent disturbing of soils around higher elevation.
- Footings shall be poured in neat excavations, without side forms whenever possible.
- Carry all foundations to required depths into compacted fill or natural soil (as per Structural Plans and Details).
- All foundation excavations shall be inspected and approved by the Inspector of Record or Geotechnical Engineer prior to forming and placement of reinforcing or concrete.
- Foundations shall not be poured until all required reinforcing steel, sleeves, inserts, conduits, pipes, etc. and formwork is properly placed and inspected by the Authority having Jurisdiction.
- The sides and bottoms of excavations which are to have concrete contact must be moistened several times just prior to pouring upon them.
- De-water footings, as required, to maintain dry working conditions.

REINFORCING STEEL

- All reinforcing steel shall be deformed intermediate grade bars conforming to ASTM A615, Grade 60 ($f_y = 60$ ksi) unless noted otherwise.
- Reinforcing steel shall not be welded, unless specifically noted otherwise.
- To hold reinforcing bars in their true position and prevent displacement, standard tie and anchorage devices must be provided. Placing of reinforcement shall conform to ACI 318-14 Section 26.6.2.
- Shop drawings for fabrication of any reinforcing steel shall be approved by Contractor and submitted to Project Specific Architect or Project Specific Structural Engineer of Record, for their review, prior to fabrication.
- Refer to typical details for minimum splice length and minimum radius of bend of reinforcing steel.
- All reinforcing steel splices shall be staggered 24", unless specifically noted or detailed otherwise.
- All reinforcing bar bends shall be made cold.
- Fabrication, erection and placement of reinforcing steel shall conform to Concrete Reinforcing Steel Institute of Standard Practice.
- Reinforcing steel shall be clean of rust, grease or other material likely to impair bond.

CONCRETE

- All concrete shall have a minimum ultimate compressive strength (f'_c) as outlined below at 28 days. All concrete shall be regular weight (unless specifically noted otherwise).
 - Concrete for footings: 4,500 psi $w/c = 0.45$ max. (see note 2)
- Maximum Fly Ash content shall be 15%, by weight, of total cementitious materials and shall conform to ASTM C618.
- All concrete work shall comply with CBC Chapter 19A and ACI 318-14 and latest edition of ACI Manual of Concrete Practice.
- Special Inspection (as required or specified) shall conform to CBC Chapter 17A.
- Cement shall be portland cement Type V and shall conform to ASTM C150.

- Aggregates shall conform to ASTM C33, provide aggregates from a single source.
- Water shall conform to ASTM C94 and be potable.
- Where not specifically detailed, the minimum concrete cover on reinforcing steel shall be:
 - Concrete cast against and permanently exposed to earth or weather: 3"
- All reinforcing steel, anchor bolts, dowels, inserts and any other hardware to be set in concrete shall be well secured in position prior to pouring of concrete.
- Vibrate all concrete as it is placed, with a mechanical vibrator operated by experienced personnel. The vibrator shall be used to consolidate the concrete, not transport it. Reinforcing and forms shall not be vibrated.
- Formwork design and removal shall conform to ACI 318-14 Section 26.11. Remove forms in accordance with the following minimum schedule:
 - Side forms of footings: Minimum 48 hours
 - Column and pier forms: 72 hours & 70% of design strength
- Concrete shall not free fall more than six feet. Use tremie, pump or other approved methods.
- Concrete shall be maintained in a moist condition for a minimum of 5 days after placement.
- The Contractor may use concrete admixtures as a construction means and methods to execute "Contract or Construction Documents". Use of admixture is solely the responsibility of the Contractor.
- Mix designs shall be prepared by an approved testing laboratory, signed by a licensed engineer and shall be submitted to the Project Specific Design Professional of Record for approval. SSG is not responsible for review or approval of site specific concrete mix design.
- Only one grade of concrete shall be allowed on project site at any one time
- Concrete strength shall be verified by standard cylinder tests (in accordance with CBC Section 1905A.1.16) made by an approved testing laboratory.
- Concrete placed when the air temperature has fallen to, or is expected to fall below 40° shall conform to ACI 318-14 Section 26.5.4, and ACI 308R-16.
- Concrete placed during hot weather shall conform to ACI 318-14 Section 26.5.5, and ACI 308R-14.
- Conduits and sleeves placed within structural concrete shall not be tied directly to structural reinforcement.
 - 1" concrete cover shall be maintained around all reinforcement.
- No stakes shall be permitted within the footing section.

DRILLED CAISSON/PIER AND GRADE BEAM NOTES

- Excavations for drilled caissons/pier shall be performed in compliance with local grading codes and ordinances as well as CBC Chapters 18A and 33A.
- Provide Special Inspection in accordance with CBC Section 1705A.B and Table 1705A.B.
- Excavations for all drilled caissons/piers shall be approved by the Project Geotechnical Engineer or Project Special Inspector prior to placing of concrete.
- Reinforcement for drilled caissons/pier shall be approved by the Structural Engineer of Record prior to placing in caisson/pier excavation.
- De-water caisson/pier footings and building excavation as required to maintain dry working conditions.
- Caisson/piers are to be poured within 24 hours after completion of drilling operation. Shoring requirements shall be determined by contractor. Contractor shall be provide fall protection and safety barriers at and near the drilled hole as required by OSHA and the Authority Having Jurisdiction.
- The Contractor shall be responsible for all shoring, bracing, etc. necessary to support cut and/or fill banks, and existing structures during excavation, and the forming and placement of concrete.
- Bottom of caissons/piers shall be thoroughly cleaned prior to placement of concrete.

STRUCTURAL STEEL AND WELDING

- All structural steel construction shall conform to AISC 360-16 and AISC 341-16.
 - Fabrication of all structural steel shall be done in the shop of an approved fabricator. Inspection and approval for fabricator's shops used for fabrication of structural load bearing members, components, materials or assemblies shall conform to CBC Section 1704A.2.5.
- All structural steel shall conform to the following specifications:
 - Angles, channels, plates, bars, rounds, and other miscellaneous shapes: Shall conform to ASTM A36 and shall have a minimum yield stress (F_y) of 36 ksi.
 - Wide-flange shapes: Shall conform to ASTM A992 and shall have a minimum yield stress (F_y) of 50 ksi.
 - Structural tubes: Shall be ASTM A500, Grade B, and shall have a min. yield stress (F_y) of 46 ksi.
- All structural steel fasteners shall conform to the following specifications:
 - Bolts shall conform to ASTM A307
 - Anchor bolts shall conform to ASTM 1155A, Grade as noted in drawings
 - Carbon steel nuts shall conform to ASTM A563
 - Stainless steel nuts shall conform to ASTM F594
 - Washers shall conform to ASTM F436
- Special Inspection shall be provided for all structural steel and welding, in accordance with CBC Chapter 17A.
- All structural steel shall be fabricated, erected and welded in accordance with AISC Specifications for Structural Steel Buildings (AISC 360-10) and Code of Standard Practice for Steel Buildings and Bridges (AISC 303-10).
- All welding shall be done by qualified and certified welders.
- Shop drawings for the fabrication of any structural steel shall be approved by the Contractor and submitted to Project Specific Architect or Project Specific Structural Engineer of Record for their review, prior to fabrication.
- No holes other than those specifically detailed shall be allowed through structural steel members. Burning of holes is not permitted.
- All welding shall conform to 'AWS D1.1' specifications for welding. (E-70XX Electrodes).
- Where fillet weld size is not indicated, use 'AWS' minimum size based on the thickness of the thinner part being welded, as specified in AISC Specifications for Structural Steel Buildings (AISC 360-10), Section 12.2.
- All butt welds to be complete joint penetration, unless specifically noted otherwise.
- Welder qualification requirements, welding procedure and welding electrodes for all structural steel (except structural sheet steel, see steel decking) shall conform to CBC Sections 1705A.2.1 and 2204A.1.
- Provide 3" minimum concrete cover around all structural steel below grade.
- Structural steel embedded into concrete shall be uncoated.
- Structural steel shall be hot-dip galvanized (minimum ASTM A123 or A153 Class D) or painted with zinc-rich primer, undercoat, and finish coat; or equivalent paint system.
- All exposed steel fasteners, including cast-in-place anchor bolts/rods, shall be stainless steel (Type 304 minimum), hot-dip galvanized (ASTM A153, Class D minimum or ASTM F2329), or protected with corrosion-preventive coating that demonstrated no more than 2% of red rust in minimum 1,000 hours of exposure in salt spray test per ASTM B117. Zinc plated fasteners do not comply with this requirement.


ABBREVIATIONS

A.B.	Anchor Bolt	HORIZ.	Horizontal
ABV.	Above	HSS	Hollow Steel Section
ACI	American Concrete Institute	HT.	Height
ADJ.	Adjacent		
AHJ	Authority Having Jurisdiction	ICC	International Building Code
AISC	American Institute of Steel Construction	ICC	International Code Council
AOR	Architect of Record	ID	Inside Diameter
APPROX.	Approximately	IN.	Inch, Inches
ASCE	American Society of Civil Engineers	INT.	Interior
ARCH.	Architect, Architecture	ksi	Kips per Square Inch
ASTM	American Society of Testing and Materials	LL	Live Load
ATR	All Thread Rod		
AWS	American Welding Society	MAX.	Maximum
		MB	Machine Bolt
B.O.	Bottom of _____	MFR.	Manufactured, Manufacturer
BOT.	Bottom	MIN.	Minimum
b/t	Between	MPH	Miles per Hour
CAC	California Administrative Code	N/R	Not Required
CBC	California Building Code	N.T.S.	Not to Scale
CIP	Cast-in-place		
CJP	Complete Joint Penetration	o.c.	On Center
CL	Centerline	o/	Over
CL.R.	Clear	OD	Outside Diameter
COL.	Column		
CONC.	Concrete	PEN.	Penetration
CONN.	Connection	PL	Plate
CONST.	Construction	PIP	Partial Joint Penetration
CONT.	Continue, Continuous	psi	Pounds per Square Inch
		PSF	Pounds per Square Foot
Ø	Diameter		
DBL.	Double	REBAR	Reinforcing Bar
DET.	Detail	REINF.	Reinforcement
DL	Dead Load	REQD	Required
DSA	Division of State Architect		
DWGS.	Drawings	S.F.	Square Feet
		SHT.	Sheet
EA.	Each	SIM.	Similar
E.F.	Each Face	SMS	Sheet Metal Screw
ELEC.	Electric, Electrical	sq	Square
ELEV.	Elevation	STAG'D	Staggered
EMBED.	Embedded, Embedment	STD.	Standard
EOR	Engineer of Record	STL	Steel
EQ	Equal	SEOR	Structural Engineer of Record
EQUIP.	Equipment		
E.S.	Each Side	T&B	Top and bottom
E.W.	Each Way	THR'D	Threaded
EXT.	Exterior	T.O.	Top of _____
		TYP.	Typical
FAB.	Fabricated	U.N.O.	Unless Noted Otherwise
FDN.	Foundation		
F.G.	Finish Grade	VERT.	Vertical
F.O.	Face of _____	VIF	Verify in Field
FRMG.	Framing		
FT.	Foot, Feet	w/	With
FTG.	Footing	w/c	Water/Cement Ratio
		WSS	Welded Steel Stud
GA.	Gauge	WT.	Weight
GALV.	Galvanized		
GEOR	Geotechnical Engineer of Record		

NOTE: FOR TESTING & SPECIAL INSPECTIONS SEE FORM DSA 103 SUBMITTED SEPARATELY



DATE SIGNED: 11.20.20
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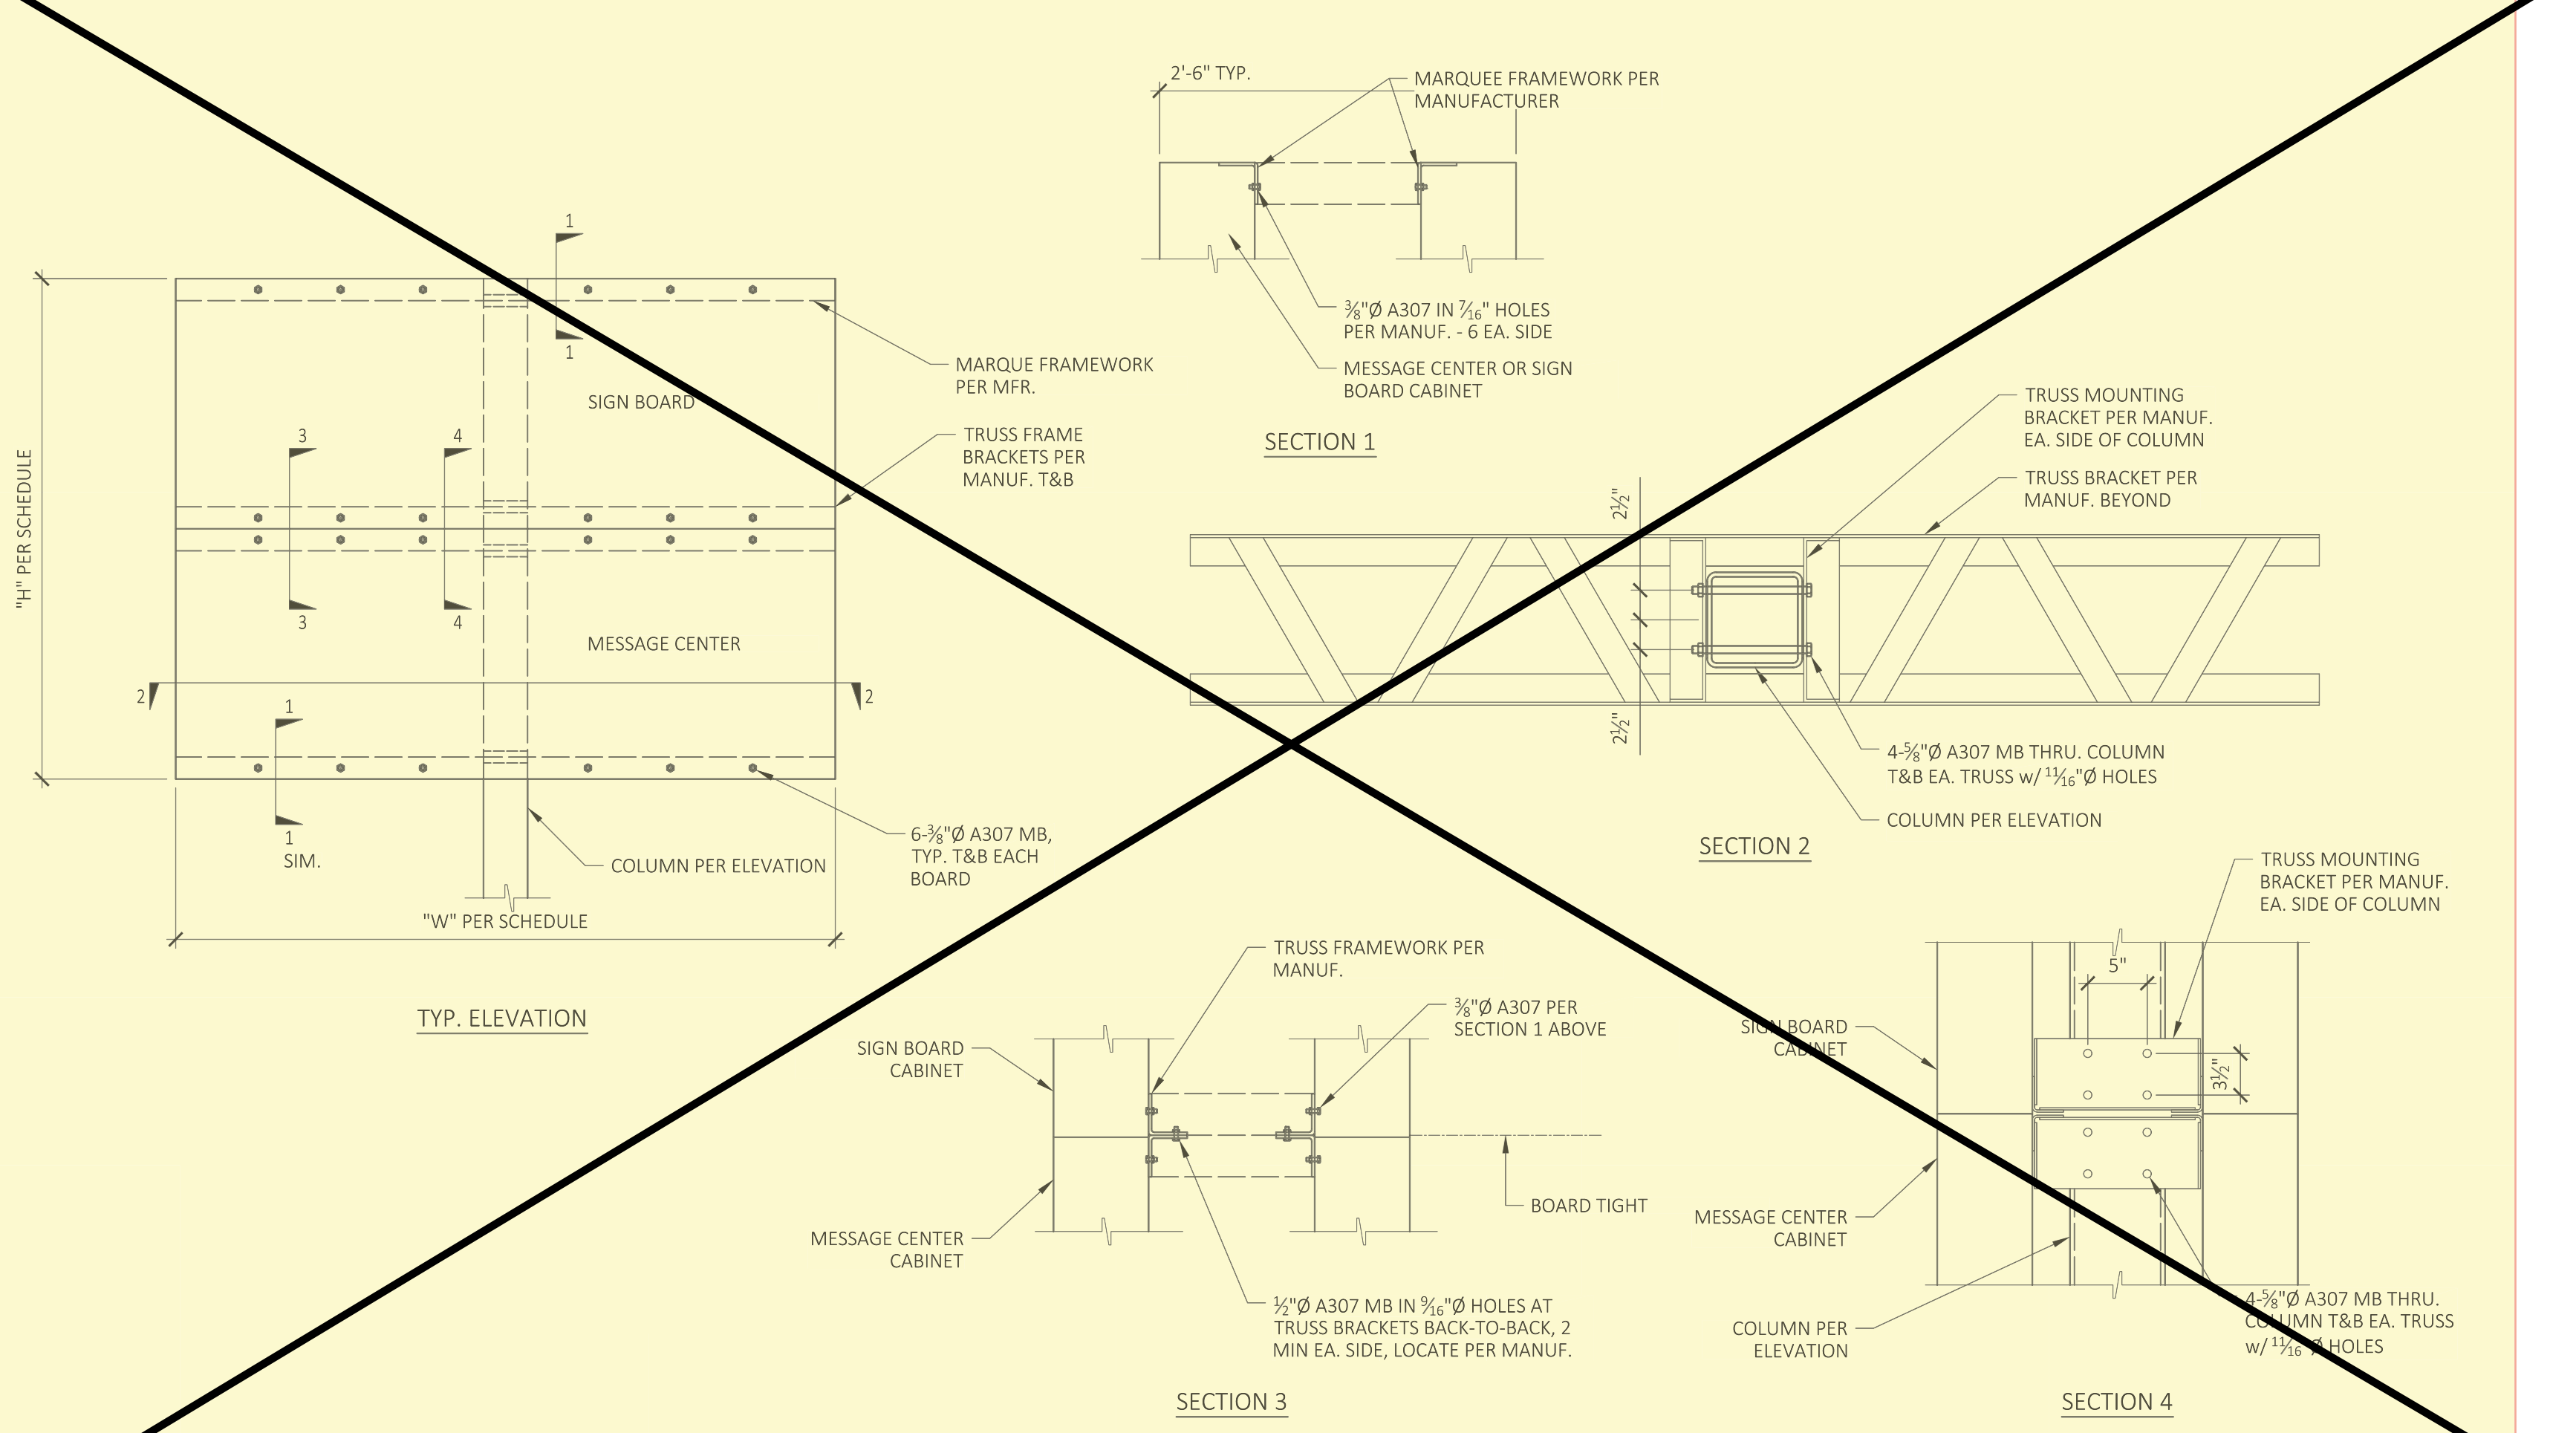
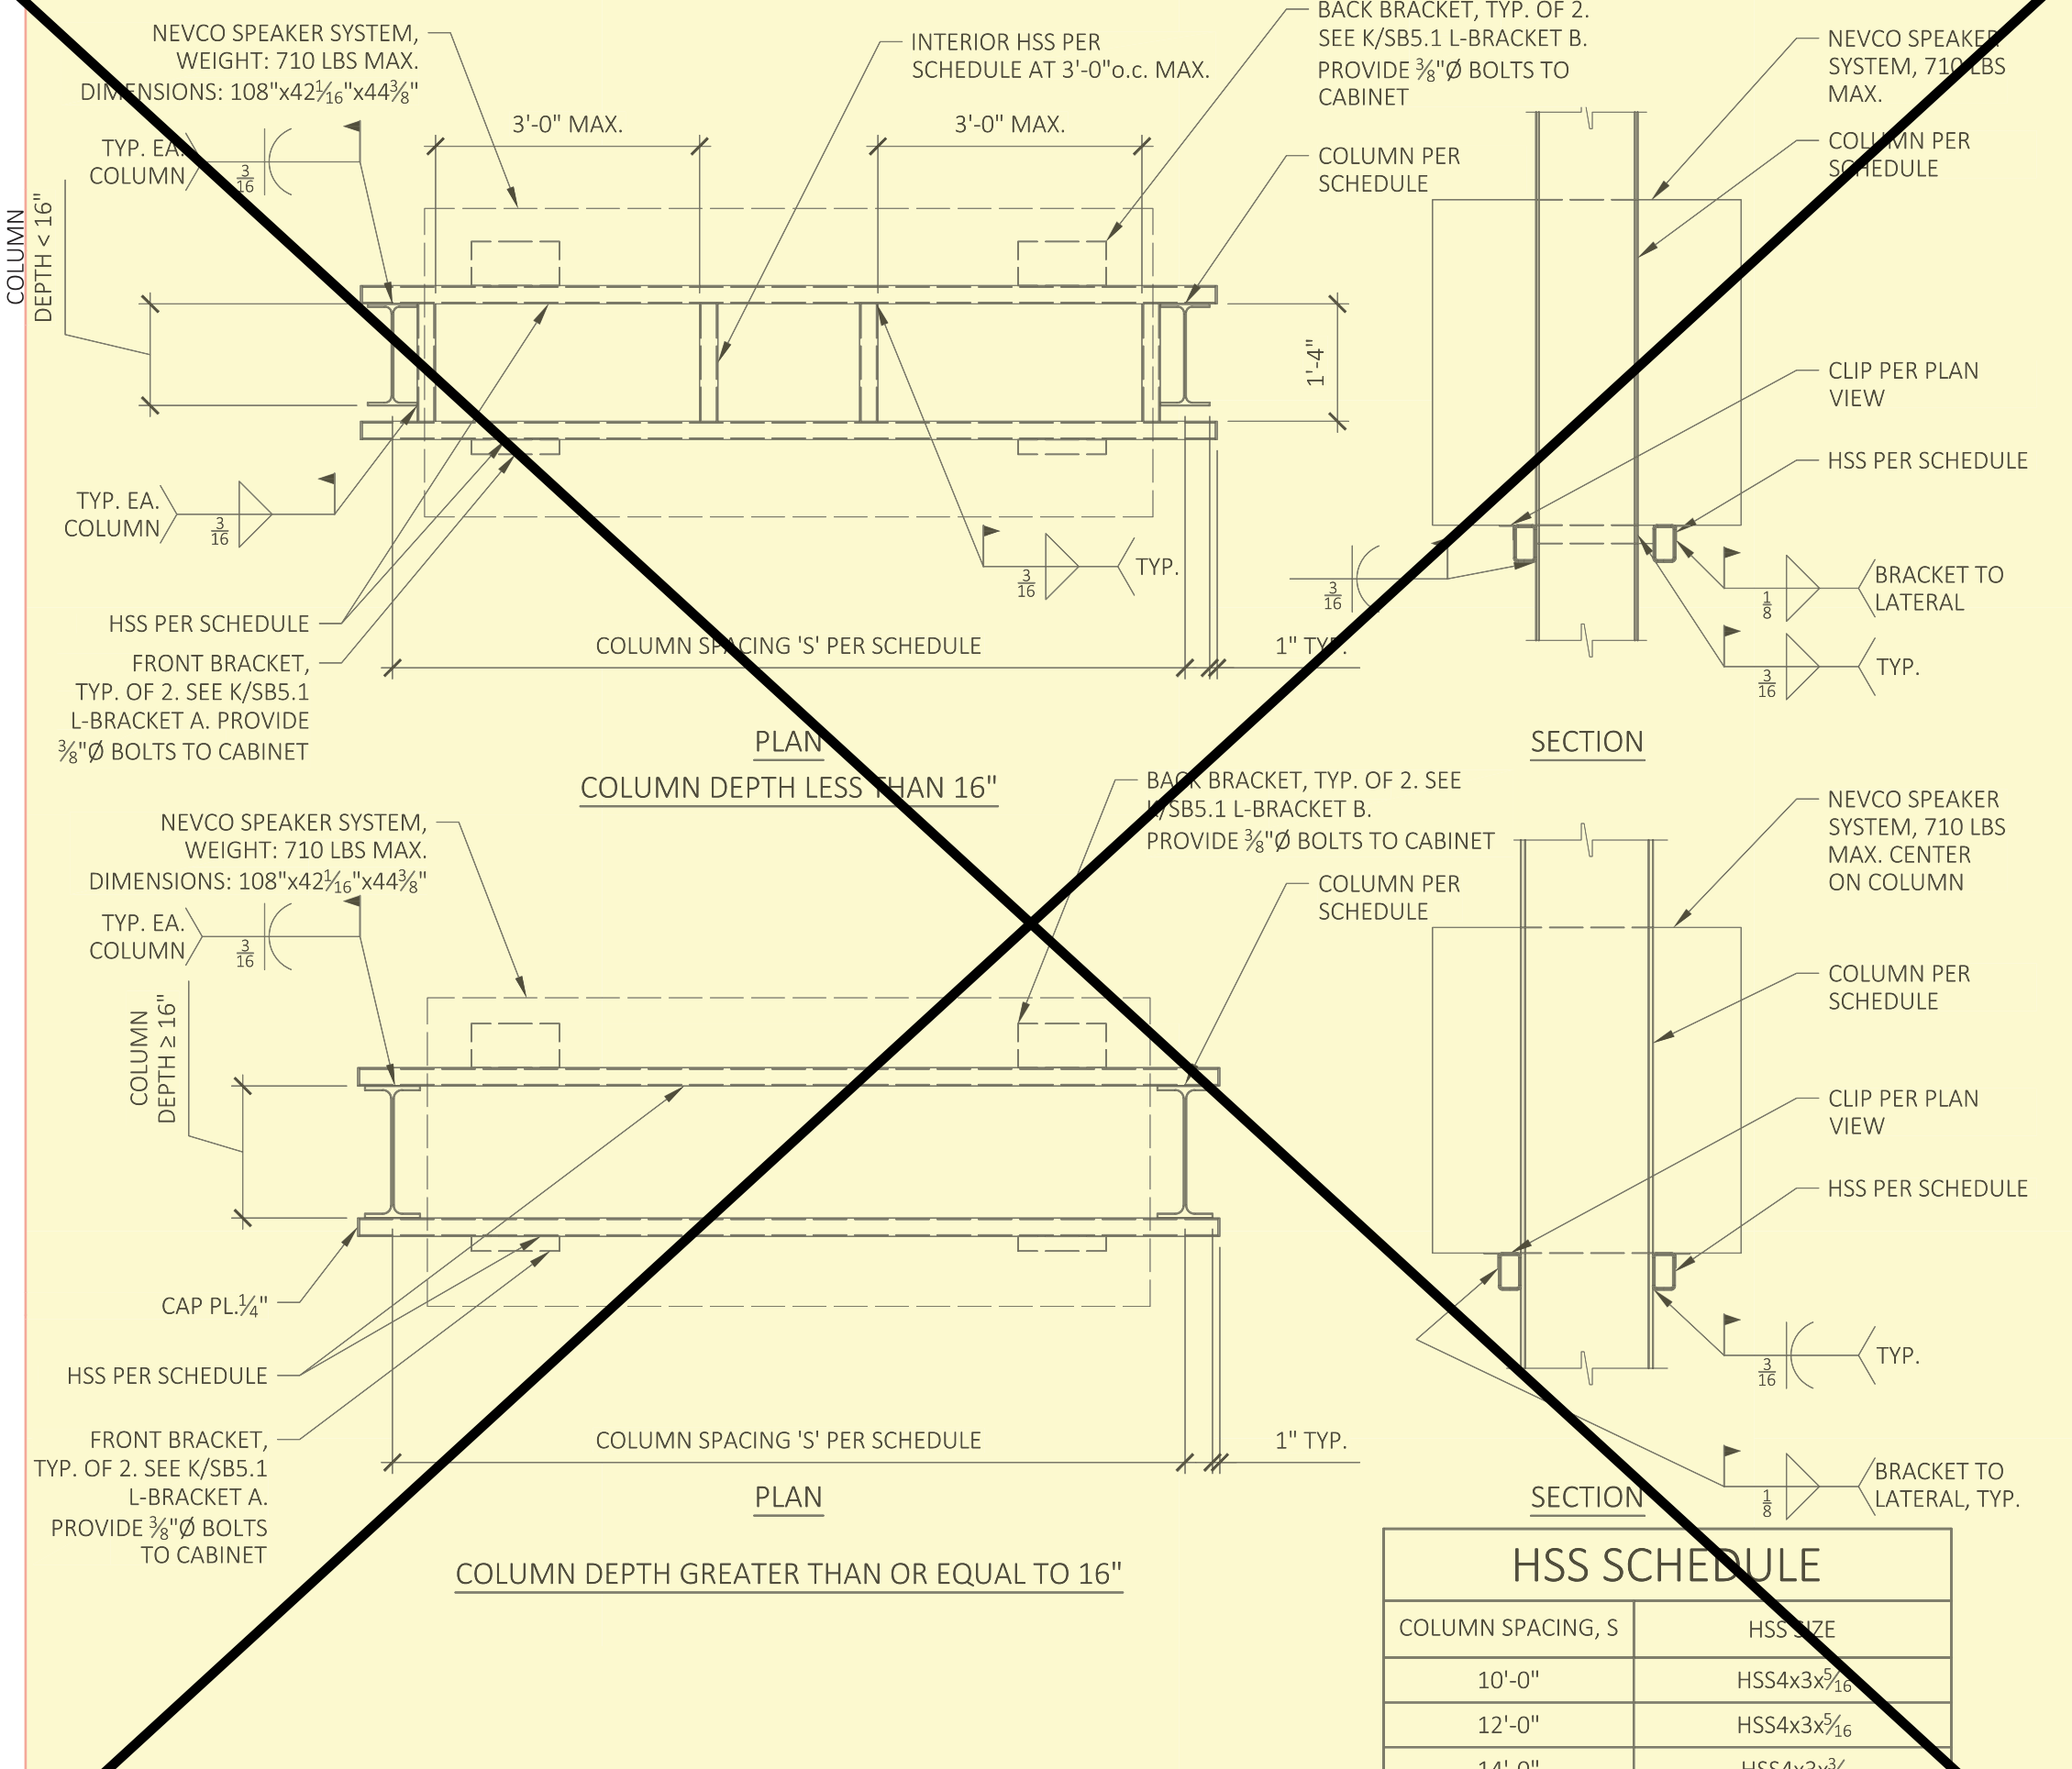
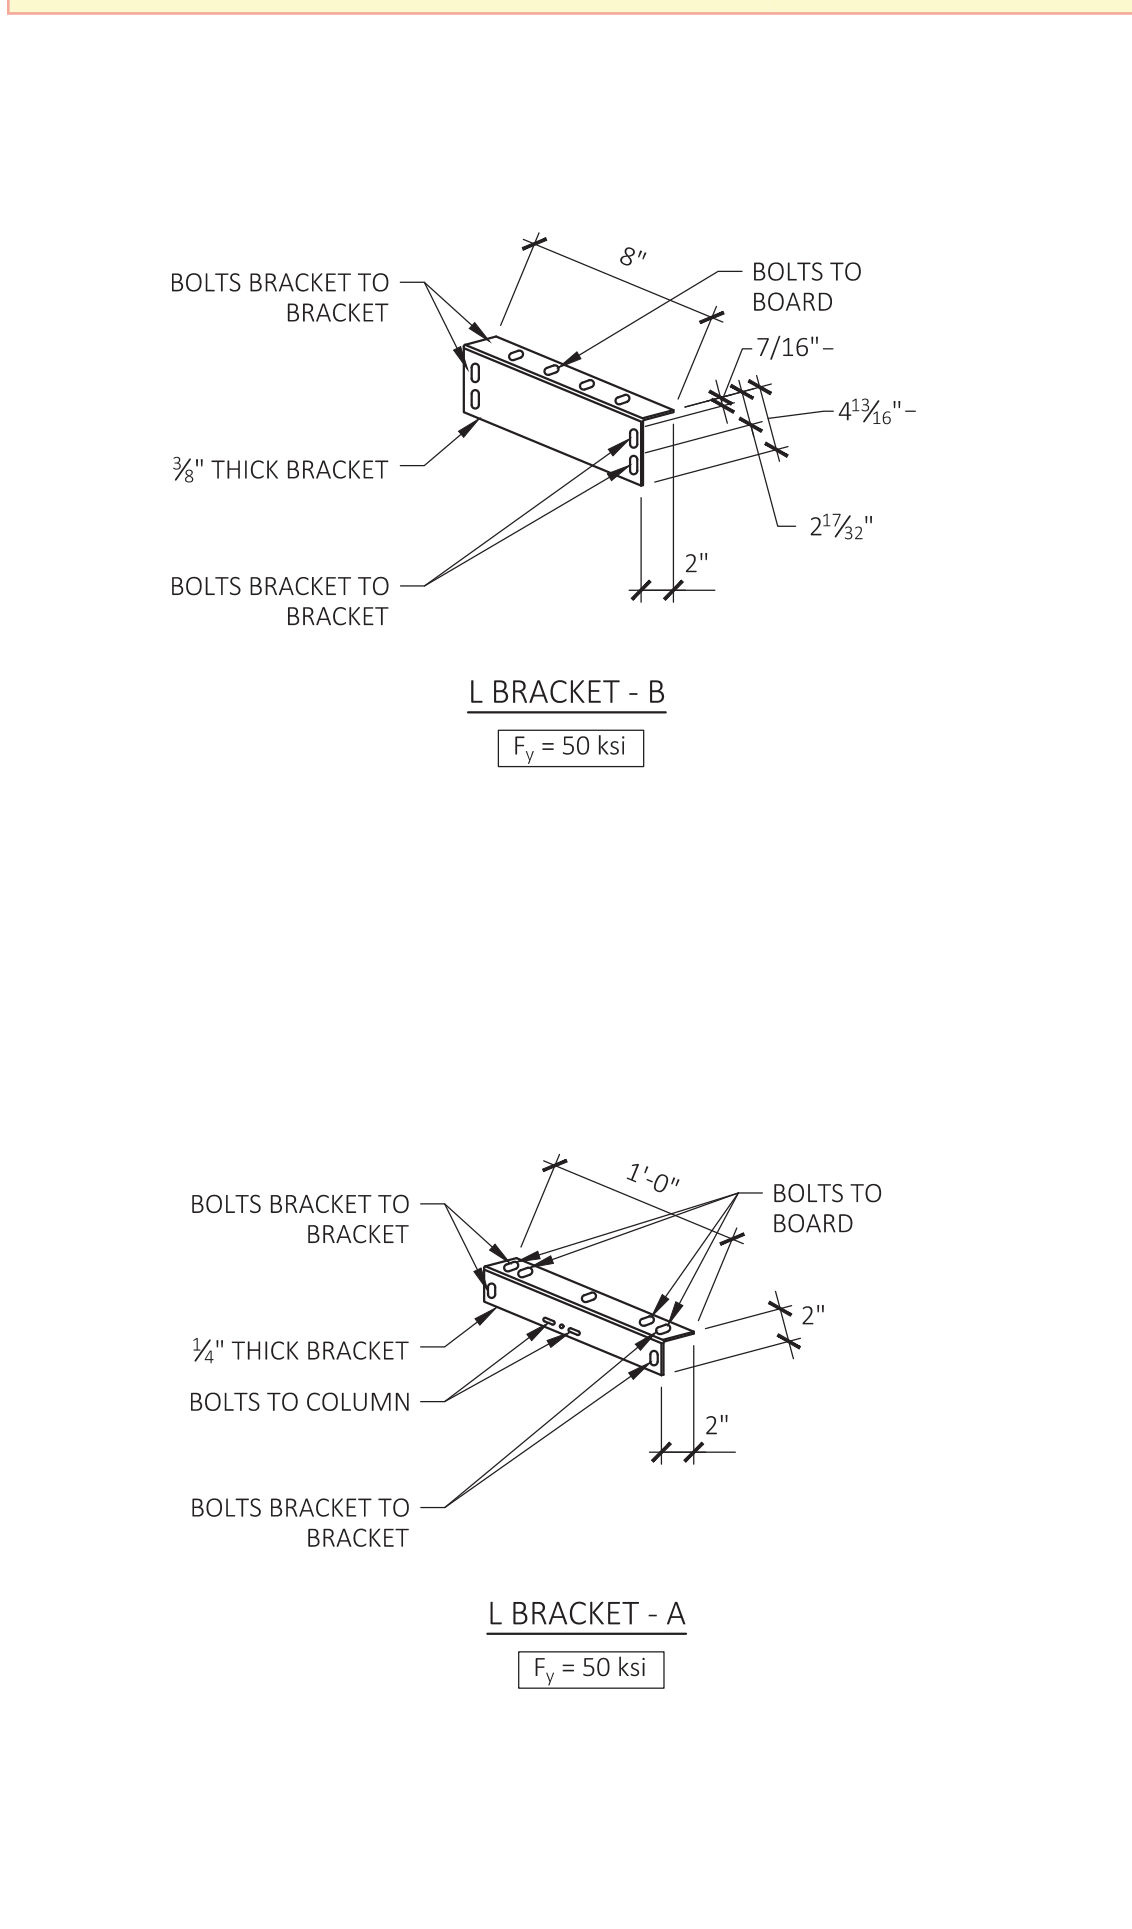
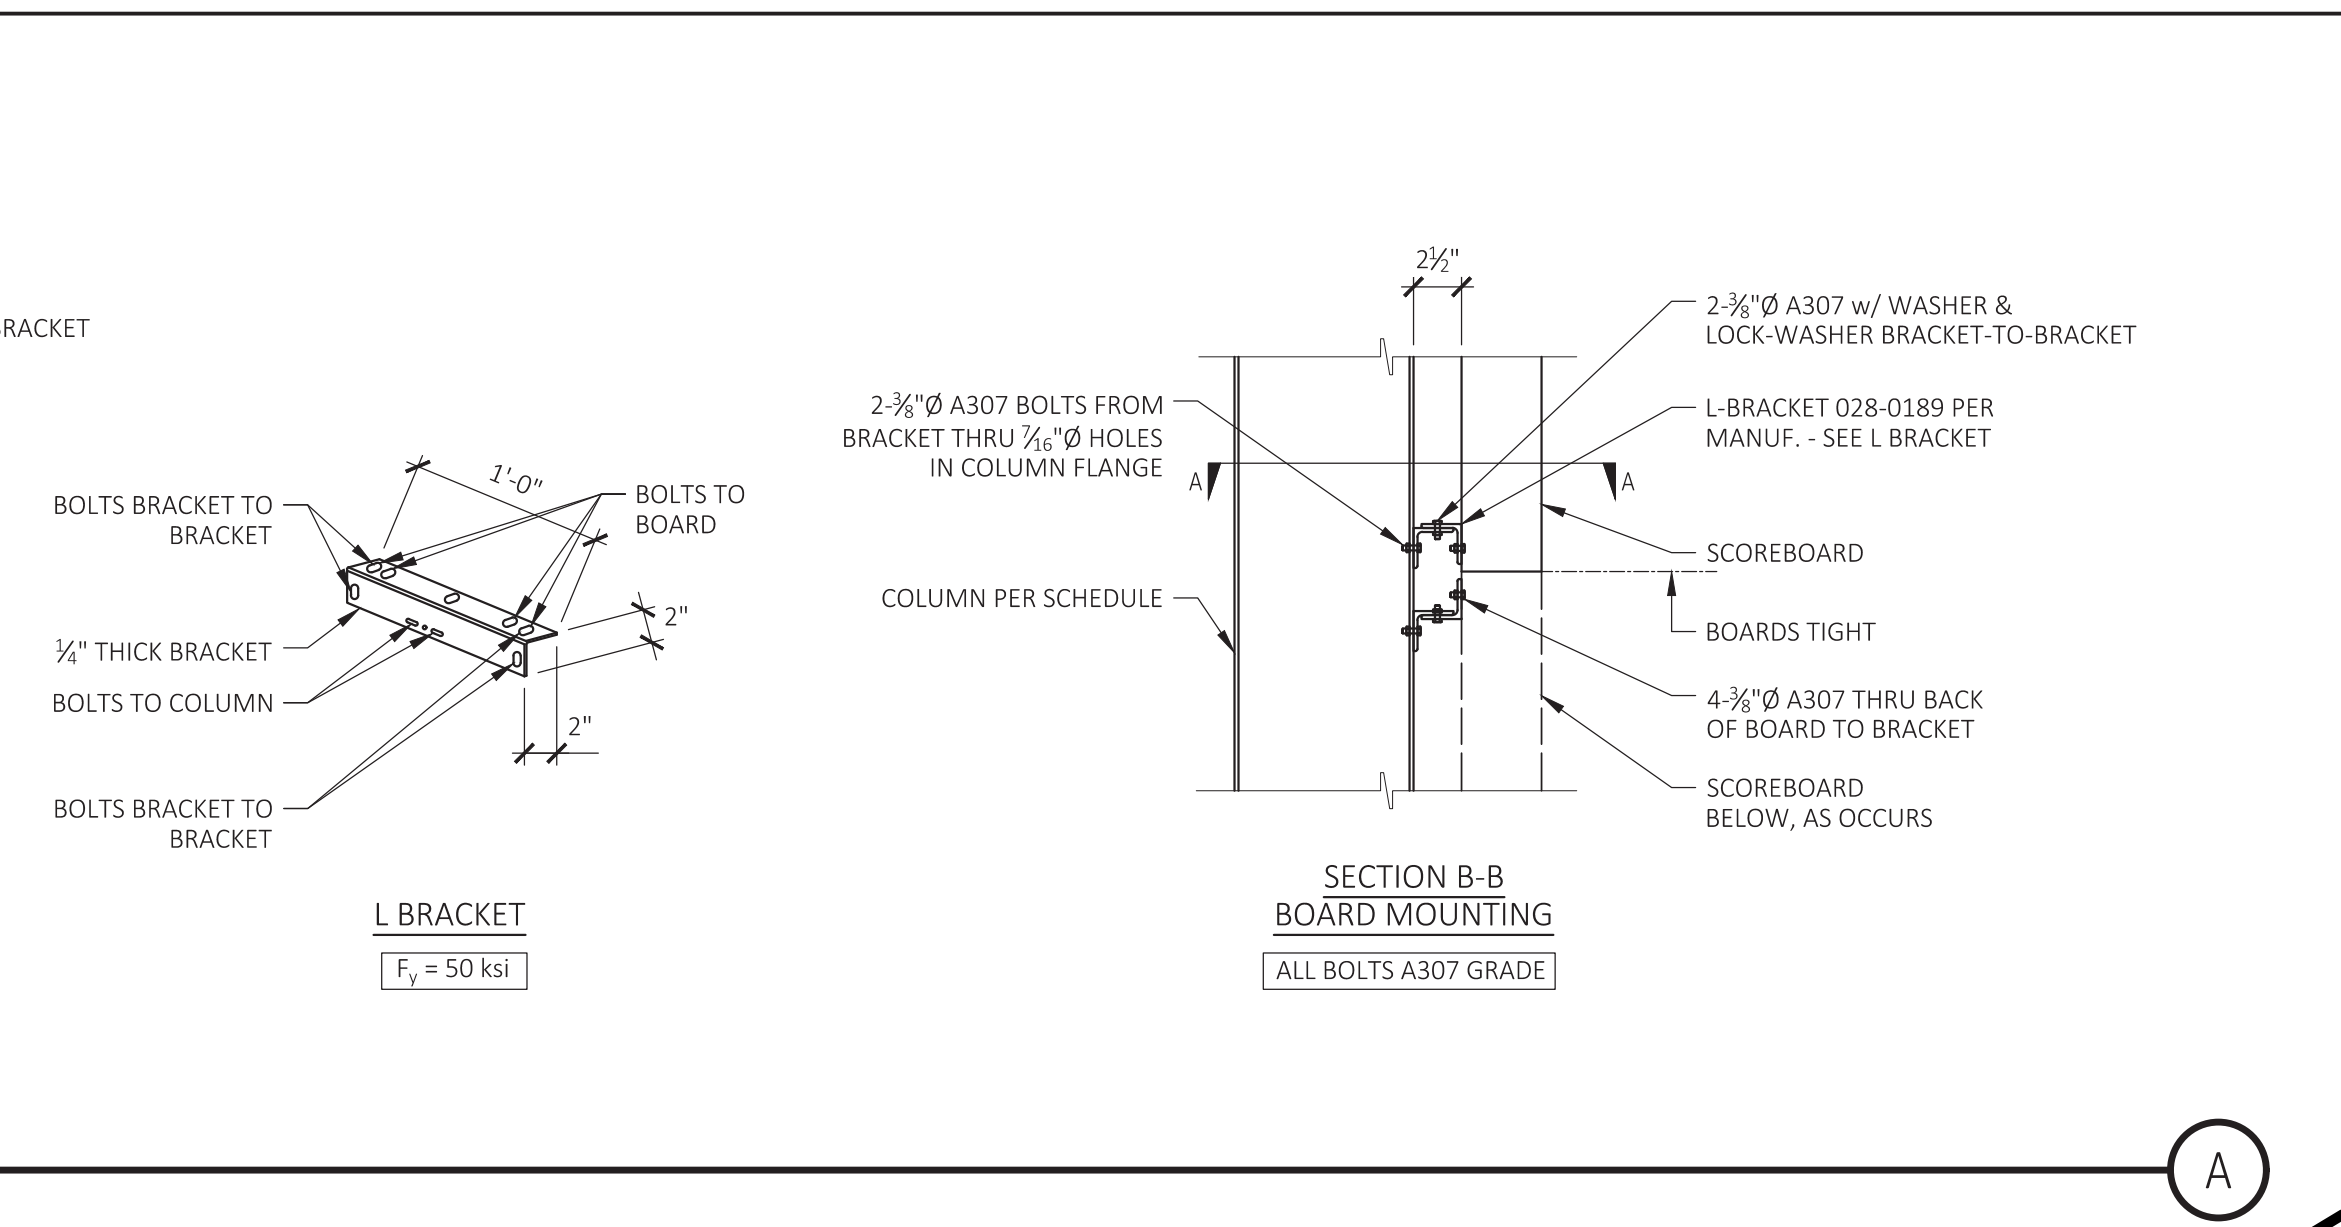
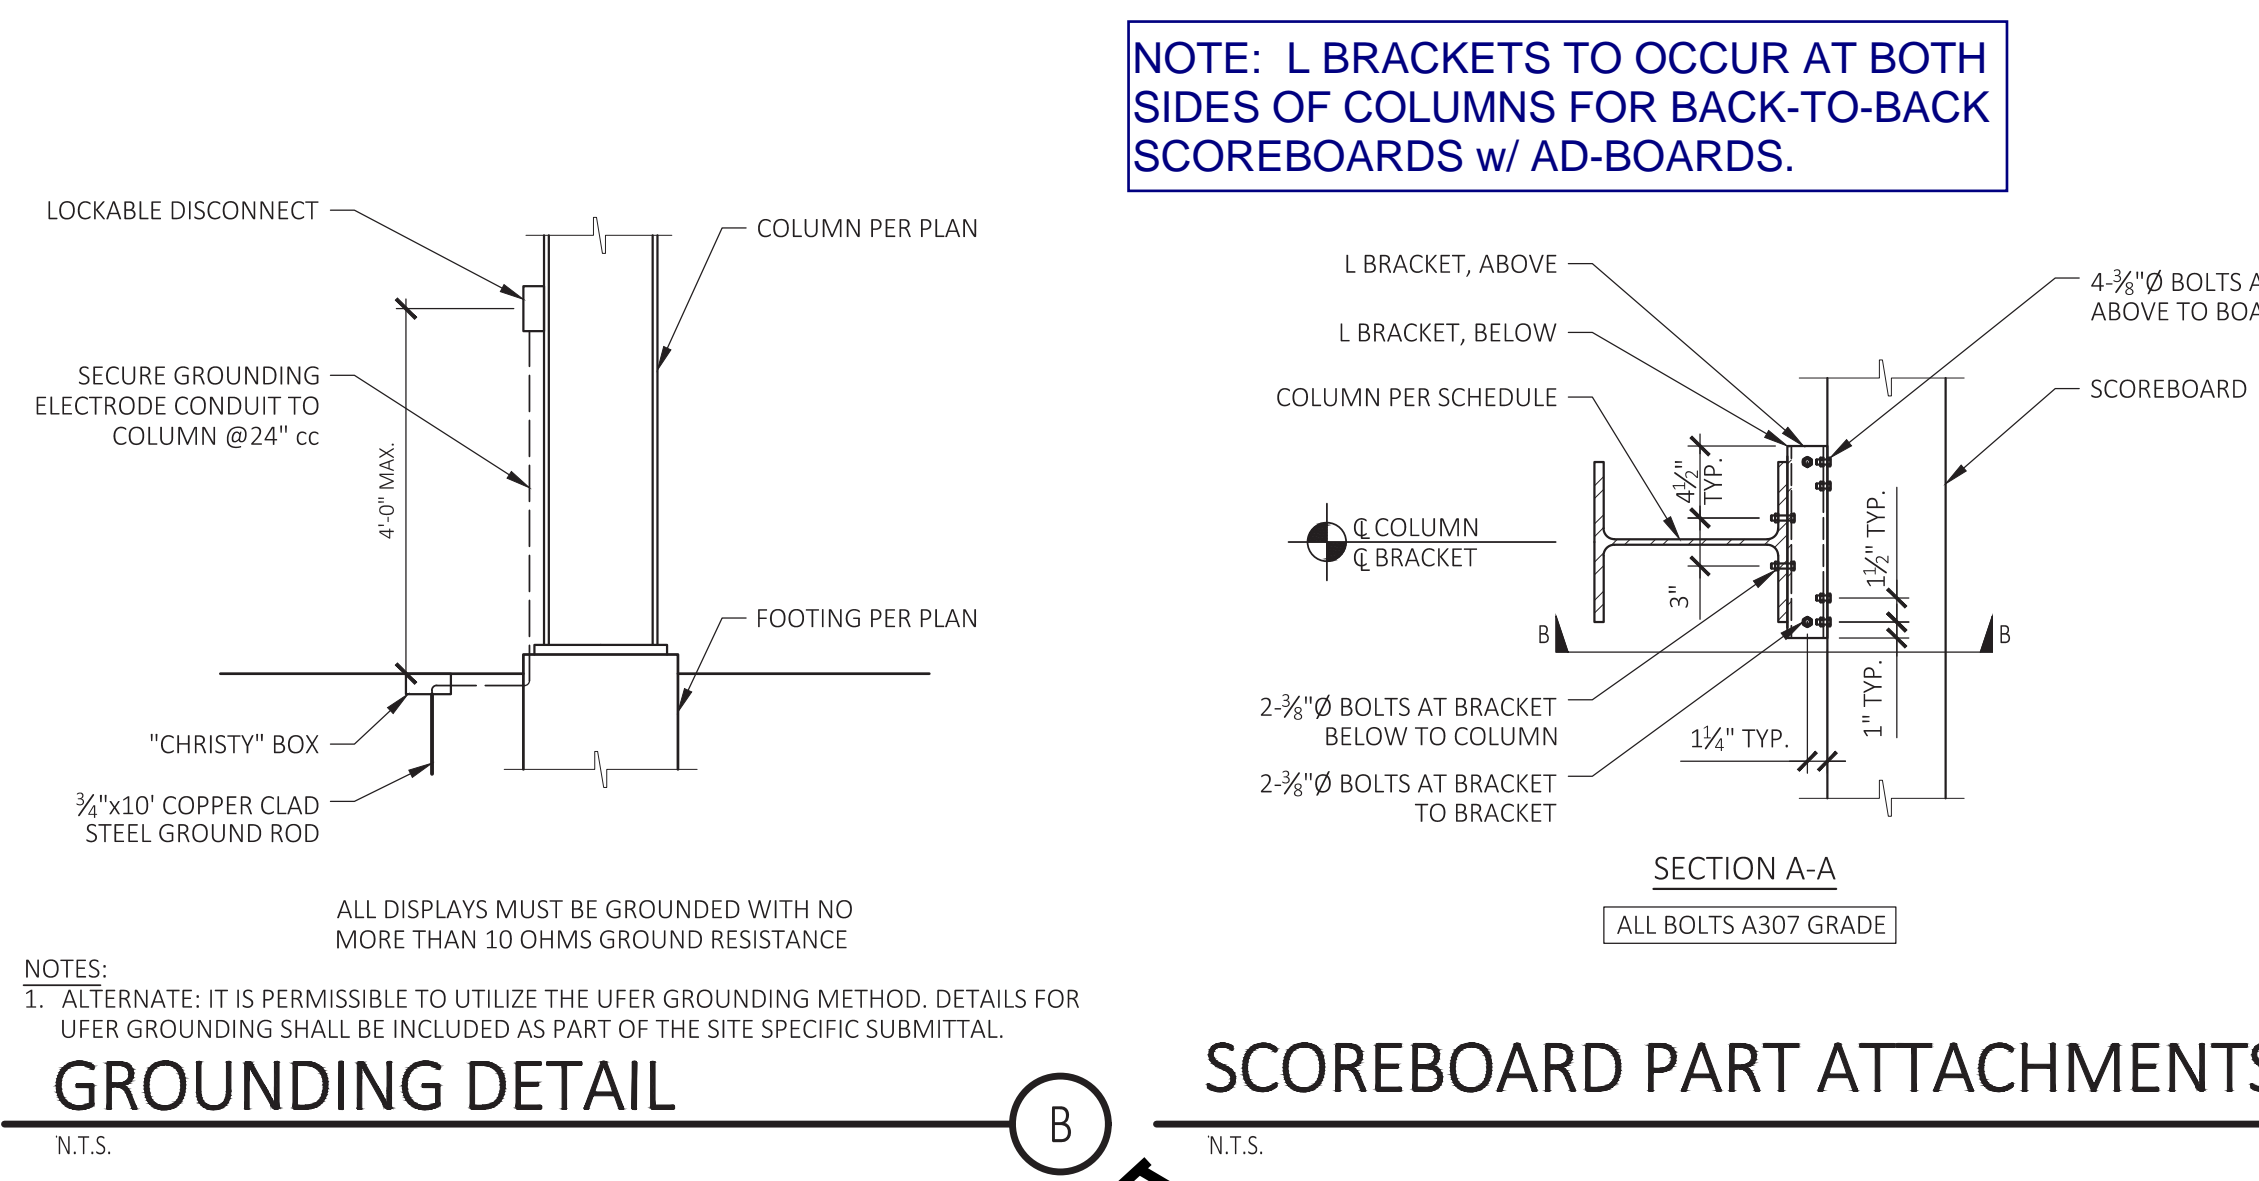
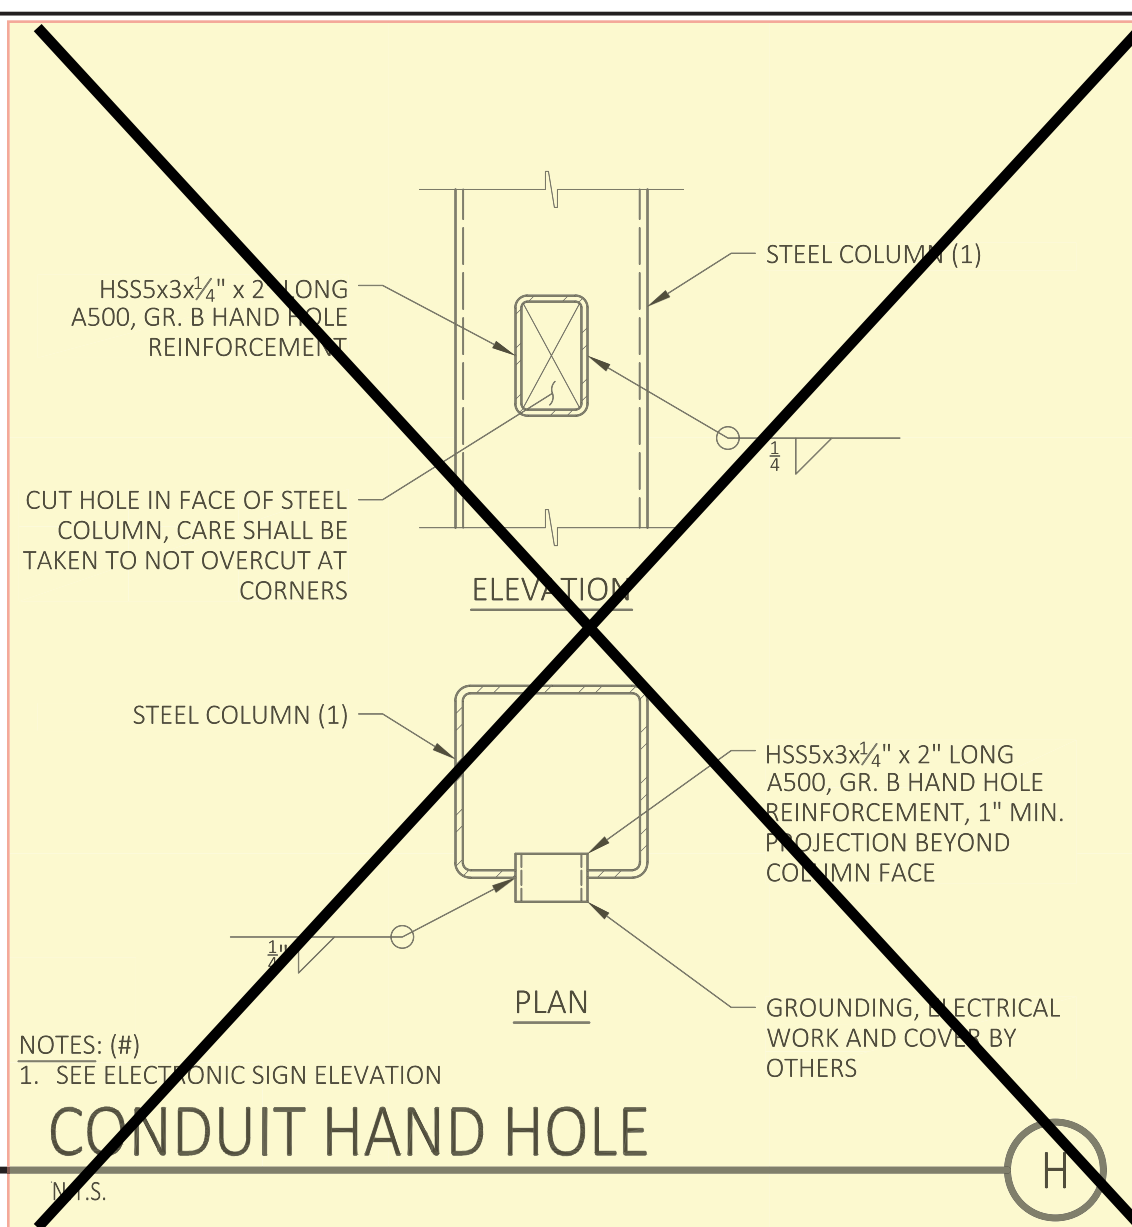
PRE-CHECK (PC) DOCUMENT CODE: 2019

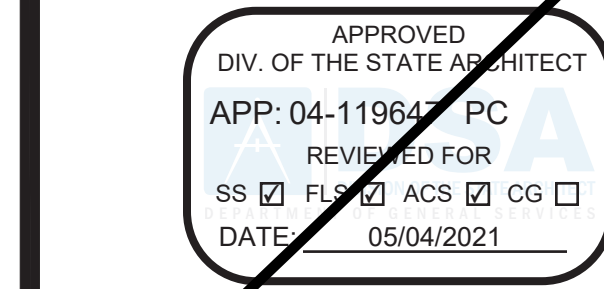A separate project application for construction is required.

HIRAM JOHNSON HS BS, SB & GOLF PROJECT SCOREBOARD MODEL 7632, 18" WIDE x 9' HIGH WITH 36" HIGH AD-BOARD AT TOP COLUMNS BOLTED TO PIERS 2019 CBC




STRUCTURAL NOTES & SPECIAL INSPECTIONS

DATE	03.25.2021
DRAWN	JMK
CHECKED	MEP
SSG JOB #	S20284
SHEET	SB0.3



HSS SCHEDULE

COLUMN SPACING, S	HSS TYPE
10'-0"	HSS4x3x3/8
12'-0"	HSS4x3x3/4
14'-0"	HSS4x3x3/2

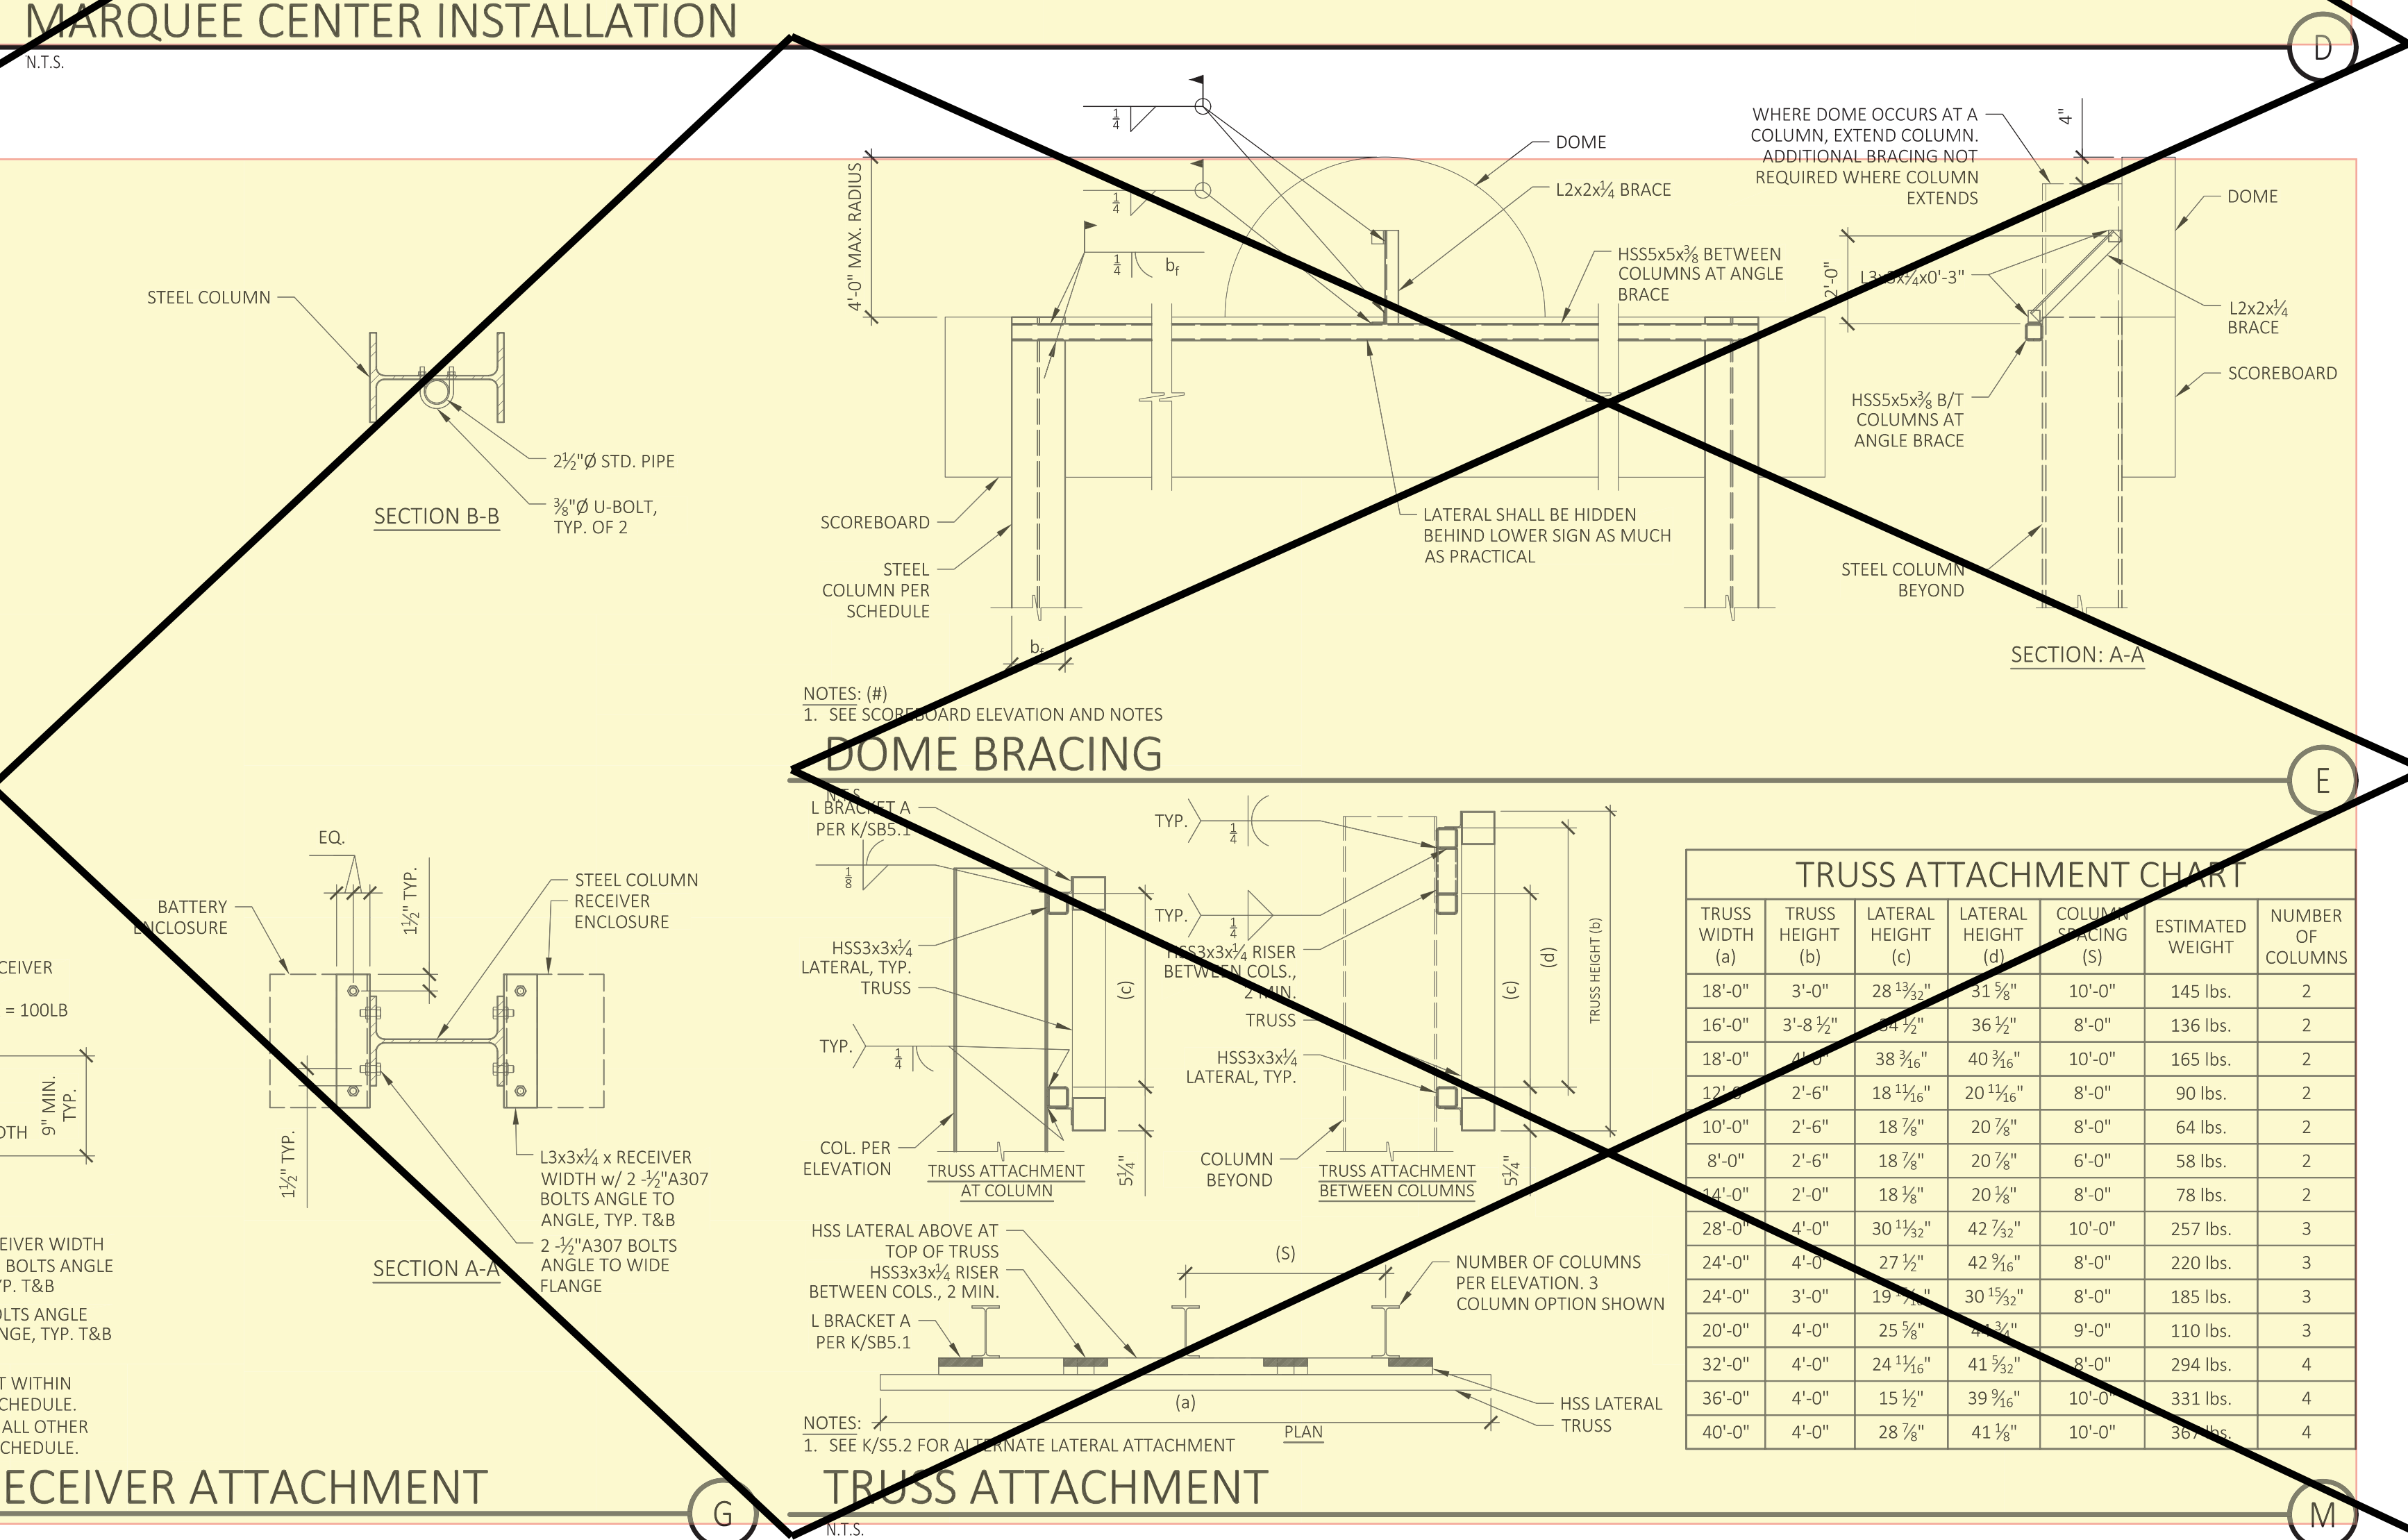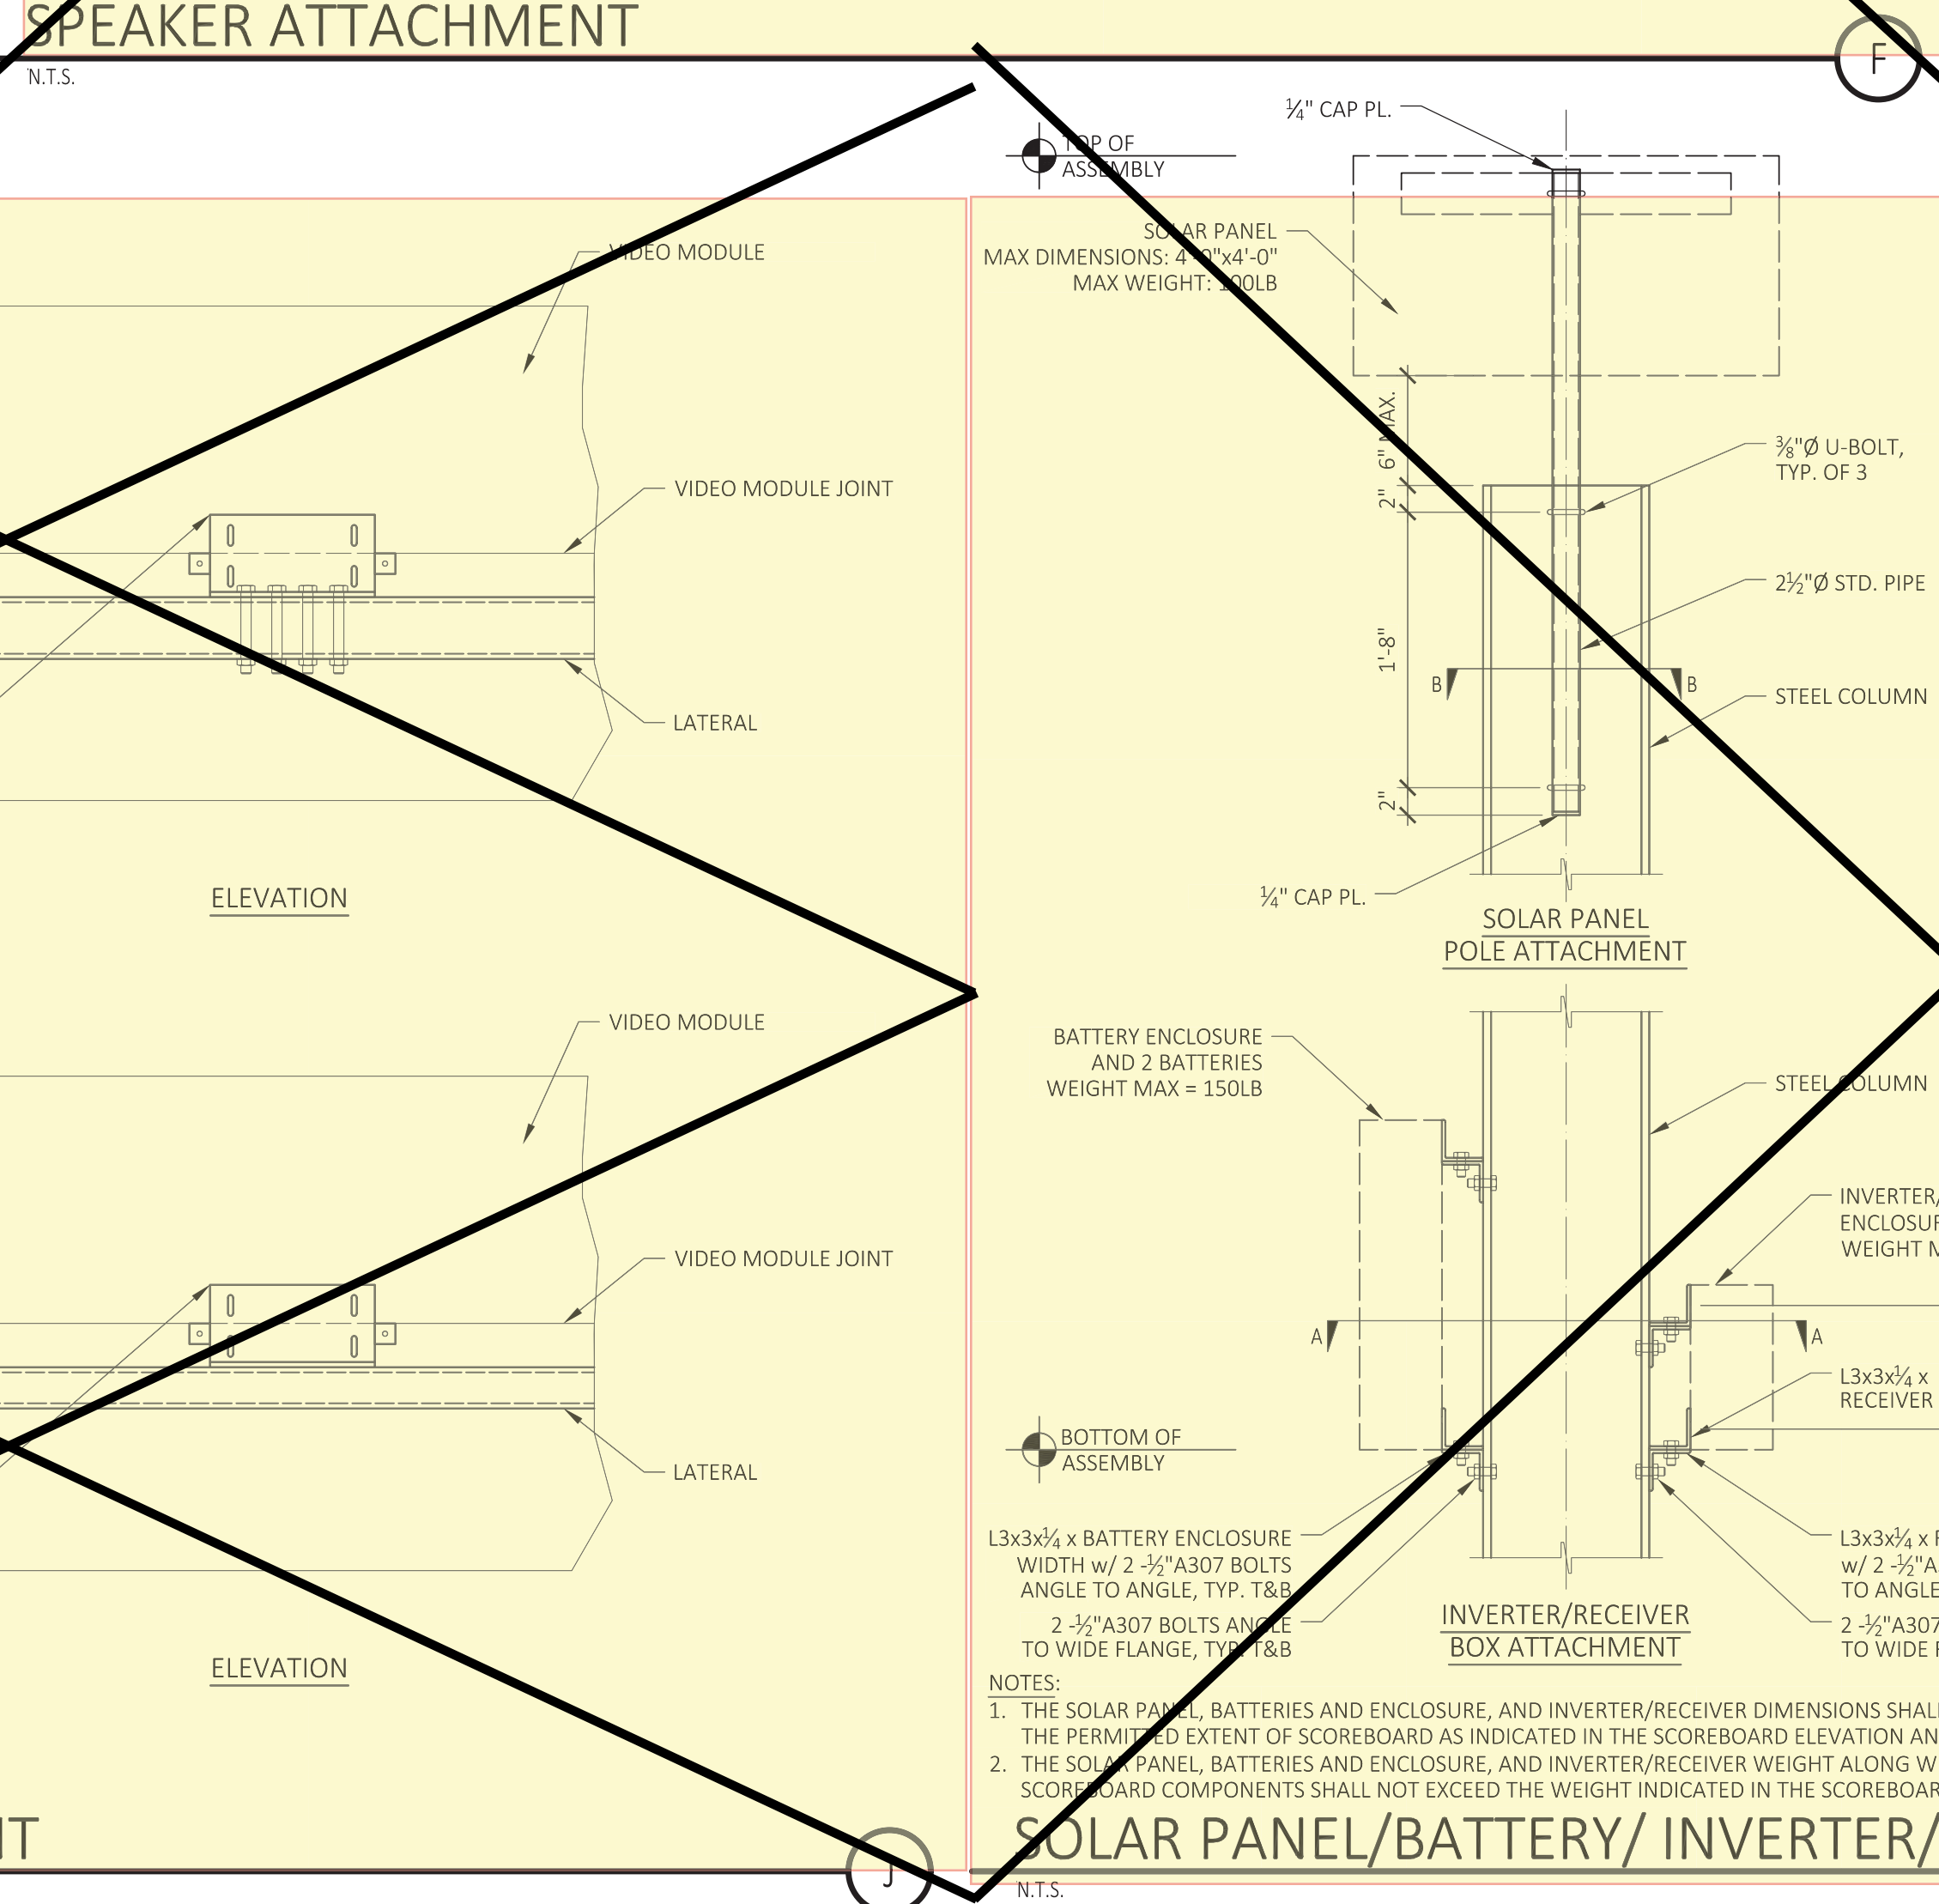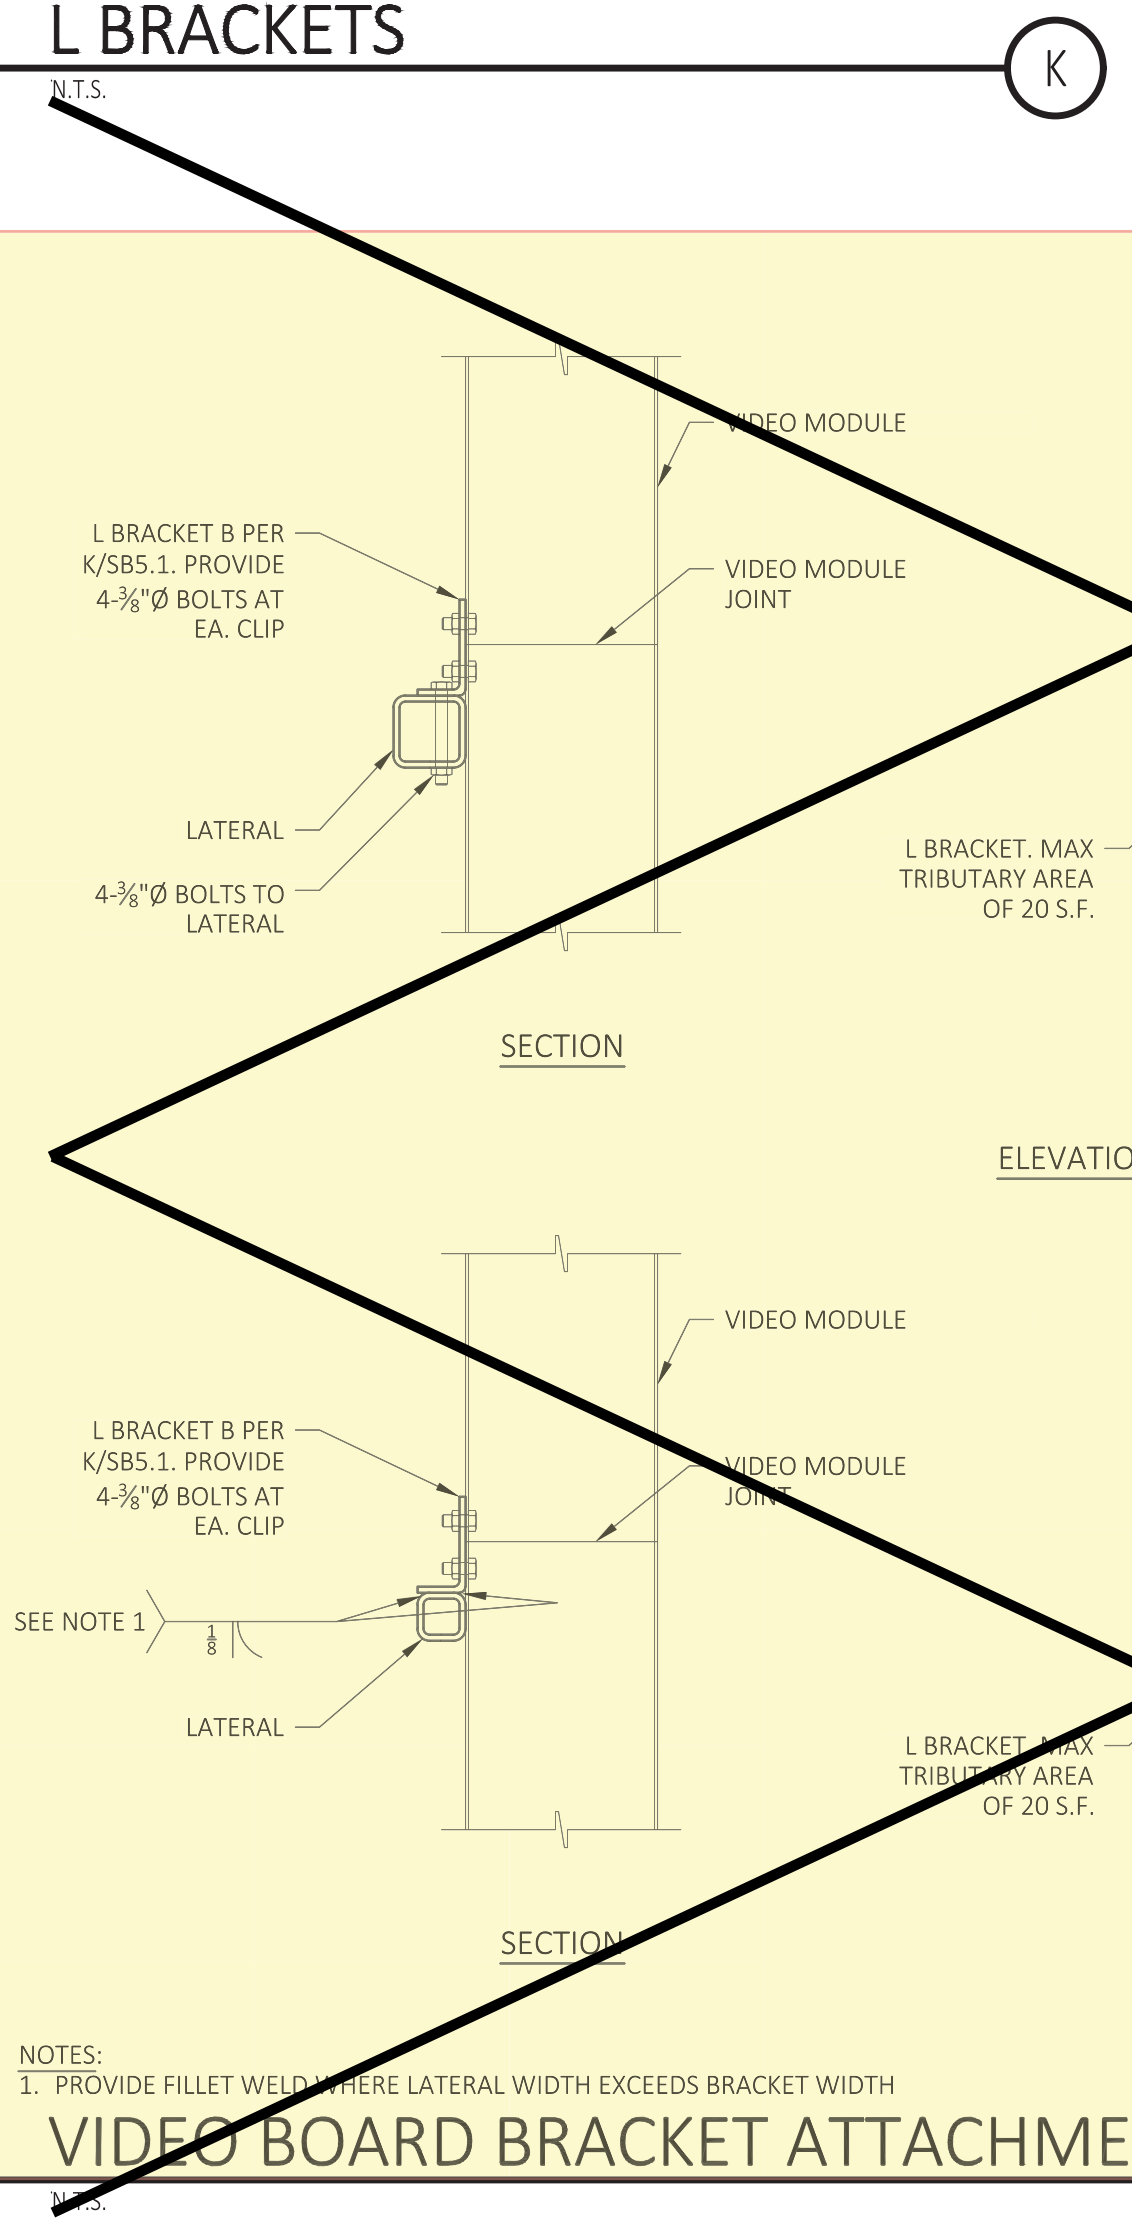

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REGISTERED PROFESSIONAL ENGINEER
No. 5405
STRUCTURAL
STATE OF CALIFORNIA

DATE SIGNED: 11.20.20

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301 East Harris Avenue, Greenville, Illinois 62246
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APPROVED
DIV. OF THE STATE ARCHITECT
APP: 04-1196 PC
REVIEWED FOR
SS □ FL □ ACS □ CG □
DATE: 05/04/2021











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HIRAM JOHNSON HS, BS, SB & GOLF PROJECT
SCOREBOARD MODEL 7632,
18' WIDE x 9' HIGH WITH
36" HIGH AD-BOARD AT TOP
COLUMNS BOLTED TO PIERS
2019 CBC

ATTACHMENT DETAILS

SHEET INFORMATION
DATE: 03.25.2021
DRAWN: JMK
CHECKED: MEP
SSG JOB #: S20284
SHEET: SB5.1



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NEVCO
301 East Harris Avenue, Greenville, Illinois 62246
Phone: (618) 664-0960
www.nevco.com

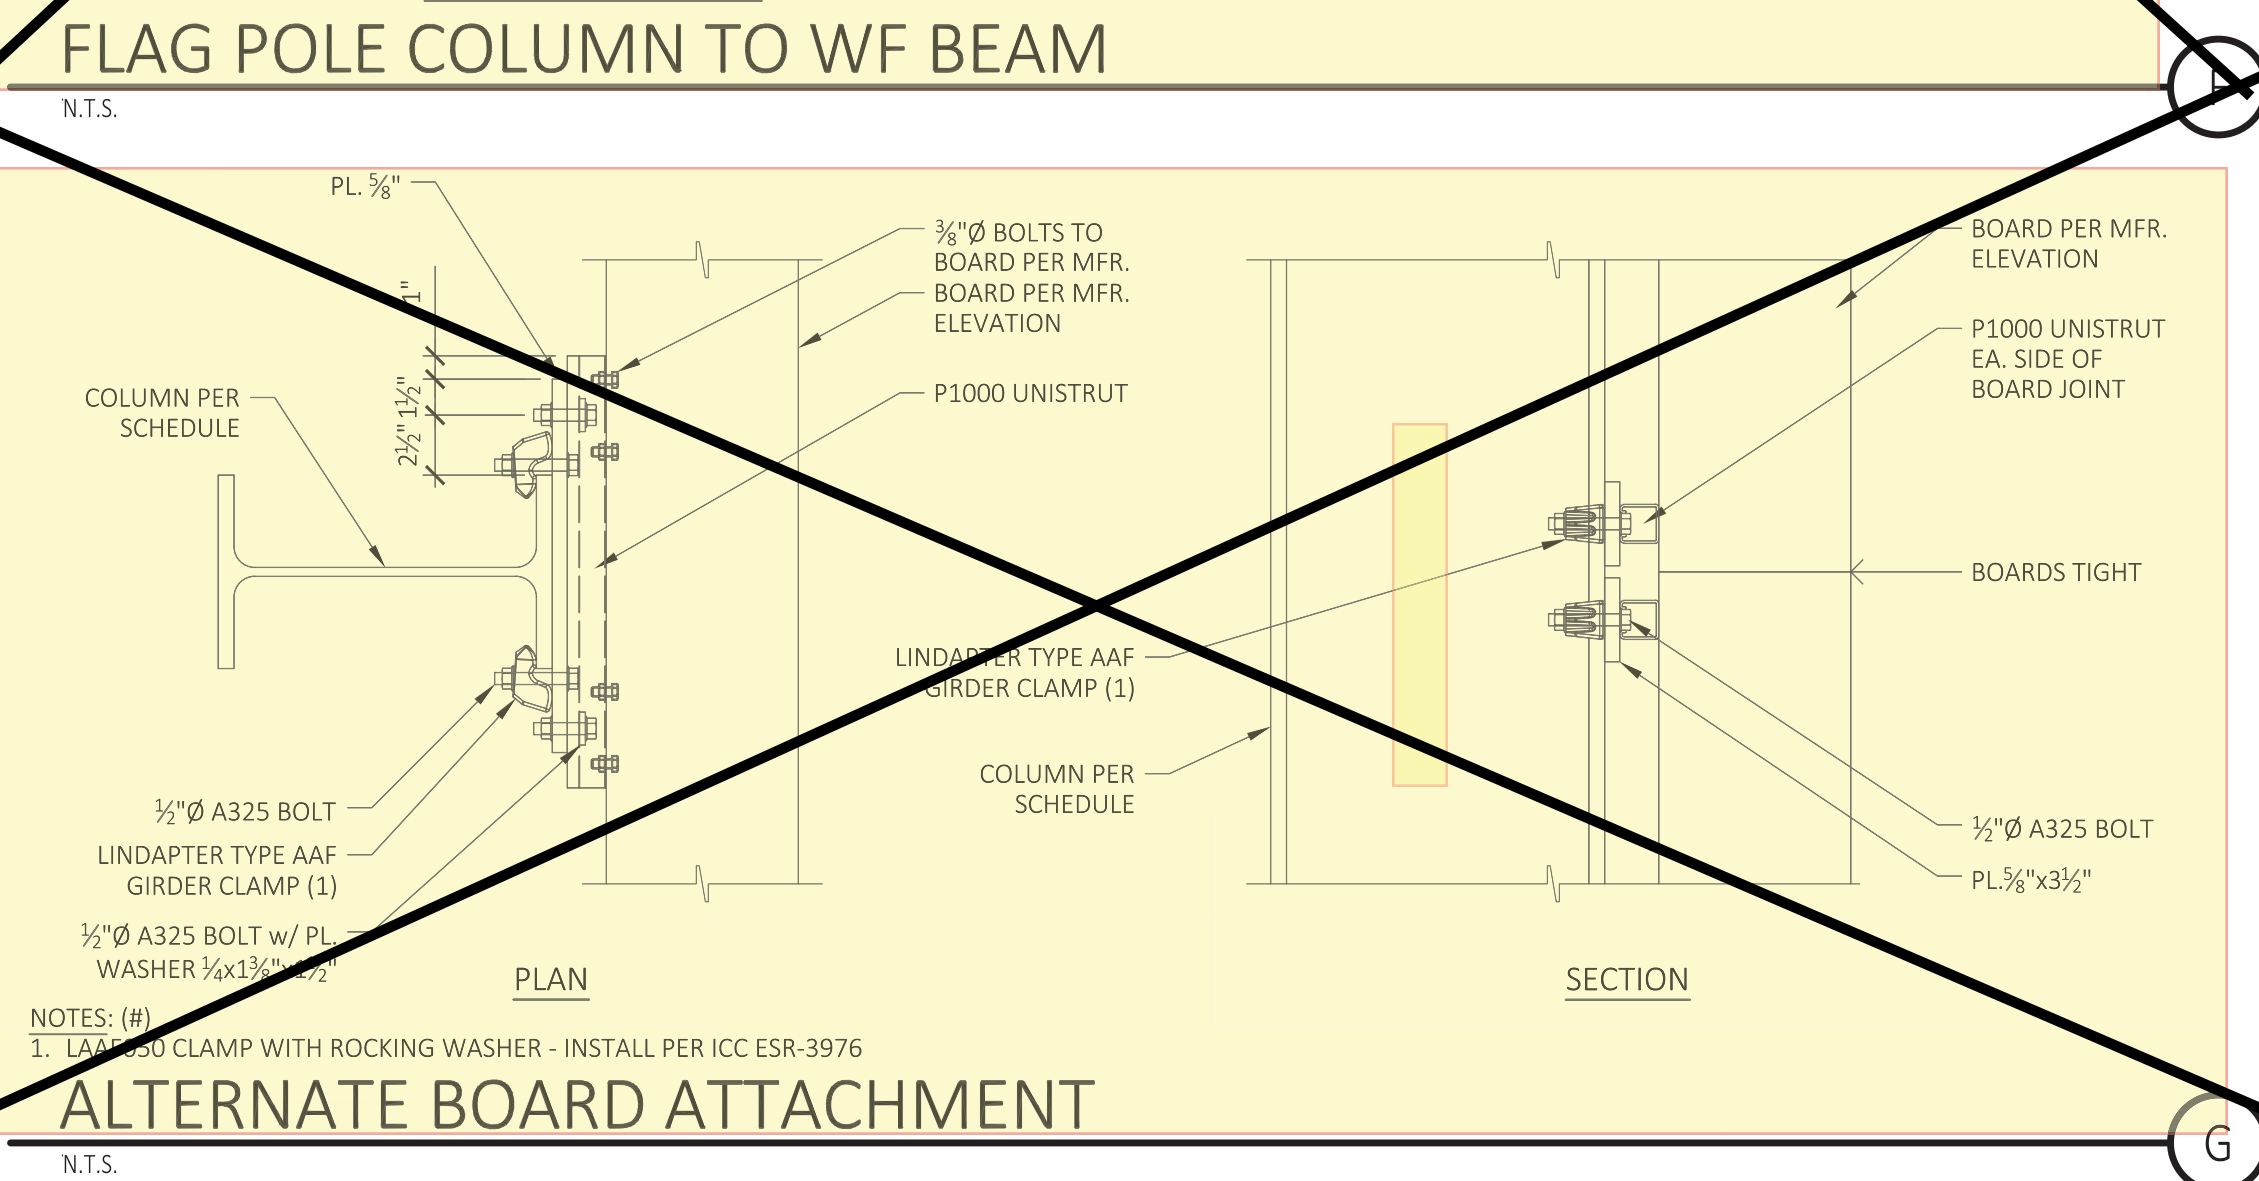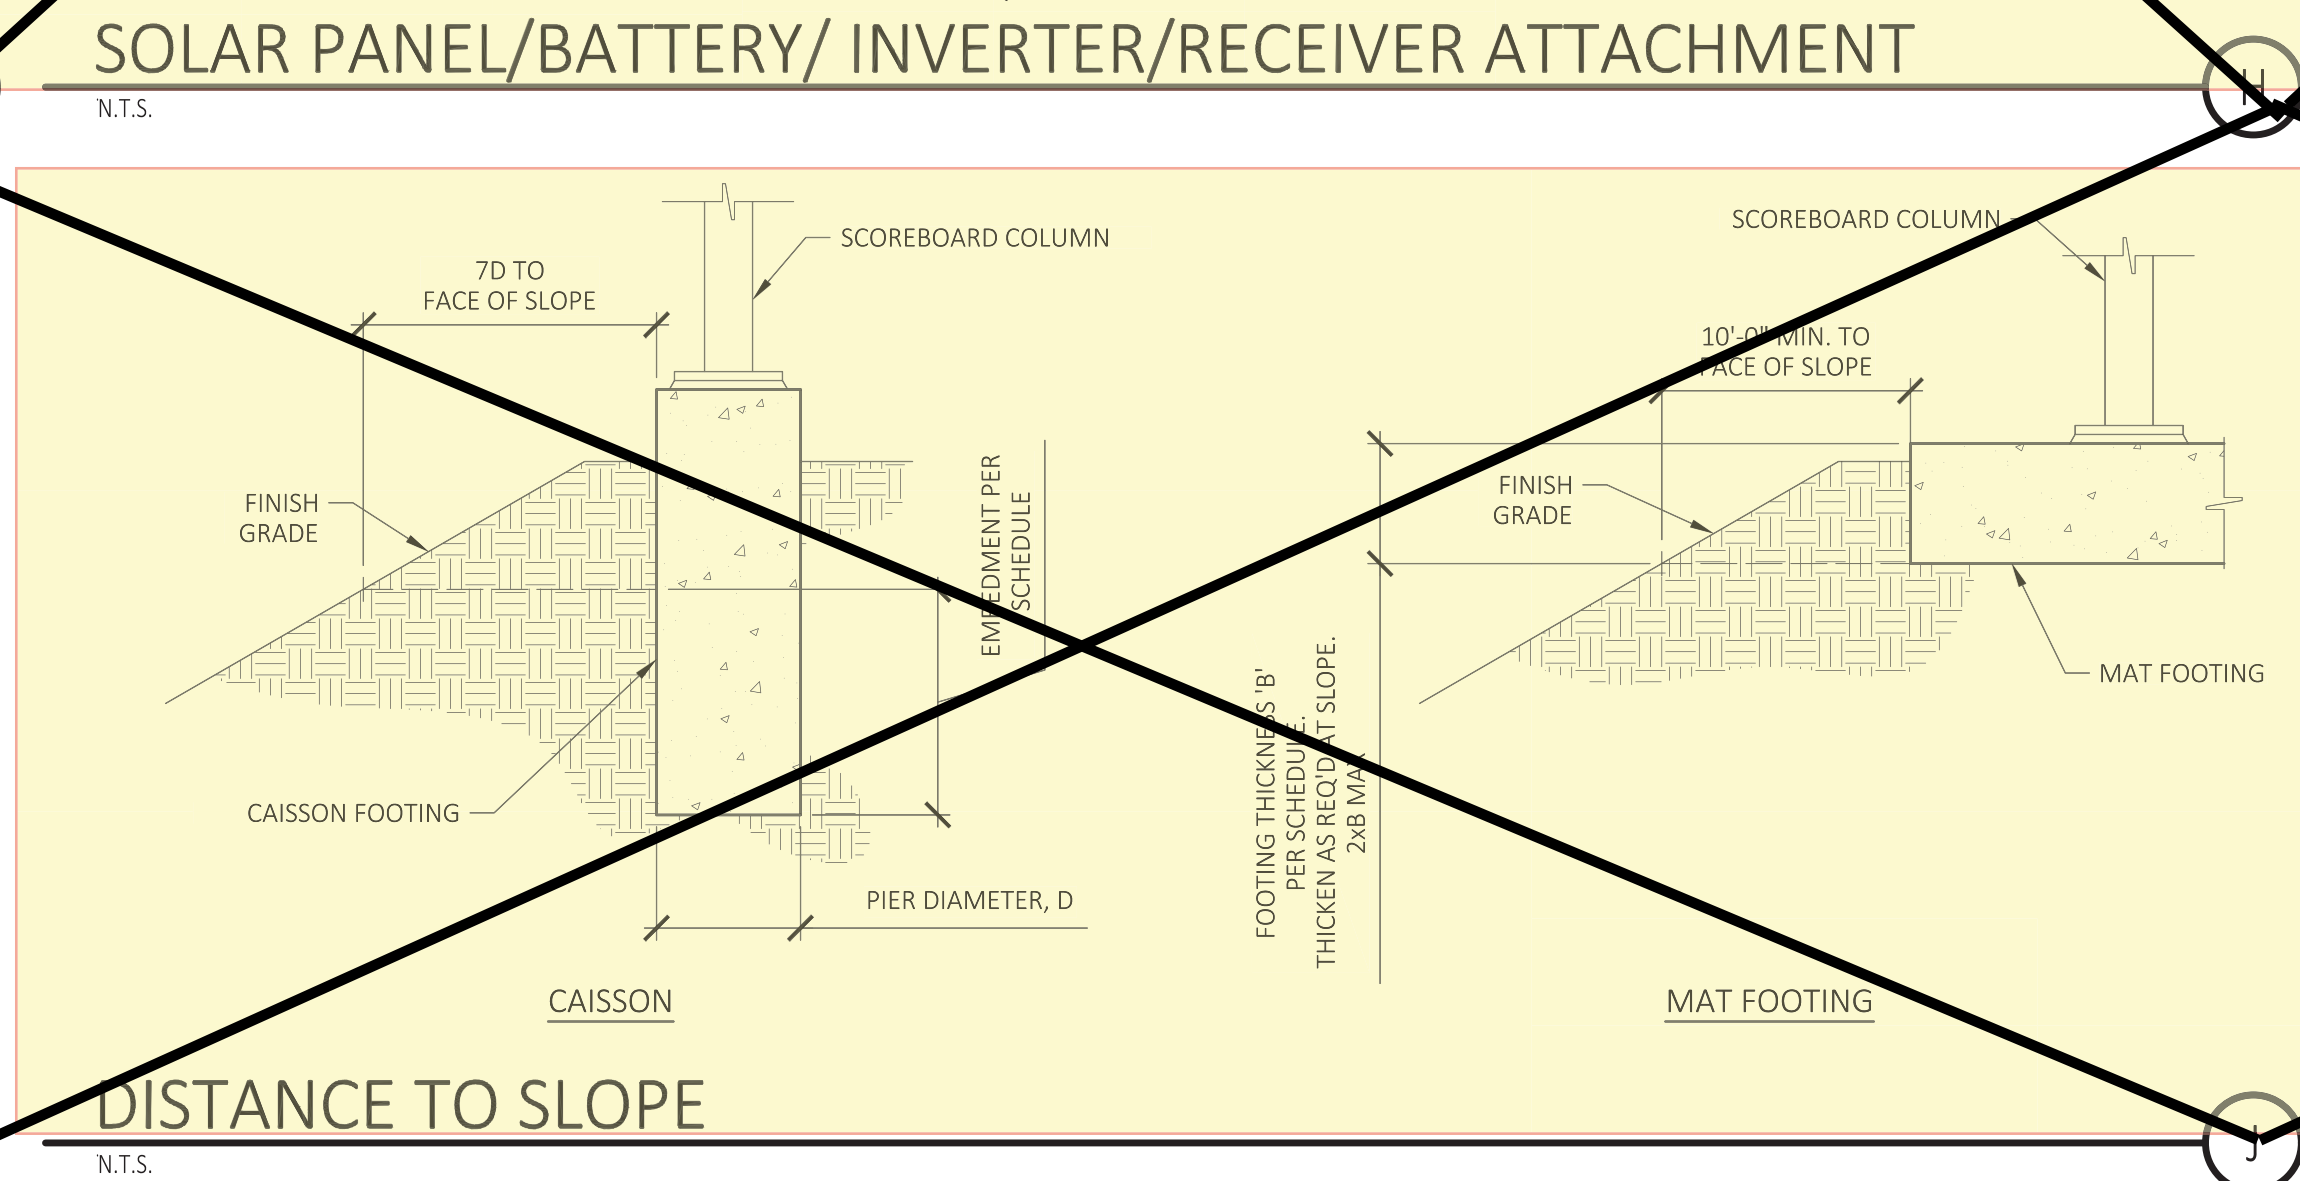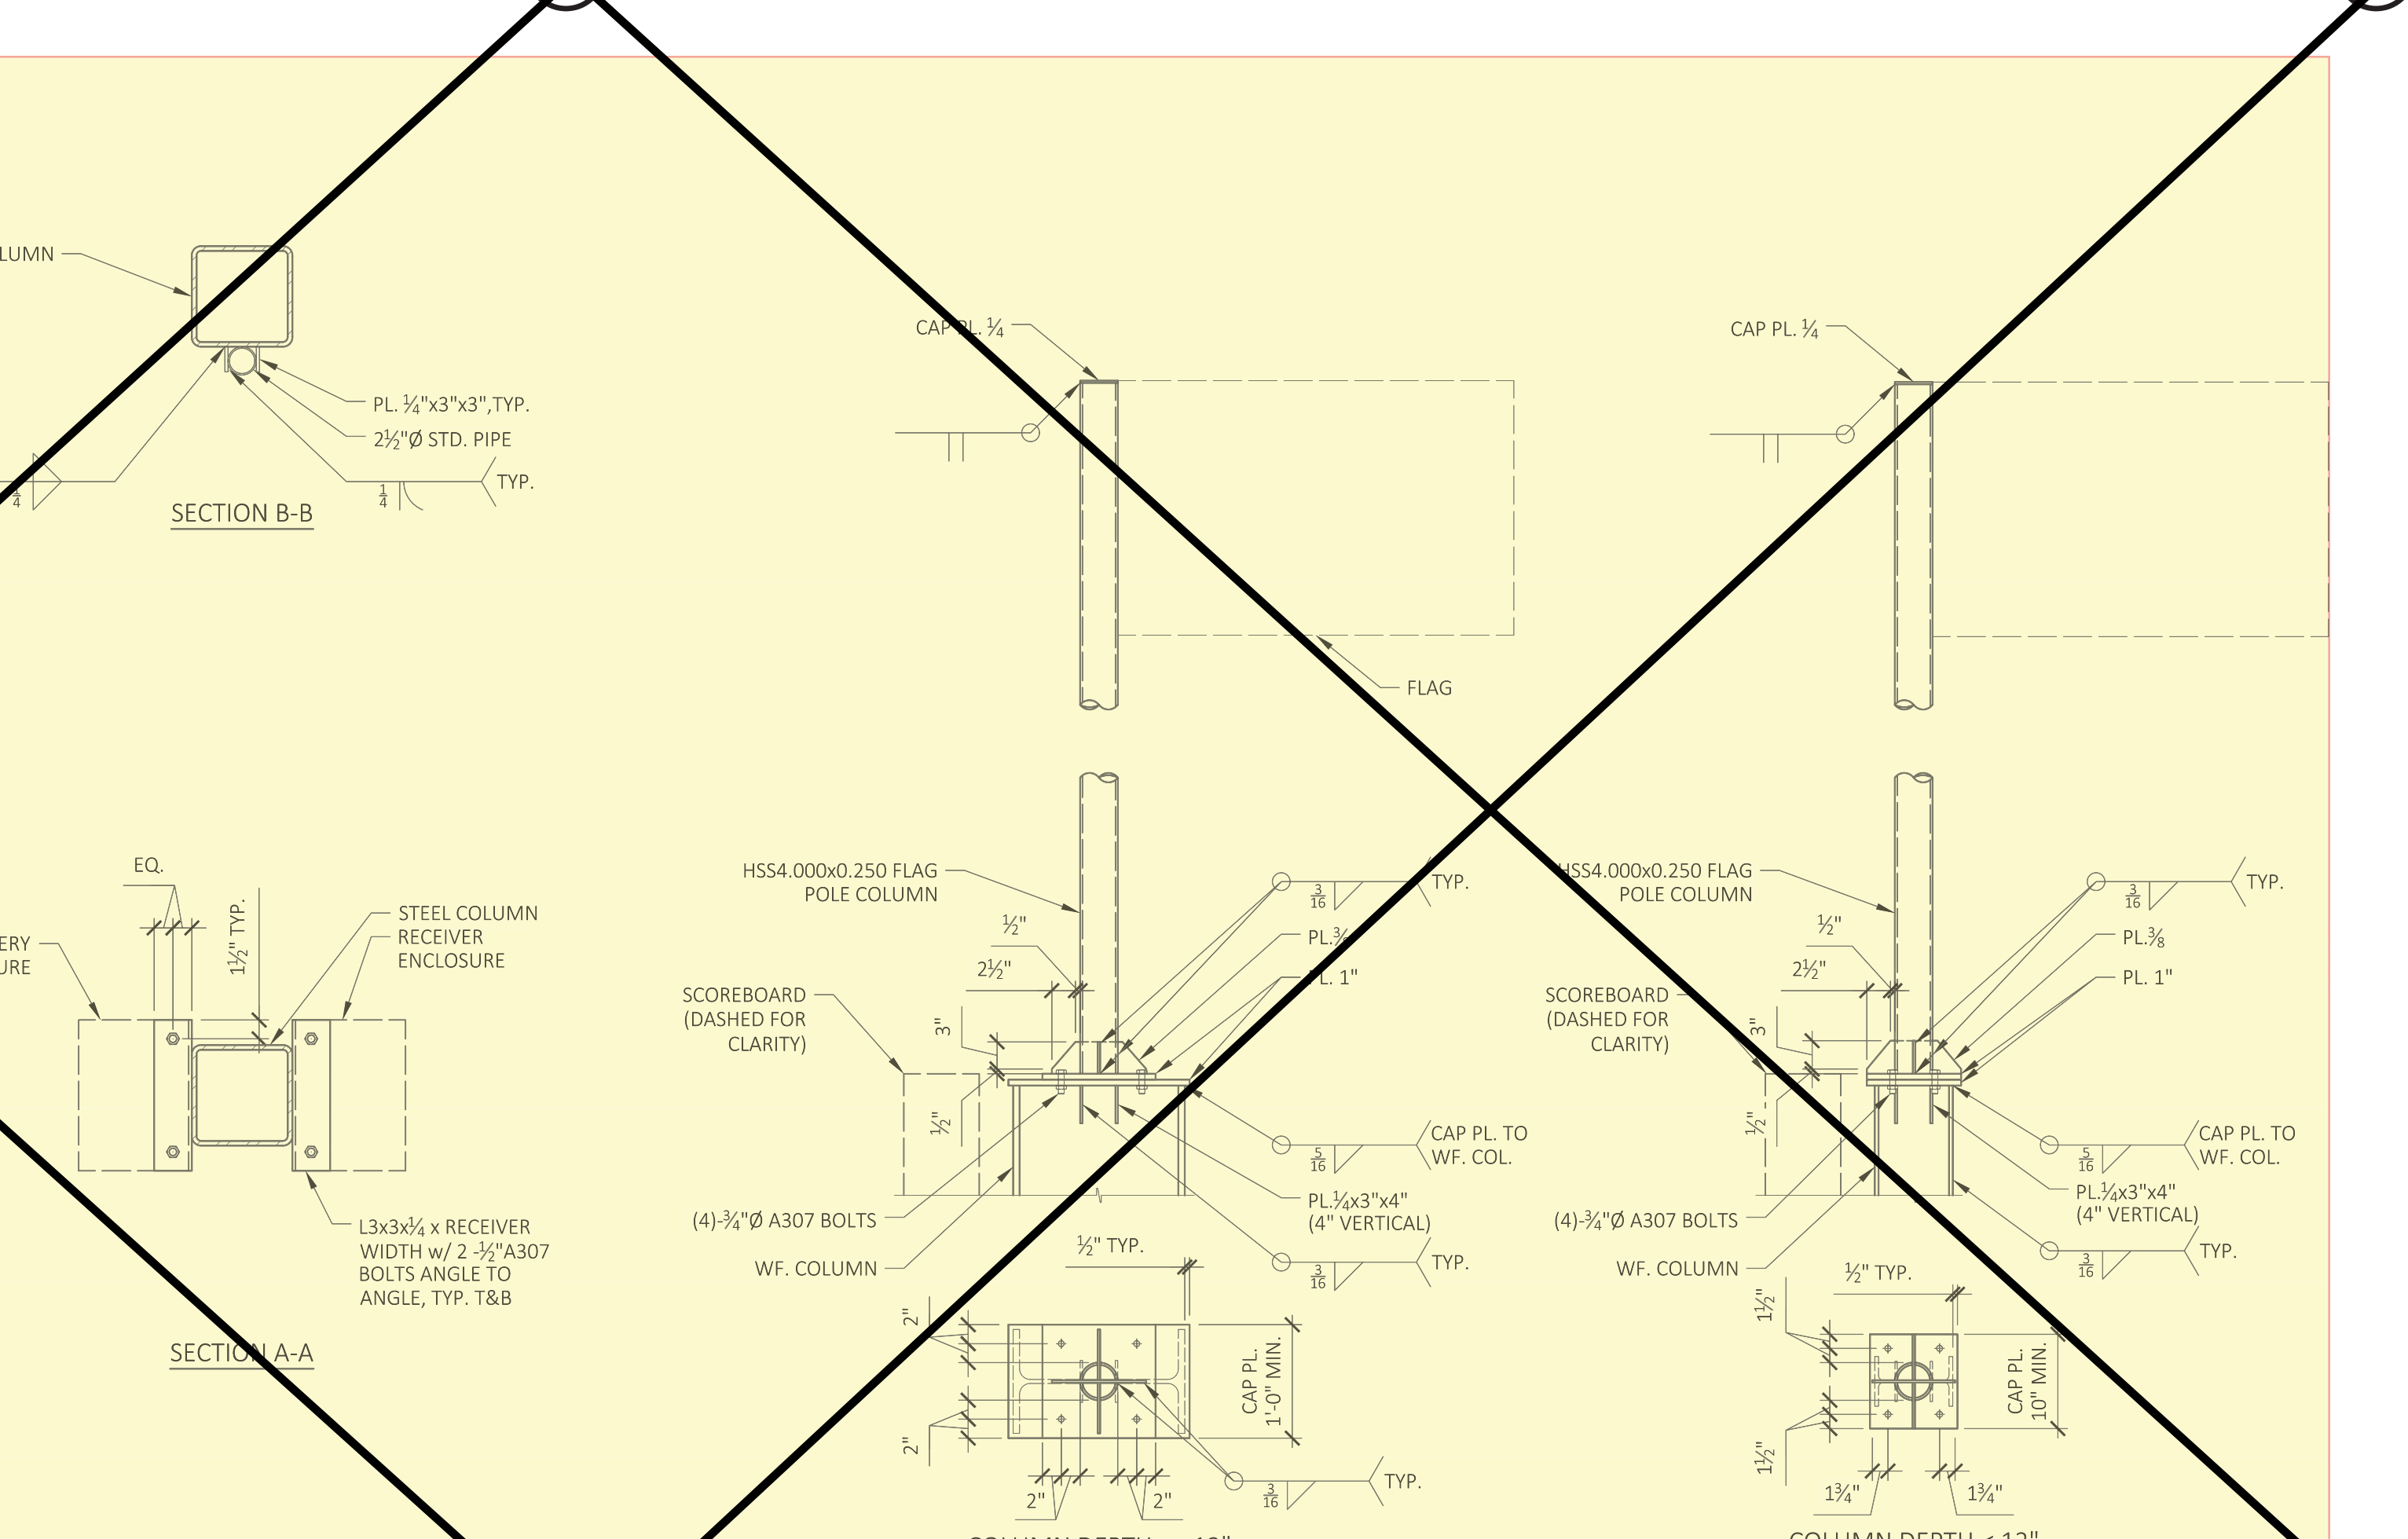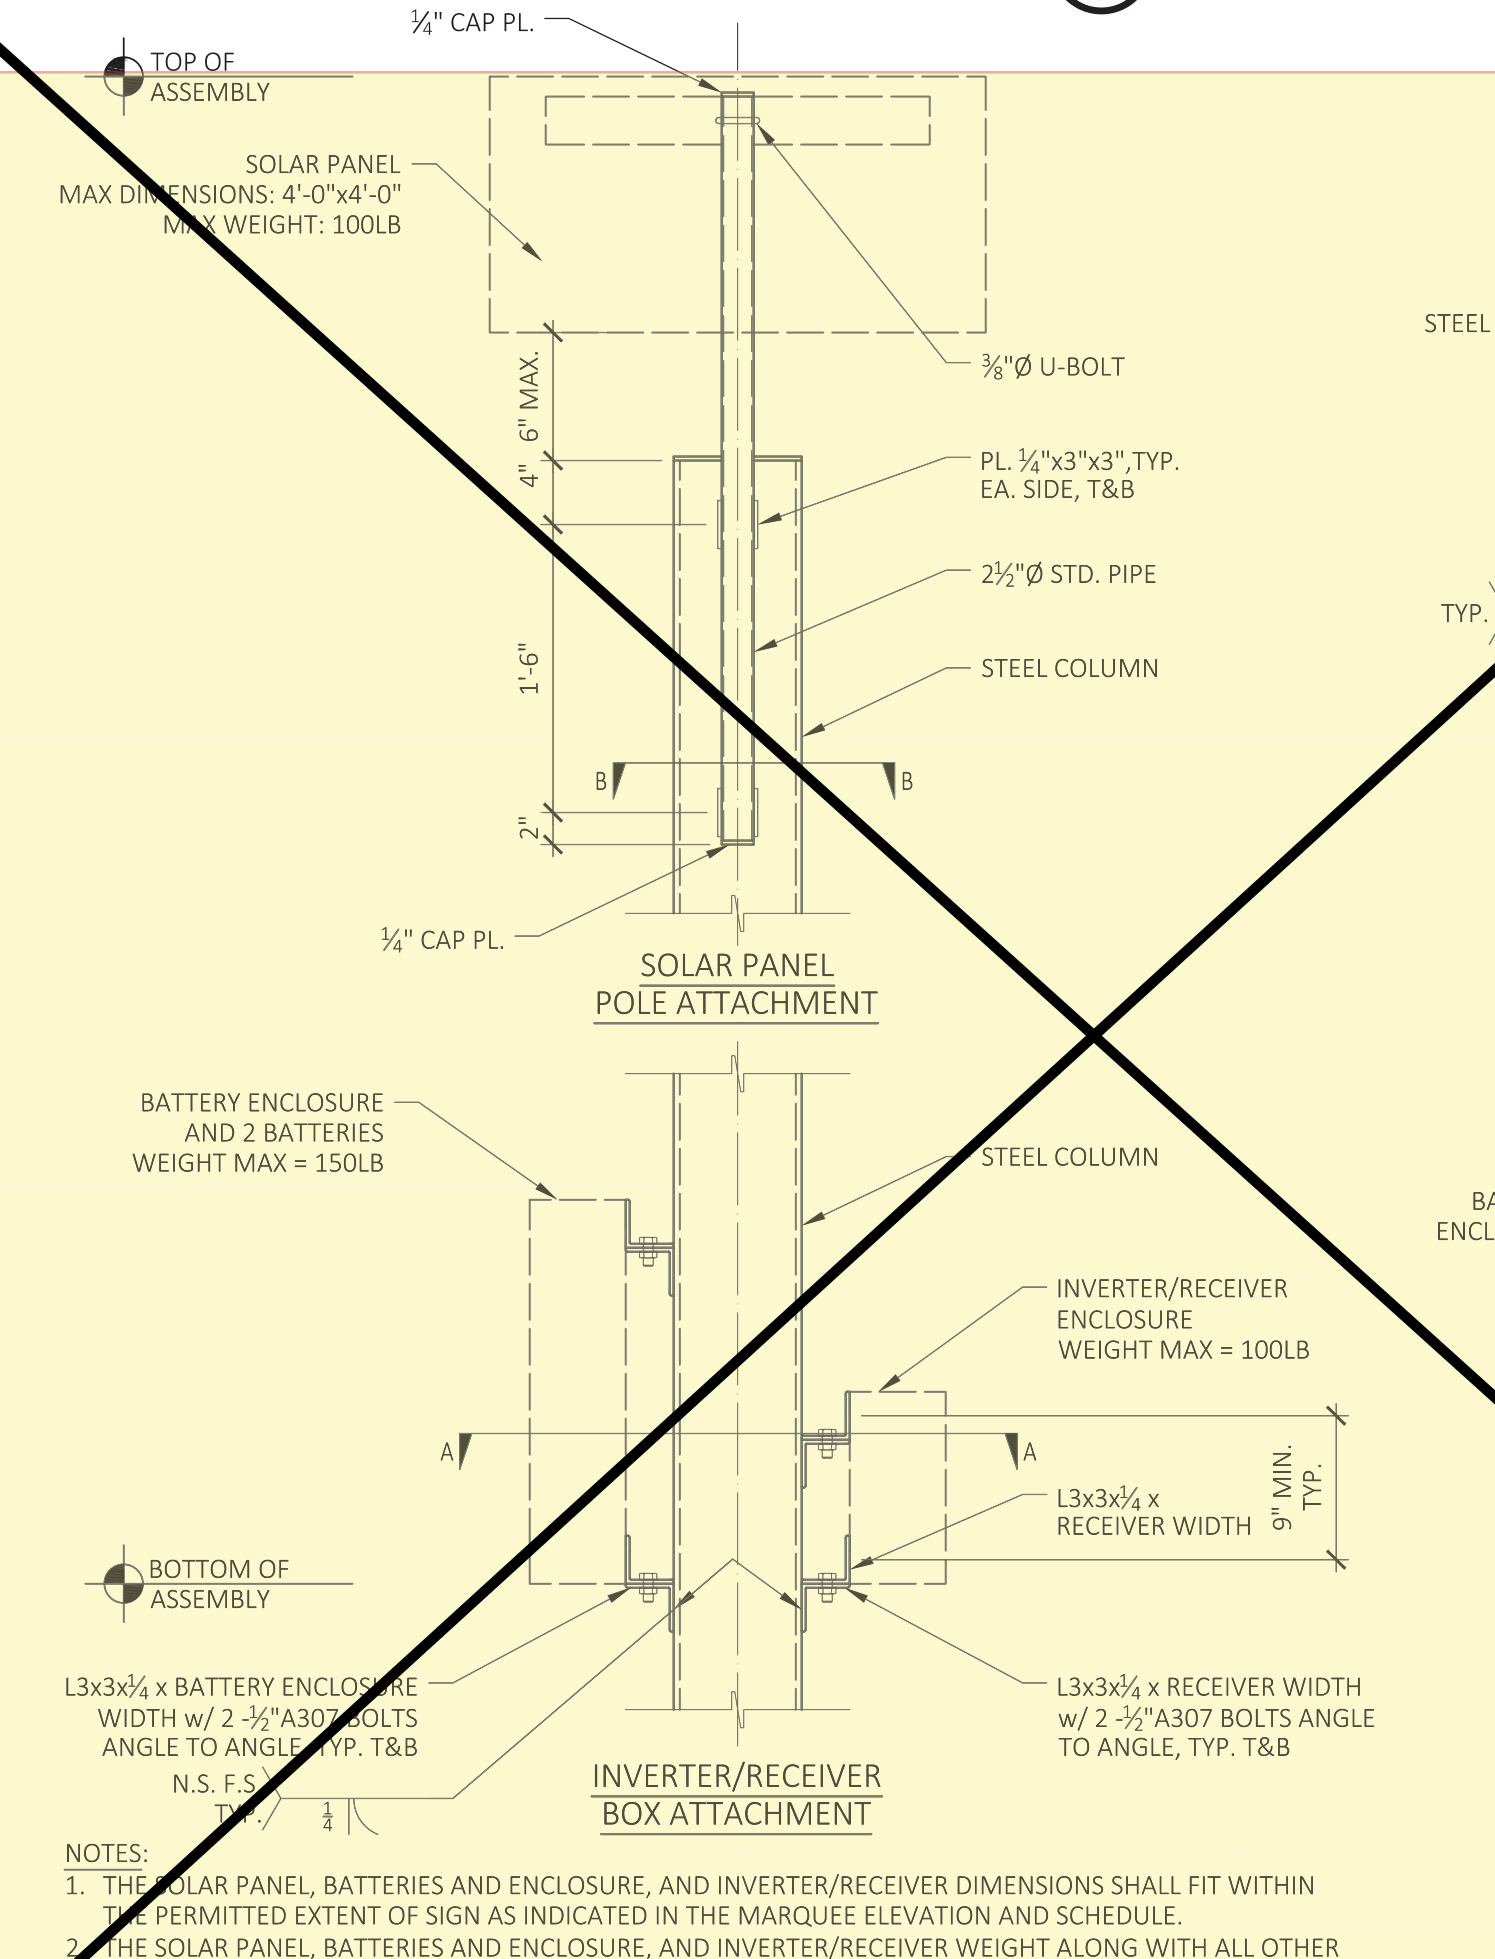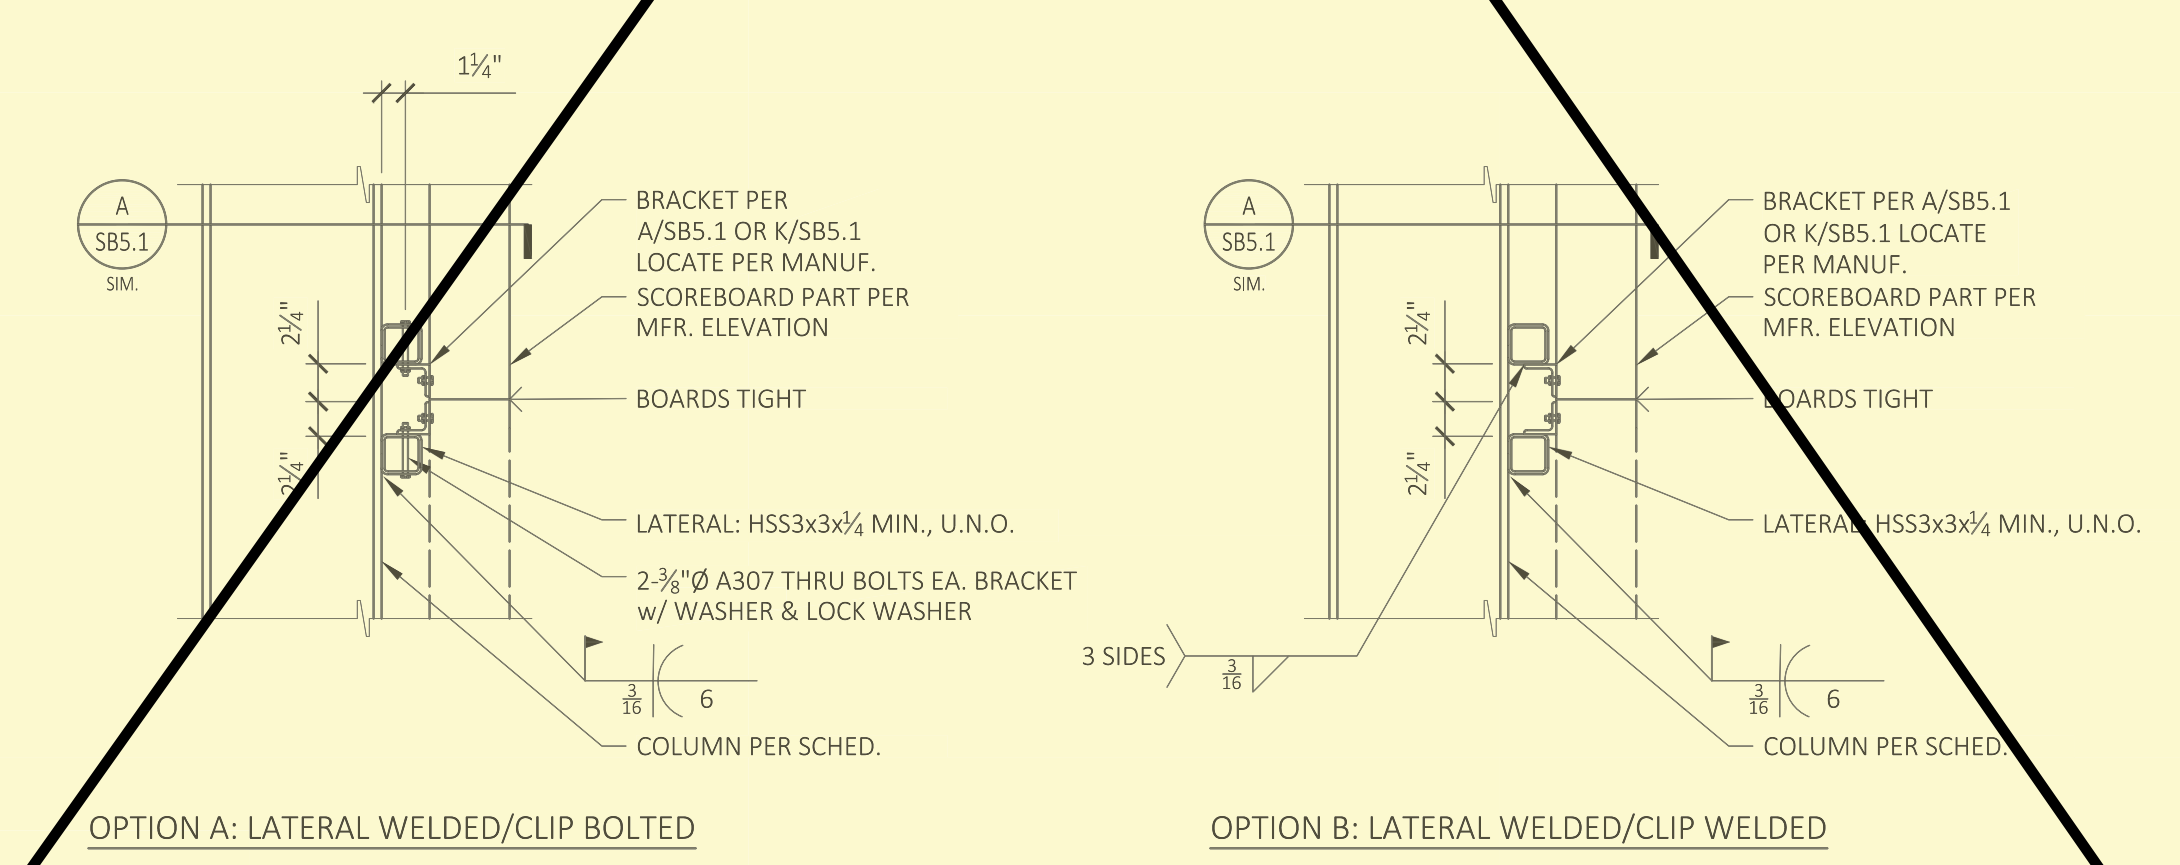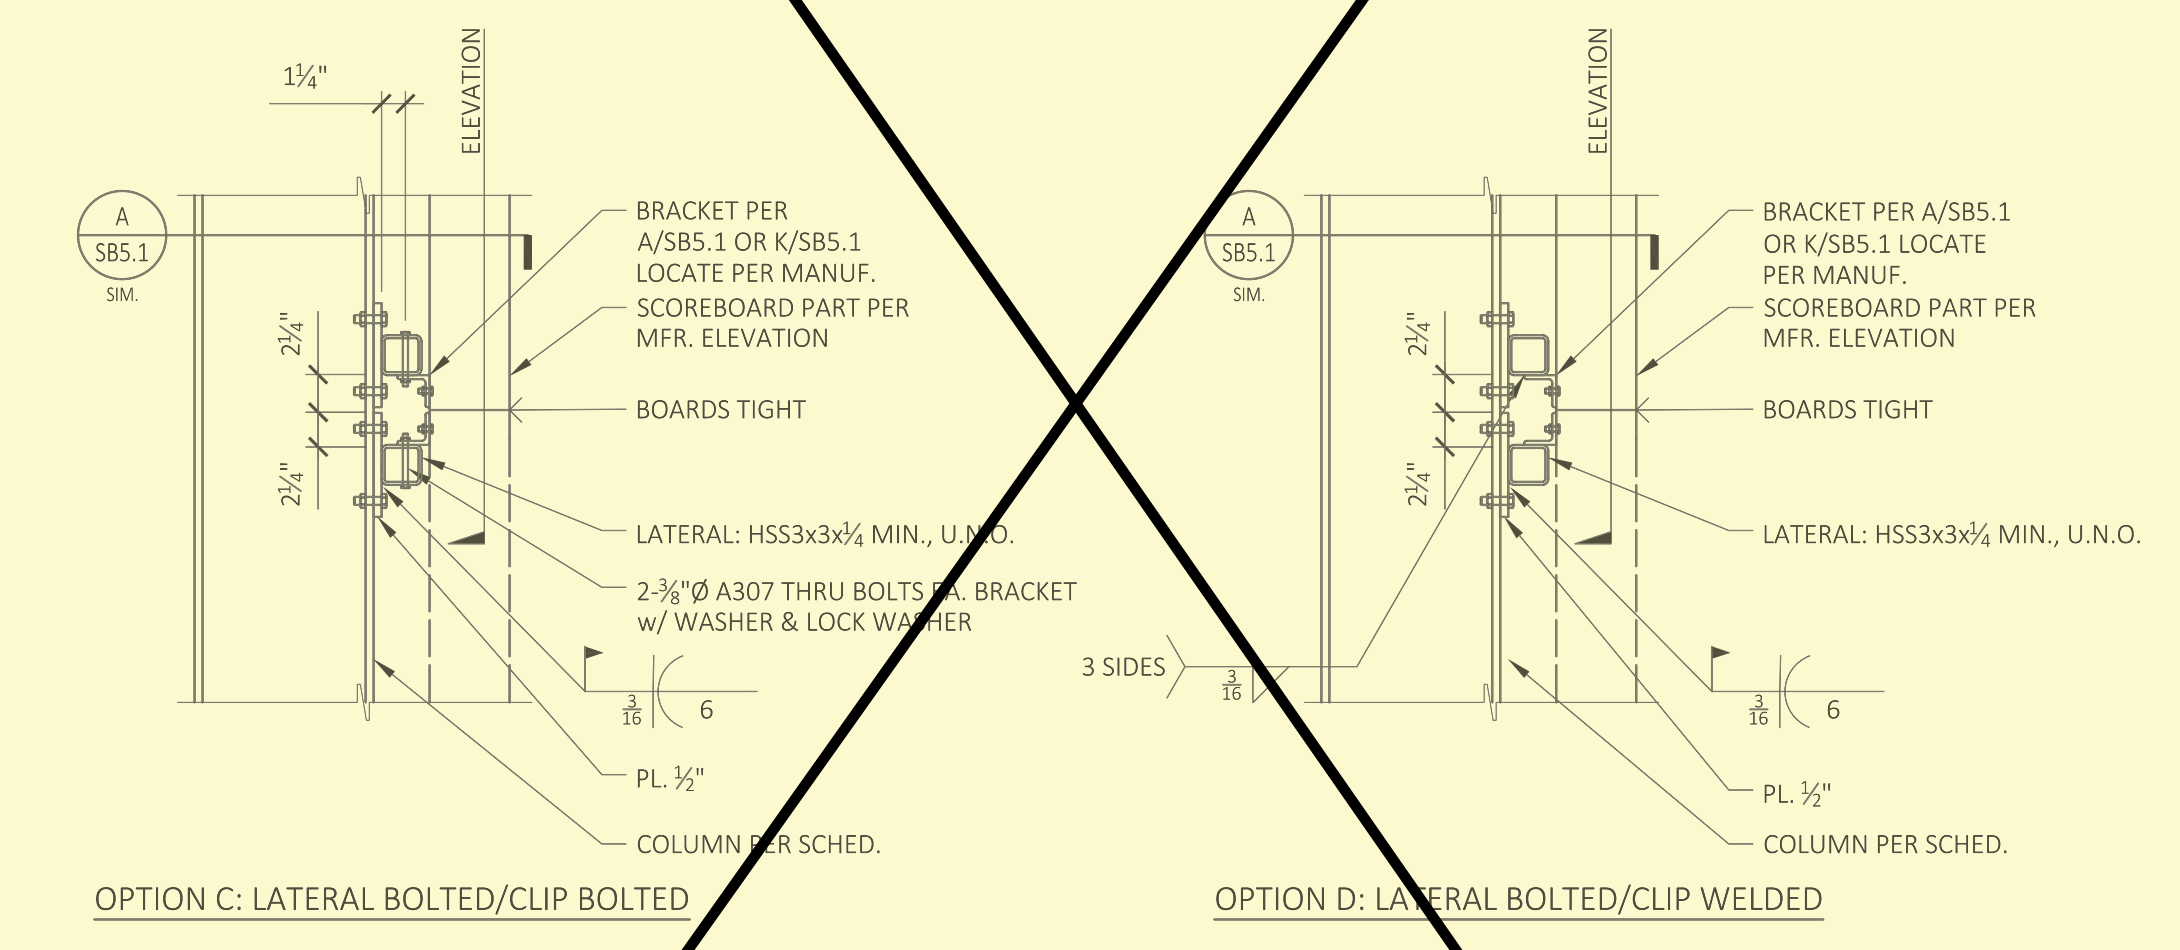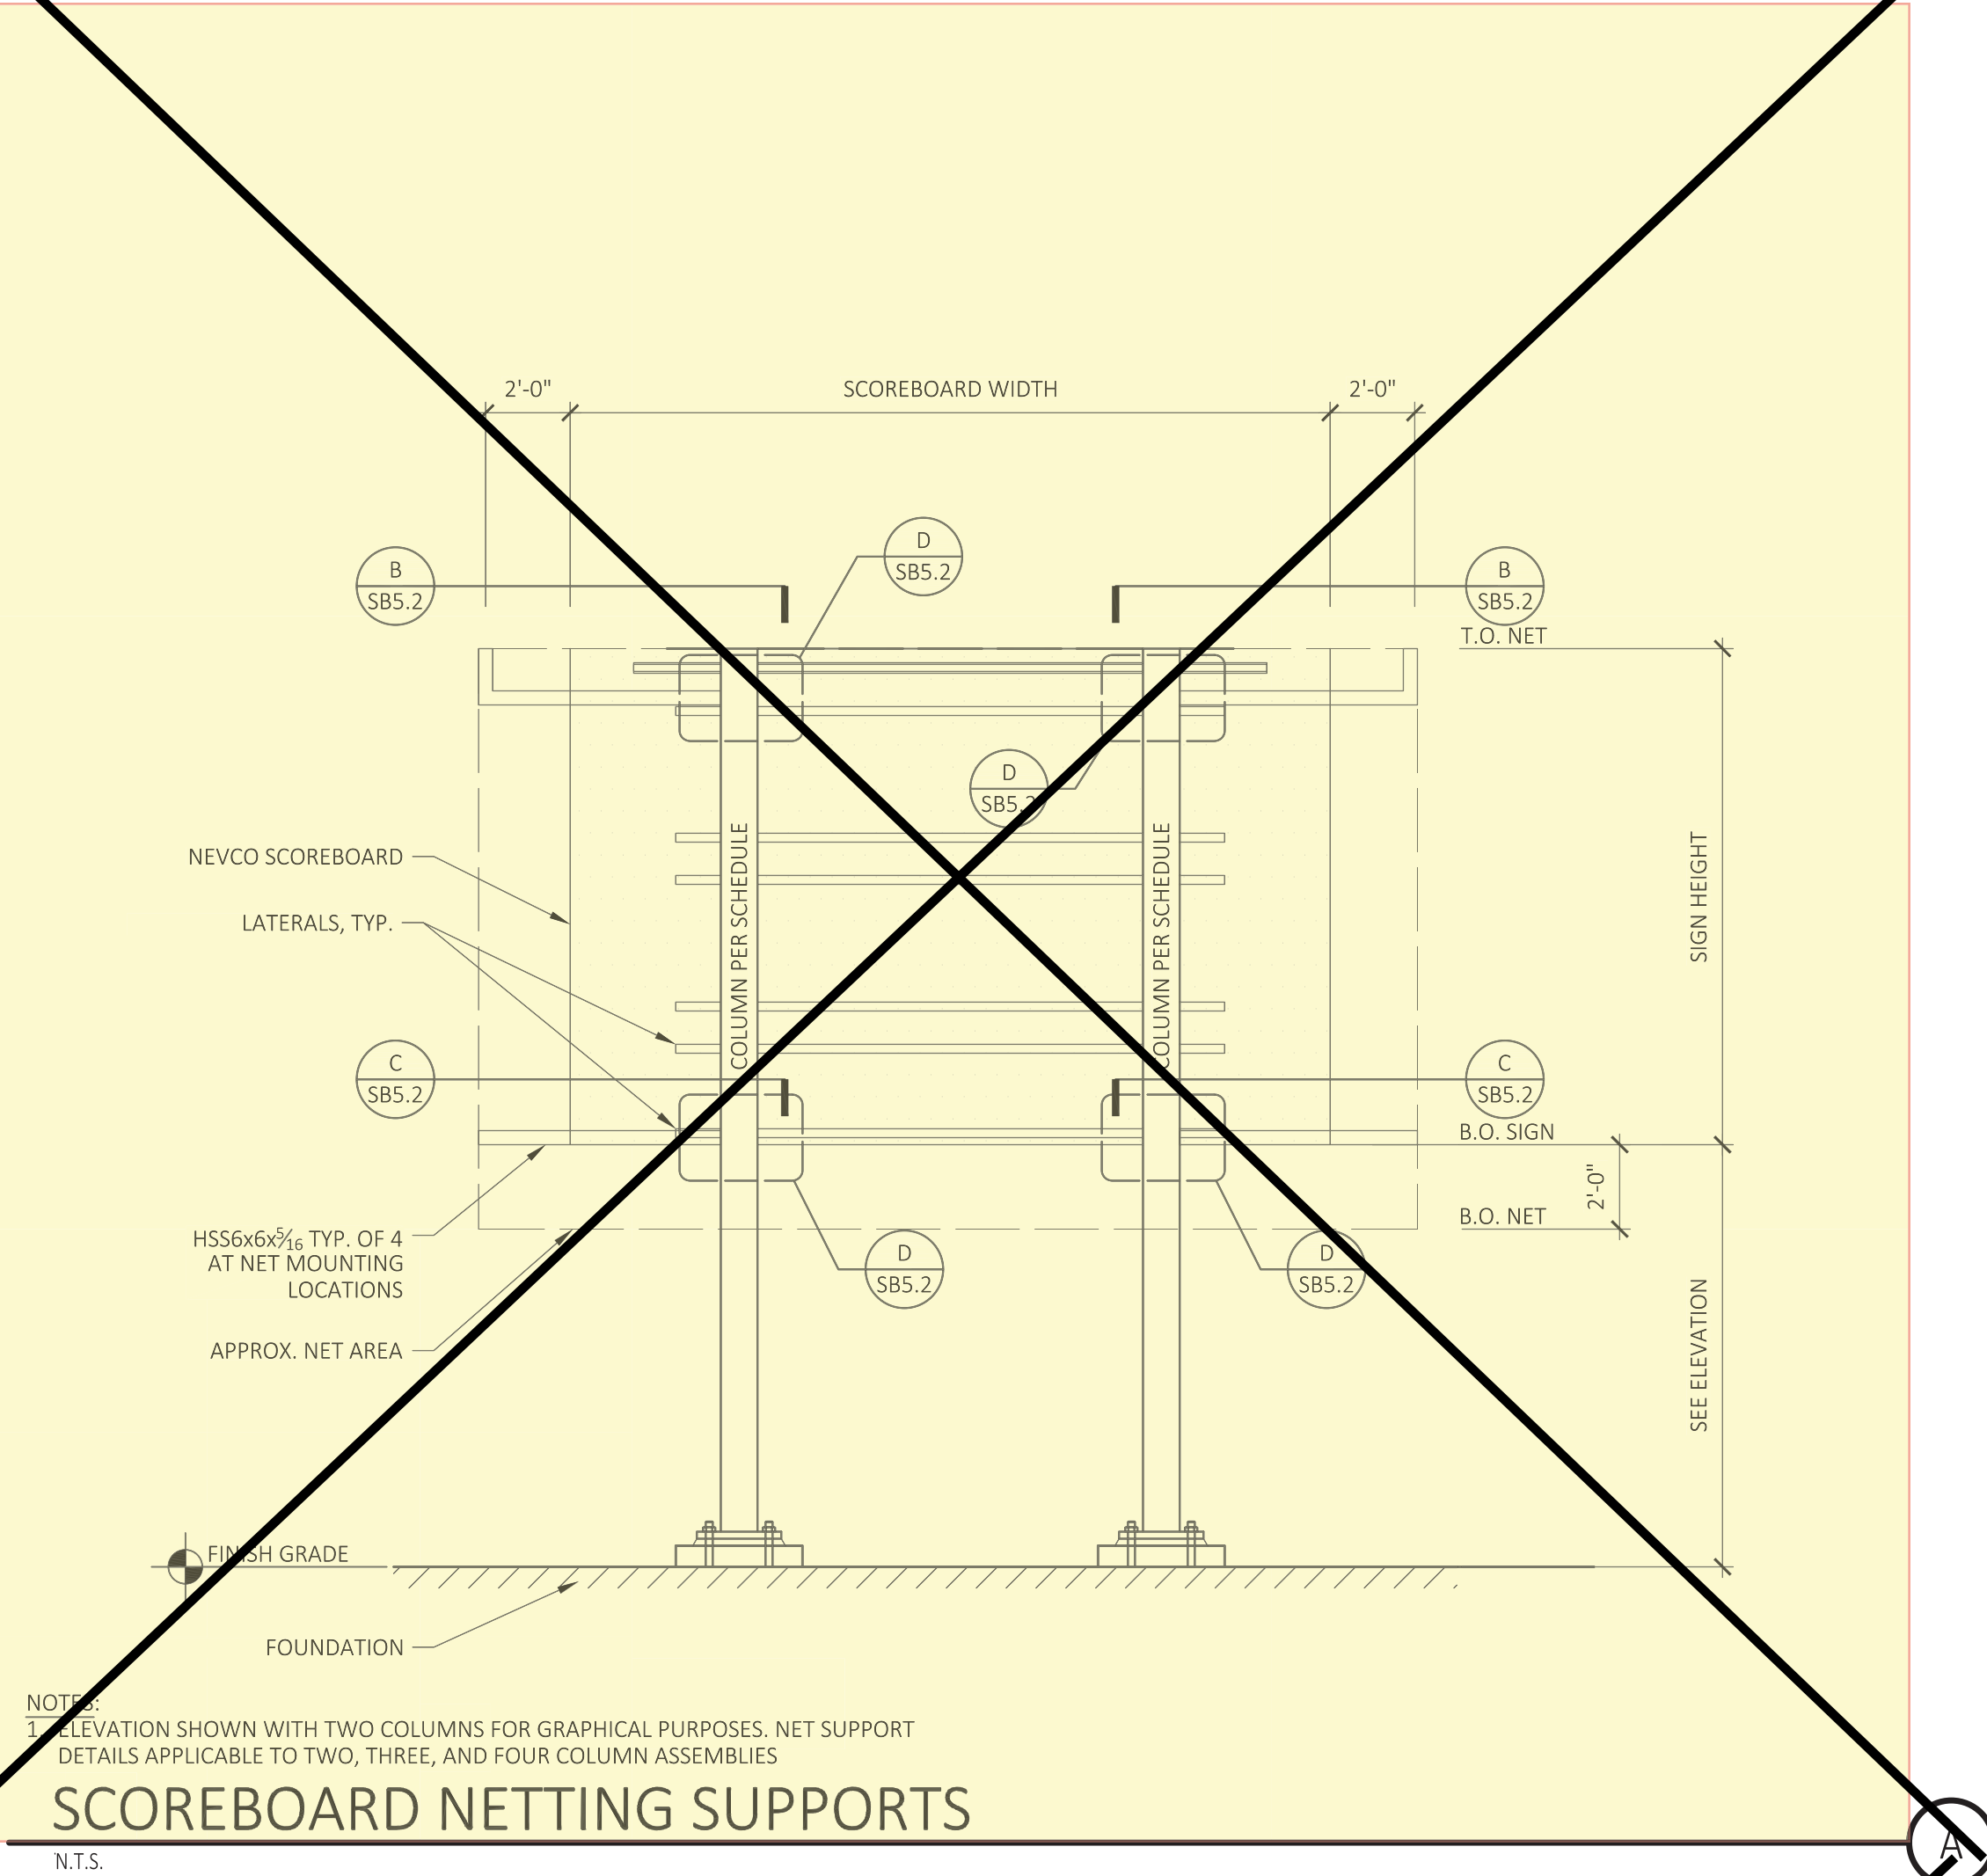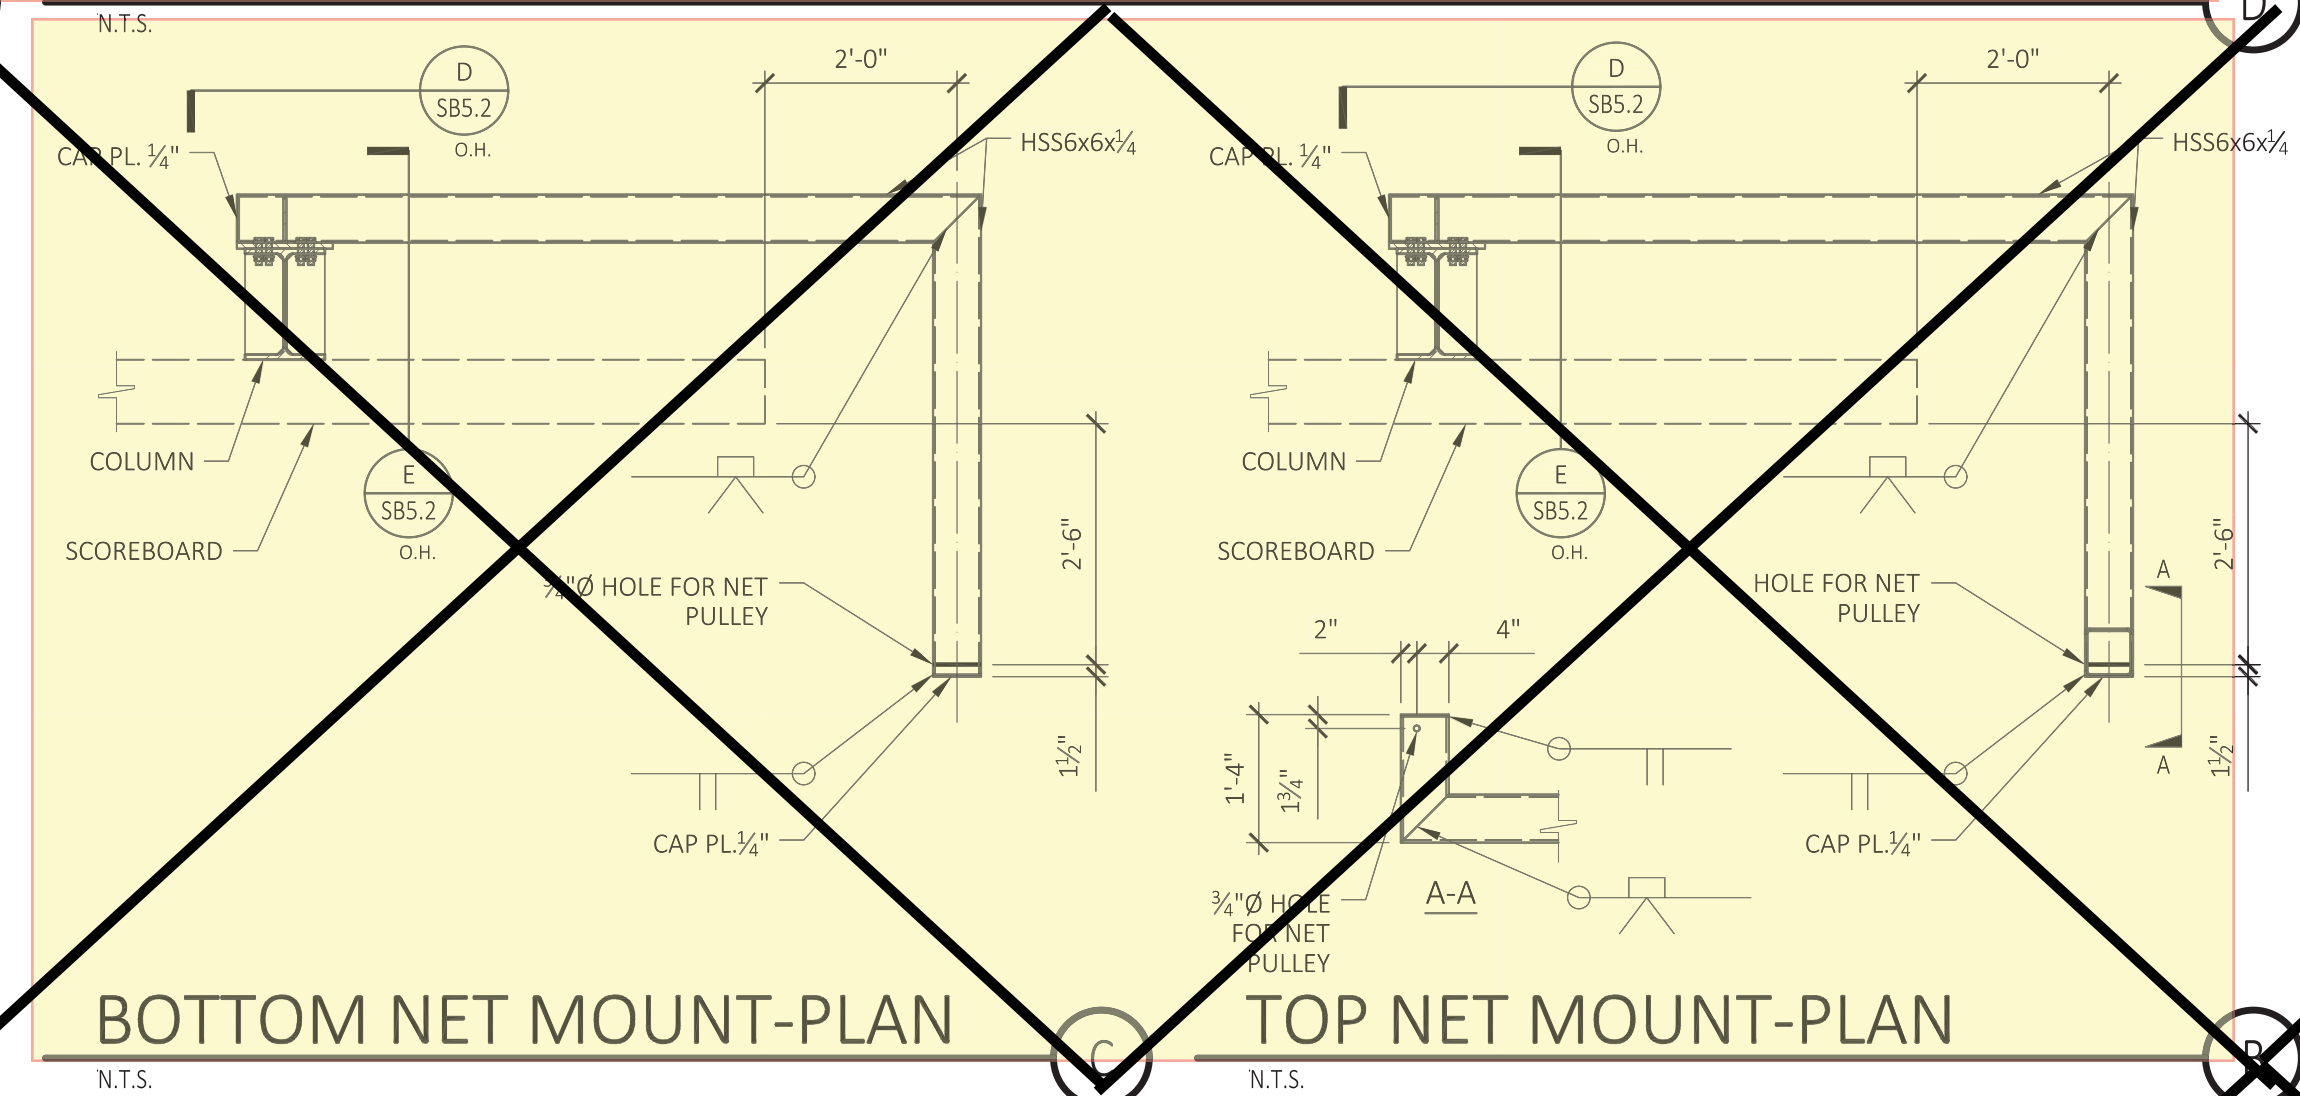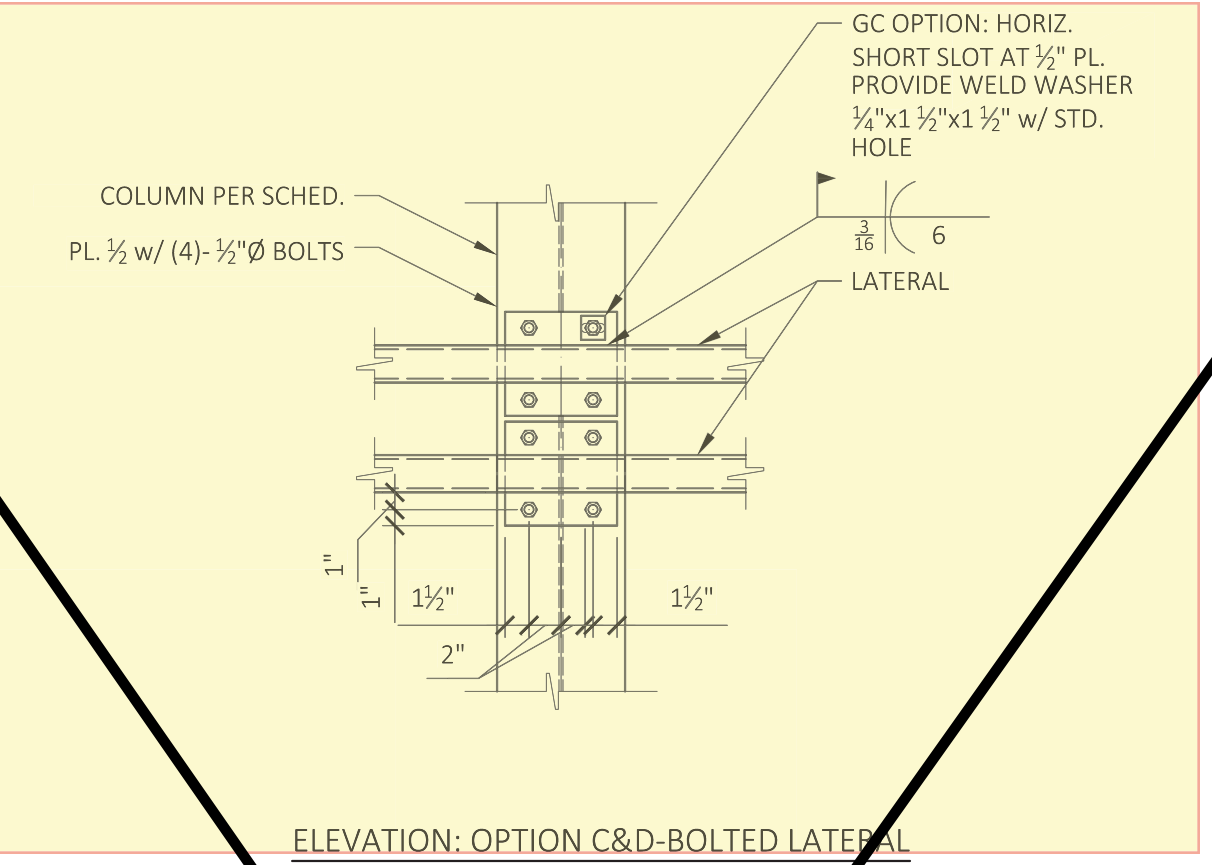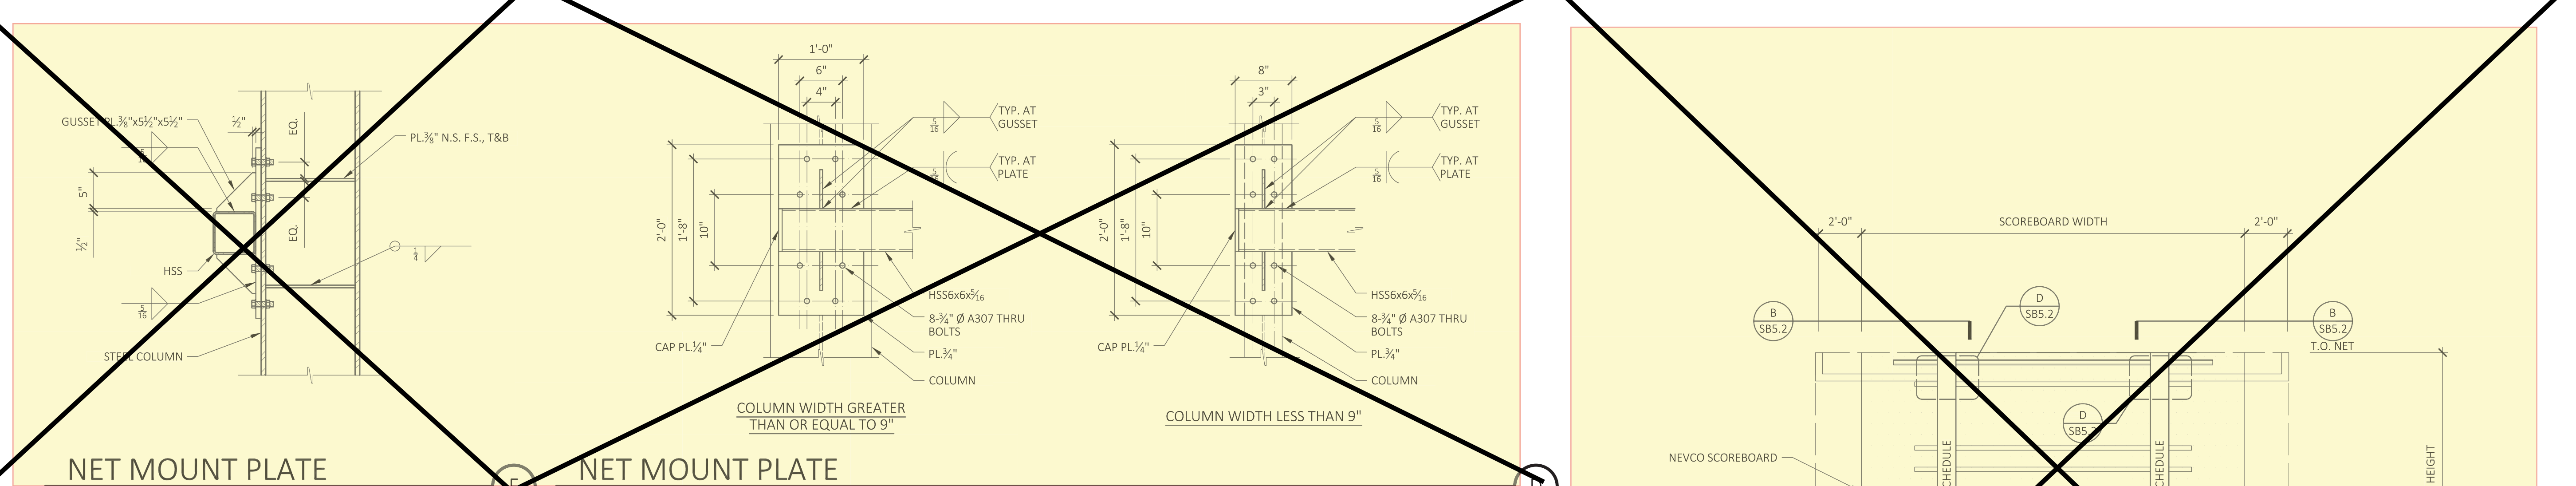APPROVED ARCHITECT
DIV. OF THE STATE ARCHITECT
APP: 04-11966 PC
REVIEWED FOR
SS [] FL [] ACS [] CG []
DATE: 05/04/2021

PRE-CHECK (PC) DOCUMENT
CODE: 2019

A separate project application for construction is required.

HIRAM JOHNSON HS BS, SB & GOLF PROJECT
SCOREBOARD MODEL 7632,
18" WIDE x 9' HIGH WITH
36" HIGH AD-BOLTED TO TOP
COLUMNS BOLT TO PIERS
2019 CBC

OPTIONAL SCOREBOARD FEATURE ATTACHMENT DETAILS

SHEET INFORMATION

DATE: 03.25.2021

DRAWN: JMK

CHECKED: MEP

SSG JOB #: S20284

SHEET: SB5.2