

ABBREVIATIONS:	
A	AMPERE
AF	ABOVE FINISHED FLOOR
AFG	ABOVE FINISHED GRADE
ANN	ANNUNCIATOR
AP	ACCESS POINT
BFF	BELOW FINISHED FLOOR
BFG	BELOW FINISHED GRADE
BICSI	BUILDING INDUSTRY CONSTRUCTION SERVICE INTERNATIONAL
BLDG	BUILDING
C	CONDUIT
CAB	CABINET
CAT	CATEGORY
CATV	CABLE TELEVISION
CD	CANDELA
CFOI	CONTRACTOR FURNISHED/CONTRACTOR INSTALLED
CL	CENTER LINE
CO	CARBON MONOXIDE
DN	DOWN
(E)	EXISTING
EMT	ELECTRICAL METALLIC TUBING
EOL	END OF LINE
FA	FIRE ALARM
FACP	FIRE ALARM CONTROL PANEL
FTC	FIRE TERMINAL CABINET
GRC	GALVANIZED RIGID CONDUIT
G OR GB	GROUND BOX
IACP	INTRUSION ALARM CONTROL PANEL
IDF	INTERMEDIATE DISTRIBUTION FRAME
IMC	INTERMEDIATE METAL CONDUIT
J OR JB	JUNCTION BOX
MEP	MECHANICAL / ELECTRICAL / PLUMBING
MDF	MAIN DISTRIBUTION FRAME
MPOE	MINIMUM POINT OF ENTRY
(N)	NEW
NFPA	NATIONAL FIRE PROTECTION ASSOCIATION
NTS	NOT TO SCALE
N/A	NOT APPLICABLE
OFE	OWNER FURNISHED EQUIPMENT
OF	OWNER FURNISHED/CONTRACTOR INSTALLED
OF	OWNER FURNISHED/OWNER INSTALLED
OSP	OUTSIDE PLANT
PVC	POLYVINYL CHLORIDE
RCDD	REGISTERED COMMUNICATION DISTRIBUTION DESIGNER
RCWY	RACEWAY
RM	ROOM
SR	SURFACE RACEWAY
TYP	TYPICAL
UG	UNDERGROUND
UL	UNDERWRITERS LABORATORIES
UNO	UNLESS NOTED OTHERWISE
V	VOLTS
W	WATT
WP	WEATHERPROOF

TECHNOLOGY SYMBOL LEGEND: ALL EQUIPMENT AND MATERIALS ARE CONTRACTOR FURNISHED, INSTALLED AND CONFIGURED (UNO)				
SYMBOL	DESCRIPTION	MANUFACTURER	PART NUMBER	NOTES / DETAIL REFERENCES
	(N) SURFACE MOUNTED CONDUIT	COMMERCIAL GENERIC	N/A	GREY = EXISTING
	(E) UNDERGROUND CONDUIT	N/A	N/A	N/A
	(N) MEDIUM CAPACITY SURFACE MOUNTED CABLE RACEWAY	WIREMOLD	WM2300	GREY = EXISTING
	(N) HIGH CAPACITY SURFACE MOUNTED CABLE RACEWAY	WIREMOLD	WM5400	GREY = EXISTING
	(N) CONDUIT STUB	COMMERCIAL GENERIC	N/A	GREY = EXISTING
	(E) CONDUIT RISER	N/A	N/A	N/A
	(E) DATA RACK	EXISTING	EXISTING	N/A
	(E) GROUND BOX	N/A	N/A	N/A
	(N) JUNCTION BOX	COMMERCIAL GENERIC	N/A	GREY = EXISTING
	(E) MINIMAL POINT OF ENTRY	EXISTING	EXISTING	N/A
	(E) INTERCOM CONTROL CENTER HEADEND	EXISTING	EXISTING	N/A
	(E) INTRUSION KEYPAD	EXISTING	EXISTING	N/A
	(N) CAT8A DATA DROP LOCATION (QTY = 1) - IP CLOCK/SPEAKER/MP MODULE COMBO BOX	RAULAND	SEE SHEET T400	N/A
	(N) CAT8A DATA DROP LOCATION - WALL MOUNTED SPEAKER/MP MODULE	RAULAND	SEE SHEET T400	N/A
	(N) CAT8A DATA DROP LOCATION - EXTERIOR INTERCOM SPEAKER/MP MODULE	RAULAND & LOWELL	SEE SHEET T400	N/A
	(N) CAT8A DATA DROP LOCATION - LARGE MESSAGE BOARD	RAULAND	SEE SHEET T400	N/A
	(N) CAT8A DATA DROP LOCATION - EXTERIOR WIRELESS ACCESS POINT	SEE 27 10 00	SEE 27 10 00	QTY. AS PER PLAN
	(N) CAT8A DATA DROP LOCATION - EXTERIOR WIRELESS ACCESS POINT	SEE 27 10 00	SEE 27 10 00	N/A

PRE-CON MEETING REQUIREMENTS:
1. PRIOR TO BEGINNING ANY SITE WORK, INCLUDING DEMO, AN ON-SITE PRE-CONSTRUCTION MEETING SHALL BE HELD WITH THE LOW VOLTAGE DESIGNER. ANY SITE WORK COMMENCED PRIOR TO THIS MEETING SHALL BE AT THE CONTRACTOR'S SOLE RISK.

JOB SPECIFIC STANDARDS FOR LOW VOLTAGE:
SEE SPECIFICATIONS DIVISION 27 AND 28 FOR COMPLETE REQUIREMENTS.
1. CONDUIT BODIES, CONDULETS, PULLING ELBOWS, AND/OR "LB" FITTINGS ARE PROHIBITED IN ANY PATHWAY CONTAINING DATA CABLEING (COPPER OR FIBER).
2. SINGLE HOLE CONDUIT STRAPS ARE PROHIBITED.
3. ALL WIRE AND CABLE PASSING THROUGH METALWORK SHALL BE SLEEVED WITH AN APPROPRIATE GROMMET OR BUSHING.

SYSTEM PROGRAMMING AND COMMISSIONING REQUIREMENTS:
1. THE DISTRICT WILL PERFORM ALL DATA NETWORK (CISCO) SWITCH PROGRAMMING. ALL OTHER PROGRAMMING/COMMISSIONING IS THE RESPONSIBILITY OF THE CONTRACTOR.
2. TO FACILITATE DATA NETWORK SWITCH PROGRAMMING BY THE DISTRICT, THE CONTRACTOR SHALL PROVIDE, NO LATER THAN 14 CALENDAR DAYS PRIOR TO CUTOVER, AN INVENTORY OF SWITCH PORTS THAT WILL BE UTILIZED BY THE TELECENTER SYSTEM. THIS SHALL INCLUDE ALL DATA DROPS, NEW AND EXISTING.

PAINT SCOPE OF WORK:
1. CONTRACTOR SHALL PATCH AND PAINT ALL WALL AND CEILING SURFACES DISTURBED OR EXPOSED AS A RESULT OF DEMO TO MATCH THE ADJACENT EXISTING SURFACE.
2. CONTRACTOR SHALL CLEAN, PRIME, AND PAINT ALL (N) CONDUIT AND J-BOXES THAT RUN AGAINST FINISHED WALLS, TO MATCH THE ADJACENT WALL SURFACE.
3. CONTRACTOR SHALL COORDINATE WITH DISTRICT REPRESENTATIVE FOR PAINT COLORS AND SPECIFICATIONS.

SCOPE OF WORK:
1. 1. THE CONTRACTOR SHALL PROVIDE A (N) RAULAND TELECENTER U INTERCOM SYSTEM IN ACCORDANCE WITH THE PLANS AND SPECIFICATIONS.
2. THE CONTRACTOR SHALL REWORK THE (E) IDF AND MDF LOCATIONS, INCLUDING INSTALLATION OF (N) OWNER-FURNISHED DATA NETWORK SWITCHES, AS NOTED.
3. THE CONTRACTOR SHALL PROVIDE AND PERFORM OTHER DATA NETWORK INSTALLATION AND REWORK AS NOTED.
4. SYSTEMS ON THIS PROJECT REQUIRE CERTIFIED INSTALLERS. CONTRACTOR SHALL COMPLY WITH ALL CERTIFICATION REQUIREMENTS AS A CONDITION OF BID.
5. ALL EQUIPMENT SHALL BE NEW AND CONTRACTOR FURNISHED, UNO.
6. AFTER CUTOVER TO NEW SYSTEMS, THE CONTRACTOR SHALL REMOVE OLD OR ABANDONED DATA NETWORK, AUDIOVISUAL, ANALOG TELEPHONE, ANALOG INTERCOM, ANALOG CLOCK, AND COAX CABLEING AND DEVICES AS NOTED.
7. THE PROJECT WILL REQUIRE SWING AND/OR GRAVEYARD AND/OR WEEKEND AND/OR HOLIDAY WORK SCHEDULES IN ORDER TO MEET THE PROJECT REQUIREMENTS AND MINIMIZE DISRUPTION TO THE ACTIVE USE OF THE SITE.
8. THE CONTRACTOR SHALL CAREFULLY COORDINATE CUTOVERS AND ACTIVATION/COMMISSIONING OF NEW SYSTEMS WITH THE DISTRICT REPRESENTATIVE.
9. THE CLOCK/INTERCOM SYSTEM AND ALL DATA NETWORK SYSTEMS SHALL BE MAINTAINED OPERATIONAL AT ALL TIMES THAT SCHOOL IS IN SESSION.

CONTRACTOR FURNISHED DOCUMENTS:
(SHOP DRAWINGS / PRODUCT SUBMITTALS / QUALIFICATIONS)
1. ORDERING AND INSTALLATION OF THE SYSTEMS SHALL NOT BE STARTED UNTIL THE FOLLOWING:
1.1. CONTRACTOR FURNISHED SHOP DRAWINGS ARE RECEIVED AND APPROVED BY THE DESIGNER.
1.2. PRODUCT SUBMITTAL DOCUMENTS ARE RECEIVED AND APPROVED BY THE DESIGNER.
1.3. APPLICABLE QUALIFICATION DOCUMENTATION ARE RECEIVED AND APPROVED BY THE DESIGNER.
2. ANY DESIGN AND/OR INSTALLATION DISCREPANCIES/CHANGE ORDER REQUESTS ARE TO BE ADDRESSED AT TIME OF SHOP DRAWING CREATION. CHANGE ORDERS AFTER APPROVED SHOP DRAWINGS ARE THE SOLE RESPONSIBILITY OF THE CONTRACTOR.
3. ALTERNATIVE PRODUCTS ARE TO SUBMITTED WITH A FORMAL SUBSTITUTION REQUEST AND THE CONTRACTOR IS RESPONSIBLE FOR DEMONSTRATING PRODUCT FULL EQUIVALENCY.
4. IT SHALL BE UNDERSTOOD THAT THE DRAWINGS, DETAILS, AND ONE-LINES PROVIDED WITH THE DESIGN PACKAGE ARE DIAGRAMMATIC. INFORMATION PRESENTED IN DESIGN DRAWINGS ARE AS ACCURATE AS POSSIBLE, BUT ACCURACY IS NOT GUARANTEED AND FIELD VERIFICATION OF ALL DIMENSIONS, ROUTING, ETC., BY THE CONTRACTOR IS REQUIRED.
5. DRAWINGS AND SPECIFICATIONS ARE PROVIDED TO SHOW THE INTENT OF THE DESIGN TO ASSIST THE CONTRACTOR IN SUBMITTING AN ACCURATE BID. CONTRACTOR IS DIRECTED TO MAKE FIELD SURVEYS AS PART OF THEIR WORK PRIOR TO SUBMITTING SYSTEM LAYOUT DRAWINGS (SHOP DRAWINGS). THE CONTRACTOR SHALL MAKE ALLOWANCE IN THE PROPOSAL TO COMPLY WITH THE INTENT OF THE DESIGN.
6. IN CASE OF DOUBT OF WORK INTENDED, IT IS THE RESPONSIBILITY OF THE CONTRACTOR TO REQUEST INSTRUCTIONS FROM THE DESIGNER OR OWNER PRIOR TO BID.
7. THE CONTRACTOR SHALL BE RESPONSIBLE FOR INSTALLING A COMPLETE, OPERABLE, AND FULLY FUNCTIONING SYSTEM.

TECHNOLOGY GENERAL PROJECT NOTES:
1. UPON COMPLETION OF THE INSTALLATION OF THE SYSTEMS, THE CONTRACTOR SHALL PROVIDE A SATISFACTORY TEST OF THE ENTIRE SYSTEMS IN THE PRESENCE OF THE ARCHITECT/DESIGNER, INSPECTOR, AND THE OWNER.
2. A STAMPED SET OF APPROVED SYSTEM DESIGN DOCUMENTS, AND CONTRACTOR FURNISHED SHOP DRAWINGS SHALL BE ON THE JOB SITE AND USED FOR INSTALLATION. THE CONTRACTOR SHALL INCORPORATE ANY AND ALL REVISIONS TO DRAWINGS SETS AS REQUIRED. ANY DEVIATION FROM APPROVED DESIGN DOCUMENTS, INCLUDING THE SUBSTITUTION OF DEVICES, SHALL BE APPROVED BY THE ARCHITECT/DESIGNER AND THE OWNER PRIOR TO INSTALLATION.
3. ANY DISCREPANCIES BETWEEN THE DRAWINGS AND THE CODE OR RECOGNIZED STANDARDS SHALL BE BROUGHT TO THE ATTENTION OF THE ARCHITECT/DESIGNER PRIOR TO INSTALLATION.
4. ALL PENETRATIONS THROUGH RATED ASSEMBLIES REQUIRING OPENING PROTECTION SHALL BE PROVIDED WITH THROUGH PENETRATION FIRST STOP SYSTEMS WITH A "T" RATING EQUAL TO THE ASSEMBLY PENETRATED. SEE DETAILS ON SHEET T801 FOR MORE INFORMATION.
5. PER CEC STANDARDS, ALL WIRING IS TO BE PULLED THROUGH EACH JUNCTION BOX AND CONNECTED DIRECTLY TO EACH DEVICE. DO NOT SPLICE THE WIRE. THERE MUST BE AT LEAST 6" OF LEAD WIRE FROM THE BOX TO THE DEVICE.
6. ALL CLOCK, BELL, AND INTERCOM CIRCUITS SHALL BE IN CONDUIT, SURFACE RACEWAY, OR OPEN RUN ABOVE CEILINGS, UNDER FLOORS AND IN WALLS IN A NEAT AND PROTECTED MANNER AS INDICATED ON DESIGN DOCUMENTS. EXPOSED CABLES ARE ONLY PERMITTED IF INDICATED ON DESIGN DOCUMENTS AS "EXPOSED".
7. LOW VOLTAGE PANELS, REMOTES, AND COMPONENTS SHALL BE SECURED TO MOUNTING SURFACES PER MANUFACTURER'S SPECIFICATIONS. NO SINGLE DEVICE SHALL EXCEED THE WEIGHT FOR 20 LBS., WITHOUT SPECIAL MOUNTING DETAILS.
8. THE CONTRACTOR SHALL NOTIFY THE ARCHITECT/DESIGNER AT A MINIMUM OF FIVE (5) WORKING DAYS PRIOR TO FINAL INSPECTION FOR FINAL PUNCH ALL ITEMS ON PUNCH LIST MUST BE COMPLETE FOR JOB TO FINAL.
9. PRIOR TO FINAL INSPECTION, THE CONTRACTOR SHALL PROVIDE ALL PROJECT AS-BUILT DRAWINGS AND MANUALS PER SPECIFICATIONS.
10. THE CONTRACTOR SHALL ALSO PROVIDE A TYPED RECORD OF COMPLETION. A FINAL WILL NOT BE GRANTED UNTIL THE ABOVE IS APPROVED BY THE OWNER.
11. THE TERM "PROVIDE" SHALL MEAN TO FURNISH, INSTALL AND MAKE FULLY OPERATIONAL.

PROJECT CODES AND STANDARDS:
PARTIAL LIST OF APPLICABLE CODES AND STANDARDS EFFECTIVE : JANUARY 1, 2023:
2022 CALIFORNIA ADMINISTRATIVE CODE (CAC), CCR, TITLE 24, PART 1
2022 CALIFORNIA BUILDING CODE (CBC), CCR, TITLE 24, PART 2 (2018 INTERNATIONAL BUILDING CODE WITH CALIFORNIA AMENDMENTS)
2022 CALIFORNIA ELECTRICAL CODE (CEC), CCR, TITLE 24, PART 3 (2017 NATIONAL ELECTRICAL CODE WITH CALIFORNIA AMENDMENTS)
2022 CALIFORNIA MECHANICAL CODE (CMC), CCR, TITLE 24, PART 4 (2018 UNIFORM MECHANICAL CODE, WITH CALIFORNIA AMENDMENTS)
2022 CALIFORNIA ENERGY CODE, CCR, TITLE 24, PART 6
2022 CALIFORNIA FIRE CODE (CFC), CCR, TITLE 24, PART 9 (2018 INTERNATIONAL FIRE CODE WITH CALIFORNIA AMENDMENTS)
2022 CALIFORNIA GREEN BUILDING STANDARDS CODE, CCR, TITLE 24, PART 11
2022 CALIFORNIA REFERENCED STANDARDS CODE, CCR, TITLE 24, PART 12
2022 NFPA 72: NATIONAL FIRE ALARM AND SIGNALING CODE, NATIONAL FIRE PROTECTION ASSOCIATION

ANCHORAGE AND BRACING NOTES:
APPLICABLE CODE: 2019 CBC
REVISED: 02/14/2020
MEP COMPONENT ANCHORAGE NOTE:
ALL MECHANICAL, PLUMBING, AND ELECTRICAL COMPONENTS SHALL BE ANCHORED AND INSTALLED PER THE DETAILS ON THE USA APPROVED CONSTRUCTION DOCUMENTS. THE FOLLOWING COMPONENTS SHALL BE ANCHORED OR BRACED TO MEET THE FORCE AND DISPLACEMENT REQUIREMENTS PRESCRIBED IN THE 2019 CBC SECTIONS 1617A.1.18 THROUGH 1617A.1.26 AND ASCE 7-16 CHAPTERS 13, 26 THRU 30:
1. ALL PERMANENT EQUIPMENT AND COMPONENTS.
2. TEMPORARY, MOVEABLE OR MOBILE EQUIPMENT THAT IS PERMANENTLY ATTACHED (E.G. HARD WIRED) TO THE BUILDING UTILITY SERVICES SUCH AS ELECTRICITY, GAS OR WATER. "PERMANENTLY ATTACHED" SHALL INCLUDE ALL ELECTRICAL CONNECTIONS EXCEPT PLUGS FOR 110/220 VOLT RECEPTACLES HAVING A FLEXIBLE CABLE.
3. TEMPORARY, MOVEABLE OR MOBILE EQUIPMENT WHICH IS HEAVIER THAN 400 POUNDS OR HAS A CENTER OF MASS LOCATED 4 FEET OR MORE ABOVE THE ADJACENT FLOOR OR ROOF LEVEL THAT DIRECTLY SUPPORT THE COMPONENT IS REQUIRED TO BE RESTRAINED IN A MANNER APPROVED BY DSA.

THE FOLLOWING MECHANICAL AND ELECTRICAL COMPONENTS SHALL BE POSITIVELY ATTACHED TO THE STRUCTURE BUT NEED NOT DEMONSTRATE DESIGN COMPLIANCE WITH THE REFERENCES NOTED ABOVE. THESE COMPONENTS SHALL HAVE FLEXIBLE CONNECTIONS PROVIDED BETWEEN THE COMPONENT AND ASSOCIATED DUCT/WORK, PIPING, AND CONDUIT. FLEXIBLE CONNECTIONS MUST ALLOW MOVEMENT IN BOTH TRANSVERSE AND LONGITUDINAL DIRECTIONS.
A. COMPONENTS WEIGHING LESS THAN 400 POUNDS AND HAVING A CENTER OF MASS LOCATED 4 FEET OR LESS ABOVE THE ADJACENT FLOOR OR ROOF LEVEL THAT DIRECTLY SUPPORT THE COMPONENTS.
B. COMPONENTS WEIGHING LESS THAN 20 POUNDS, OR IN THE CASE OF DISTRIBUTION SYSTEMS, LESS THAN 5 POUNDS PER FOOT, WHICH ARE SUSPENDED FROM A ROOF OR FLOOR OR HUNG FROM A WALL.
THE ANCHORAGE OF ALL MECHANICAL, ELECTRICAL AND PLUMBING COMPONENTS SHALL BE SUBJECT TO THE APPROVAL OF THE DESIGN PROFESSIONAL IN GENERAL RESPONSIBLE CHARGE OR STRUCTURAL ENGINEER DELEGATED RESPONSIBILITY AND ACCEPTANCE BY DSA. THE PROJECT INSPECTOR WILL VERIFY THAT ALL COMPONENTS AND EQUIPMENT HAVE BEEN ANCHORED IN ACCORDANCE WITH THE ABOVE REQUIREMENTS.
PIPING, DUCT/WORK, AND ELECTRICAL DISTRIBUTION SYSTEM BRACING NOTE:
PIPING, DUCT/WORK AND ELECTRICAL SYSTEMS SHALL BE BRACED TO COMPLY WITH THE FORCES AND DISPLACEMENTS PRESCRIBED IN ASCE 7-16 SECTIONS 13.3 AS DEFINED IN ASCE 7-16 SECTIONS 13.6.5, 13.6.6, 13.6.7, 13.6.8 AND 2019 CBC SECTIONS 1617A.1.24, 1617A.1.25 AND 1617A.1.26
THE METHOD OF SHOWING BRACING AND ATTACHMENTS TO THE STRUCTURE FOR THE IDENTIFIED DISTRIBUTIONS SYSTEM ARE A NOTED BELOW. WHEN BRACING AND ATTACHMENTS ARE BASED ON A PRE-APPROVED INSTALLATION GUIDE (E.G., OSHPD OPM FOR 2013 CBC OR LATER), COPIES OF THE BRACING SYSTEM INSTALLATION GUIDE OR MANUAL SHALL BE AVAILABLE ON THE JOBSITE PRIOR TO THE START OF AND DURING THE HANGING AND BRACING OF THE DISTRIBUTION SYSTEMS. THE STRUCTURAL ENGINEER OF RECORD SHALL VERIFY THE ADEQUACY OF THE STRUCTURE TO SUPPORT THE HANGER AND BRACE LOADS.
MECHANICAL PIPING (MP), MECHANICAL DUCTS (MD), PLUMBING PIPES (PP), ELECTRICAL DISTRIBUTION SYSTEMS (E):
MP   MD   PP   E   X   OPTION 1: DETAILED ON THE APPROVED DRAWINGS WITH PROJECT SPECIFIC NOTES AND DETAILS.
MP   MD   PP   E   OPTION 2: SHALL COMPLY WITH THE APPLICABLE OSHPD PRE-APPROVED (OPM #)

SHEET INDEX:
SHEET DESCRIPTION
T000 TECHNOLOGY COVER SHEET
T010 TECHNOLOGY SITE PLAN - DEMO
T100 TECHNOLOGY SITE PLAN - NEW
T200 TECHNOLOGY FLOOR PLAN NEW - MDF 1.00
T201 TECHNOLOGY FLOOR PLAN NEW - IDF 1.01 AND 1.02
T202 TECHNOLOGY FLOOR PLAN NEW - IDF 1.03 AND 1.04
T400 TECHNOLOGY RACK ELEVATIONS
T401 TECHNOLOGY RACK ELEVATIONS
T402 TECHNOLOGY SINGLE LINE DIAGRAMS
T800 TECHNOLOGY DETAILS
T801 TECHNOLOGY DETAILS

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IF DRAWING IS NOT 30"x42" IT IS A REDUCED PRINT

SHEET REVISIONS		
DELTA	DESCRIPTION	DATE

PROJECT  
**SACRAMENTO CITY  
UNIFIED SCHOOL DISTRICT**  
**H.W. HARKNESS  
TELECENTER UPGRADE**  
2147 54TH AVENUE  
SACRAMENTO, CA 95822

SHEET TITLE  
**TECHNOLOGY  
COVER SHEET**

DRAWING STATUS  
**CONSTRUCTION DRAWINGS**

PROJECT NO:	
BID PACKAGE:	0139-411
DESIGNED BY:	CS
CHECKED BY:	SD
ISSUE DATE:	2025-05-19
WORKING DATE:	2025-05-19

REVISION

SHEET  
**T000**



1.03

CLASSROOM 21

CLASSROOM 19

IDF1.03

1

2

3

1.02

CLASSROOM 18

CLASSROOM 17

CLASSROOM 16

CLASSROOM 15

CLASSROOM 14

CLASSROOM 13

IDF1.02

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CLASSROOM 09

CLASSROOM 08

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CLASSROOM 07

CLASSROOM 06

CLASSROOM 05

CLASSROOM 04

CLASSROOM 03

CLASSROOM 02

CLASSROOM 01

STORAGE 001

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
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REST 3



ACTIVE DATA LOCATE  
PRESERVE IN PLACE

CONDUIT QTY. AND SIZE:	
①	1 EA. 2" CONDUIT.
②	2 EA. 2" CONDUIT.
③	1 EA. 2" CONDUIT.

GENERAL NOTES:

1. CONTRACTOR SHALL TOUCH UP PAINT TO MATCH EXISTING CONDITIONS FOR ALL AREAS OF NEW INSTALL OR DEMOLITION.
2. CONTRACTOR SHALL DEMO ALL SURFACE RACEWAY OR CONDUIT ABANDONED AS A RESULT OF DEMO.
3. AFTER CUTOVER TO NEW SYSTEMS, ALL ANALOG INTERCOM AND CLOCK CABLING SHALL BE DEMOED FROM ENDPOINT TO ENDPOINT, INCLUDING WITHIN CONDUITS AND PULL BOXES.
4. COMPLETE DEMO IN ALL CLASSROOMS PER TYPICAL CLASSROOM DEMO PICTURE DETAIL.

SHEET NOTES:

- |    |  |
|----|--|
| 1  | DEMO (E) CLOCK. DEMO CABLE TO SOURCE. PROVIDE CUSTOM BLANKING PLATE OVER CLOCK BACKBOX PER DETAIL. 12/78/00.                   |
| 2  | DEMO (E) SPEAKER AND BACKBOX. DEMO CABLE TO SOURCE. WATERPROOF ANY PENETRATIONS.   |
| 3  | DEMO ANALOG TELEPHONE WALL PLATE AND CABLEING TO SOURCE. PROVIDE BLANK COVER PLATE.  |
| 4  | DEMO ABANDONED DATA AND/OR LOCATION AND CABLEING TO SOURCE. PROVIDE BLANK COVER PLATE AS REQ'D.                                |
| 5  | DEMO ABANDONED IFV CABINET. DEMO BACKBOARD AS OCCURS.  |
| 6  | DEMO ABANDONED COAX PLATE AND CABLEING TO SOURCE. PROVIDE BLANK COVER PLATE AS REQ'D.  |
| 7  | DEMO TELECENTER HEADEND EQUIPMENT INCLUDING WALL PLATE. DELIVER HEADEND UNIT TO DISTRICT ELECTRONICS SHOP. SEE PICTURE DETAIL. |
| 8  | DEMO CLOCK HEADEND UNIT. INSTALL A (N) TACK BOARD ON HINGES TO COVER THE BACKBOX.  |
| 9  | DEMO ALL ANALOG CLOCK AND INTERCOM CABLES AT THIS STC CABINET.   |
| 10 | DEMO CUT CABLES. THIS LOCATION, TO ENDPOINT. FULLY REMOVE FROM ENDPOINTS AND JUNCTIONS.  |
| 11 | DEMO 66-BLOCKS AND ASSOCIATED CABLEING. SEE PICTURE DETAIL FOR SCENE OF DEMO.  |
| 12 | DEMO LCD MONITOR ON BRACKET.   |

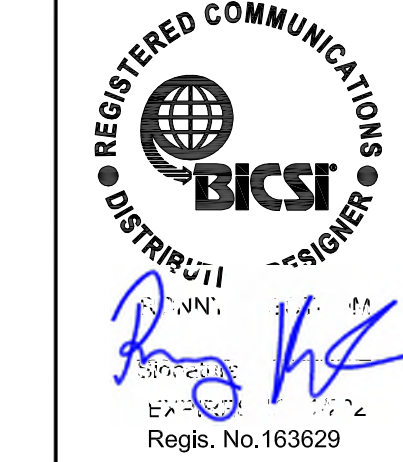


**KMM**  
Services, Inc.

**KMM SERVICES, INC**  
TECHNOLOGY & FIRE LIFE SAFETY

5433 El Camino Ave. Suite 5  
Carmichael, CA 95608  
Office: (916) 359-4000 [www.kmmsservices.com](http://www.kmmsservices.com)

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## SHEET REVISIONS

[illegible]

PROJECT  
SACRAMENTO CITY  
UNIFIED SCHOOL DISTRICT  
H.W. HARKNESS  
TELECENTER UPGRADE  
2147 54TH AVENUE  
SACRAMENTO, CA 95822

SHEET TITLE

TECHNOLOGY  
SITE PLAN - DEMO

DRAWING STATUS

CONSTRUCTION DRAWINGS

PROJECT NO:	
BID PACKAGE:	0139-411
DESIGNED BY:	CS
CHECKED BY:	SD
ISSUE DATE:	2025-05-19
WORKING DATE:	2025-05-19

SHEET

T010

login Name: jgoodin  
 log Date: May 16, 2025 - 3:18 pm  
 File Name: L:\25-914\_HHWarkness\_Telecenter\_SQUAD\06a-Design\ACAD\T010\_Site Plan Dermo.dwg



HOGAN DRIVE

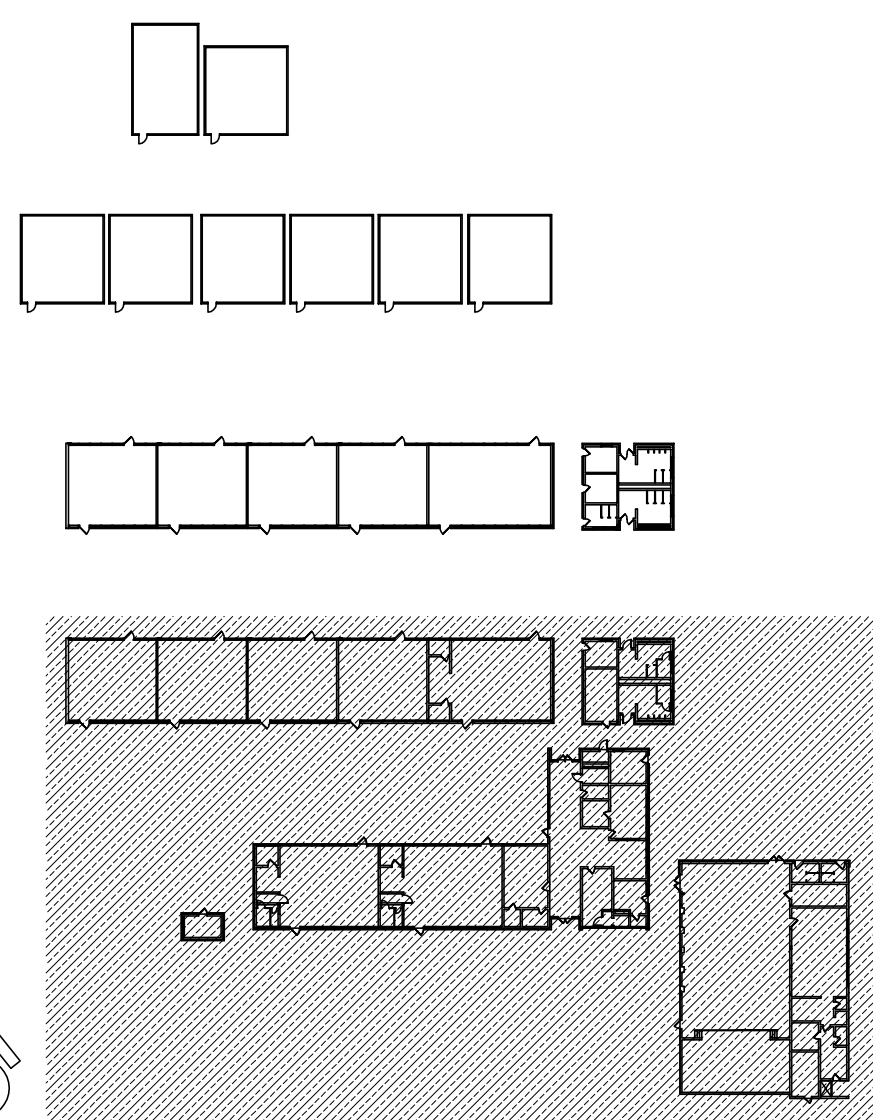


SHEET **T100**



Login Name: jgoodin  
Plot Date: May 16, 2025 -- 3:18 pm  
XREFS: \\server\shared\Background

KEY PLAN



CEILING CONDITION CHART:

- 1 DROP IN CEILING TILES.
- 2 HARD LID CEILING.

GENERAL NOTES:

- 1. NO STRUCTURAL BEAMS SHALL BE PENETRATED OR ALTERED.
- 2. ALL EQUIPMENT AND MATERIALS ARE CONTRACTOR FURNISHED, INSTALLED, AND CONFIGURED, UNO.
- 3. CONTRACTOR SHALL TOUCH UP PAINT TO MATCH EXISTING CONDITIONS FOR ALL AREAS OF NEW INSTALL OR DEMOLITION.

PIC DETAIL - CLERK C10 WIREMOLD REWORK



TRANSITION WM5400 DOWN WALL

REWORK (E) DATA DROPS INTO (N) WM5400 AND DEMO PN10 RACEWAY

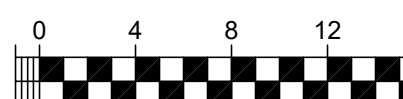
WM5400 CONTINUES ACROSS WALL TO RIGHT (NOT PICTURED)

SHEET NOTES:

- 1 REWORK MDF/IDF PER RACK ELEVATION. SEE T400/T401.
- 2 PROVIDE (N) COMBO BOX WITH (N) SPEAKER, (N) CLASSROOM IP MODULE, AND (N) IP CLOCK. LOCATE (E) DATA DROP ABOVE T-BAR AND FISH THROUGH WALL TO (N) CUT-IN BOX BEHIND COMBO BACKBOX.
- 3 REMOVE (E) WIREMOLD SURFACE BOX WITH PREWIRED DATA DROP. INSTALL (N) COMBO BOX WITH (N) SPEAKER, (N) CLASSROOM IP MODULE, AND (N) IP CLOCK. REWORK (E) DATA DROP INTO (N) COMBO BOX USING WIREMOLD PN10F15V "T" FITTING.
- 4 PROVIDE (N) EXTERIOR SPEAKER WITH (N) EXTERIOR BACKBOX. PROVIDE (N) INTERIOR ENCLOSURE WITH (N) CLASSROOM IP MODULE. PROVIDE (N) 1 EA. CAT6A DATA DROP AT INTERIOR ENCLOSURE.
- 5 PROVIDE (N) COMBO BOX WITH (N) SPEAKER, (N) CLASSROOM IP MODULE, AND (N) IP CLOCK. PROVIDE (N) 1 EA. CAT6A DATA DROP.
- 6 PROVIDE (N) BACKBOX WITH (N) SPEAKER AND (N) CLASSROOM IP MODULE. PROVIDE (N) 1 EA. CAT6A DATA DROP.
- 7 PROVIDE (N) LARGE MESSAGE BOARD WITH PROTECTIVE COVER. REWORK (E) DATA DROP INTO (N) METAL WIREMOLD BOX (PN V5741). METAL BOX REQUIRED HERE FOR ADEQUATE STABILITY OF LARGE MESSAGE BOARD.
- 8 PROVIDE (N) CAT6A DATA DROP, QUANTITY INDICATED, VIA (N) PATHWAY.
- 9 PROVIDE (N) WM5400 SURFACE RACEWAY (WHITE) FROM EXISTING, DOWN AND ACROSS WALL. INTENT IS TO REPLACE (E) PN10 AND FULLY CONCEAL WIRING AT THIS LOCATION. PULL BACK AND DETERMINATE DATA DROPS AT PRINCIPAL OFFICE C05 AS REQUIRED. SEE PICTURE DETAIL.
- 10 RE-SECURE SURFACE RACEWAY COMING AWAY FROM WALL/CEILING.
- 11 (N) 1 EA. 1" CONDUITS.
- 12 PROVIDE (N) 4-PAIR COPPER FEEDER BETWEEN FACP AND 66-BLOCK ON ADJACENT WALL. COORD. WITH DISTRICT REPRESENTATIVE FOR CUTOVER.
- 13 PROVIDE (N) 1 EA. CAT6A DATA DROP AT (E) EXTERIOR AP. REWORK AND PROVIDE REQUIRED COMPONENTS PER DETAIL T7891.
- 14 PROVIDE (N) WM5400 SURFACE RACEWAY (IVORY) ACROSS WALL. REMOVE (E) PN10 RACEWAY AND BOXES AND REWORK ALL (E) DATA DROPS INTO (N) WM5400. PROVIDE (N) WM2300 TO DATA DROP LOCATIONS AS REQ'D. INTENT IS TO FULLY REPLACE ALL (E) PN10 DATA RACEWAY ALONG THIS WALL WITH (N) WM5400 AND WM2300.

TECHNOLOGY FLOOR PLAN NEW - MDF1.00

SCALE: 1/8"=1'



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SACRAMENTO CITY  
UNIFIED SCHOOL DISTRICT  
H.W. HARKNESS  
TELECENTER UPGRADE  
2147 54TH AVENUE  
SACRAMENTO, CA 95822

SHEET TITLE

TECHNOLOGY  
FLOOR PLAN -  
NEW

DRAWING STATUS  
CONSTRUCTION DRAWINGS


PROJECT NO:	
BID PACKAGE:	0139-411
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CHECKED BY:	SD
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REVISION

SHEET


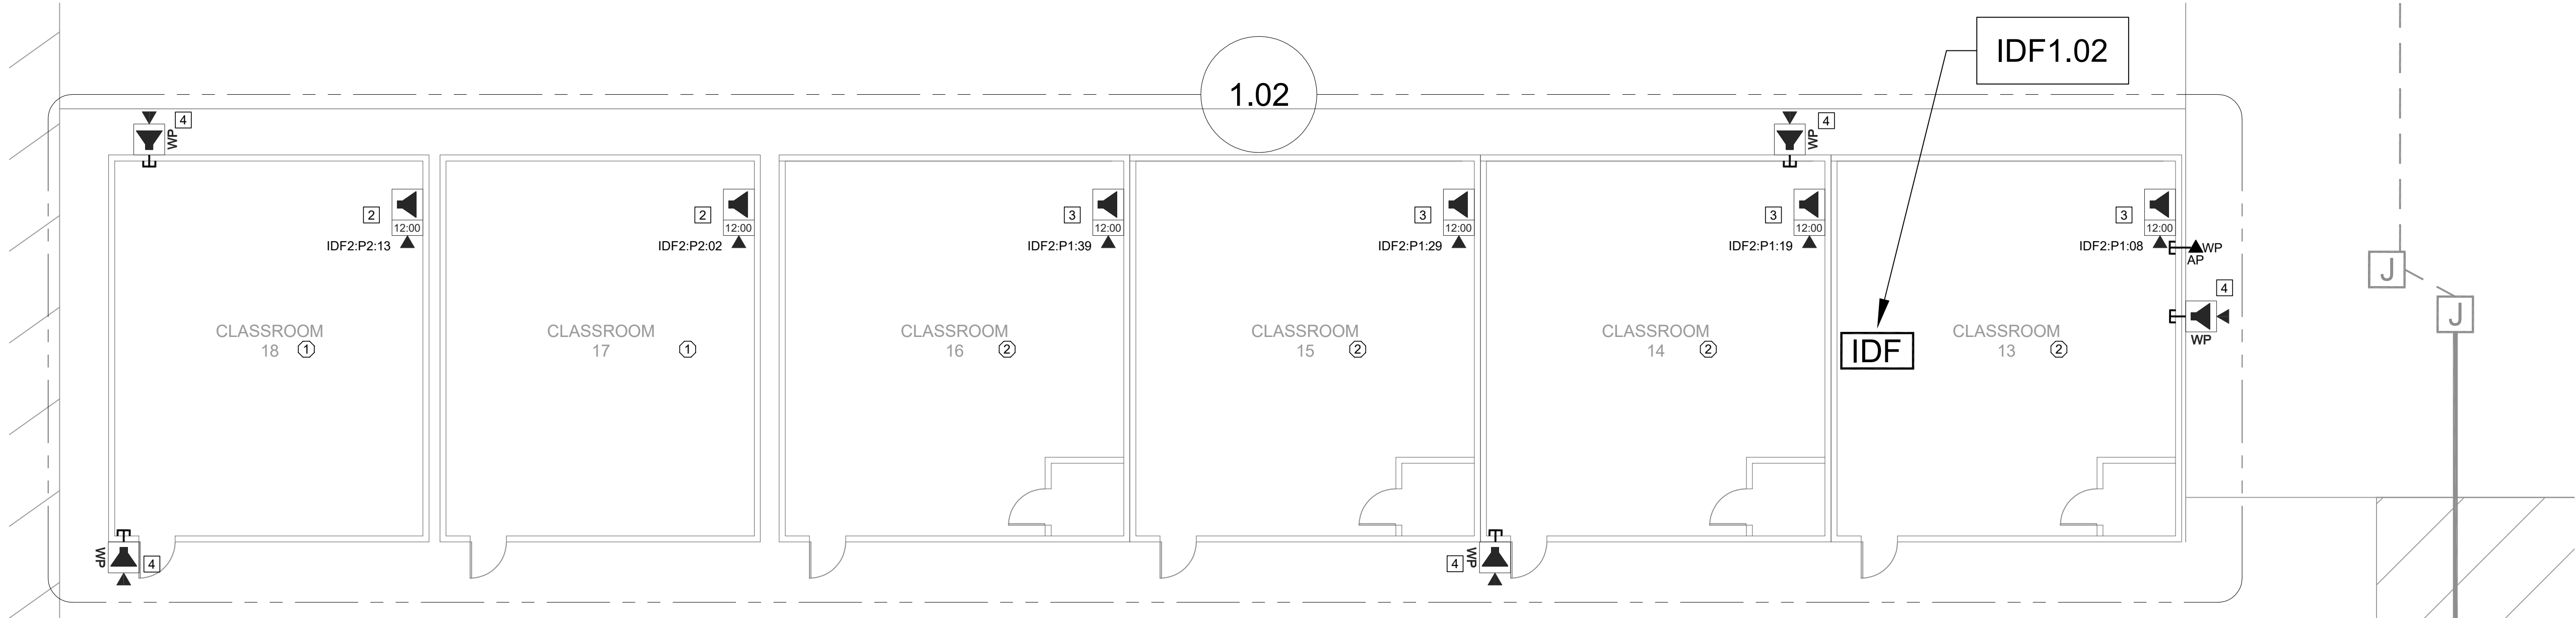
T200






## TECHNOLOGY FLOOR PLAN NEW - IDF1.02

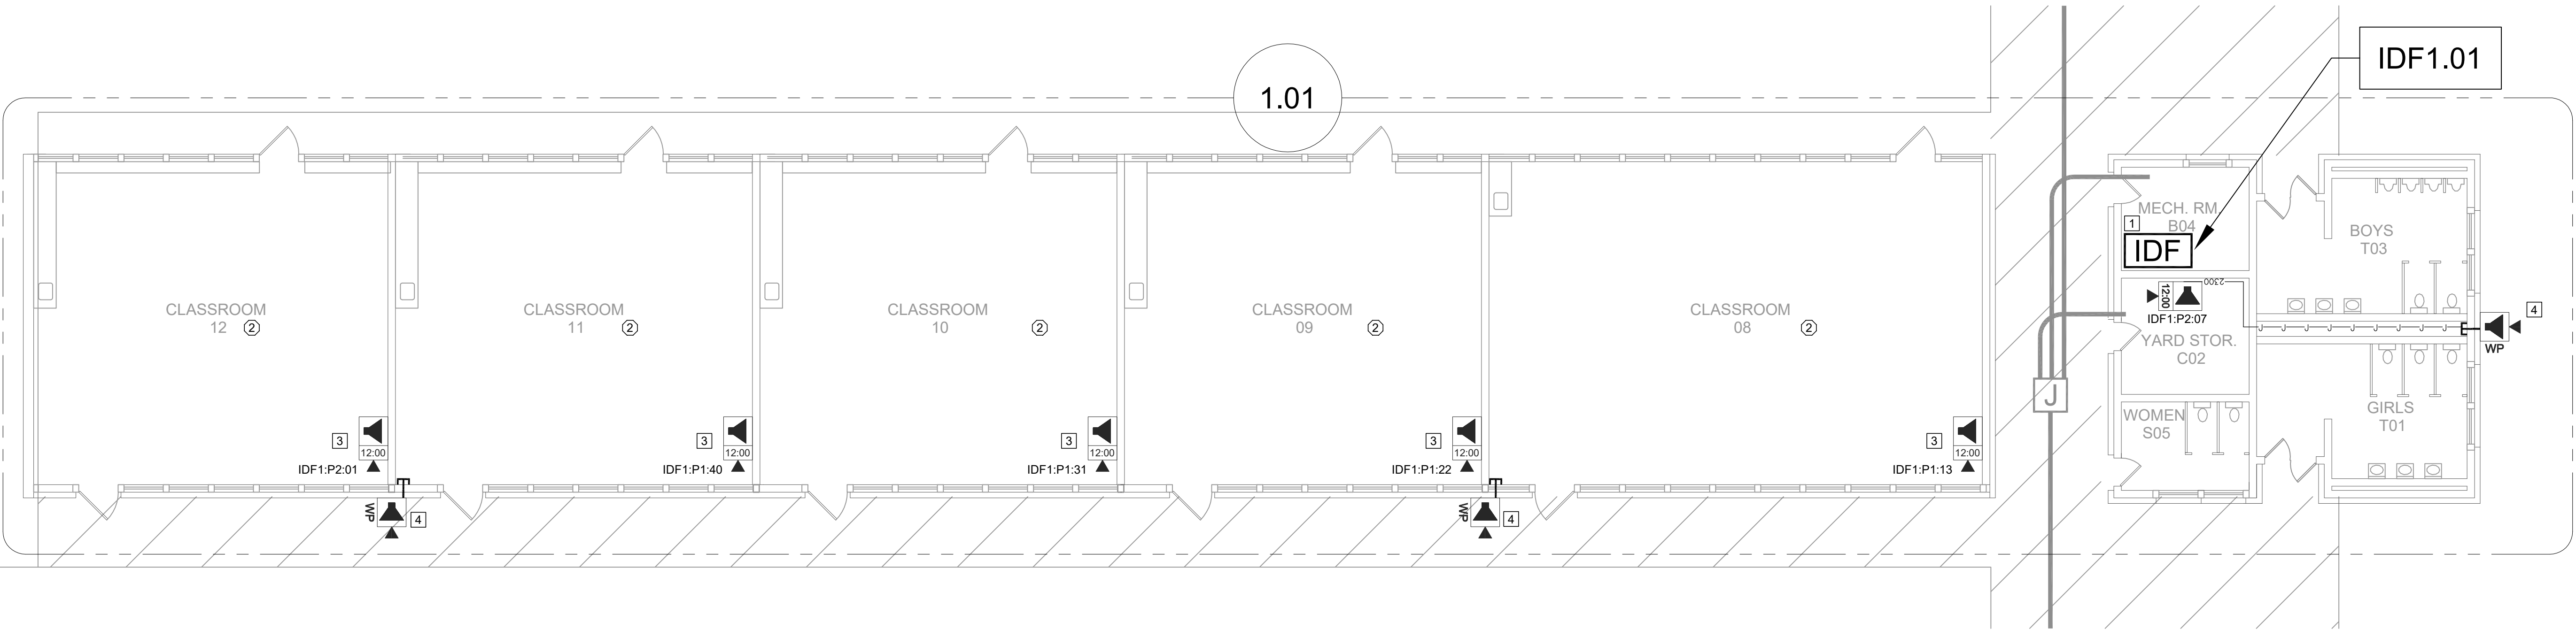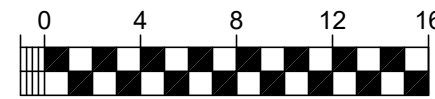SCALE: 1/8"=1'



## TECHNOLOGY FLOOR PLAN NEW - IDF1.01

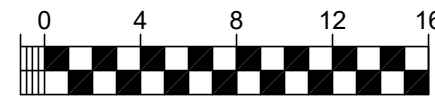SCALE: 1/8"=1'



### CEILING CONDITION CHART:

- ① DROP IN CEILING TILES.
- ② HARD LID CEILING.

### GENERAL NOTES:

- NO STRUCTURAL BEAMS SHALL BE PENETRATED OR ALTERED.
- ALL EQUIPMENT AND MATERIALS ARE CONTRACTOR FURNISHED, INSTALLED, AND CONFIGURED, UNO.
- CONTRACTOR SHALL TOUCH UP PAINT TO MATCH EXISTING CONDITIONS FOR ALL AREAS OF NEW INSTALL OR DEMOLITION.

### SHEET NOTES:

- REWORK MDF/IDF PER RACK ELEVATION. SEE T400/T401.
- PROVIDE (N) COMBO BOX WITH (N) SPEAKER, (N) CLASSROOM IP MODULE, AND (N) IP CLOCK. LOCATE (E) DATA DROP ABOVE T-BAR AND FISH THROUGH WALL TO (N) CUT-IN BOX BEHIND COMBO BACKBOX.
- REMOVE (E) WIREMOLD SURFACE BOX WITH PREWIRED DATA DROP. INSTALL (N) COMBO BOX WITH (N) SPEAKER, (N) CLASSROOM IP MODULE, AND (N) IP CLOCK. REWORK (E) DATA DROP INTO (N) COMBO BOX USING WIREMOLD PN10F15V "T" FITTING.
- PROVIDE (N) EXTERIOR SPEAKER WITH (N) EXTERIOR BACKBOX. PROVIDE (N) INTERIOR ENCLOSURE WITH (N) CLASSROOM IP MODULE. PROVIDE (N) 1 EA. CAT6A DATA DROP AT INTERIOR ENCLOSURE.
- PROVIDE (N) COMBO BOX WITH (N) SPEAKER, (N) CLASSROOM IP MODULE, AND (N) IP CLOCK. PROVIDE (N) 1 EA. CAT6A DATA DROP.
- PROVIDE (N) BACKBOX WITH (N) SPEAKER AND (N) CLASSROOM IP MODULE. PROVIDE (N) 1 EA. CAT6A DATA DROP.
- PROVIDE (N) LARGE MESSAGE BOARD WITH PROTECTIVE COVER. REWORK (E) DATA DROP INTO (N) METAL WIREMOLD BOX (PN V5741). METAL BOX REQUIRED HERE FOR ADEQUATE STABILITY OF LARGE MESSAGE BOARD.
- PROVIDE (N) CAT6A DATA DROP, QUANTITY INDICATED, VIA (N) PATHWAY.
- PROVIDE (N) WM5400 SURFACE RACEWAY (WHITE) FROM EXISTING, DOWN AND ACROSS WALL. INTENT IS TO REPLACE (E) PN10 AND FULLY CONCEAL WIRING AT THIS LOCATION. PULL BACK AND DETERMINE DATA DROPS AT PRINCIPAL OFFICE C05 AS REQUIRED. SEE PICTURE DETAIL.
- RE-SECURE SURFACE RACEWAY COMING AWAY FROM WALL/CEILING.
- (N) 1 EA. 1" CONDUITS.
- PROVIDE (N) 4-PAIR COPPER FEEDER BETWEEN FACP AND 66-BLOCK ON ADJACENT WALL. COORD. WITH DISTRICT REPRESENTATIVE FOR CUTOVER.
- PROVIDE (N) 1 EA. CAT6A DATA DROP AT (E) EXTERIOR AP. REWORK AND PROVIDE REQUIRED COMPONENTS PER DETAIL 1/T801.
- PROVIDE (N) WM5400 SURFACE RACEWAY (IVORY) ACROSS WALL. REMOVE (E) PN10 RACEWAY AND BOXES AND REWORK ALL (E) DATA DROPS INTO (N) WM5400. PROVIDE (N) WM2300 TO DATA DROP LOCATIONS AS REQ'D. INTENT IS TO FULLY REPLACE ALL (E) PN10 DATA RACEWAY ALONG THIS WALL WITH (N) WM5400 AND WM2300.



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UNIFIED SCHOOL DISTRICT**  
H.W. HARKNESS  
TELECENTER UPGRADE  
2147 54TH AVENUE  
SACRAMENTO, CA 95822

SHEET TITLE  
**TECHNOLOGY  
FLOOR PLAN -  
NEW**

DRAWING STATUS  
**CONSTRUCTION DRAWINGS**

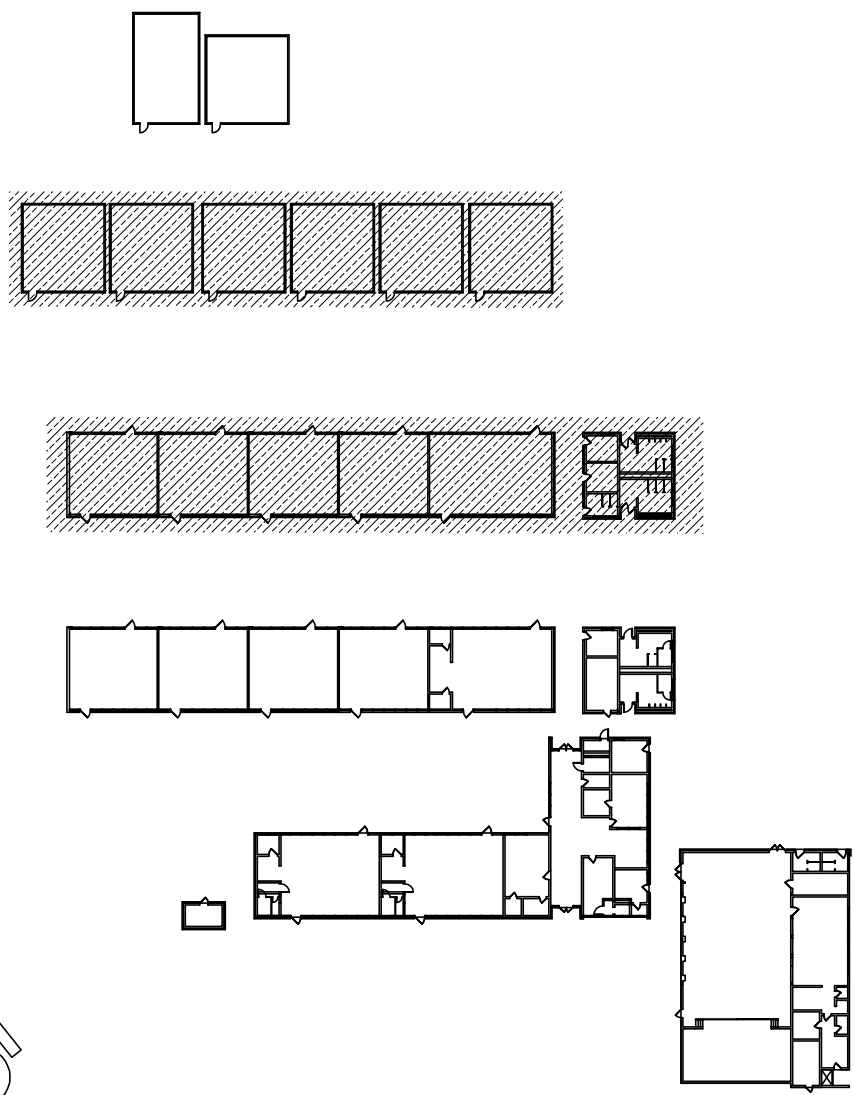
PROJECT NO:	
BID PACKAGE:	0139-411
DESIGNED BY:	CS
CHECKED BY:	SD
ISSUE DATE:	2025-05-19
WORKING DATE:	2025-05-19

REVISION

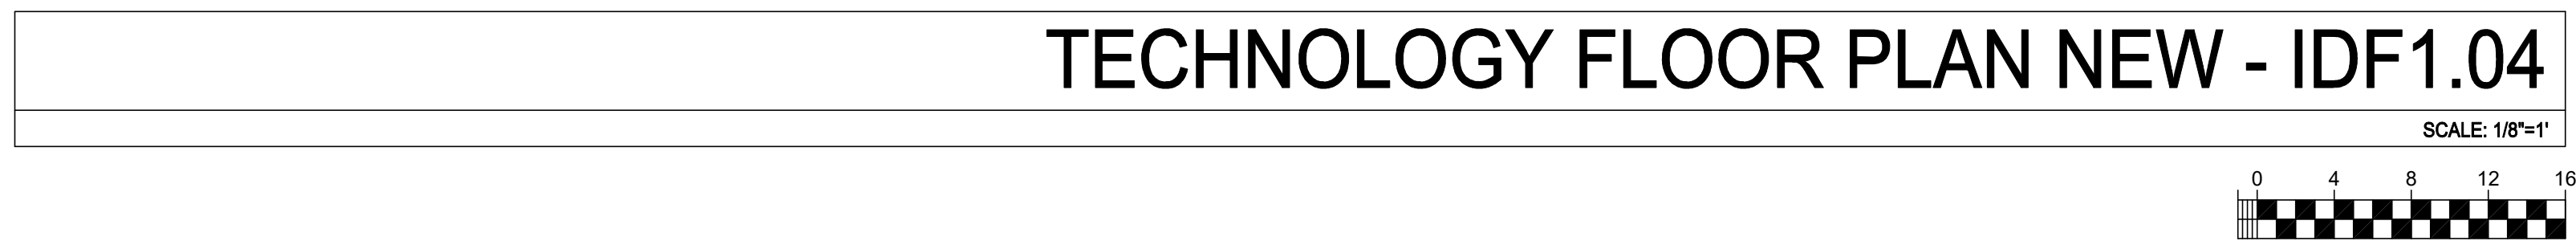
SHEET

**T201**

### KEY PLAN







## SHEET NOTES:

- 1 REWORK MDF/DP PER RACK ELEVATION. SEE T400T/401.
- 2 PROVIDE (N) COMBO BOX WITH (N) SPEAKER, (N) CLASSROOM IP MODULE AND (N) IP CLOCK. LOCATE (E) DATA DROP ABOVE T-BAR AND FISH THROUGH WALL TO (N) CUT-IN BOX BEHIND COMBO BACKBOX.
- 3 REMOVE (E) WIREMOLD SURFACE BOX WITH PREWIRED DATA DROP. INSTALL (N) COMBO BOX WITH (N) SPEAKER, (N) CLASSROOM IP MODULE, AND (N) IP CLOCK. REWORK (E) DATA DROP INTO (N) COMBO BOX USING WIREMOLD PN10-15W "T" FITTING.
- 4 PROVIDE (N) EXTERIOR SPEAKER WITH (N) EXTERIOR BACKBOX. PROVIDE (N) INTERIOR ENCLOSURE WITH (N) CLASSROOM IP MODULE. PROVIDE (N) 1 EA. CAT6A DATA DROP AT INTERIOR ENCLOSURE.
- 5 PROVIDE (N) COMBO BOX WITH (N) SPEAKER, (N) CLASSROOM IP MODULE AND (N) IP CLOCK. PROVIDE (N) 1 EA. CAT6A DATA DROP.
- 6 PROVIDE (N) BACKBOX WITH (N) SPEAKER AND (N) CLASSROOM IP MODULE. PROVIDE (N) 1 EA. CAT6A DATA DROP.
- 7 PROVIDE (N) LARGE MESSAGE BOARD WITH PROTECTIVE COVER. REWORK (E) DATA DROP INTO (N) METAL WIREMOLD BOX (PN V51-M). METAL BOX REQUIRED HERE FOR ADEQUATE STABILITY OF LARGE MESSAGE BOARD.
- 8 PROVIDE (N) CAT6A DATA DROP. QUANTITY INDICATED. VIA (N) PATHWAY.
- 9 PROVIDE (N) WM5400 SURFACE RACEWAY (WHITE) FROM EXISTING, DOWN AND ACROSS WALL. INTENT IS TO REPLACE (E) PN10 AND FISH METAL WIREMOLD TO (N) LOCATION. PULL BACK AND RETERMINATE DATA DROPS AT EXISTING OUTLET COXS AS REQUIRED. SEE PICTURE DETAIL.
- 10 RE-SECURE SURFACE RACEWAY COMING FROM WALL/HALLING.
- 11 (N) 1 EA "T" CONDUITS.
- 12 PROVIDE (N) AD-PAIR CORD FEEDER BETWEEN FACP AND 66-BLOCK ON COPPER WALL. COORD. WITH DISTRICT REPRESENTATIVE FOR CUTOVER.
- 13 PROVIDE (N) 1 EA. CAT6A DATA DROP AT (E) EXTERIOR AP. REWORK AND PROVIDE REQUIRED COMPONENTS PER DETAIL 17B01.
- 14 PROVIDE (N) WM5400 SURFACE RACEWAY (VORY) ACROSS WALL. REMOVE (E) PN10 RACEWAY AND BOXES AND REWORK ALL (E) DATA DROPS INTO (N) WM5400. PROVIDE (N) WMK200 TO DATA DROP. REWORKS AS REQUIRED TO REPLACE ALL (E) PN10 DATA RACEWAY ALLONG THIS WALL WITH (N) WM5400 AND WMK200.



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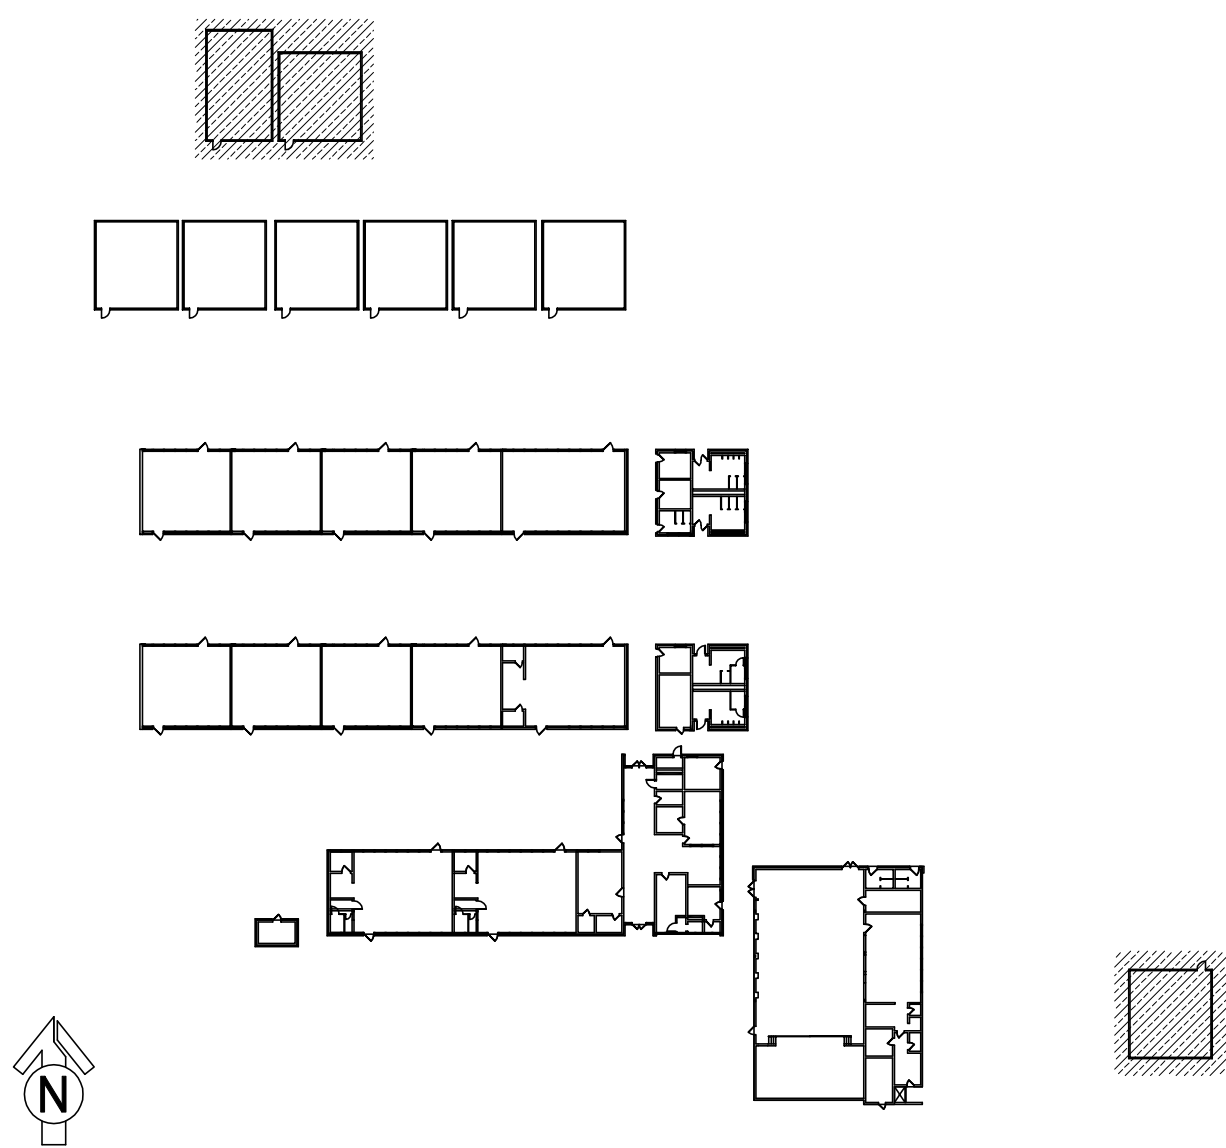
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[illegible]

PROJECT NO:	
BID PACKAGE:	0139-41
DESIGNED BY:	C&S
CHECKED BY:	SE
ISSUE DATE:	2025-05-15
WORKING DATE:	2025-05-15

REVISION

SHEET **T202**





- SCOPE OF WORK - IDF 1.01
1. PROVIDE (N) 24P PATCH PANEL PER THE ELEVATION. RELOCATE (16) KEYSTONES CURRENTLY IN (E) PATCH PANEL P2 INTO THIS (N) 24P PATCH PANEL. COPY LABELING FROM (E) PATCH PANEL.

2. TERMINATE 4 EA. (E) CCTV DATA DROP ON (N) BLUE KEYSTONE IN (N) PATCH PANEL P2.

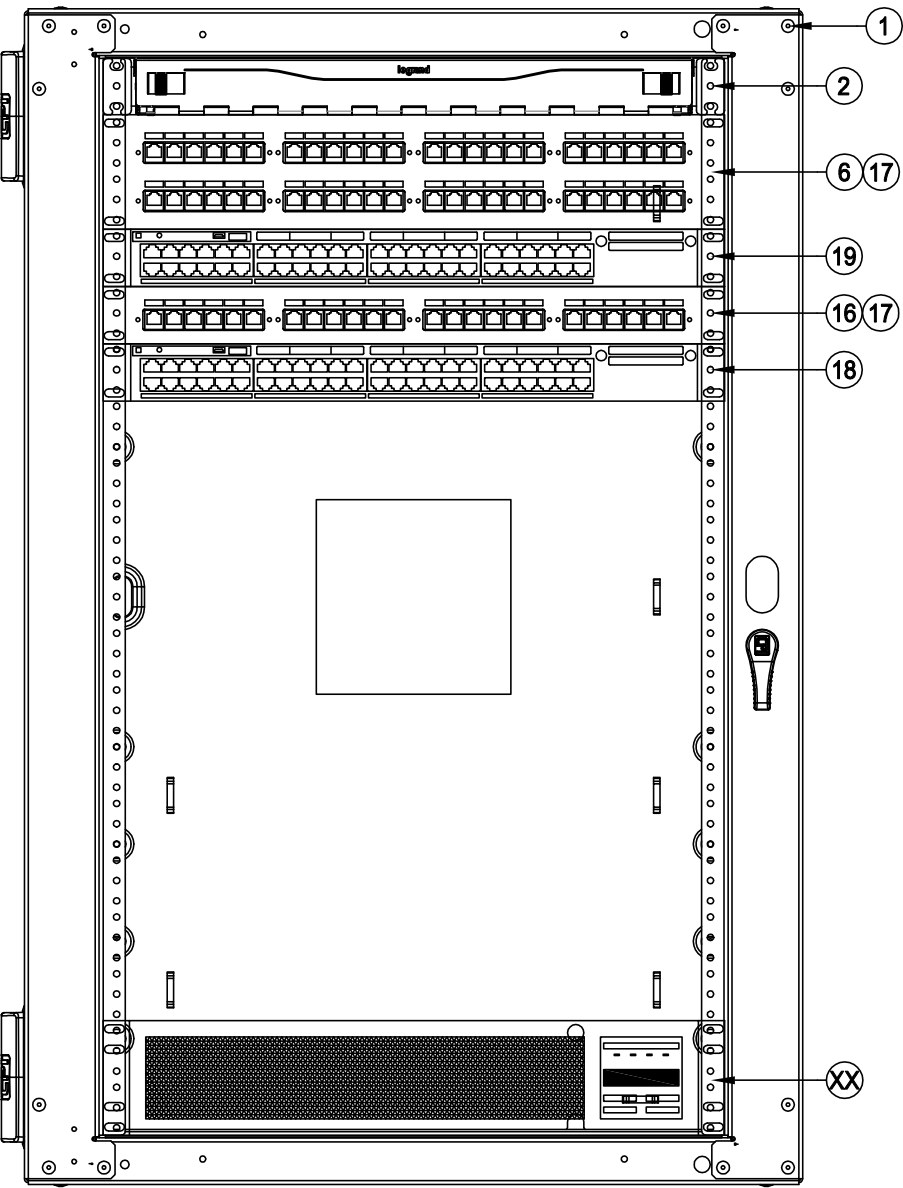
3. REMOVE (E) CCTV SWITCH AND PSU (SYMBOL 9) AND RETURN TO DISTRICT.

4. PROVIDE (N) UNINTERRUPTIBLE POWER SUPPLY PER THE ELEVATION. ROUTE POWER FOR ALL RACK COMPONENTS SO THAT IT IS PROTECTED BY THE UPS.



RACK - EXISTING CONDITION

SCALE: NONE



RACK - FINAL LAYOUT

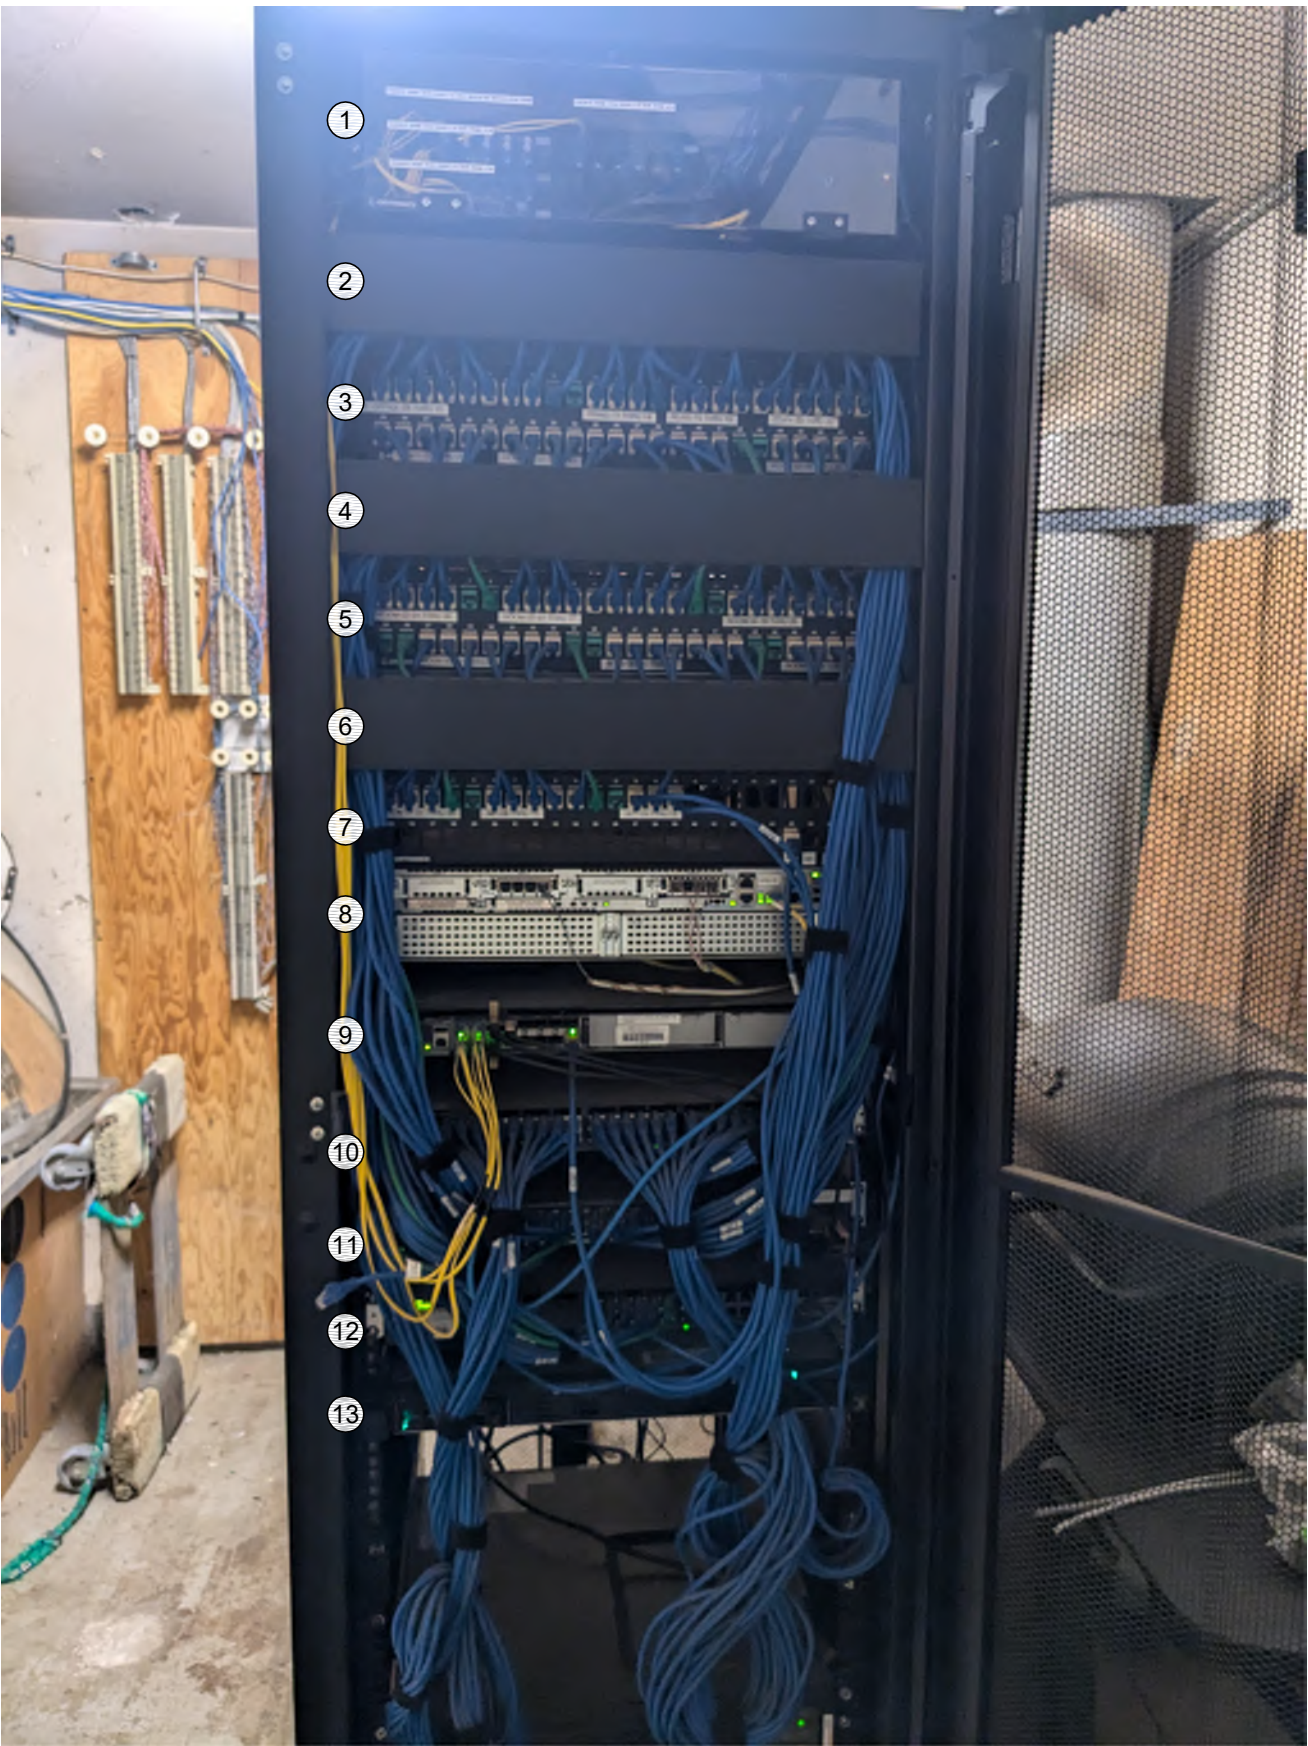
SCALE: NONE

- SCOPE OF WORK - MDF 1.00
1. PROVIDE (N) 24P PATCH PANEL PER THE ELEVATION. RELOCATE (20) KEYSTONES CURRENTLY IN (E) PATCH PANEL P3 INTO THIS (N) 24P PATCH PANEL. COPY LABELING FROM (E) PATCH PANEL.

2. TERMINATE 16 EA. (E) CCTV DATA DROP ON (N) BLUE KEYSTONE IN (N) PATCH PANELS P3, P4.


3. REMOVE (E) CCTV SWITCH AND PSU (AT REAR OF RACK, NOT PICTURED) AND RETURN TO DISTRICT.

4. PROVIDE (N) UNINTERRUPTIBLE POWER SUPPLY PER THE ELEVATION. ROUTE POWER FOR THE TELECENTER HEADEND COMPONENTS SO THAT IT IS PROTECTED BY THIS UPS.



RACK - EXISTING CONDITION

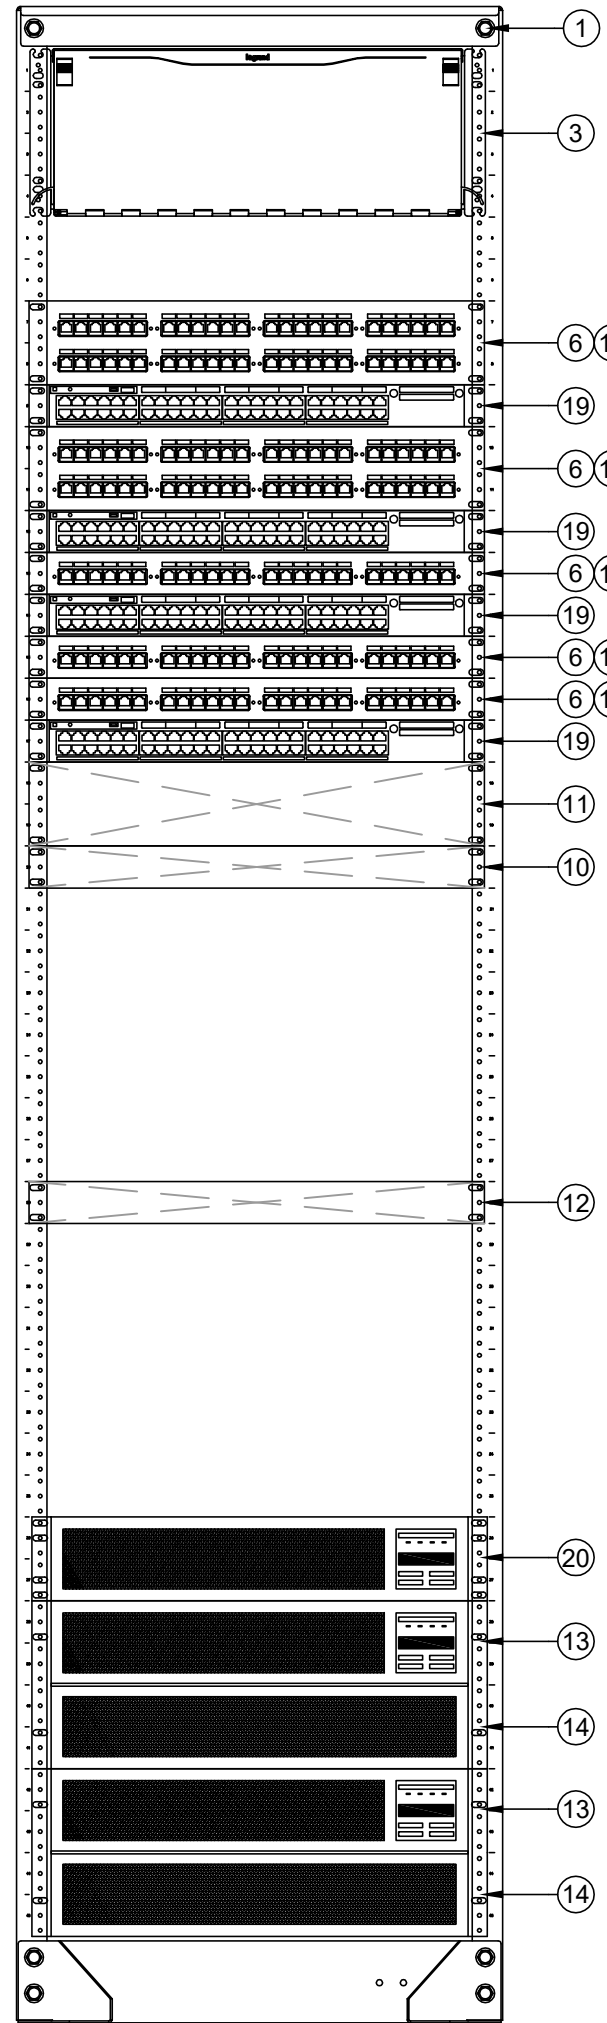SCALE: NONE



RACK - FINAL LAYOUT

SCALE: NONE

- GENERAL SCOPE OF WORK:  
(ALL IDF/MDF)
1. REMOVE ALL (E) RACK-MOUNTED CABLE MANAGER(S).

2. PROVIDE (N) REAR CABLE MANAGEMENT BAR(S) AT EACH PATCH PANEL AND DRESS (E) CABLES FOR STRAIN RELIEF PER 11/17800.

3. RELOCATE (E) DEVICES PER THE ELEVATION.

4. INSTALL (N) OWNER-FURNISHED SWITCHES PER THE ELEVATION.

5. PROVIDE (N) 12" SLIMLINE CAT6A PATCH CABLES TO REPLACE ALL (E) PATCH CABLES AND FOR ALL (N) DROPS, COLOR CODED TO DISTRICT STANDARD.

EQUIPMENT SCHEDULE: ALL EQUIPMENT AND MATERIALS ARE CONTRACTOR FURNISHED, INSTALLED AND CONFIGURED (UNO)				
SYMBOL	DESCRIPTION	MFG	PART NUMBER	NOTES / DETAIL REFERENCES
①	RACK CABINET	EXISTING	EXISTING	N/A
②	(E) 1U FIBER LIU	EXISTING	EXISTING	N/A
③	(E) 4U FIBER LIU	EXISTING	EXISTING	N/A
④	(E) 2U CABLE MANAGER	EXISTING	EXISTING	DEMO
⑤	(E) 1U 24P PATCH PANEL	EXISTING	EXISTING	RELOCATE PER ELEVATION
⑥	(E) 2U 48P PATCH PANEL	EXISTING	EXISTING	RELOCATE PER ELEVATION
⑦	(E) 24P SWITCH	EXISTING	EXISTING	DEMO
⑧	(E) 48P SWITCH	EXISTING	EXISTING	DEMO
⑨	(E) CCTV SWITCH AND PSU	EXISTING	EXISTING	DEMO
⑩	(E) CORE SWITCH	EXISTING	EXISTING	N/A
⑪	(E) VOIP GATEWAY	EXISTING	EXISTING	N/A
⑫	(E) NVR	EXISTING	EXISTING	N/A
⑬	(E) UPS	EXISTING	EXISTING	N/A
⑭	(E) UPS BATTERY	EXISTING	EXISTING	N/A
⑮	NOT USED	NOT USED	NOT USED	N/A
⑯	(N) 1U 24P PATCH PANEL	ORTRONICS	SPKSU24	N/A
⑰	(N) REAR CABLE MANAGEMENT BAR	ORTRONICS	OR-CMBFRURU	N/A
⑱	(N) 24P SWITCH	CISCO	OFCI	N/A
⑲	(N) 48P SWITCH	CISCO	OFCI	N/A
⑳	(N) UPS - 1000VA	N1C	N1C.L1000	N/A
㉑	(N) UPS - 1500VA	N1C	N1C.L1500	N/A



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H.W. HARKNESS  
TELECENTER UPGRADE  
2147 54TH AVENUE  
SACRAMENTO, CA 95822

SHEET TITLE  
TECHNOLOGY  
RACK ELEVATIONS

DRAWING STATUS  
CONSTRUCTION DRAWINGS

PROJECT NO:	
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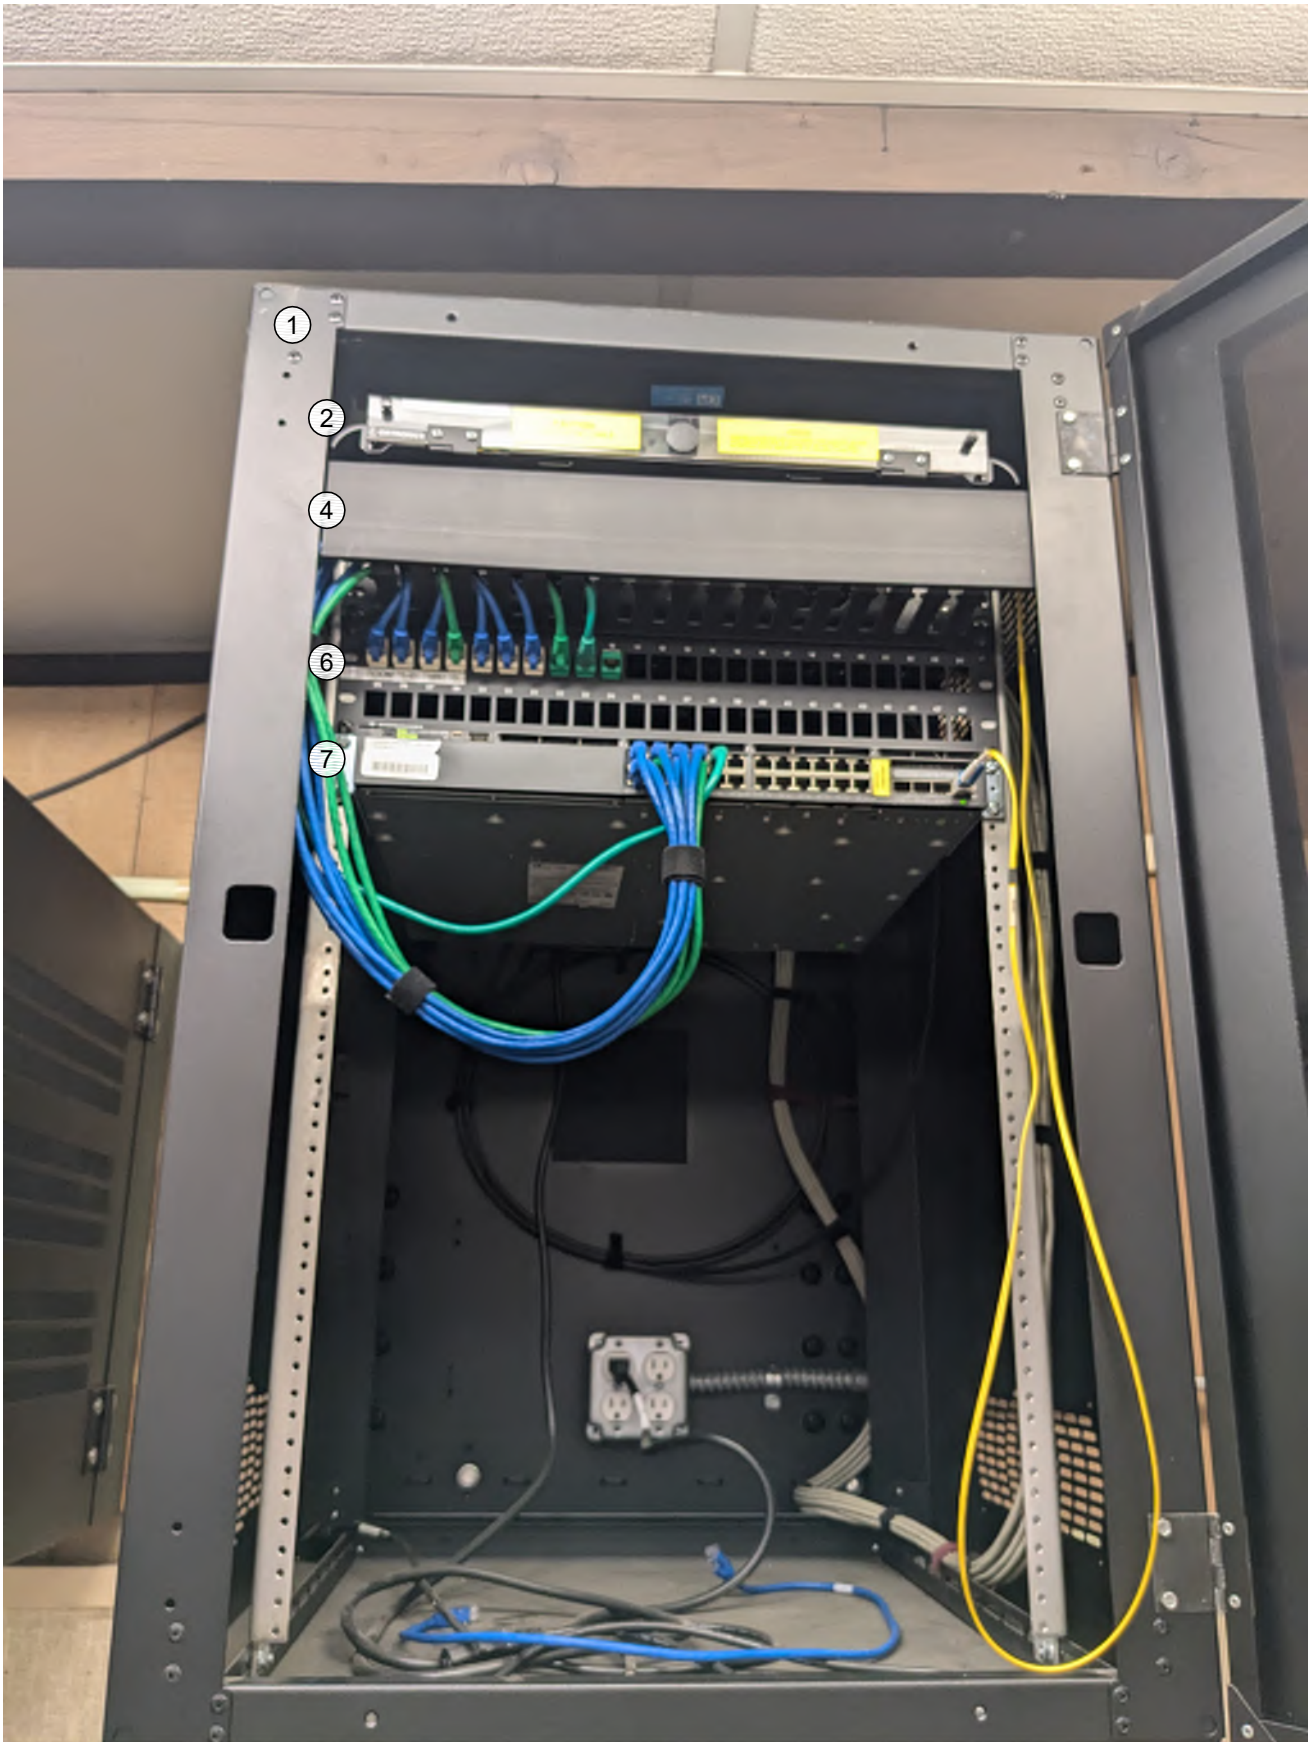
T400



\*\*REFER TO SYMBOL LEGEND ON T400 FOR ALL DEVICES ON THIS SHEET\*\*

SCOPE OF WORK - IDF 1.04

1. PROVIDE (N) 24P PATCH PANEL PER THE ELEVATION. RELOCATE (10) KEYSTONES CURRENTLY IN (E) PATCH PANEL P2 INTO THIS (N) 24P PATCH PANEL. COPY LABELING FROM (E) PATCH PANEL.
2. PROVIDE (N) UNINTERRUPTIBLE POWER SUPPLY PER THE ELEVATION. ROUTE POWER FOR ALL RACK COMPONENTS SO THAT IT IS PROTECTED BY THE UPS.



RACK - EXISTING CONDITION

SCALE: NONE

SCOPE OF WORK - IDF 1.03

1. TERMINATE 1 EA. (E) CCTV DATA DROP ON (N) BLUE KEYSTONE IN (E) PATCH PANEL P1.
2. REMOVE (E) MEDIA CONVERTER AND POE INJECTOR AND RETURN TO DISTRICT.
3. PROVIDE (N) UNINTERRUPTIBLE POWER SUPPLY PER THE ELEVATION. ROUTE POWER FOR ALL RACK COMPONENTS SO THAT IT IS PROTECTED BY THE UPS.



RACK - EXISTING CONDITION

SCALE: NONE

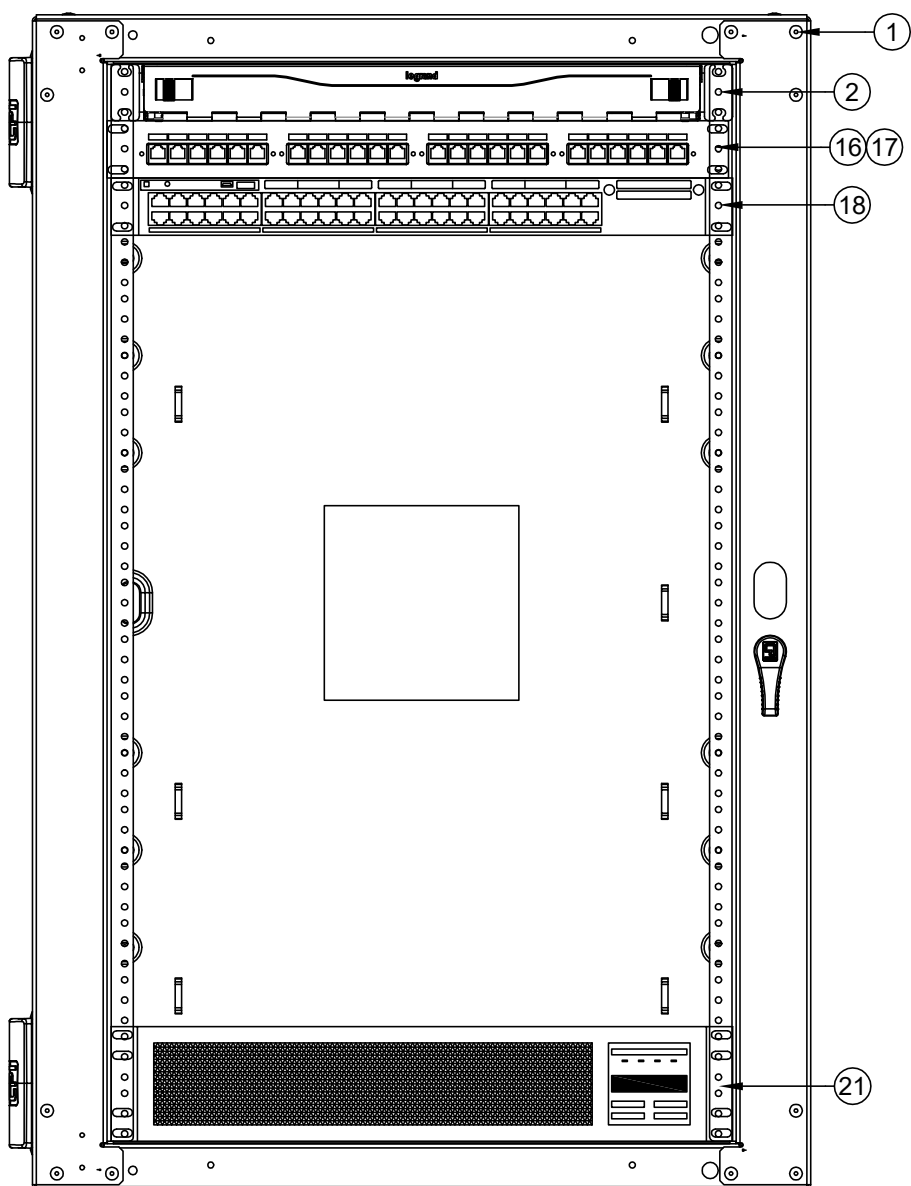
SCOPE OF WORK - IDF 1.02

1. PROVIDE (N) 24P PATCH PANEL PER THE ELEVATION. RELOCATE (16) KEYSTONES CURRENTLY IN (E) PATCH PANEL P2 INTO THIS (N) 24P PATCH PANEL. COPY LABELING FROM (E) PATCH PANEL.
2. TERMINATE 2 EA. (E) CCTV DATA DROP ON (N) BLUE KEYSTONE IN (N) PATCH PANEL P2.
3. REMOVE (E) CCTV SWITCH AND PSU (SYMBOL 9) AND RETURN TO DISTRICT.
4. PROVIDE (N) UNINTERRUPTIBLE POWER SUPPLY PER THE ELEVATION. ROUTE POWER FOR ALL RACK COMPONENTS SO THAT IT IS PROTECTED BY THE UPS.




RACK - EXISTING CONDITION

SCALE: NONE




RACK - FINAL LAYOUT

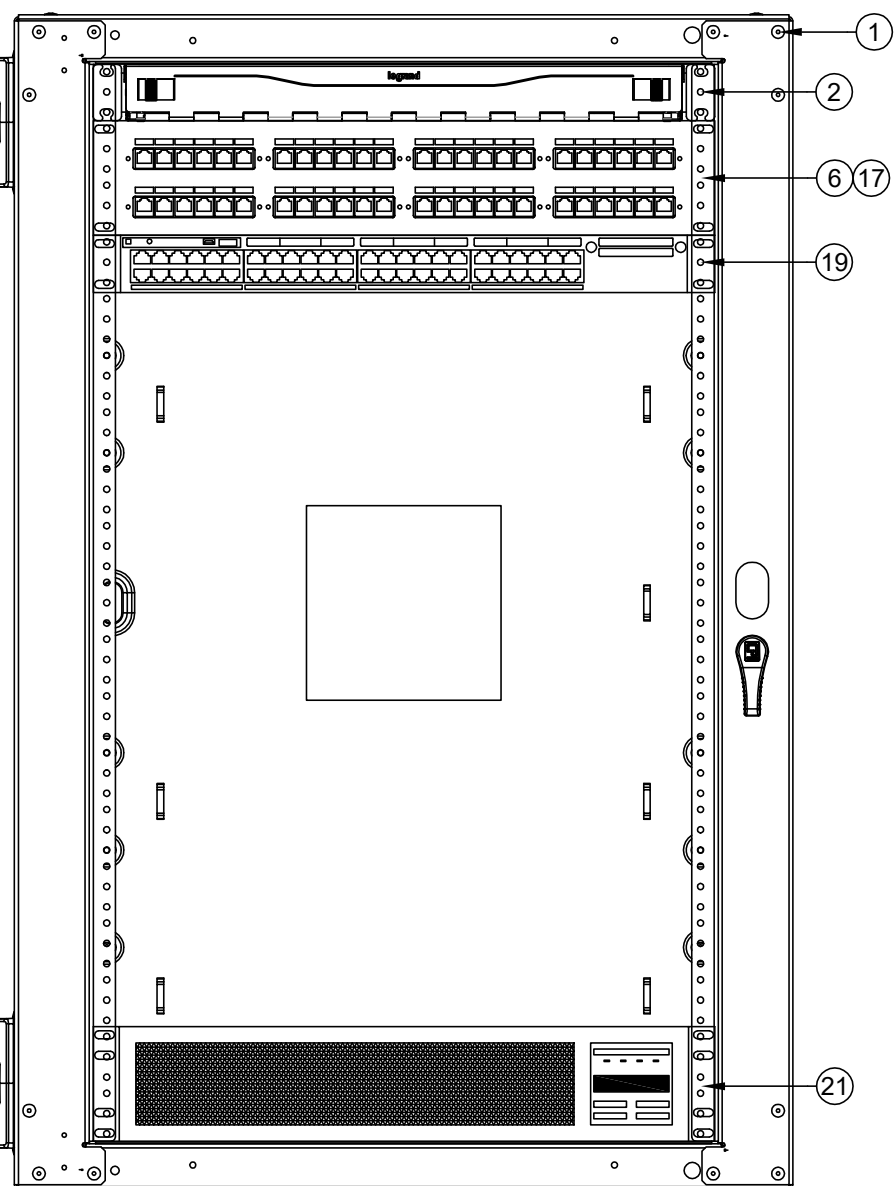SCALE: NONE



RACK - FINAL LAYOUT

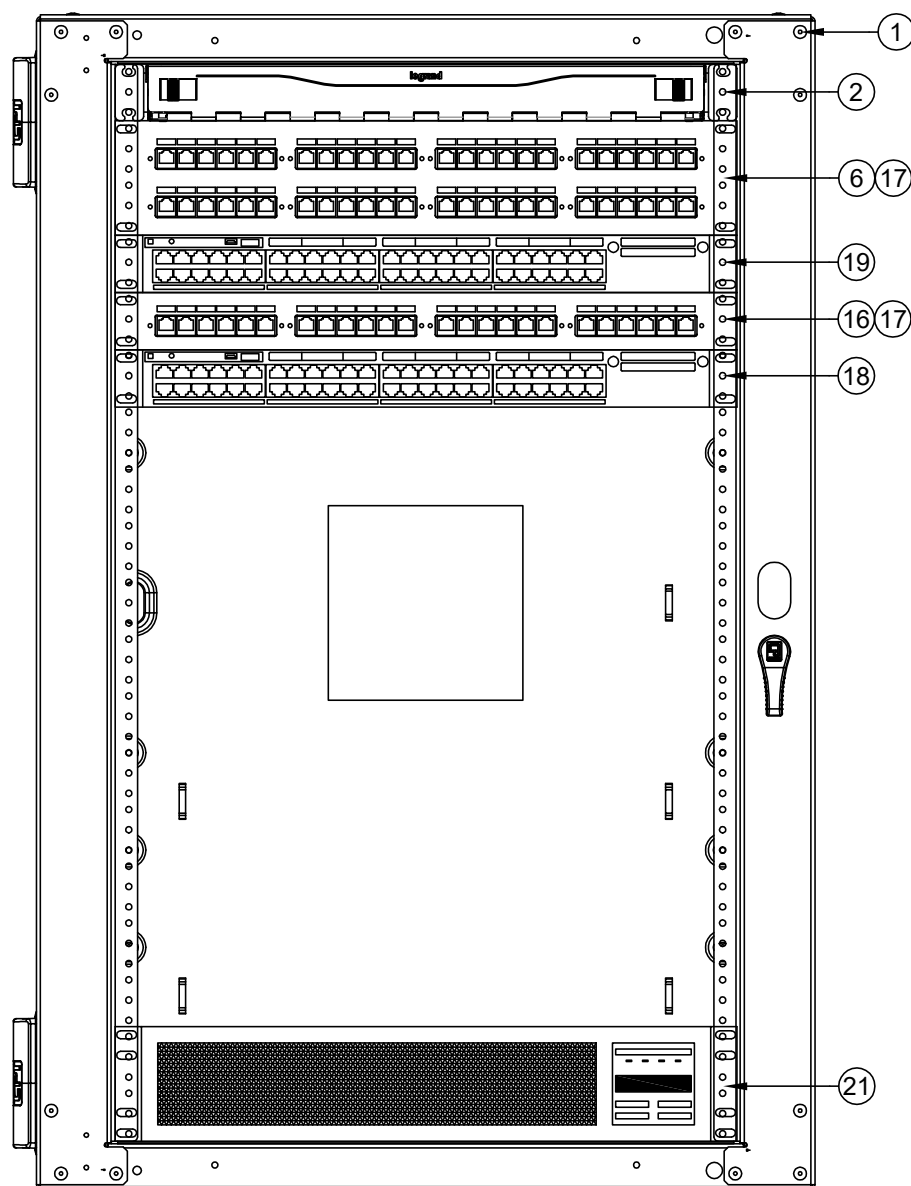SCALE: NONE



RACK - FINAL LAYOUT

SCALE: NONE



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DELTA	DESCRIPTION	DATE

PROJECT  
SACRAMENTO CITY  
UNIFIED SCHOOL DISTRICT  
H.W. HARKNESS  
TELECENTER UPGRADE  
2147 54TH AVENUE  
SACRAMENTO, CA 95822

SHEET TITLE  
TECHNOLOGY  
RACK ELEVATIONS

DRAWING STATUS  
CONSTRUCTION DRAWINGS






PROJECT NO:	
BID PACKAGE:	0139-411
DESIGNED BY:	CS
CHECKED BY:	SD
ISSUE DATE:	2025-05-19
WORKING DATE:	2025-05-19

REVISION

SHEET  
T401



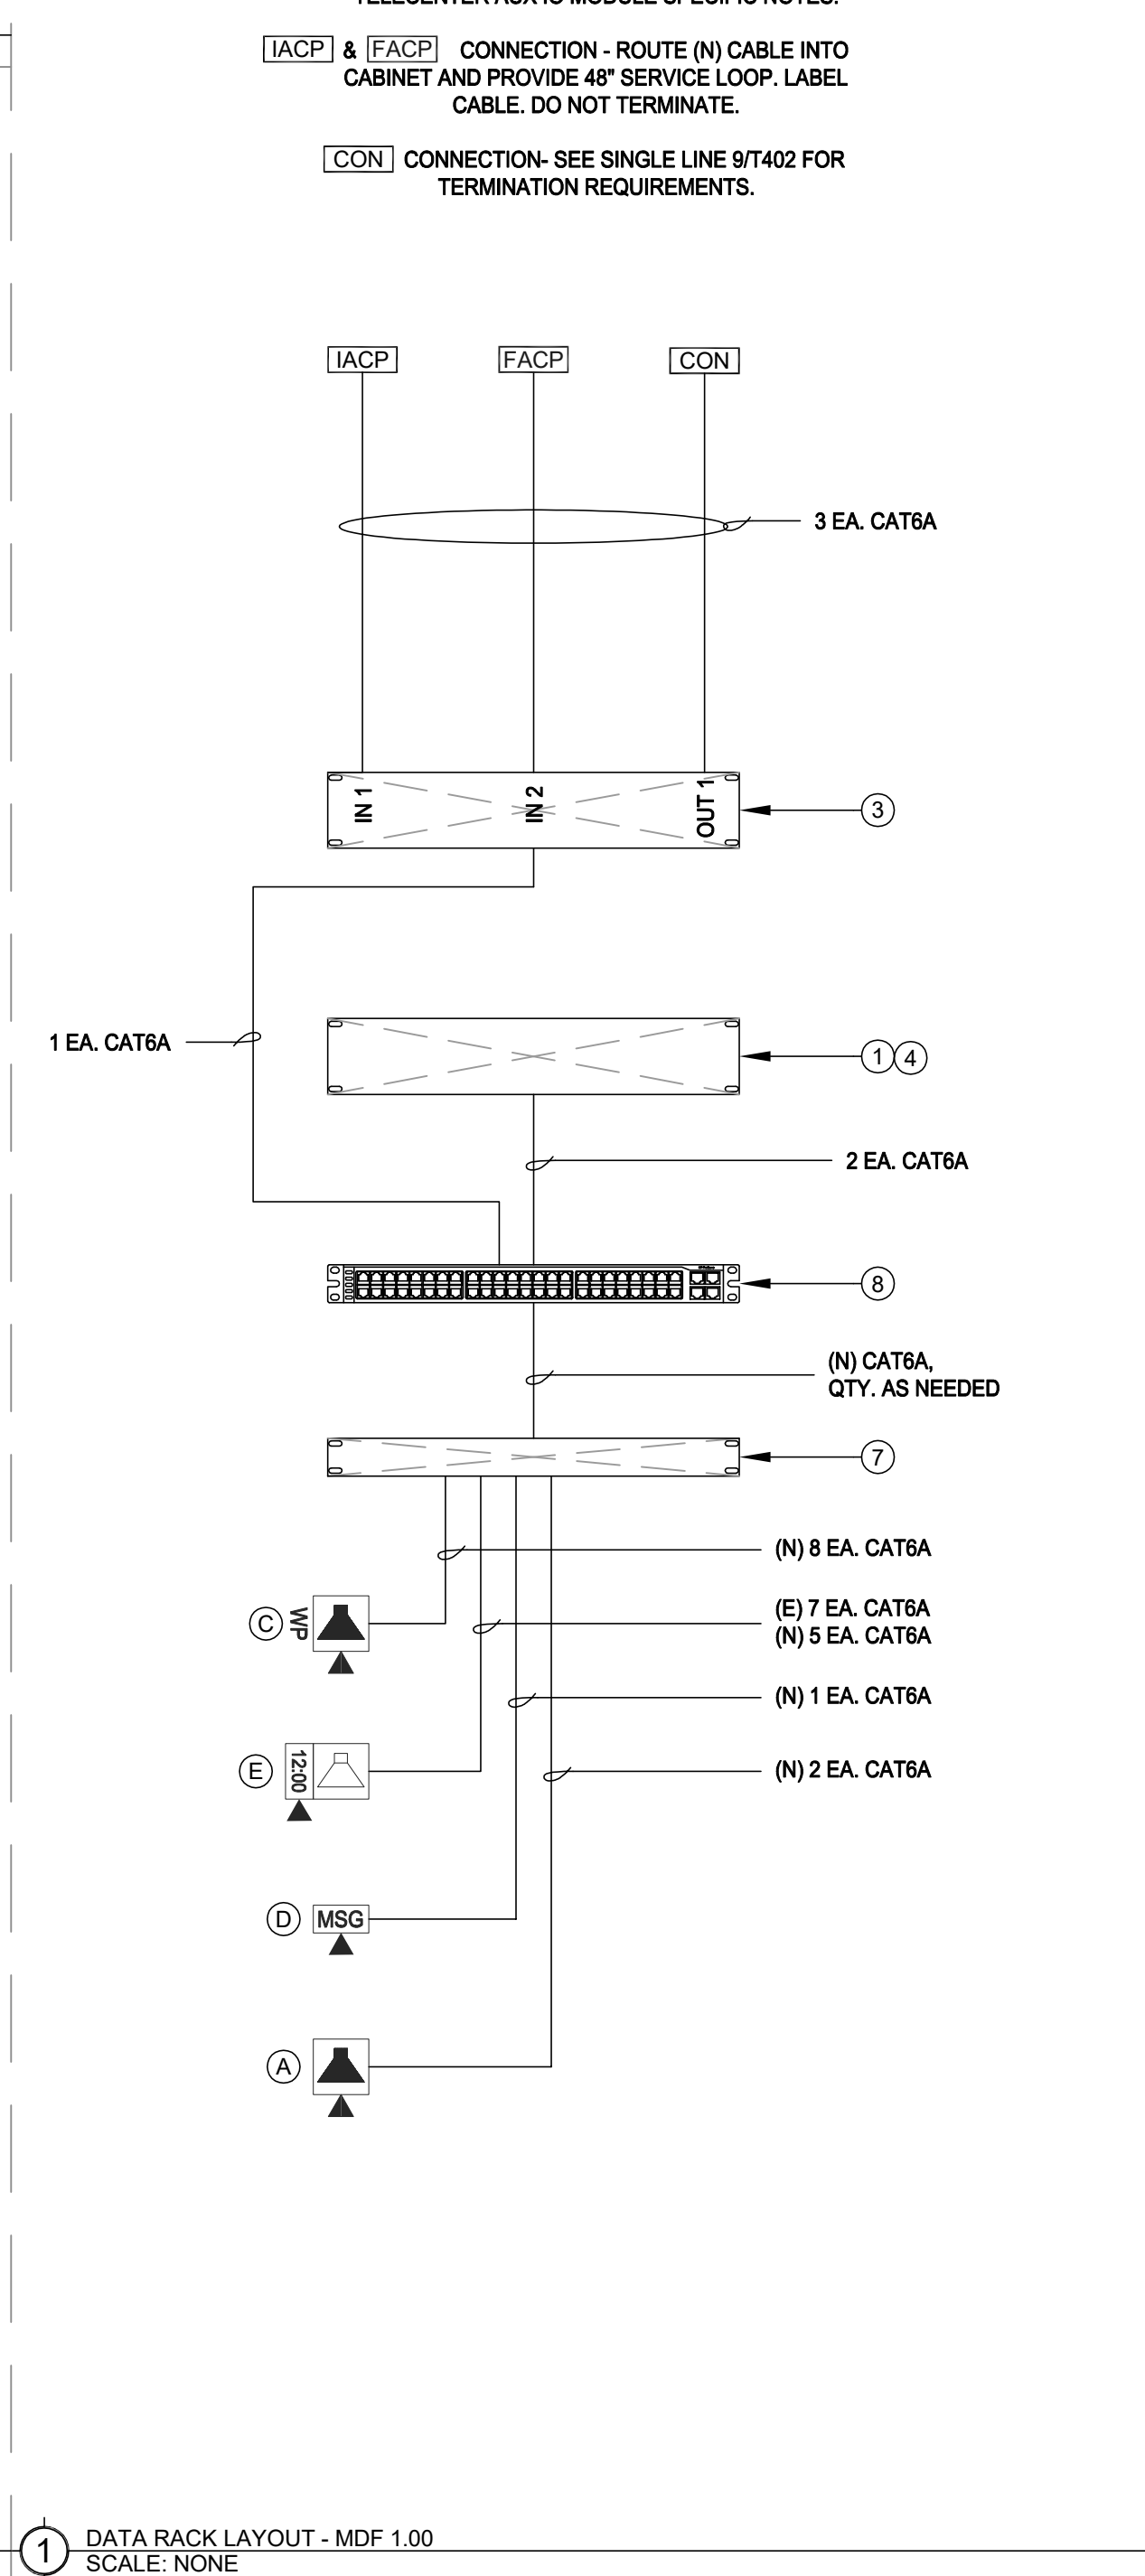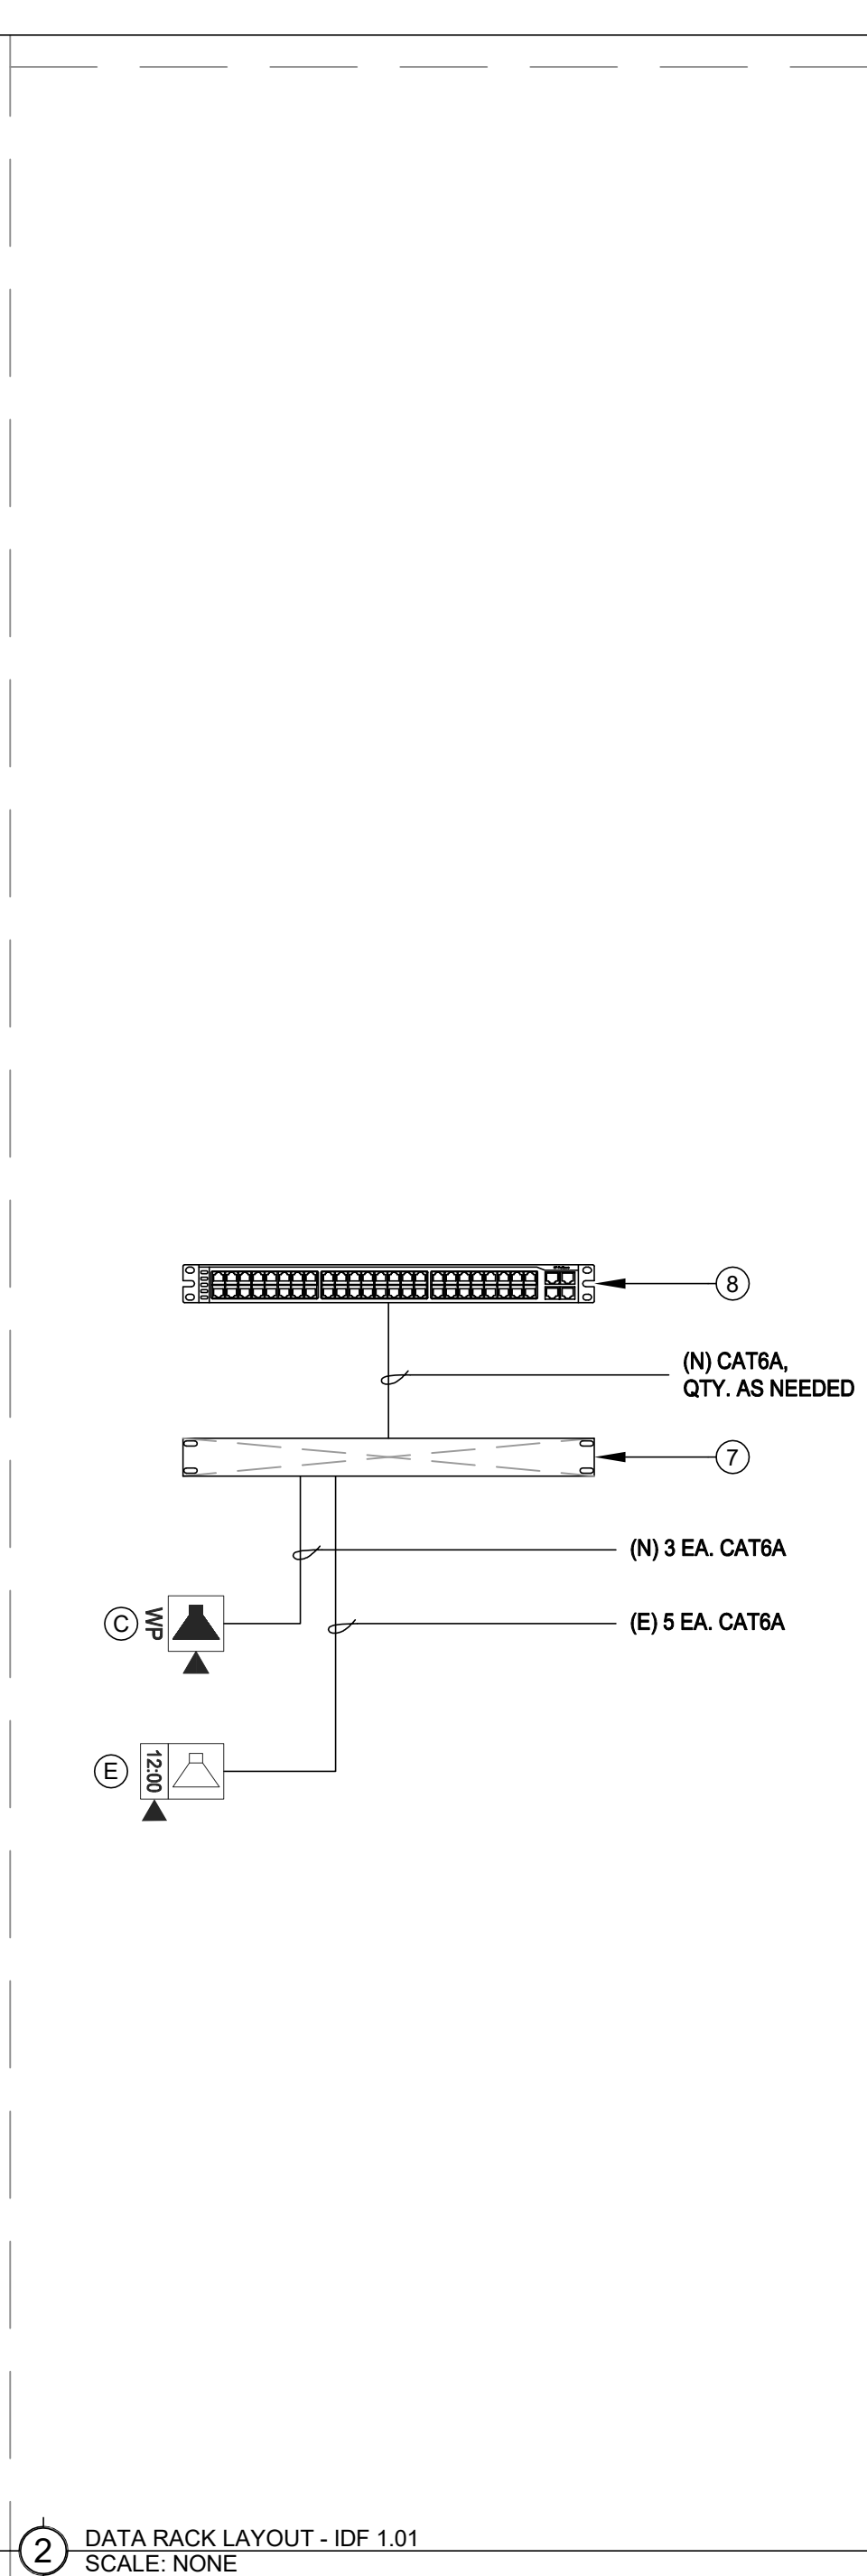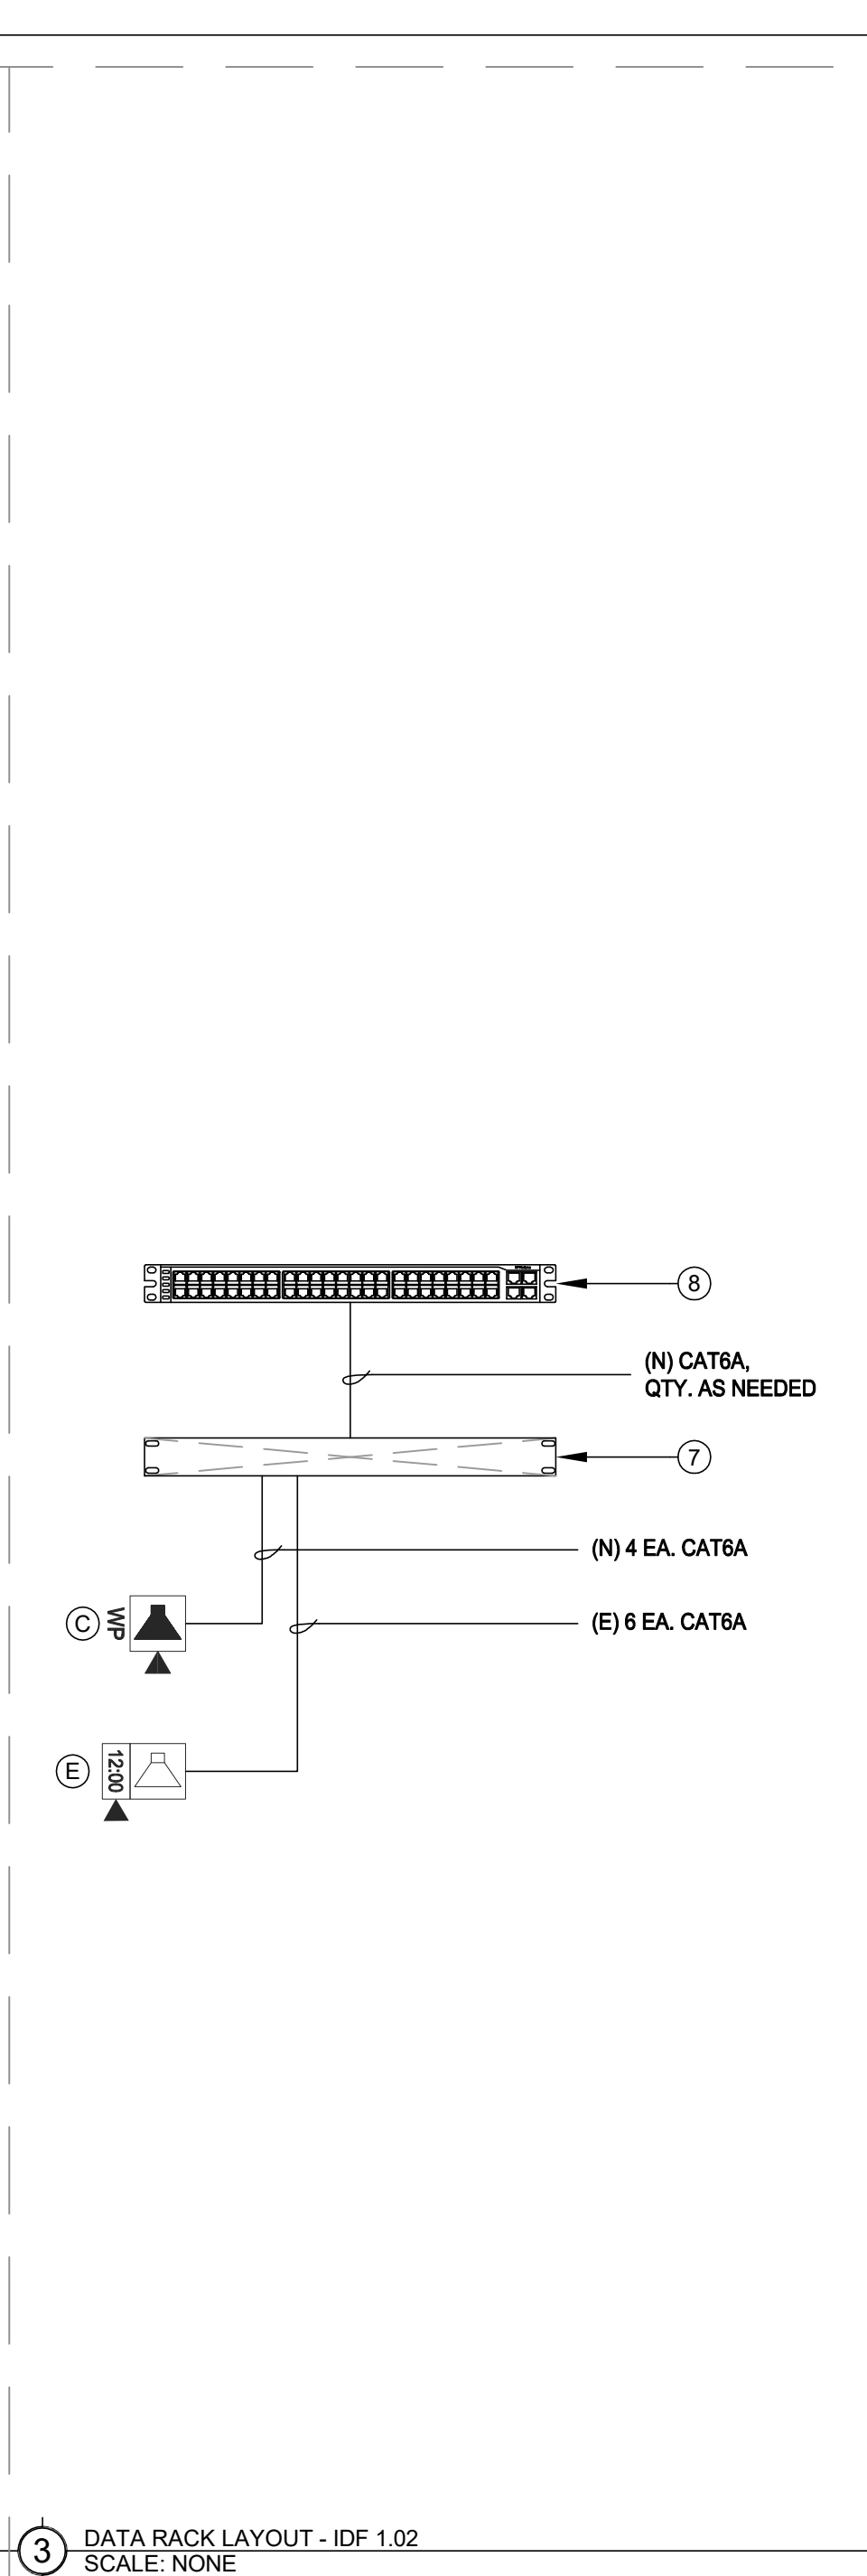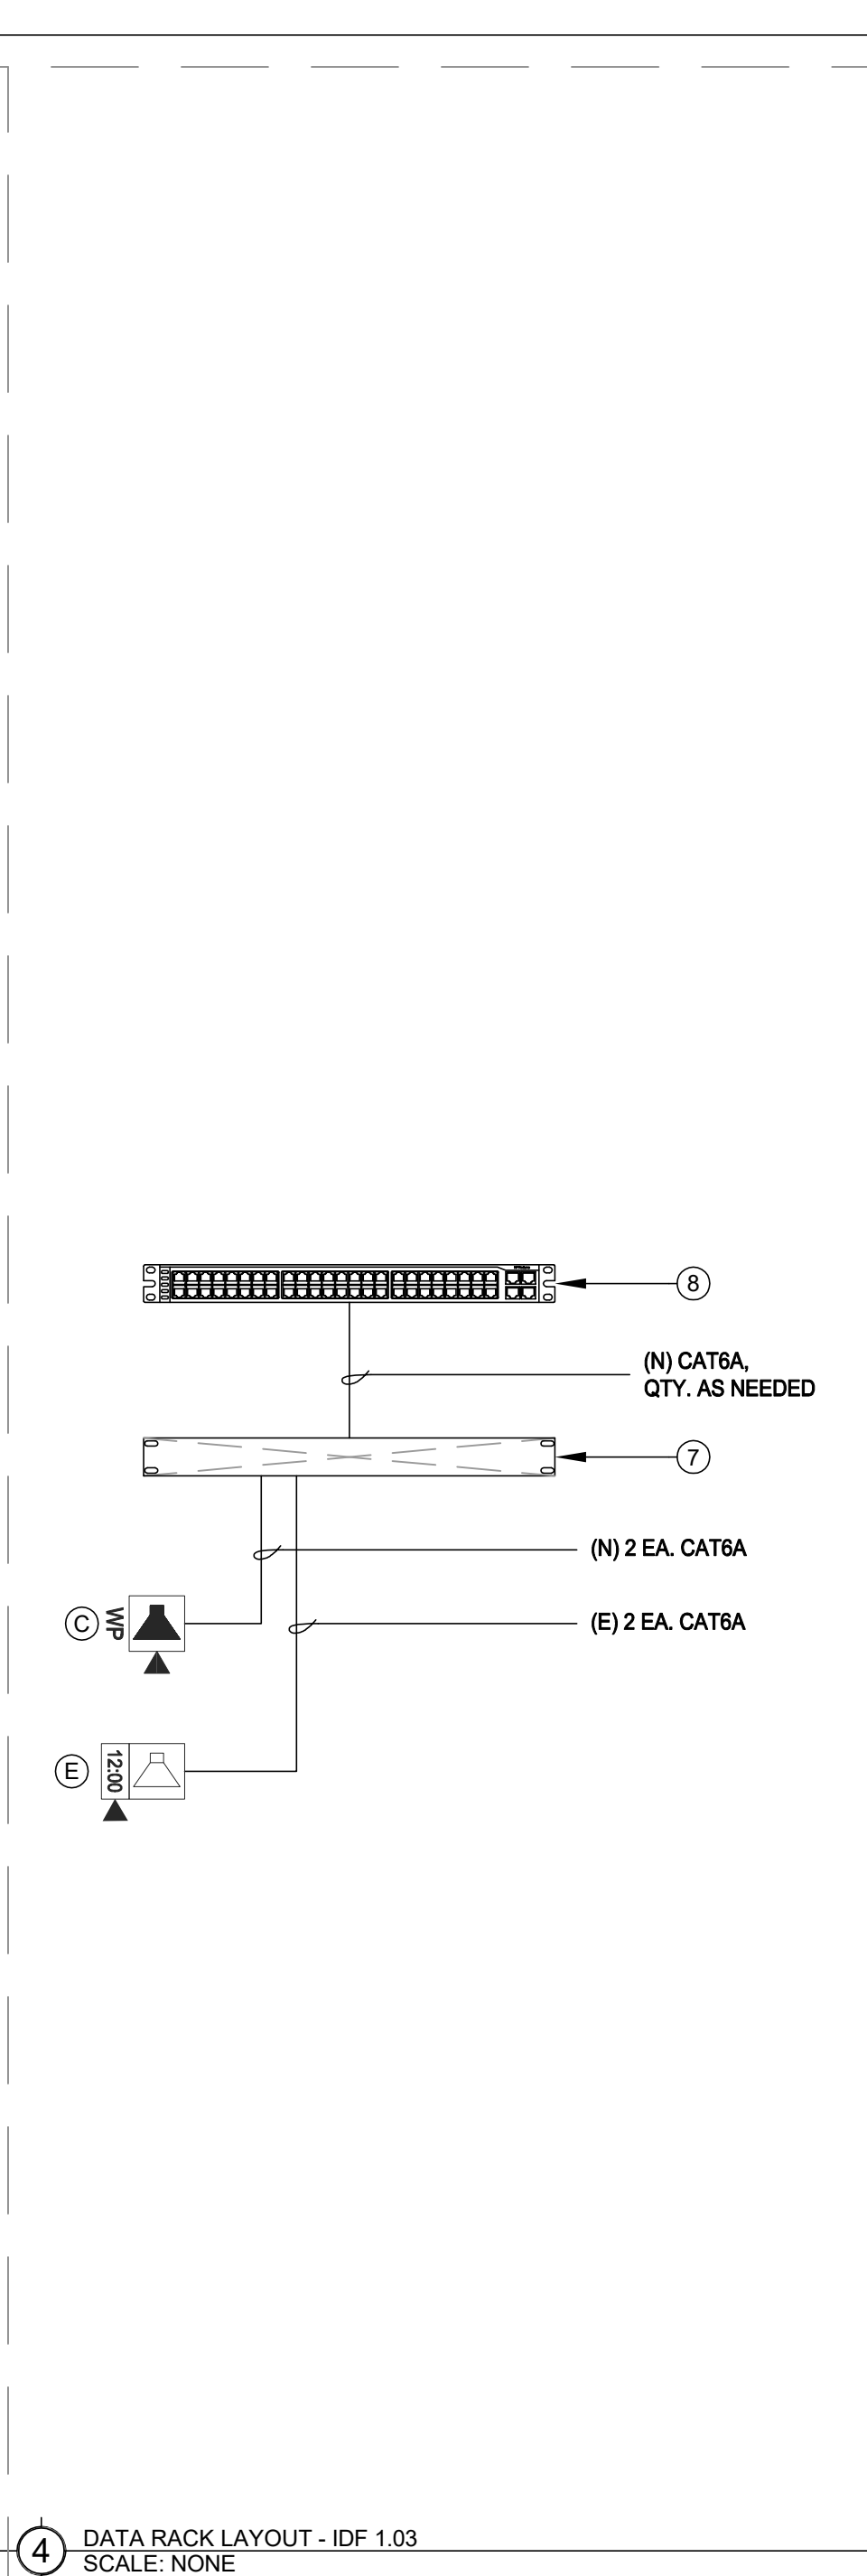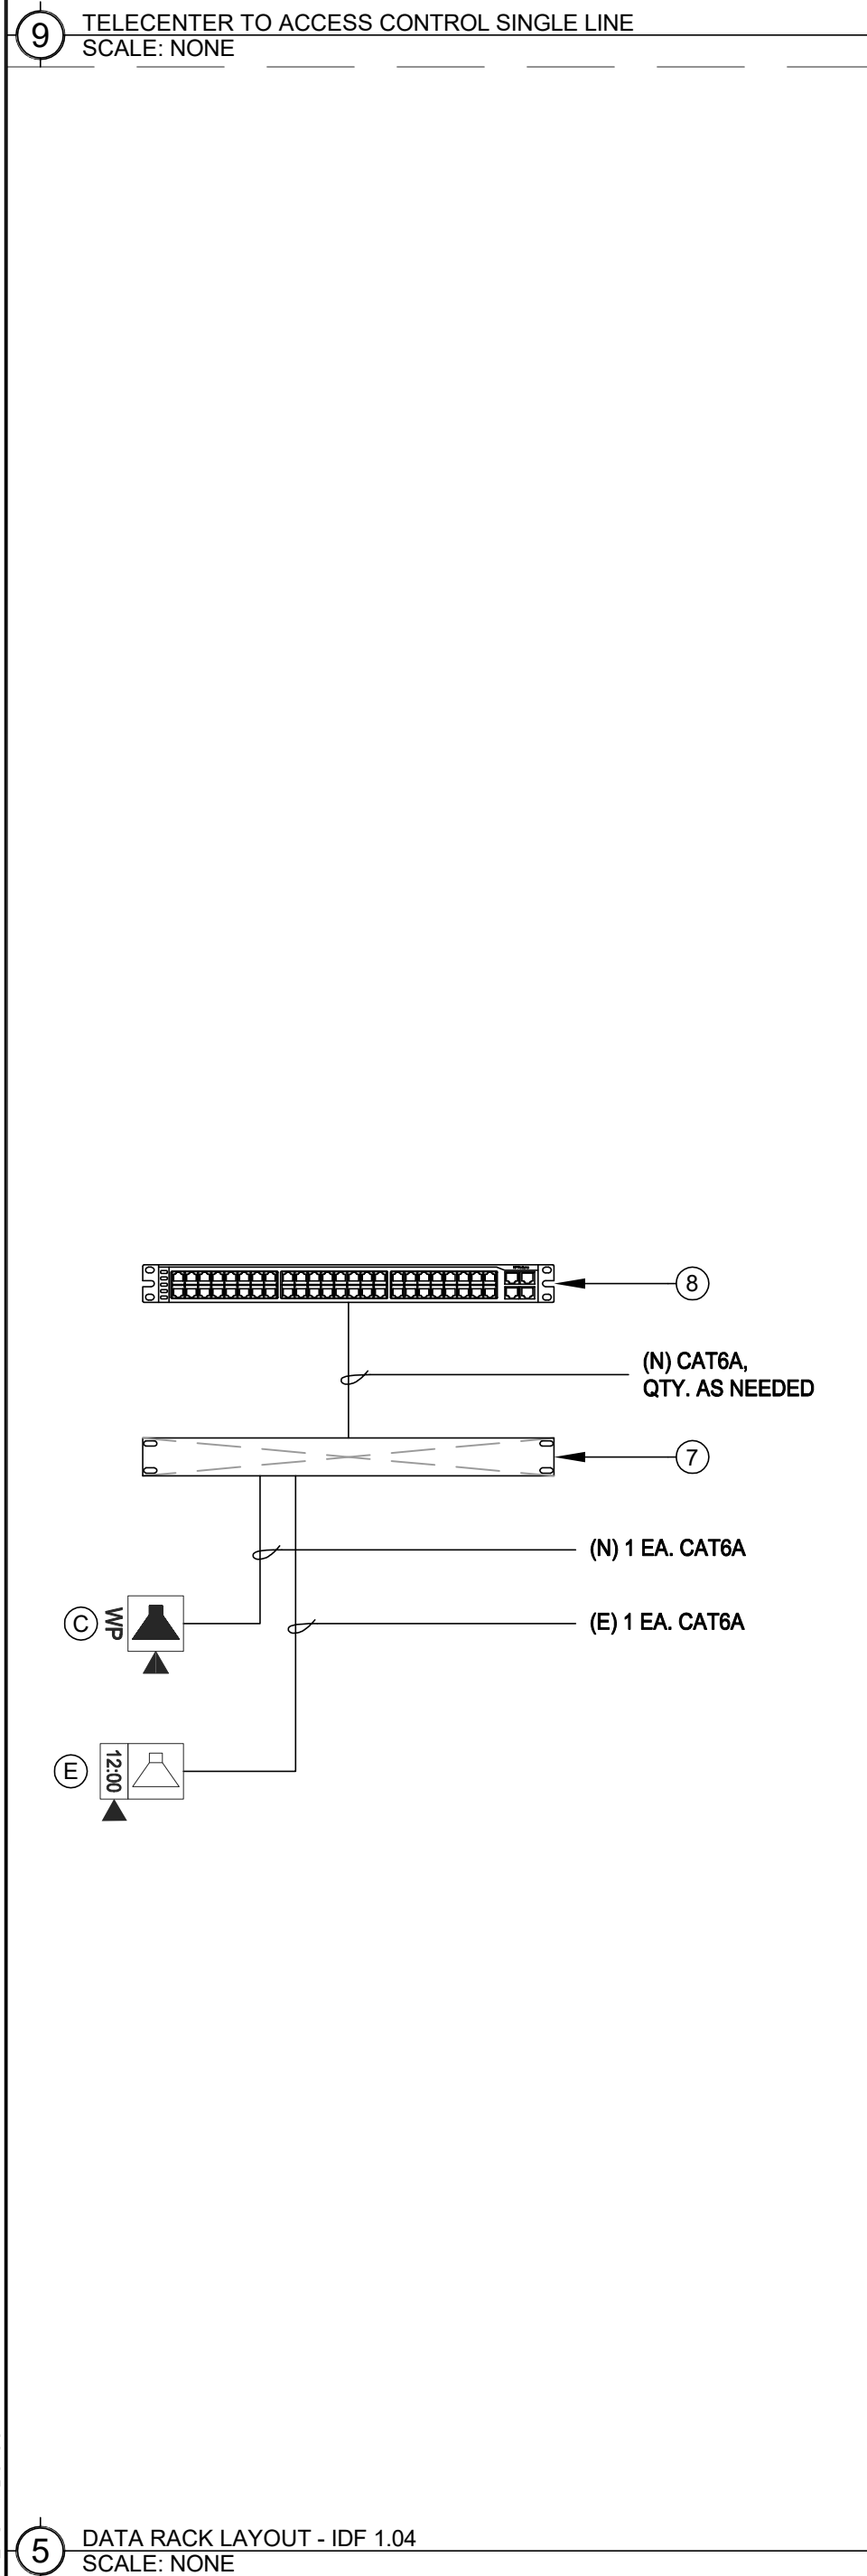Login Name: jgoodin  
Plot Date: May 16, 2025 -- 3:18 pm  
XREF: JGoodin  
C:\Users\jgoodin\AppData\Local\Temp\T402\_Single\_Line.dwg



TELECENTER AUX IO MODULE SPECIFIC NOTES:  
[IACP] & [FACP] CONNECTION - ROUTE (N) CABLE INTO CABINET AND PROVIDE 48" SERVICE LOOP. LABEL CABLE. DO NOT TERMINATE.  
[CON] CONNECTION - SEE SINGLE LINE 9/7402 FOR TERMINATION REQUIREMENTS.

EQUIPMENT INTERCOM SCHEDULE: ALL EQUIPMENT AND MATERIALS ARE CONTRACTOR FURNISHED, INSTALLED AND CONFIGURED (UNO)				
SYMBOL	DESCRIPTION	MODEL	PART NUMBER	NOTES / DETAIL REFERENCES
①	TELECENTER U IP CONTROLLER	RAULAND	TCC2000	N/A
②	TELECENTER U ADMIN CONSOLE	RAULAND	TCC2045	N/A
③	TELECENTER U AUX. IN/OUT. MODULE		TCC2033	N/A
	UNIVERSAL RACK MOUNTING KIT		TCC2099	N/A
④	TELECENTER U PROGRAM LINE INPUT MODULE		TCC2055	N/A
⑦	24-PORT OR 48-PORT PATCH PANEL	SEE DATA TECHNOLOGY RACK ELEVATIONS BELOW FOR MORE INFORMATION.		(N) OR (E) AS NOTED
⑧	48-PORT NETWORK SWITCH	SEE DATA TECHNOLOGY RACK ELEVATIONS BELOW FOR MORE INFORMATION.		(N) OR (E) AS NOTED
[IACP]	INTRUSION ALARM CONTROL PANEL	EXISTING	EXISTING	N/A
[FACP]	FIRE ALARM CONTROL PANEL	EXISTING	EXISTING	N/A
[CON]	ACCESS CONTROL PANEL	EXISTING	EXISTING	N/A

EQUIPMENT SCHEDULE INTERIOR SURFACE SPEAKER: ALL EQUIPMENT AND MATERIALS ARE CONTRACTOR FURNISHED, INSTALLED AND CONFIGURED (UNO)				
DESCRIPTION	MODEL	PART NUMBER	NOTES / DETAIL REFERENCES	
TELECENTER U IP CLASSROOM MODULE	RAULAND	TCC2011B	MOUNT INSIDE ENCLOSURE	
8 OHM, 8" SPEAKER WITH RJ45 CONNECTOR	RAULAND	US0880	N/A	
SPEAKER BAFFLE	RAULAND	ACC1003	N/A	
SURFACE MOUNT SPEAKER ENCLOSURE	RAULAND	ACC1112	N/A	

EQUIPMENT SCHEDULE EXTERIOR SURFACE SPEAKER: ALL EQUIPMENT AND MATERIALS ARE CONTRACTOR FURNISHED, INSTALLED AND CONFIGURED (UNO)				
DESCRIPTION	MODEL	PART NUMBER	NOTES / DETAIL REFERENCES	
TELECENTER U IP CLASSROOM MODULE	RAULAND	TCC2011B	MOUNT INSIDE BUILDING	
TELECENTER U BREAKOUT MODULE	RAULAND	603101	MOUNT INSIDE BUILDING	
8 OHM, 8" MOISTURE RESISTANT SPEAKER	LOWELL	8C10MRB	N/A	
GRILLE VANDAL RESISTANT	RAULAND	ACC1012	N/A	
SURFACE MOUNT SPEAKER ENCLOSURE	RAULAND	ACC1113	N/A	
(N) SURFACE MOUNTED 4 GANG BACKBOX - WHITE	FSR	SMWB-4G-WHT	MOUNT INSIDE BUILDING	

EQUIPMENT SCHEDULE LARGE MESSAGE BOARD: ALL EQUIPMENT AND MATERIALS ARE CONTRACTOR FURNISHED, INSTALLED AND CONFIGURED (UNO)				
DESCRIPTION	MODEL	PART NUMBER	NOTES / DETAIL REFERENCES	
LARGE MESSAGE BOARD	RAULAND	TCC3012L	N/A	
PROTECTIVE CAGE	AMERICAN TIME	G20550F-28	N/A	


EQUIPMENT SCHEDULE INTERIOR SURFACE CLOCK/SPEAKER COMBO: ALL EQUIPMENT AND MATERIALS ARE CONTRACTOR FURNISHED, INSTALLED AND CONFIGURED (UNO)				
DESCRIPTION	MODEL	PART NUMBER	NOTES / DETAIL REFERENCES	
TELECENTER U IP CLASSROOM MODULE	RAULAND	TCC2011B	MOUNT IN ENCLOSURE	
IP DIGITAL CLOCK	RAULAND	TCC3011S	N/A	
BAFFLE ASSEMBLY WITH SPEAKER	RAULAND	ACC3011S	N/A	
SURFACE MOUNT ENCLOSURE CLOCK/SPEAKER COMBO	RAULAND	ACC3011SBB	N/A	

ACTION MATRIX: INTERCONNECTIONS TO OTHER SYSTEMS				
MODULES		TCC2033 (IDF 1.01)		
I/O PORTS		IN-1	IN-2	OUT-1
EVENT: LOCKDOWN				[C]
EVENT: INTRUSION ALARM ACTIVE	[A]			
EVENT: FIRE ALARM ACTIVE		[B]		
[A]	INPUT: CLOSURE FROM INTRUSION ALARM PANEL			
[B]	INPUT: CLOSURE FROM FIRE ALARM PANEL			
[C]	OUTPUT: CLOSURE TO ACCESS CONTROL			



KMM SERVICES, INC  
TECHNOLOGY & FIRE LIFE SAFETY

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IF DRAWING IS NOT 30"X42" IT IS A REDUCED PRINT
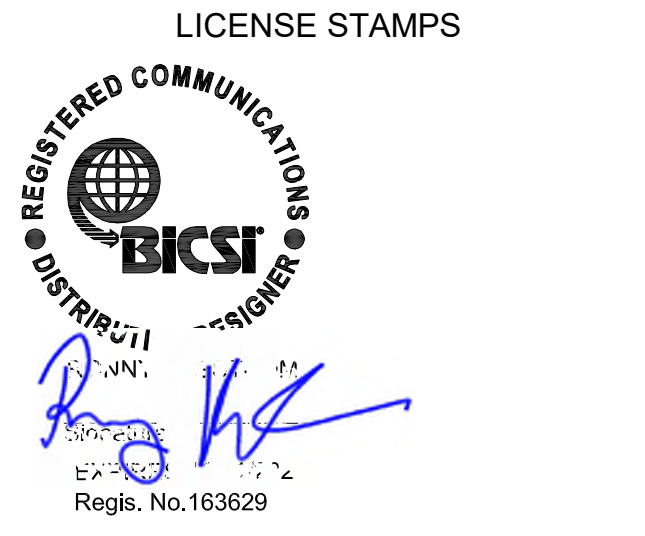
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H.W. HARKNESS  
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2147 54TH AVENUE  
SACRAMENTO, CA 95822  
SHEET TITLE  
TECHNOLOGY  
SINGLE LINE DIAGRAMS





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NOTE:  
 (1) DEVICE BOX (10) TO BE USED TO TRANSITION OVER CONDUIT AND SHALLOW WALL OBSTRUCTIONS (I.E. BULLETIN BOARD, TRIM, CASEWORK, ETC.) WHERE REQUIRED. UNDER NO CIRCUMSTANCES SHOULD SURFACE RACEWAY BE BENT OVER OBSTRUCTIONS.



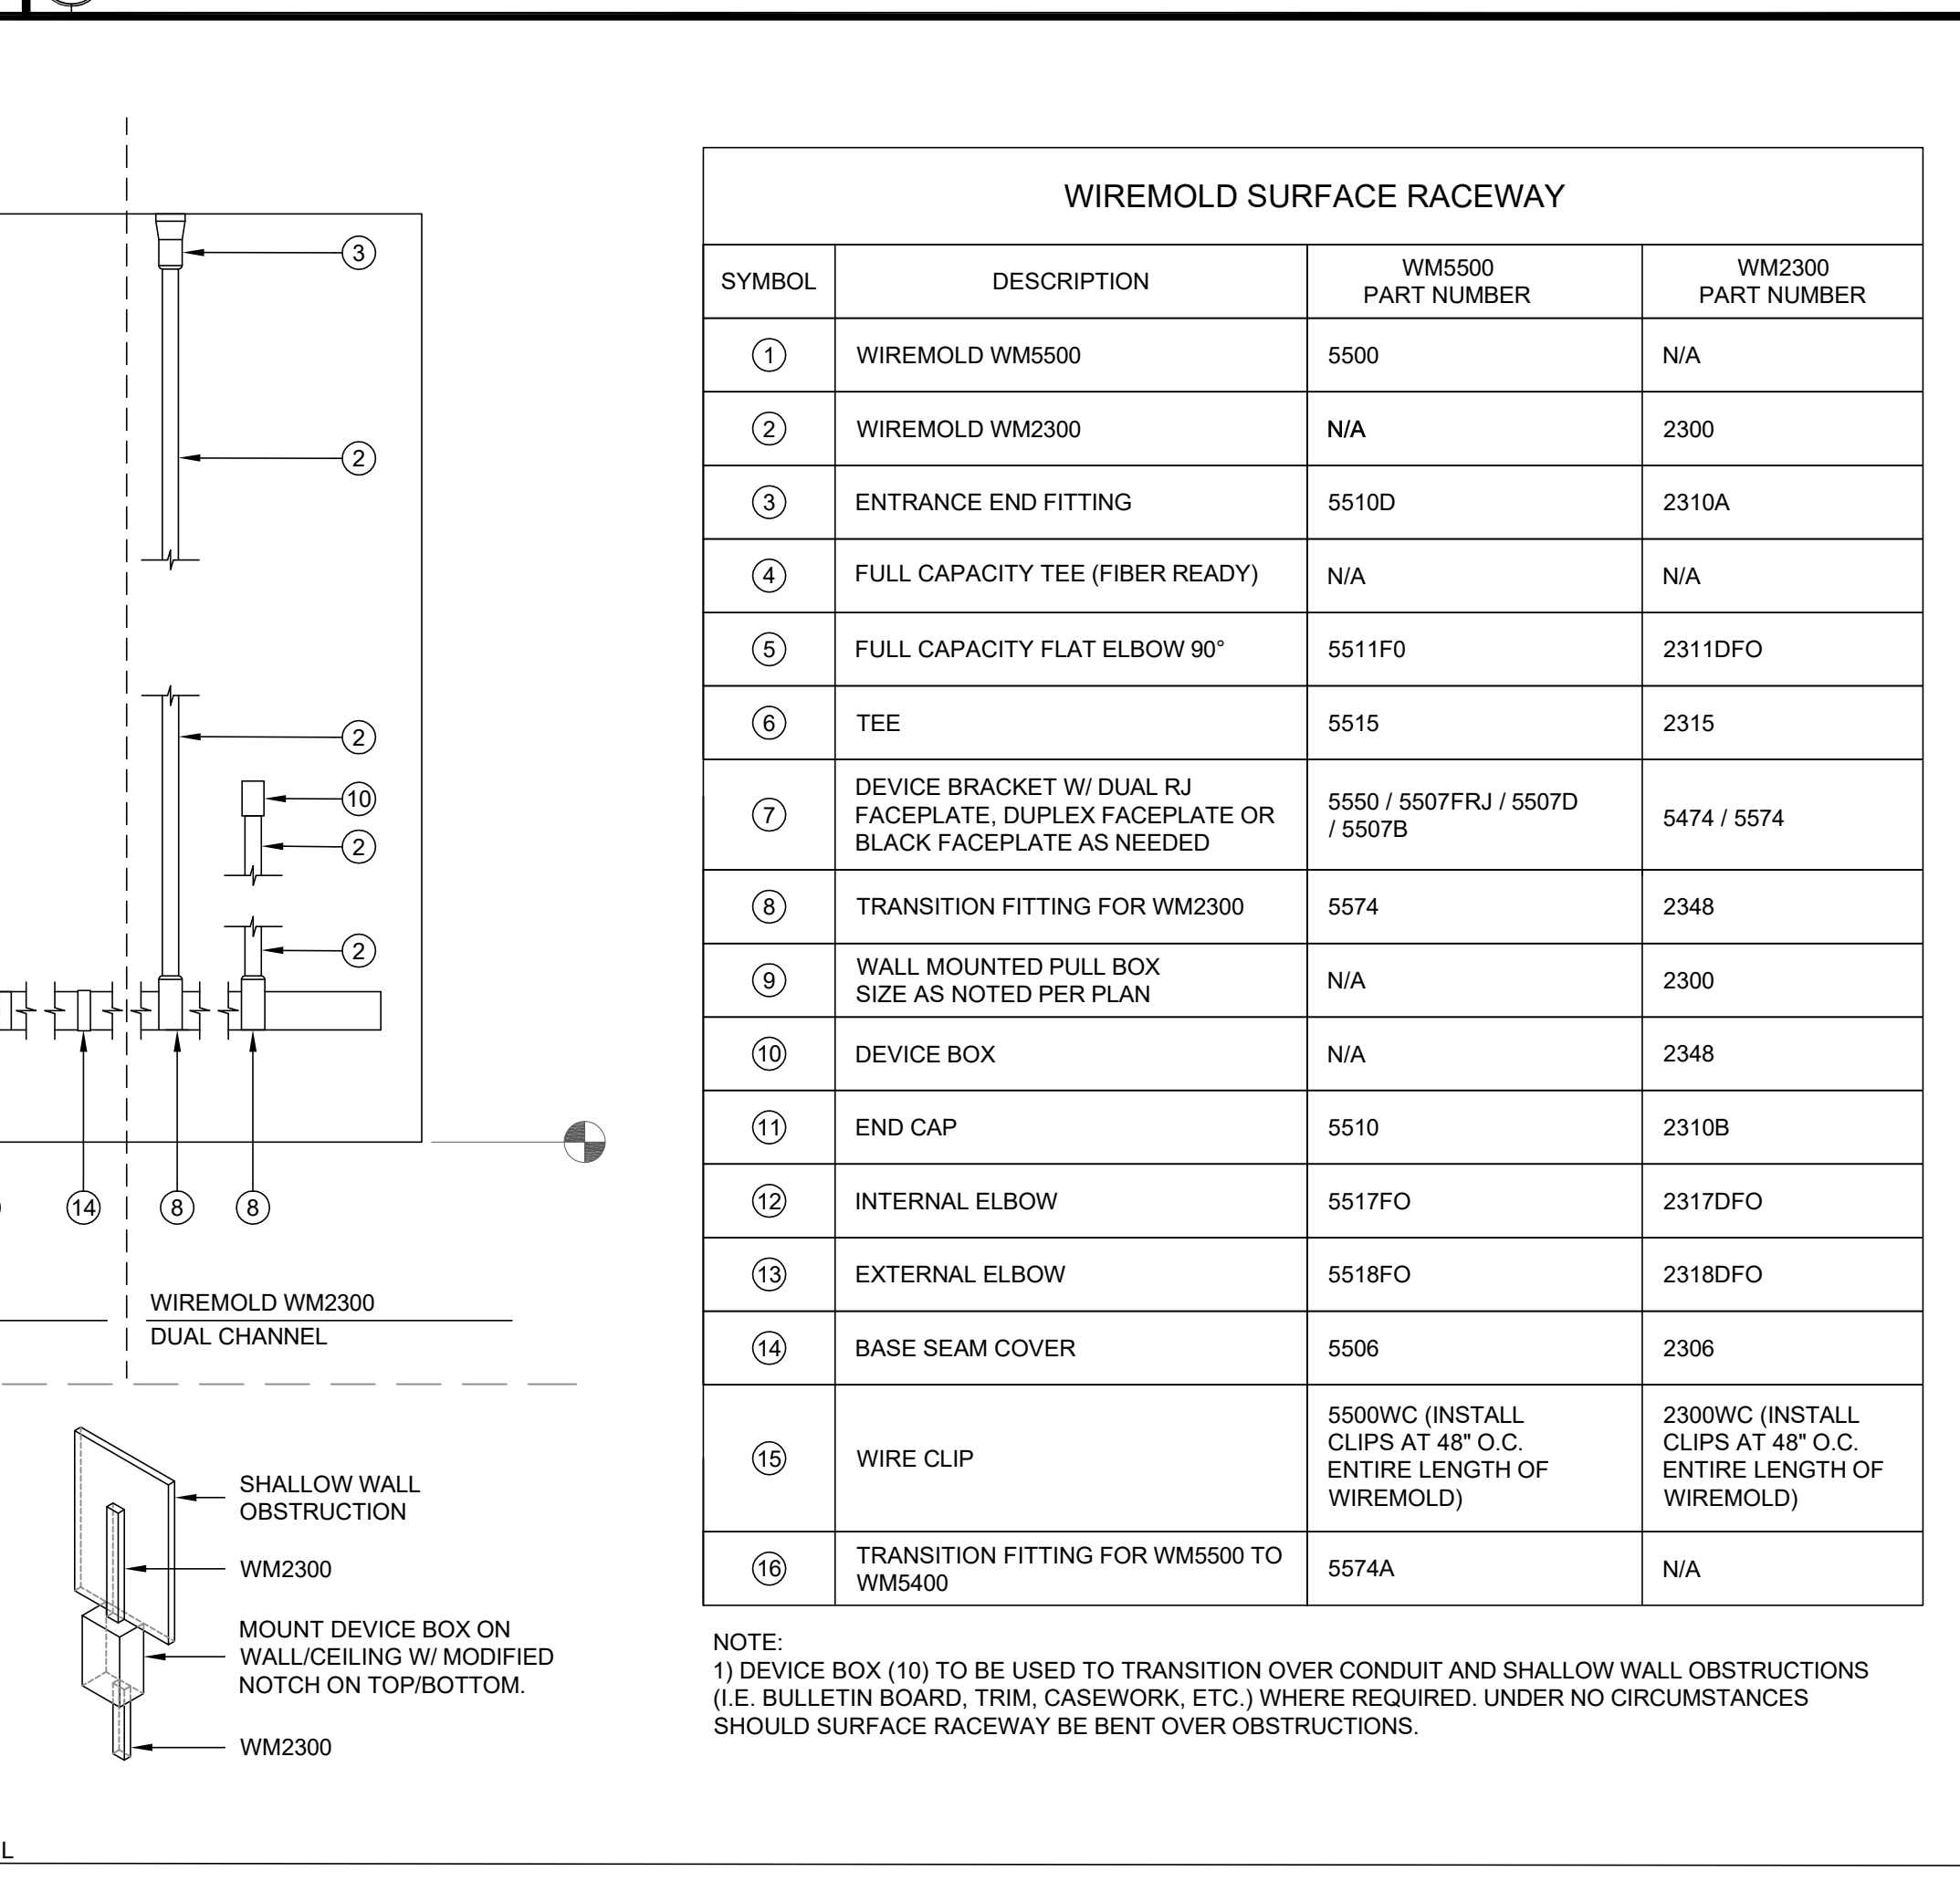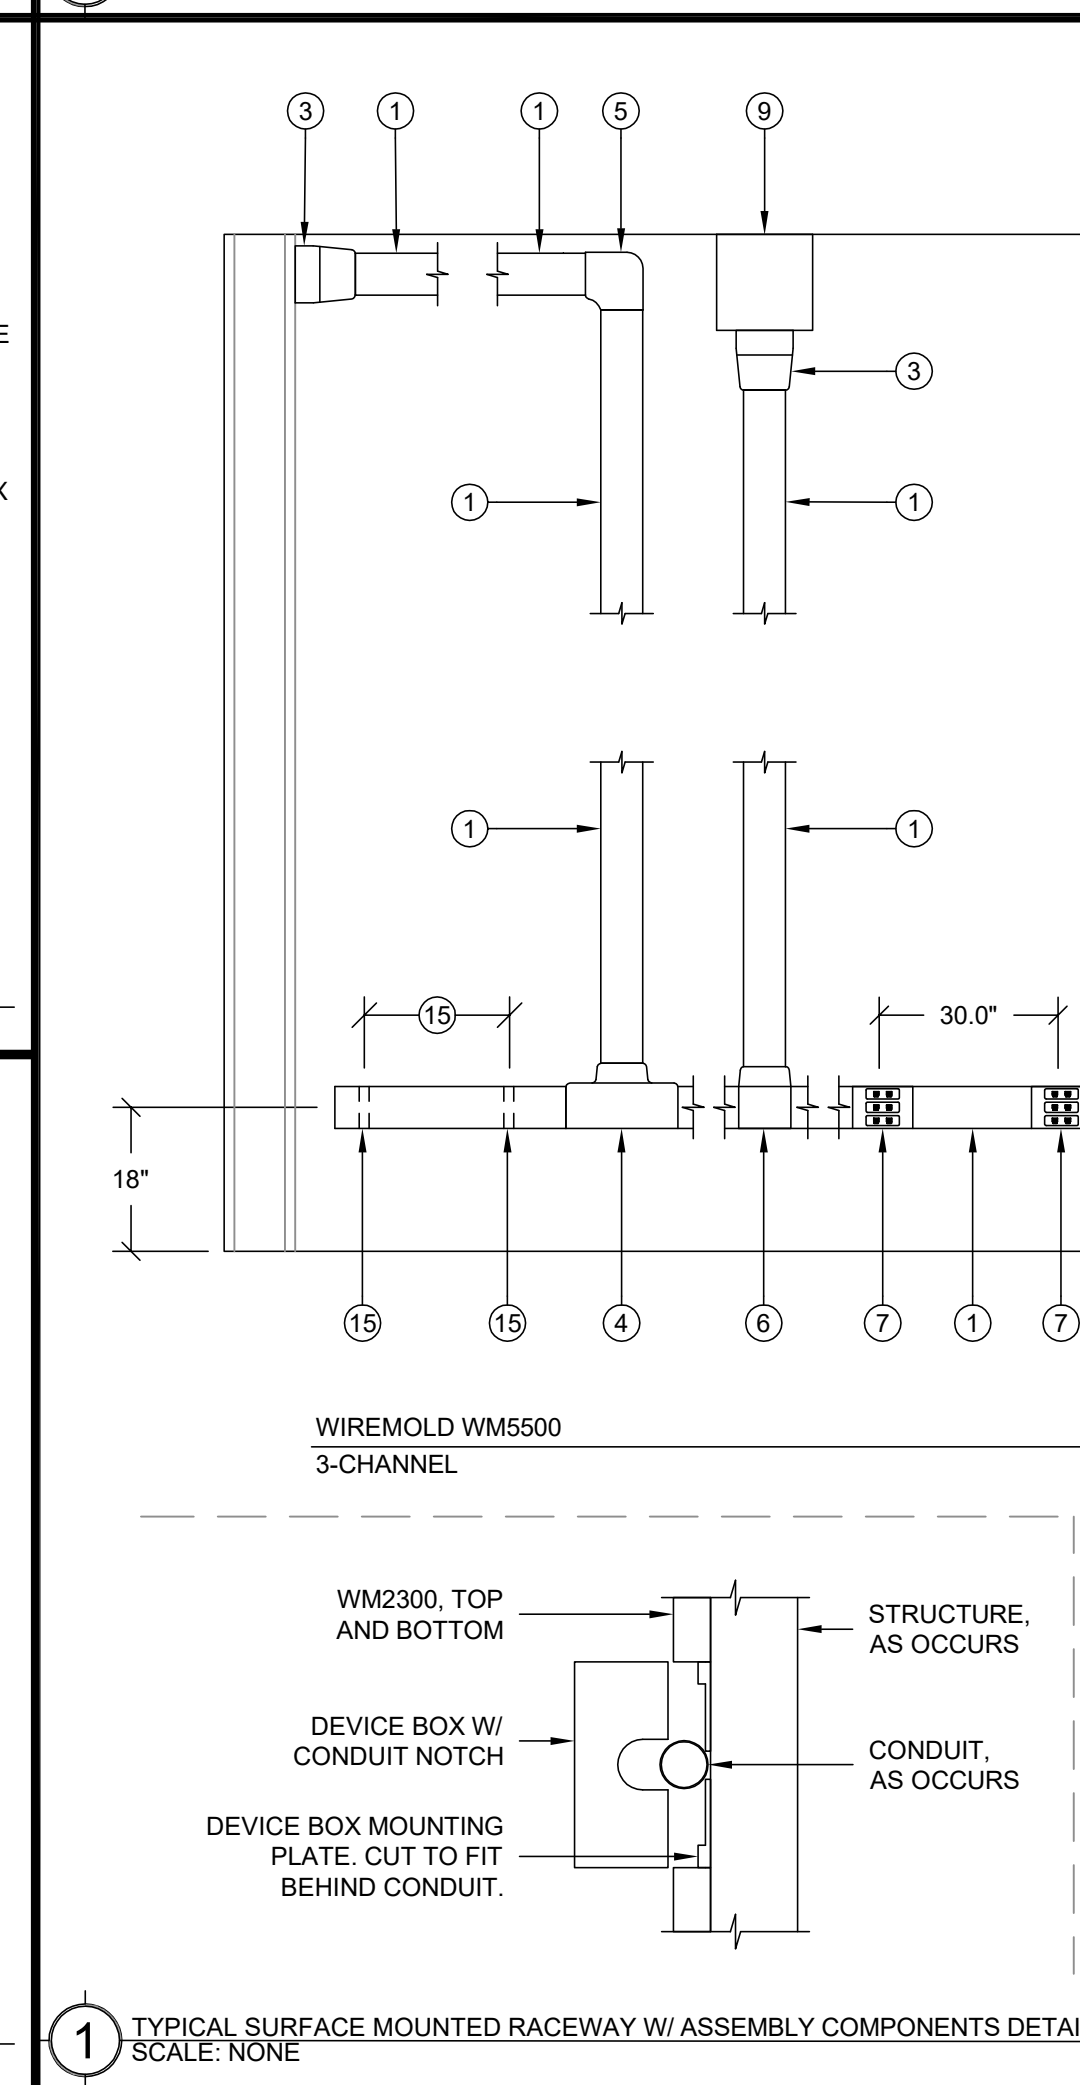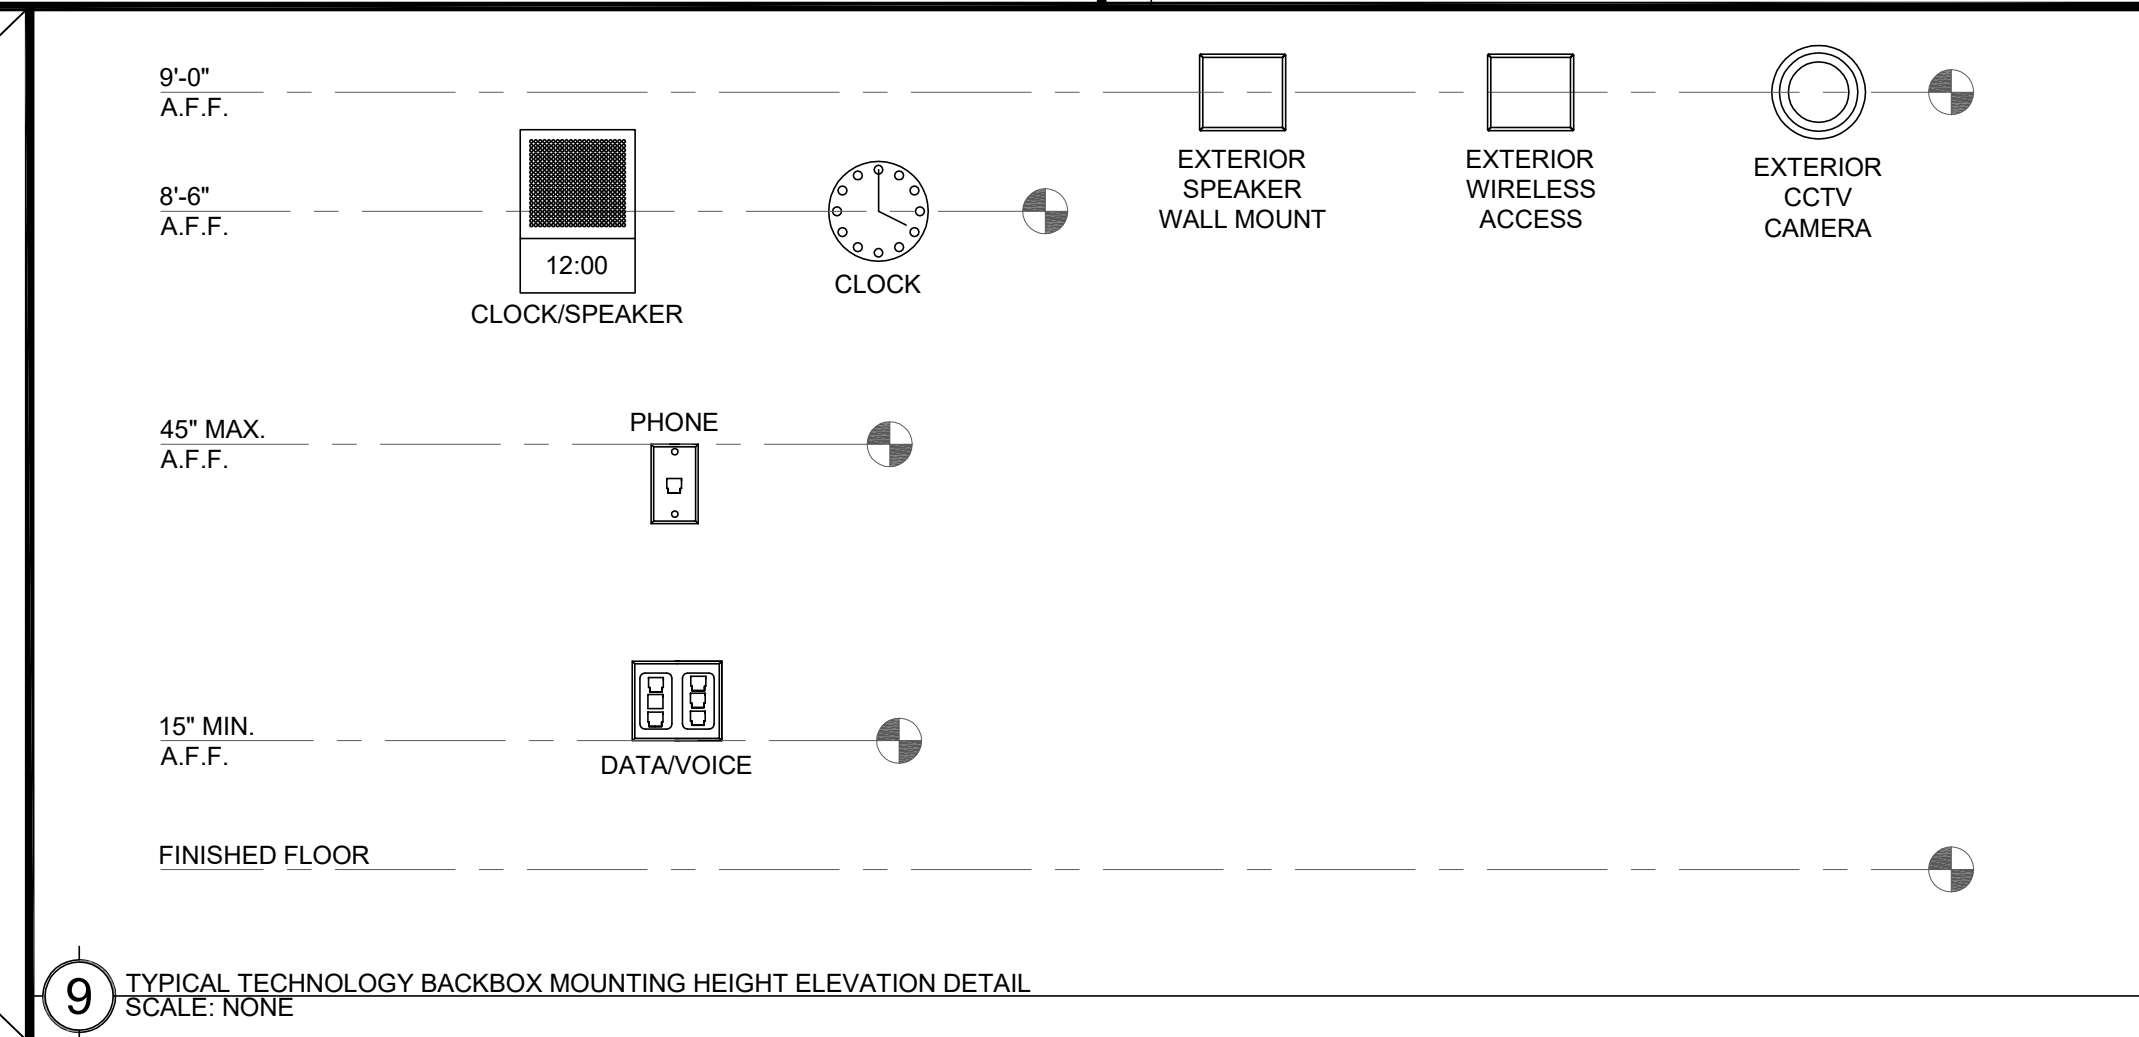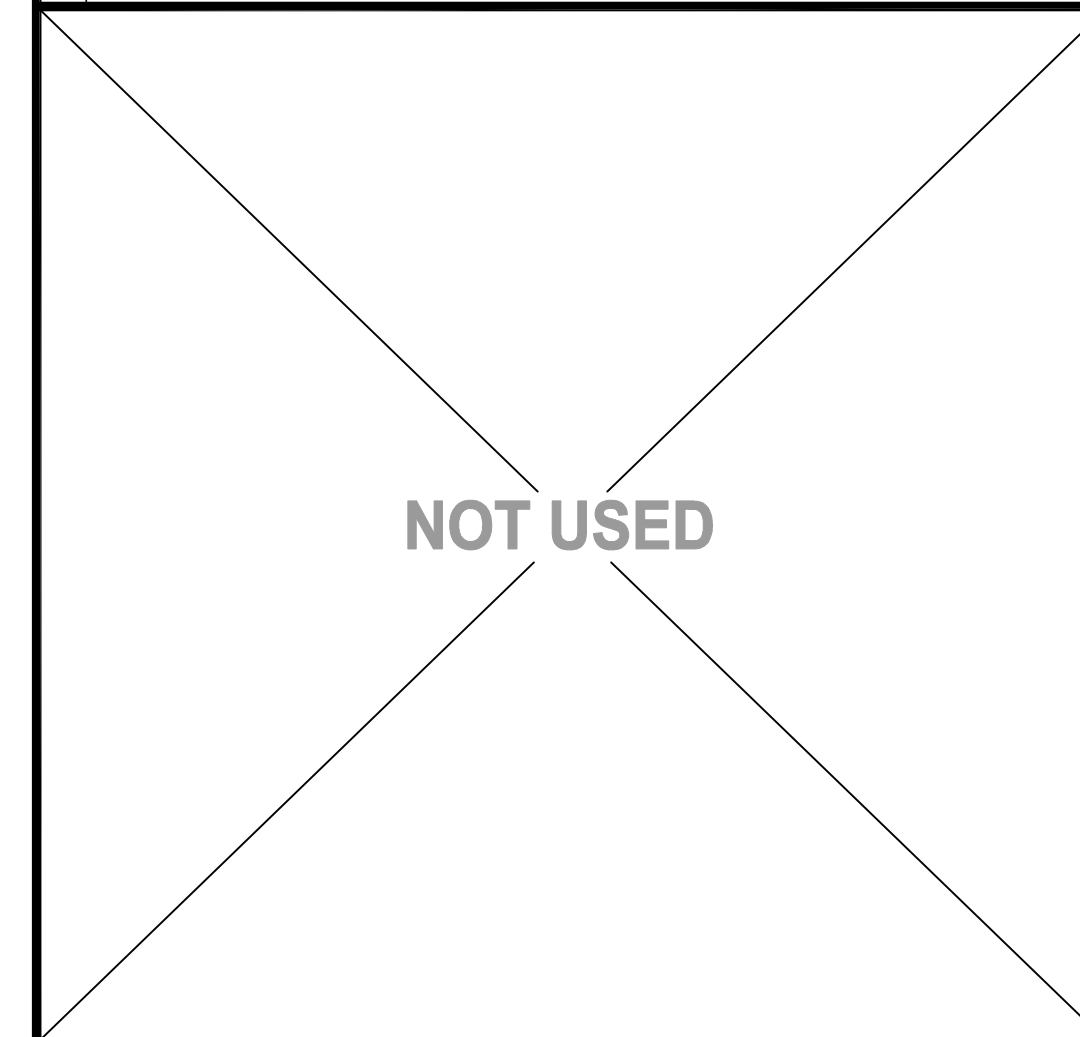