

MATSUYAMA ELEMENTARY SCHOOL

3186-070-000

SACRAMENTO, CA, 95816

OWNER DISTRICT

ARCHITECTURE

CIVIL T (916) 985-1870

LANDSCAPE **MTW GROUP** T (916) 369-3990

STRUCTURAL

T (916) 716-6910 MECHANICAL

ELECTRICAL

PLUMBING T (916) 771-0778

FOOD SERVICE T (530)333-4606

FACILITY: MATSUYAMA ELEMENTARY SCHOOL 7680 WINDBRIDGE DRIVE SACRAMENTO, CA 95831

PROJECT: MATSUYAMA ELEMENTARY SCHOOL MODERNIZATION


SHEET NAME: **COVER SHEET**



DATE: 01/04/2024 SHEET:



DSA SUBMITTAL

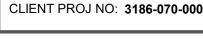



GENERAL NOTES

- CONSTRUCTION DOCUMENTS DESCRIBE THE PRODUCTS, SYSTEMS, QUANTITIES, CONFIGURATION, AND PERFORMANCE SPECIFICATIONS THAT DELIVER THE OVERALL DESIGN INTENT OF THE PROJECT. THE CONSTRUCTION DOCUMENT DRAWINGS AND SPECIFICATIONS ARE COMPLEMENTARY, AND WHAT IS REQUIRED BY ONE SHALL BE AS BINDING AS IF REQUIRED BY BOTH. PERFORMANCE BY THE CONSTRUCTION
- TEAM SHALL BE CONSISTENT WITH THE CONSTRUCTION DRAWINGS AND SPECIFICATIONS AS NECESSARY TO DELIVER THE INDICATED RESULTS OF THE DESIGN INTENT. VERIFY ALL DIMENSIONS, LOCATIONS OF
- EXISTING UTILITIES, AND CONDITIONS ON THE JOB SITE PRIOR TO THE START OF WORK OR PORTIONS OF THE WORK. NOTIFY THE ARCHITECT IMMEDIATELY OF ANY DISCREPANCIES BETWEEN THE ACTUAL FIELD CONDITIONS AND THE CONSTRUCTION DOCUMENTS. EXISTING CONDITIONS ARE INDICATED AS A RESULT OF FIELD OBSERVATIONS, INFORMATION SHOWN ON AVAILABLE DOCUMENTS AND FIELD CONDITIONS AT THE TIME OF
- PREPARATION. ALL MATERIALS AND WORKMANSHIP SHALL COMPLY WITH ALL GOVERNING CODES, ORDINANCES, REGULATIONS AND LAWS. THE DESIGN ADEQUACY AND SAFETY OF ERECTION BRACING, SHORING, TEMPORARY SUPPORTS AND
- SCAFFOLDING IS THE SOLE RESPONSIBILITY OF THE CONTRACTOR. WHERE ANY CONFLICT OCCURS BETWEEN THE REQUIREMENTS OF LAWS, CODES, ORDINANCES, RULES AND REGULATIONS, THE MOST STRINGENT SHALL GOVERN. IN NO CASE SHALL WORKING DIMENSIONS BE SCALED FROM PLANS, SECTIONS OR DETAILS ON THE DRAWINGS.
- DETAILS MARKED 'TYPICAL' SHALL APPLY IN ALL CASES UNLESS SPECIFICALLY NOTED OTHERWISE ENACT ALL MEASURES TO PROTECT AND 10. SAFEGUARD ALL EXISTING ELEMENTS TO
- REMAIN FROM BEING DAMAGED. REPLACE OR REPAIR EXISTING ELEMENTS DAMAGED BY THE EXECUTION OF THIS CONTRACT TO EQUAL OR BETTER CONDITION. 11. PRIOR TO THE START OF WORK THE CONTRACTOR SHALL COORDINATE
- BETWEEN THE REQUIREMENTS OF ALL DISCIPLINES HEREIN AND BETWEEN THE REQUIREMENTS OF ALL DRAWINGS AND SPECIFICATIONS IN ORDER THAT ALL ITEMS SATISFACTORILY RELATE TO ONE ANOTHER. NOTIFY ARCHITECT IMMEDIATELY REGARDING ANY ITEMS THAT CANNOT BE COORDINATED.
- 12. CONTRACTOR SHALL EXCERCISE EXTREME CAUTION IN EXCAVATING AND TRENCHING ON THIS SITE TO AVOID EXISTING DUCTS, PIPING, CONDUIT, ETC. AND TO PREVENT HAZARD TO PERSONNEL AND/OR TO EXISTING UNDERGROUND UTILITIES OR STRUCTURES. THE CONTRACTOR SHALL
- IMMEDIATELY NOTIFY THE ARCHITECT SHOULD SUCH UNIDENTIFIED CONDITIONS BE DISCOVERED. THESE DRAWINGS AND SPECIFICATIONS DO NOT INCLUDE THE NECESSARY COMPONENTS FOR CONSTRUCTION SAFETY.
- CHANGES TO THE APPROVED DRAWINGS 13. AND/OR SPECIFICATIONS SHALL BE MADE BY ADDENDA OR A CHANGE ORDER. CUTTING, BORING, SAWCUTTING OR 14 DRILLING THROUGH THE EXISTING OR NEW STRUCTURAL ELEMENTS SHALL NOT TO BE STARTED UNTIL THE DETAILS HAVE BEEN REVIEWED AND APPROVED BY THE

SYMBOL LEGEND

OF RECORD.

\AX.XX

🖌 AX.XX 🕨 A2

A3

18/AX.XX

📥 SIM•

(1) (AX.XX)

AX.XX

(101A)

FA

09-WF1

ARCHITECT, AND STRUCTURAL ENGINEER

NORTH ARROW

TICK INDICATES PLAN NORTH

ELEVATION CALLOUT

ELEVATION CALLOUT

LOCATION & SHEET WHERE

ELEVATION IS DRAWN

SECTION CALLOUT

LOCATION ON SHEET

DETAIL CALLOUT

LOCATION ON SHEET

GRID BUBBLE

DOOR CALLOUT

MATERIAL FINISH TYPE

(SEE FINISH SCHEDULE)

WINDOW CALLOUT

(SEE WINDOW SCHEDULE)

WINDOW NUMBER

DOOR NUMBER

GRID NUMBER

← FIRST FLOOR ● NAME OF ELEVATION (IF APPLICABLE) +0' - 0" ● ELEVATION ABOVE FINISHED FLOOP

INDICATES A SIMILAR CONDITION

INDICATES A SIMILAR CONDITION

SHEET WHERE SECTION IS DRAWN

CONTROL OR DATUM POINT

EXISTING BUILDING GRID SYMBOL

INTERIOR FINISH CALLOUT

NEW BUILDING GRID SYMBOL

SHEET WHERE SECTION IS DRAWN

LOCATION ON SHEET

LOCATION ON SHEET

ARROW INDICATES TRUE NORTH

SHEET WHERE ELEVATION IS DRAWN

SHEET WHERE ELEVATION IS DRAWN

ELEVATION CALLOUT - ALT.

- ALL WORK SHALL CONFORM TO 2022 15. EDITION TITLE 24, CALIFORNIA CODE OF **REGULATION (CCR)** THE LIMIT OF WORK LINE SHOWS THESE DRAWINGS IS AN APPROXIMATE LIMIT OF WORK ONLY. REFER TO CONSULTANT DRAWINGS FOR ADDITIONAL WORK. INCLUDING BUT NOT LIMITED TO INSTALLATION OF CONDUIT, MANHOLES, PULLBOXES, ETC WHICH ARE TO BE PART OF THIS WORK, ALTHOUGH OCCURING OUTSIDE OF SHOWN LIMIT OF WORK LINES.
- FABRICATION AND INSTALLATION OF DEFERRED SUBMITTAL ITEMS SHALL NOT BE STARTED UNTIL CONTRACTOR'S DRAWINGS, SPECIFICATIONS, AND ENGINEERING CALCULATIONS FOR THE ACTUAL SYSTEMS TO BE INSTALLED HAVE BEEN ACCEPTED AND SIGNED BY THE ARCHITECT OR STRUCTURAL ENGINEER AND APPROVED BY THE DSA. LIST DEFERRED SUBMITTAL ITEMS FOR THIS
- PROJECT. CHANGE TO THE APPROVED DRAWINGS AND SPECIFICATIONS SHALL BE MADE BY ADDENDA OR CONSTRUCTION CHANGE DOCUMENT (CCD) APPROVED BY DSA, AS REQUIRED BY SECTION 4-338, PART 1, TITLE 24 CCR.
- A "DSA CERTIFIED" PROJECT INSPECTOR EMPLOYED BY THE DISTRICT (OWNER) AND APPROVED BY DSA SHALL PROVIDE CONTINUOUS INSPECTION OF WORK. THE DUTIES OF THE INSPECTOR ARE DEFINED IN SECTION 4-342, PART 1, TITLE 24, CCR. INSPECTOR TO BE CLASS 2
- A DSA ACCEPTED TESTING LABORATORY DIRECTLY EMPLOYED BY THE DISTRICT (OWNER) SHALL CONDUCT ALL THE REQUIRED TESTS AND INSPECTIONS FOR THE PROJECT. THE REPORTS SHALL BE SUBMITTED TO ARCHITECT OF RECORD, STRUCTURAL ENGINEER OF RECORD, OWNER, INSPECTOR OR RECORD, AND THE DSA FIELD ENGINEER. THE REPORTS OF ANY FAILURES OF TESTS AND INSPECTIONS ARE TO BE SUBMITTED TO DSA DISTRICT
- STRUCTURAL ENGINEER. GRADING PLANS, DRAINAGE IMPROVEMENTS, ROAD AND ACCESS REQUIREMENTS AND ENVIRONMENTAL HEALTH CONSIDERATIONS SHALL COMPLY WITH ALL LOCAL ORDINANCES.
- 22 SAFETY DURING CONSTRUCTION SHALL COMPLY WITH CFC CHAPTER 33. 23. THE INTENT OF THESE DRAWINGS AND SPECIFICATIONS IS THAT THE WORK OF THE ALTERATION, REHABILITATION, OR RECONSTRUCTION IS TO BE IN ACCORDANCE WITH TITLE 24, CCR. SHOULD ANY EXISTING CONDITIONS SUCH AS DETERIORATION OR NON-COMPLYING CONSTRUCTION BE DISCOVERED WHICH IS NOT COVERED BY THE DSA APPROVED CONTRACT DOCUMENTS WHEREIN THE FINISHED WORK WILL NOT COMPLY WITH TITLE 24, CCR,, A CONSTRUCTION CHANGE DOCUMENT (CCD), OR A SEPARATE SET OF PLANS AND SPECIFICATIONS DETAILING AND SPECIFYING THE REQUIRED WORK SHALL BE SUBMITTED TO AND APPROVED BY DSA BEFORE PROCEEDING WITH THE WORK. (SECTION 4-317(C), PART 1, TITLE 24,
- NO DUMPING OR PLACING OF ANY DIRT OR DEBRIS SHALL BE ALLOWED OUTSIDE OF THE CONTRACTORS LIMIT OF WORK AREA.

\cdots THE CALIFORNIA ENERGY CODE SECTION 10-103 REQUIRES ACCEPTANCE TESTING ON ALL NEWLY INSTALLED LIGHTING CONTROLS, MECHANICAL SYSTEMS, ENVELOPES, AND PROCESS EQUIPMENT AFTER INSTALLATION AND BEFORE PROJECT COMPLETION. AN ACCEPTANC **TEST IS A FUNCTIONAL PERFORMANCE** TEST TO HELP ENSURE THAT NEWLY INSTALLED EQUIPMENT IS OPERATING A IN COMPLIENCE WITH THE ENERGY COD

- LIGHTING CONTROLS ACCEPTANCE TEST MUST BE PERFORMED BY A CERTIFIED LIGHTING CONTROLS ACCEPTANCE TEST TECHNICIAN (ATT) MECHANICAL SYSTEM ACCEPTANCE TES MUST BE PERFORMED BY A CERTIFIED
- MECHANICAL ATT FOR PROJECTS SUBMITTED ON OR AFTER OCTOBER 1 2021.
- ENVELOPE AND PROCESS EQUIPMENT ACCEPTANCE TESTS SHALL BE PERFORMED BY THE INSTALLING CONTRACTOR, ENGINEER/ ARCHITECT C RECORD OR THE OWNER'S AGENT.
- A LISTING OF CERTIFIED ATT CAN BE FOUND AT: https://www.energy.ca.gov/programs-andtopics/programs/acceptance-test-techniciancertification-provider-program/acceptance.
- THE ACCEPTANCE TESTING PROCEDUR MUST BE REPEATED, AND DEFICIENCIES MUST BE CORRECTED BY THE BUILDER INSTALLING CONTRACTOR UNTIL THE CONSTRUCTION/ INSTALLATION OF THE SPECIFIED SYSTEMS CONFORM AND PAS THE REQUIRED ACCEPTANCE CRITERIA.
- PROJECT INSPECTORS WILL COLLECT TH FORMS TO CONFIRM THAT THE REQUIRE ACCEPTANE TESTS HAVE BEEN COMPLETED. mmmmmmmmmmmmm

WALL FIRE RATING TYPE MATCHLINE REFERENCE X • Χ 🔍 LOCATION ON SHEET SHEET WHERE PLAN IS DRAWN KEYNOTE ?• - KEYNOTE NUMBER (SEE LEGEND ON SHEET) **ROOM EXITING INFORMATION** AREA (SQ FT) OFFICE OCCUPANT LOAD (AREA DIVIDED BY LOAD FACTOR) OCCUPANT LOAD FACTOR (REFER TO TABLE 1004.5) 2 EXIT(S) OCCUPANCY TYPE NUMBER OF EXITS REQUIRED (REFER TO TABLE 1006.2.1)

AS6A WALL TYPE MARK - SEE A10.11

— WALL STC RATING

WALL TYPE CALLOUT

- WIC CASEWORK TAG MANUFACTURER REFERENCE AND MODEL NUMBER
- LOCK CABINET DEPTH CABINET HEIGHT CABINET WIDTH

WO HI IVEL

- DISCIPLINE SHEET TYPE **BUILDING LETTER,** SEGMENT, 0 CODE ANALYSIS, NOTES G GENERAL (USER DEFINED) 1 SITE PLAN C CIVIL LANDSCAPE FLOOR PLAN USED ONLY IF REQUIRED. A ARCHITECTURE 3 CEILING PLAN IF NOT, COLUMN IS I INTERIORS 4 ROOF PLAN OMITTED. 5 EXTERIOR ELEVATIONS Q EQUIPMENT S STRUCTURAL 6 SECTIONS P PLUMBING 7 ENLARGED PLANS 8 INTERIOR ELEVATIONS M MECHANICAL E ELECTRICAL 9 SCHEDULES FA FIRE ALARM 10 DETAILS T TELECOM AV AV EQUIPMENT K KITCHEN DISCIPLINE SHEET TYPE SERIES / ORDER (IF APPLICABLE) FP FIRE PROTECTION
 - A A 1 . 1 1 A . A
 BULIDING LETTER
 FLOOR LEVEL OR
 SEGMENT

 (IF APPLICABLE)
 SEQUENTIAL
 (IF APPLICABLE)

CODES

2022	CALIFORNIA ADMINISTRATIVE CODE, PART 1,	NFPA 13	STANDARD FOR AUTOMATIC	2022 E
2022	TITLE 24 C.C.R. CALIFORNIA BUILDING CODE (CBC), PART 2,		FIRE SPRINKLER SYSTEMS (CA AMENDED)	
	TITLE 24 C.C.R.	NFPA 14	STANDARÓ FOR STANDPIPE	2019 E
	(2021 INTERNATIONAL BUILDING CODE VOLUMES 1 & 2 AND 2022 CALIFORNIA		AND HOSE SYSTEMS (CA AMENDED)	
2		NFPA 17	STANDARD FOR DRY	2021 E
	CALIFORNIA ELECTRICAL CODE (CEC), PART 3, TITLE 24 C.C.R.		CHEMICAL EXTINGUISHING SYSTEMS	
	(2020 NATIONAL ELECTRICAL CODE AND 2022	NFPA 17A	STANDARD FOR WET CHEMICAL	2021 E
	CALIFORNIA AMENDMENTS) CALIFORNIA MECHANICAL CODE (CMC) PART	NFPA 20	EXTINGUISHING SYSTEMS STANDARD FOR STATIONARY	2019 E
	4, TITLE 24 C.C.R.		PUMPS FOR FIRE PROTECTION	0040 5
	(2021 UNIFORM MECHANICAL CODE AND 2022 CALIFORNIA AMENDMENTS)	NFPA 22	STANDARD FOR WATER TANKS FOR PRIVATE FIRE PROTECTION	2018 E
	CALIFORNIA PLUMBING CODE (CPC), PART 5,	NFPA 24	STANDARD FOR THE	2019 E
	TITLE 24 C.C.R. (2021 UNIFORM PLUMBING CODE AND 2022		INSTALLATION OF PRIVATE FIRE MAINS AND THEIR	
	CALIFORNIA AMENDMENTS)		APPURTENANCES (CA AMENDED)	
	CALIFORNIA ENERGY CODE (CEC), PART 6, TITLE 24 C.C.R.	NFPA 72	NATIONAL FIRE ALARM & SIGNALING CODE (CA AMENDED)	2022 E
	CALIFORNIA FIRE CODE, PART 9, TITLE 24	NFPA 80	STANDARD FOR FIRE DOORS AND	2019 E
	C.C.R. (2021 INTERNATIONAL FIRE CODE AND 2022	NFPA 2001	OTHER OPENING PROTECTIVES STANDARD ON CLEAN AGENT	2018 E
			FIRE EXTINGUISHING SYSTEMS	
	CALIFORNIA EXISTING BUILDING CODE (CEBC), PART 10, TITLE 24 C.C.R.	UL 300	(CA AMENDED) STANDARD FOR FIRE TESTING OF	2005
	(2021 INTERNATIONAL EXISTING CODE AND 2022 CALIFORNIA AMENDMENTS)		FIRE EXTINGUISHING SYSTEMS FOR PROTECTION OF	(R2014
	CALIFORNIA AMENDIMENTS)		COMMERCIAL COOKING	
	CODE (CALGREEN), PART 11, TITLE 24 C.C.R. CALIFORNIA REFERENCED STANDARDS, PART	UL 464	EQUIPMENT AUDIBLE SIGNAL APPLIANCES	2003 E
	12,TITLE 24 C.C.R.	02 404	FOR FIRE ALARM AND SIGNALING	2003 L
	TITLE 19 C.C.R., PUBLIC SAFETY, STATE FIRE MARSHAL REGULATIONS.		SYSTEMS, INCLUDING ACCESSORIES	
	ASME A17.1/B44-19 SAFETY CODE FOR	UL 521	STANDARD FOR HEAT	1999 E
)	ELEVATORS AND ESCALATORS ASME 18.1 - SAFETY STANDARD FOR		DETECTORS FOR FIRE PROTECTIVE SIGNALING	(R2005
	PLATFORM LIFTS AND STAIRWAY CHAIR LIFTS		SYSTEMS	
		UL 1971	STANDARD FOR SIGNALING DEVICES FOR THE HEARING	2002 E (R2018
			IMPAIRED	·
		ICC 300	STANDARD FOR BLEACHERS, FOLDING AND TELESCOPING	2017 E
			SEATING AND GRANDSTANDS	
			LETE LIST OF APPLICABLE NFPA STANE 22 CBC (SFM) CHAPTER 35 AND CALIFO	
		CODE CHAPT	ER 80.	
			NIA BUILDING CODE, CHAPTER 35 FOR AMENDMENTS TO NFPA STANDARDS.	STATE
		CALIFORNIA	AMENDMENTS TO NEPA STANDARDS.	

HAVE BEEN PREPARED BY OTHER DESIGN PROFESSIONALS OR CONSULTANTS WHO ARE LICENSED AND/OR AUTHORIZED TO PREPARE SUCH DRAWINGS IN THIS STATE. IT HAS BEEN EXAMINED BY ME FOR:

DESIGN INTENT AND APPEARS TO MEET THE APPROPRIATE REQUIREMENTS OF TITLE 24, CALIFORNIA CODE OF REGULATIONS AND THE PROJECT SPECIFICATIONS PREPARED BY ME, AND COORDINATION WITH MY PLANS AND SPECIFICATIONS AND IS ACCEPTABLE FOR INCORPORATION INTO THE CONSTRUCTION OF THIS PROJECT.

THE STATEMENT OF GENERAL CONFORMANCE "SHALL NOT BE CONSTRUED AS RELIEVING ME OF MY RIGHTS. DUTIES, AND RESPONSIBILITIES UNDER SECTIONS 17302 AND 81138 OF THE EDUCATION CODE AND SECTIONS 4-336, 4-341 AND 4-344" OF TITLE 24, PART 1. (TITLE 24, PART 1, SECTION 4-317 (B)) I CERTIFY THAT:

ALL DRAWINGS OR SHEETS LISTED ON THE SHEET INDEX WITH AN (*) IS/ARE IN GENERAL CONFORMANCE WITH THE PROJECT DESIGN AND HAS/HAVE BEEN COORDINATED WITH THE PROJECT PLANS AND SPECIFICATIONS.

SIGNATURE ARCHITECT OR ENGINEER DESIGNATED TO BE IN GENERAL RESPONSIBLE CHARGE

PRINT NAME

C-25193 LICENSE NUMBER

07-31-2025 EXPIRATION DATE

ABBREVIATIONS

E)		FRP	FIBERGLASS REINFORCED PLASTIC	PTC	POST TENSIONED CONCRETE
	ANCHOR BOLT	FRT	FIRE RETARDANT TREATED	PTD	PAPER TOWEL DISPENSER
C PAVING	ASPHALTIC CONCRETE PAVING	FS	FINISH SURFACE	PTN	
		FTG	FOOTING	PTS	PNEUMATIC TUBE STATION /
		GB			SYSTEM
ACP		GFRC	GLASS FIBER REINFORCED	PVC	
ACT			CONCRETE	PVMT	
ADJ		GL	GLASS TYPE	QT	
AFF	ABOVE FINISH FLOOR	GLB GYP BD	GLUE LAMINATED BEAM	R	RADIUS, RISER
AGG	AGGREGATE		GYPSUM BOARD	RB	RESILIENT BASE
AHU		GYP PLAS		RD	
ARCH	ARCHITECTURAL	HB	HOSE BIBB	RECEPT	ECEPTACLE
	ATTENUATION	HD	HEAVY DUTY	REF	
AUTO	AUTOMATIC	HDR HDWR	HEADER	REFL	REFLECT(ED), (IVE)
3D BLCG	BOARD BLOCKING	HGT	HARDWARE HEIGHT	REFL REFR	REFLECT(ED), (IVE) REFRIGERATOR
BUR	BUILT UP ROOFING	HM	HOLLOW METAL	REINF	REINFORCE/REINFORCED/
CABT	CABINET	HP	HIGH POINT		REINFORCEMENT
CF	CUBIC FEET	HSS	HOLLOW STEEL SECTION	REM	REMOVE
	CONTRACTOR FURNISHED,	ID	INSIDE DIAMTER	RH	ROUND HEAD
	CONTRACTOR INSTALLED		INTERIOR	RHS	ROUND HEAD SCREW
	CONTRACTOR INSTALLED	INV	INVERT	RO	ROUGH OPENING
CFOI	CONTRACTOR FURNISHED,	LANDS	LANDSCAPE	ROW	RIGHT OF WAY
	OWNER INSTALLED	LANDS	LAVATORY	SCH	SCHEDULE (FOR PIPE)
CG	CORNER GUARD		LONG LEG HORIZONTAL	SCHED	SCHEDULE / SCHEDULING
Cl	CONTROL JOINT		LONG LEG VERTICAL	SD	STORM DRAIN / SOAP DISPENSE
CL	CENTER LINE		LOW POINT	SECT	SECTION
CLF	CHAIN LINK FENCE		LIGHT WEIGHT	SG	SAFETY GLASS
	CLEAR		LOUVER	SHT	SHEET
	CONCRETE MASONRY UNIT	MACH	MACHINE	SHTG	SHEATHING
	CLEANOUT	MB	MACHINE BOLT	SMS	SHEATTING SHEET METAL SCREW
COL	COLUMN	MDF	MEDIUM DENSITY FIBERBOARD	SND	SANITARY NAPKIN DISPOSAL
COMP	COMPRESSION / COMPOSITE	MDO	MEDIUM DENSITY OVERLAY	SOV	SHUT OFF VALVE
CF	CUBIC FEET	MECH	MECHANICAL	SPEC	SPECIFICATIONS
COORD	COORDINATE	MED	MEDIUM	SS	STAINLESS STEEL
CORR	CORRUGATED	MEMB	MEMBRANE	STC	SOUND TRAMISSION CLASS
CT	CERAMIC TILE	MFR	MANUFACTURER	STL	STEEL
CTSK	COUNTER SKUNK	MH	MANHOLE	STSMS	SELF TAPPING SHEET METAL
CW	CURTAINWALL	MO	MANNOLL MASONRY OPENING	SCREW	SEEL TAIT ING SHEET METAL
DEPR	DEPRESSED / DEPRESSION	MTD	MOUNTED	SUSP	SUSPENDED
DF	DRINKING FOUNTAIN	MTL	METAL	SV	SHEET VINYL
DIM	DIMENSION	NIC	NOT IN CONTRACT	SYM	SYMMETRICAL
DISP	DISPENSER	NR	NON RATED	T	TREAD
DS	DOWNSPOUT	NRC	NOISE REDUCTION COEFFICIENT	T&B	TOP AND BOTTOM
DTL	DETAIL	NTS	NOT TO SCALE	TO	TOP OF
DW W	DISHWASHER	0/	OVER	TOC	TOP OF CURB / CONCRETE
E/W	EACH WAY	O/A	OVERALL	TOP	TOP OF PARAPET
EIFS	EXTERIOR INSULATION FINISH	OC	ON CENTER	TOS	TOP OF STEEL
SYSTEM		OD	OUTSIDE DIAMTER	TOW	TOP OF WALL
ΞJ	EXPANSION JOINT	OFCI	OWNER FURNISHED, CONTRACTOR	TPD	TOILET PAPER DISPENSER
ELEC	ELECTRICAL		INSTALLED	TS	TACKABLE SURFACE
ELEV	ELEVATION / ELEVATOR	OFOI	OWNER FURNISHED, OWNER	U/C	UNDER CABINET (OR COUNTER
ENCL	ENCLOSE / ENCLOSURE		INSTALLED	UNO	UNLESS NOTED OTHERWISE
		OFVI	OWNER FURNISHED, VENDOR	UR	URINAL
EOS	EDGE OF SLAB		INSTALLED	VAC	VACUUM
ΞP	ELECTRICAL PANEL	ОН	OPPOSITE HAND	VB	VAPOR BARRIER
EQ	EQUAL	OPER	OPERABLE	VCT	VINYL COMPOSITION TILE
ESC	EXCUTCHEON	OPNG	OPENING	VIF	VERIFY IN FIELD
EWC	ELECTRIC WATER COOLER	ORD	OVERFLOW ROOF DRAIN	VTR	VENT THROUGH ROOF
EXP	EXPOSED	P/L	PROPERTY LINE	VWC	VINYL WALL COVERING
=A	FIRE ALARM	PA	PUBLIC ADDRESS	W/	WITH
FD	FLOOR DRAIN	PAF	POWDER ACTUATED FASTENER	W/O	WITHOUT
=DC	FIRE DEPARTMENT CONNECTION		PAVING	WB	WOOD BASE
E	FIRE EXTINGUISHER	PCC	PORTLAND CEMENT CONCRETE	wc	WATER CLOSET
EC	FIRE EXTINGUISHER W/ CABINET		PAVING	WD	WOOD
F	FINISH FLOOR	PED	PEDESTRIAN	WDW	WINDOW
- =G	FINISH GRADE	PERF	PERFORATED	WGT	WEIGHT
ΞH	FIRE HYDRANT	PERIM	PERIMETER	WH WH	WATER HEATER
-HC	FIRE HOSE CABINET	PERP	PERPENDICULAR	WP	WATERPROOFING/WALL
-SH	FLAT HEAD SCREW	PH	PANIC HARDWARE		PROTECTION
FIN	FINISH	PIV	POST INDICATOR VALVE	WR	WATER RESISTANT
FLR	FLOOR	PL	PLATE	WRGB	WATER RESISTANT GYPSUM
FOC	FACE OF CONCRETE	PLAM	PLASTIC LAMINATE		BOARD
FOF	FACE OF FINISH	PLAS	PLASTER	ws	WOOD SCREW
=OM	FACE OF MASONRY	PLUMB	PLUMBING	WSCT	WAINSCOT
=OS	FACE OF STUD	PNL	PANEL	WWF	WELDED WIRE FABRIC
-P	FIREPROOFING	PNT	PAINT / PAINTED		
- R	FIRE RATED	POC	POINT OF CONNECTION	NOTE:	
-RG	FIRE RATED GLASS	POLY ISO	POLYISOCYANURATE		BREVIATIONS USED ON THESE
		PREFIN	PREFINISHED		ARE CONSIDERED STANDARDS IN
		PREP	PREP / PREPARATION		NG INDUSTRY. CONTACT ARCHITEC


PROJECT DESCRIPTION

MODERNIZATION OF THE CAMPUS INCLUDING REPLACEMENT OF PLAYGROUND STRUCTURE FOR TK-K AND HIGHER-GRADE PLAYGROUNDS, COMPLETE HARDCOURT RESURFACING AND STRIPING, PLAYFIELDS RENOVATION WITH RUNNING TRACK, CLASSROOM SIGNAGE UPGRADE PACKAGE, ADA ACCESSIBILITY UPGRADES FOR THE CLASSROOM PATH OF TRAVEL, HVAC REPLACEMENT, ELECTRIFICATION OF KITCHEN WITH MINOR MODERNIZATION, CAMPUS WIDE EXTERIOR PAINTING, INTERIOR PAINTING, AND FLOORING UPGRADES

KINDER SHADE STRUCTURE 900 SF P.C. 04-121917 UPPER GRADE SHADE STRUCTURE 1600 SF P.C. 04-121917


DEFERRED ITEMS


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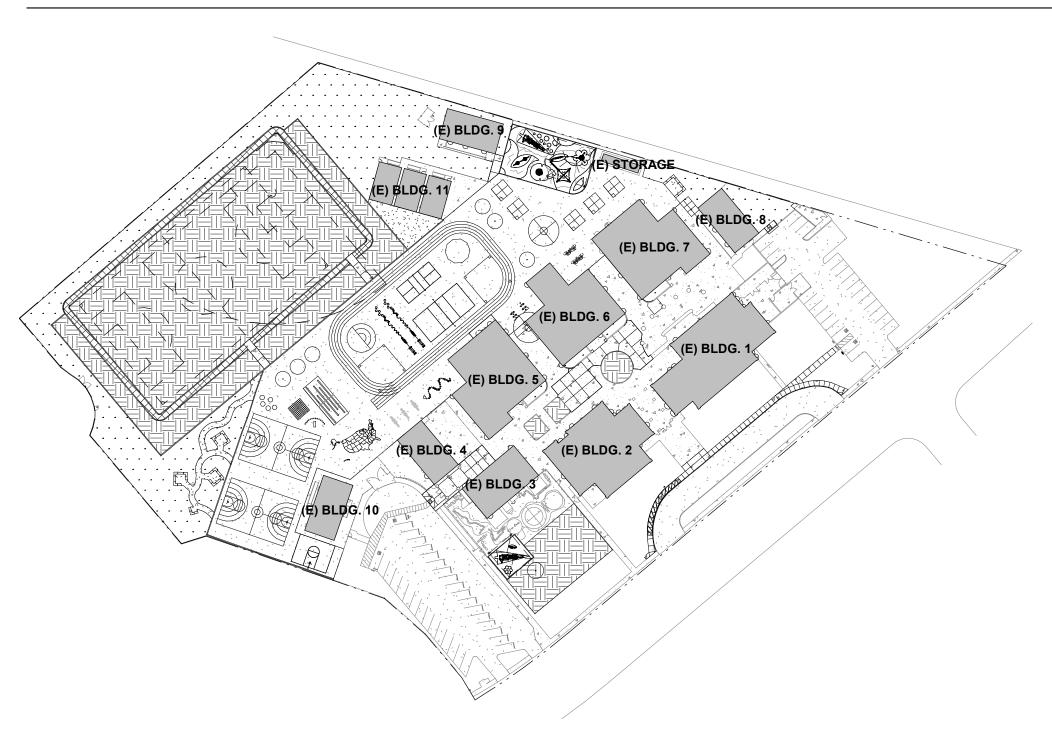


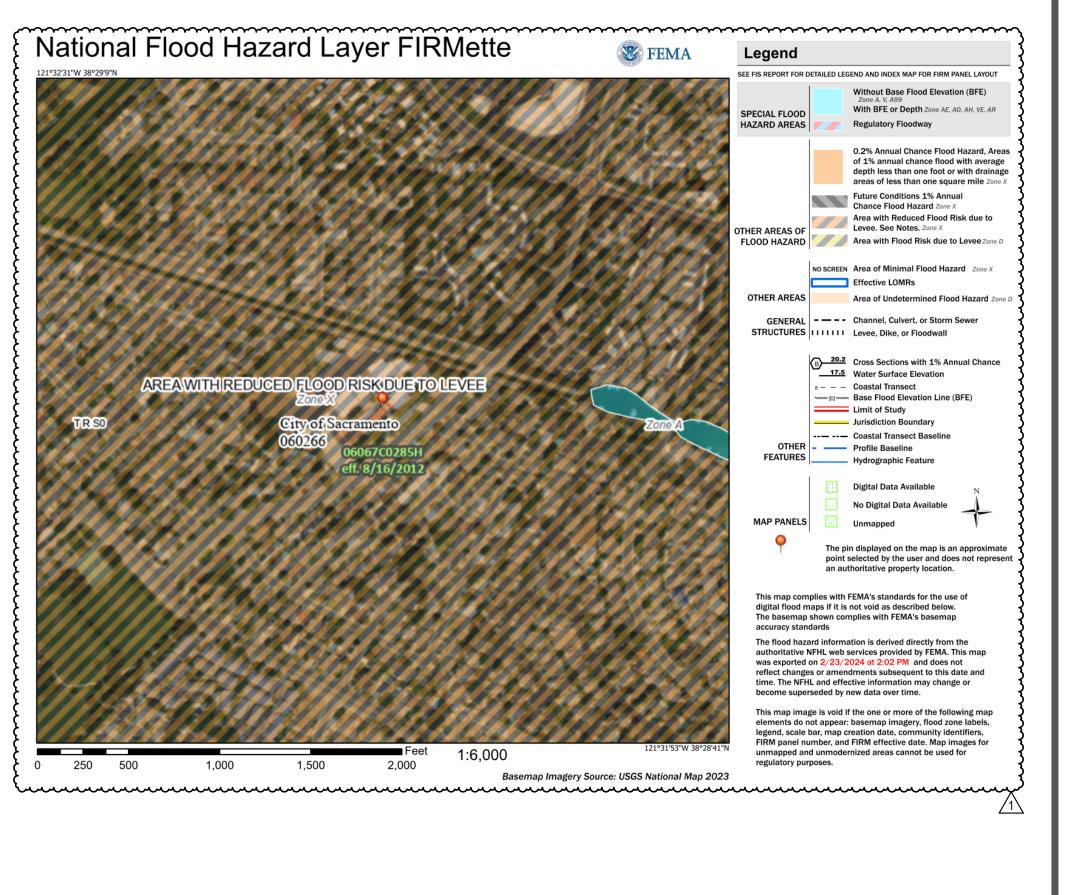STATE MAP

VICINITY MAP



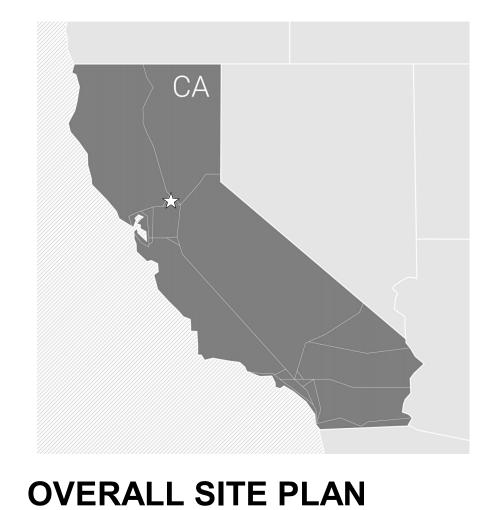

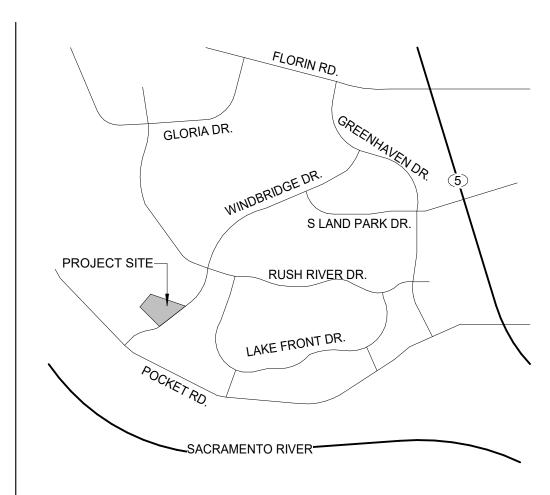

3186-070-000

ISSUE **DESCRIPTION**

1 ADDENDUM #1

FACILITY: MATSUYAMA ELEMENTARY SCHOOL 7680 WINDBRIDGE DRIVE SACRAMENTO, CA 95831

PROJECT:

SHEET NAME: **PROJECT DATA SHEET**



DATE: 01/04/2024 SHEET:

PLEASE RECYCLE



CLIENT PROJ NO: 3186-070-000

MATSUYAMA ELEMENTARY SCHOOL MODERNIZATION



DATE

03/01/2024

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NUMBER	NAME
GENERAL SH G0.10	IEET COVER SHEET
G0.13	PROJECT DATA SHEET SHEET INDEX
G1.11 4	CODE SITE PLAN
CIVIL C0.1	CIVIL GENERAL NOTES AND ABBREVIATIONS
C0.3	PARTIAL TOPOGRAPHIC SURVEY PARTIAL TOPOGRAPHIC SURVEY
C1.2	PARTIAL DEMOLITION PLAN PARTIAL DEMOLITION PLAN
-	ENGINEERED FILL PLAN PARTIAL GRADING PLAN PARTIAL GRADING PLAN
C3.1	UTILITY PLAN PAVING PLAN
C5.1 11	DETAILS
LANDSCAPE LD1.1	TREE PROTECTION PLAN
	TREE PROTECTION PLAN IRRIGATION DEMOLITION PLAN
LD2.2 L1.1	IRRIGATION DEMOLITION PLAN TREE PLANTING PLAN
L2.2	SHRUB/TURF PLANTING PLAN SHRUB/TURF PLANTING PLAN
	LANDSCAPE IRRIGATION PLAN LANDSCAPE IRRIGATION PLAN LANDSCAPE PLANTING DETAIL
L4.2 L4.3	LANDSCAPE IRRIGATION DETAIL LANDSCAPE IRRIGATION DETAIL
L5.1 13	IRRIGATION CHARTS AND SHADING CALCULATION
ARCHITECTU A1.01	IRE SITE DEMOLITION PLAN
A1.01 A1.11 A1.22	PROJECT SITE PLAN PARTIAL SITE PLAN SEGMENT - 1
A1.23 A1.31	PARTIAL SITE PLAN SEGMENT - 2 ENLARGED SITE PLAN
A2.11	DEMOLITION AND IMPROVEMENT FLOOR PLANS - BLDG 1 DEMOLITION AND IMPROVEMENT FLOOP PLANS
A2.12 A2.13	DEMOLITION AND IMPROVEMENT FLOOR PLANS - BLDG 2 DEMOLITION AND IMPROVEMEMTN FLOOR PLANS -
A2.14	BLDG 3,4 DEMOLITION AND IMPROVEMENT FLOOR PLANS - BLDG 5,6
A2.15	DEMOLITION AND IMPROVEMENT FLOOR PLANS - BLDG 7,8
A2.16	DEMOLITION AND IMPROVEMENT FLOOR PLANS - BLDG 9,11
A3.11 A3.12 A4.11A	DEMOLITION REFLECTED CEILING PLAN - BLDG 1,2 IMPROVEMENT REFLECTED CEILING PLAN - BLDG 1,2 ROOF PLAN - BLDG 1,2,3
A4.11B A5.11	ROOF PLAN - BLDG 5,7 EXTERIOR ELEVATIONS
A5.12 A5.13	EXTERIOR ELEVATIONS EXTERIOR ELEVATIONS
A5.14 A5.15 A7.11	EXTERIOR ELEVATIONS EXTERIOR ELEVATIONS ENLARGED PLANS
A8.11 A8.12	INTERIOR ELEVATIONS INTERIOR ELEVATIONS
A8.13 A8.14	INTERIOR ELEVATIONS INTERIOR ELEVATIONS
A8.15 A9.12	INTERIOR IMAGES FINISH SCHEDULE
A10.01 A10.02 A10.03	SITE DETAILS - MISC SITE DETAILS - MISC INTERIOR DETAILS
A10.04 31	SIGNAGE DETAILS
STRUCTURA	
S0.01 S2.01 S4.01	TYPICAL STRUCTURAL NOTES STRUCTURAL PLAN - BUILDING 1 DETAILS
	DETAILS
MECHANICAL	_
M0.01 M0.02 M1.11	MECHANICAL LEGEND AND NOTES MECHANICAL SCHEDULES MECHANICAL SITE PLAN
M2.11	MECHANICAL DEMOLITION AND IMPROVEMENT FLOOR PLANS - BLDG 1
M2.12	MECHANICAL DEMOLITION AND IMPROVEMENT FLOOR PLANS - BLDG 2
M2.13 M2.14	MECHANICAL DEMOLITION AND IMPROVEMENT FLOOR PLANS - BLDG 3, 4 MECHANICAL DEMOLITION AND IMPROVEMENT
M2.15	FLOOR PLANS - BLDG 5, 6 MECHANICAL DEMOLITION AND IMPROVEMENT FLOOR PLANS - BLDG 7, 8
M2.16	MECHANICAL DEMOLITION AND IMPROVEMENT FLOOR PLANS - BLDG 9, 11
M2.17	MECHANICAL DEMOLITION AND IMPROVEMENT FLOOR PLANS - BLDG 10
M4.11 M4.12	MECHANICAL DEMOLITION AND IMPROVEMENT ROOF PLANS - BLDG 1 MECHANICAL DEMOLITION AND IMPROVEMENT ROOF
M4.13	PLANS - BLDG 2 MECHANICAL DEMOLITION AND IMPROVEMENT ROOF
M4.14	PLANS - BLDG 3, 4 MECHANICAL DEMOLITION AND IMPROVEMENT ROOF PLANS - BLDG 5, 6
M4.15	MECHANICAL DEMOLITION AND IMPROVEMENT ROOF PLANS - BLDG 7, 8
M5.11 M6.01	MECHANICAL ENLARGED FLOOR PLANS - BLDG 1 KITCHEN MECHANICAL KITCHEN EQUIPMENT DRAWINGS
M6.02 M7.01	MECHANICAL KITCHEN EQUIPMENT DRAWINGS MECHANICAL KITCHEN EQUIPMENT DRAWINGS MECHANICAL CONTROLS
M7.02 M7.03	MECHANICAL CONTROLS MECHANICAL CONTROLS
M8.01 M8.02	MECHANICAL DETAILS MECHANICAL DETAILS
23	

NUMBER NAME

12

PLUMBING	
P0.01	PLUMBING LEGEND AND NOTES
P0.02	PLUMBING SCHEDULES
P1.11	PLUMBING SITE PLAN
P2.11	PLUMBING DEMOLITION AND IMPROVEMENT FLOOR PLANS - BLDG 1
P2.12	PLUMBING DEMOLITION AND IMPROVEMENT FLOOR PLANS - BLDG 2
P2.14	PLUMBING DEMOLITION AND IMPROVEMENT FLOOR PLANS - BLDG 5, 6
P2.15	PLUMBING DEMOLITION AND IMPROVEMENT FLOOR PLANS - BLDG 7, 8
P2.16	PLUMBING DEMOLITION AND IMPROVEMENT FLOOR PLANS - BLDG 9, 11
P2.17	PLUMBING DEMOLITION AND IMPROVEMENT FLOOR PLANS - BLDG 10
P4.11	PLUMBING DEMOLITION AND IMPROVEMENT ROOF PLANS - BLDG 1
P5.11	PLUMBING ENLARGED FLOOR PLANS - BLDG 1 KITCHEN
P8.01	PLUMBING DETAILS

ELECTRICAL	
E0.01	ELECTRICAL NOTES
E0.02	ELECTRICAL LEGENDS
E1.11	ELECTRICAL SITE PLAN
E1.12	ELECTRICAL ENLARGED SITE PLAN
E1.13	ELECTRICAL LIGHTING SITE PLAN
E1.14	ELECTRICAL PHOTOMETRIC SITE PLAN
E2.11	ELECTRICAL DEMOLITION AND IMPROVEMENT FLOOR PLANS - BLDG 1
E2.12	ELECTRICAL DEMOLITION AND IMPROVEMENT FLOOR PLANS - BLDG 2
E2.13	ELECTRICAL DEMOLITION AND IMPROVEMENT FLOOR PLANS - BLDG 4
E2.14	ELECTRICAL DEMOLITION AND IMPROVEMENT FLOOR PLANS - BLDG 8
E2.15	ELECTRICAL DEMOLITION AND IMPROVEMENT FLOOR PLANS - BLDGS 9, 11
E2.16	ELECTRICAL DEMOLITION AND IMPROVEMENT FLOOR PLANS - BLDG 10
E4.11	ELECTRICAL DEMOLITION AND IMPROVEMENT ROOF PLANS - BLDG 1
E4.12	ELECTRICAL DEMOLITION AND IMPROVEMENT ROOF PLANS - BLDG 2
E4.13	ELECTRICAL DEMOLITION AND IMPROVEMENT ROOF PLANS - BLDG 5
E4.14	ELECTRICAL DEMOLITION AND IMPROVEMENT ROOF PLANS - BLDG 7
E5.11	ELECTRICAL ENLARGED FLOOR PLANS - BLDG 1 KITCHEN
E6.01	ELECTRICAL ONE-LINE DIAGRAM
E7.01	ELECTRICAL FIXTURE AND PANEL SCHEDULES
E8.01	ELECTRICAL DETAILS
E8.02	ELECTRICAL DETAILS
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TITLE 24	
T24.01	TITLE 24 COMPLIANCE - BUILDING 8
T24.02	TITLE 24 COMPLIANCE - BUILDING 8
T24.03	TITLE 24 COMPLIANCE - BUILDING 9
T24.04	TITLE 24 COMPLIANCE - BUILDING 9
T24.05	TITLE 24 COMPLIANCE - BUILDING 10
T24.06	TITLE 24 COMPLIANCE - BUILDING 10
T24.07	TITLE 24 COMPLIANCE - BUILDING 11
T24.08	TITLE 24 COMPLIANCE - BUILDING 11
T24.09	TITLE 24 COMPLIANCE - KITCHEN
T24.10	TITLE 24 COMPLIANCE - KITCHEN
T24.11	TITLE 24 COMPLIANCE - ELECTRICAL BUILDING 2 AND SITE LIGHTING
T24.12	TITLE 24 COMPLIANCE - ELECTRICAL BUILDING 2 AND SITE LIGHTING
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FOOD SE	RVICE
FS1.1	FOOD SERVICE EQUIPMENT FLOOR PLAN
FS2.1	FOOD SERVICE EQUIPMENT PLUMBING PLAN
FS3.1	FOOD SERVICE EQUIPMENT ELECTRICAL PLAN
FS4.1	FOOD SERVICE EQUIPMENT MECHANICAL PLAN
FS5.1	FOOD SERVICE EQUIPMENT EXHAUST HOOD DETAILS
FS5.2	FOOD SERVICE EQUIPMENT EXHAUST HOOD DETAILS
FS5.3	FOOD SERVICE EQUIPMENT EXHAUST HOOD DETAILS
FS8.1	FOOD SERVICE EQUIPMENT ANCHORAGE DETAILS
FS8.2	FOOD SERVICE EQUIPMENT ANCHORAGE DETAILS
FS8.3	FOOD SERVICE EQUIPMENT ANCHORAGE DETAILS
FS9.1	FOOD SERVICE EQUIPMENT ELEVATIONS
11	

USA SHADE STRUCTURE - P.C. 04-121917 P.C.T-1.0 P.C. TITLE SHEET P.C.T-2.0 P.C. UNIT SELECTION P.C.T-3.0 P.C. T & I FORMS P.C.2.1-1000 P.C. DSA3013030-22 P.C.2.2-2000 P.C. DSA4013030-22 P.C.4.1-1000 P.C.4014040-22 P.C.4.2-2000 P.C. DSA4014040-22

7 Grand total: 149 ×

3186-070-000

ISSUE Δ **DESCRIPTION** 1 ADDENDUM #1

KEYNOTES

NOTES

FACILITY: MATSUYAMA ELEMENTARY SCHOOL 7680 WINDBRIDGE DRIVE SACRAMENTO, CA 95831

PROJECT: MATSUYAMA ELEMENTARY SCHOOL MODERNIZATION

SHEET NAME: SHEET INDEX



DATE: 01/04/2024 SHEET:




CLIENT PROJ NO: 3186-070-000





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OCC. TYPE	CONST. TYPE	ACTUAL BUILDING (SF)	SPRINKLER SYSTEM	{ALLOWABLE S1 (SF)	ALLOWABLE S1 W/ AREA INCREASE (SF)	ACTUAL OVERHANG (SF)	ALLOWABLE BUILDING HEIGHT	ACTUAL BUILDING HEIGHT	NUMBER OF STORIES
А	V-B	7,860	NO	<u>}</u> -	-	-	-	-	-
E	V-B	6,735	NO	-	-	-	-	-	-
E	V-B	2,800	NO	-	-	-	-	-	-
E	V-B	1,920	NO	-	-	-	-	-	-
E	V-B	6,492	NO	-	-	-	-	-	-
E	V-B	6,000	NO }	-	-	-	-	-	-
E	V-B	6,492	NO }	-	-	-	-	-	-
E	V-B	1,920	NO	-	-	-	-	-	-
E	V-B	1,920	NO	-	-	-	-	-	-
E	V-B	1,920	NO È	-	-	-	-	-	-
E	V-B	2,840	NO	-	-	-	-	-	-
A-3	V-B	900	NO	6,000	N/A	N/A	40'-0"	15'-0"	1
A-3	V-B	1,600	NO	6,000	N/A	N/A	40'-0"	15'-0"	1
	OCC. TYPE A E E E E E E E E E E E E A-3	OCC. TYPECONST. TYPEAV-BEV-BEV-BEV-BEV-BEV-BEV-BEV-BEV-BEV-BEV-BEV-BEV-BEV-B	OCC. TYPE CONST. TYPE ACTUAL BUILDING (SF) A V-B 7,860 E V-B 6,735 E V-B 2,800 E V-B 1,920 E V-B 6,492 E V-B 6,492 E V-B 6,492 E V-B 1,920 E V-B 2,840 C A-3 V-B 900	OCC. TYPECONST. TYPEACTUAL BUILDING (SF)SPRINKLER SYSTEMAV-B7,860NOEV-B6,735NOEV-B2,800NOEV-B1,920NOEV-B6,492NOEV-B6,492NOEV-B6,492NOEV-B1,920NOEV-B1,920NOEV-B1,920NOEV-B1,920NOEV-B1,920NOEV-B2,840NOCV-B2,840NOCV-B2,840NO	OCC. TYPE CONST. TYPE ACTUAL BUILDING (SF) SPRINKLER SYSTEM ALLOWABLE S1 (SF) A V-B 7,860 NO - E V-B 6,735 NO - E V-B 2,800 NO - E V-B 1,920 NO - E V-B 6,492 NO - E V-B 6,492 NO - E V-B 6,492 NO - E V-B 1,920 NO - E V-B 2,840 NO - E V-B 900 NO 6,000	OCC. TYPECONST. TYPEACTUAL BUILDING (SF)SPRINKLER SYSTEMALLOWABLE S1 (SF)ALLOWABLE S1 (W) AREA INCREASE (SF)AV-B7,860NOEV-B6,735NOEV-B2,800NOEV-B1,920NOEV-B6,492NOEV-B6,492NOEV-B6,492NOEV-B1,920NOEV-B1,920NOEV-B1,920NOEV-B1,920NOEV-B1,920NOEV-B900NO	OCC.TYPECONST.TYPEACTUAL BUILDING (SF)SPRINKLER SYSTEMALLOWABLE S1 (SF)ALLOWABLE S1 (SF)ACTUAL OVERHANG (SF)AV-B7,860NOEV-B6,735NOEV-B2,800NOEV-B1,920NOEV-B6,492NOEV-B6,000NOEV-B6,492NOEV-B1,920NOEV-B1,920NOEV-B1,920NOEV-B1,920NOEV-B1,920NOEV-B2,840NOEN-B2,840NOEN-B2,840NOEN-B2,840NOEN-B2,840NOEN-B2,840NOEN-B2,840NOEN-B2,840NOEN-B2,840NOEN-B2,840NO<	OCC. TYPECONST. TYPEACTUAL BUILDING (SP)SPRINKLER SYSTEMALLOWABLE S1 (SF)ACTUAL OVERHANGALLOWABLE BUILDINGAV-B7,860NOEV-B6,735NOEV-B2,800NOEV-B1,920NOEV-B6,492NOEV-B6,492NOEV-B6,492NOEV-B6,492NOEV-B1,920NOEV-B1,920NOEV-B1,920NOEV-B1,920NOEV-B1,920NOEV-B1,920NOEV-B2,840NOEN-B2,840NOEA-B2,840NOEA-B2,840NOEA-B2,840NOCEN-B2,840NOEA-B2,840NO-	OCC. TYPECONST. TYPEACTUAL BUILDING (SF)SPRINKLER SYSTEMALLOWABLE S1 (SF)ALLOWABLE S1 (SF)ACTUAL OVERHANGALLOWABLE BUILDINGACTUAL BUILDINGAV-B7,860NOEV-B6,735NOEV-B2,800NOEV-B1,920NOEV-B6,492NOEV-B6,492NOEV-B6,492NOEV-B1,920NO </td



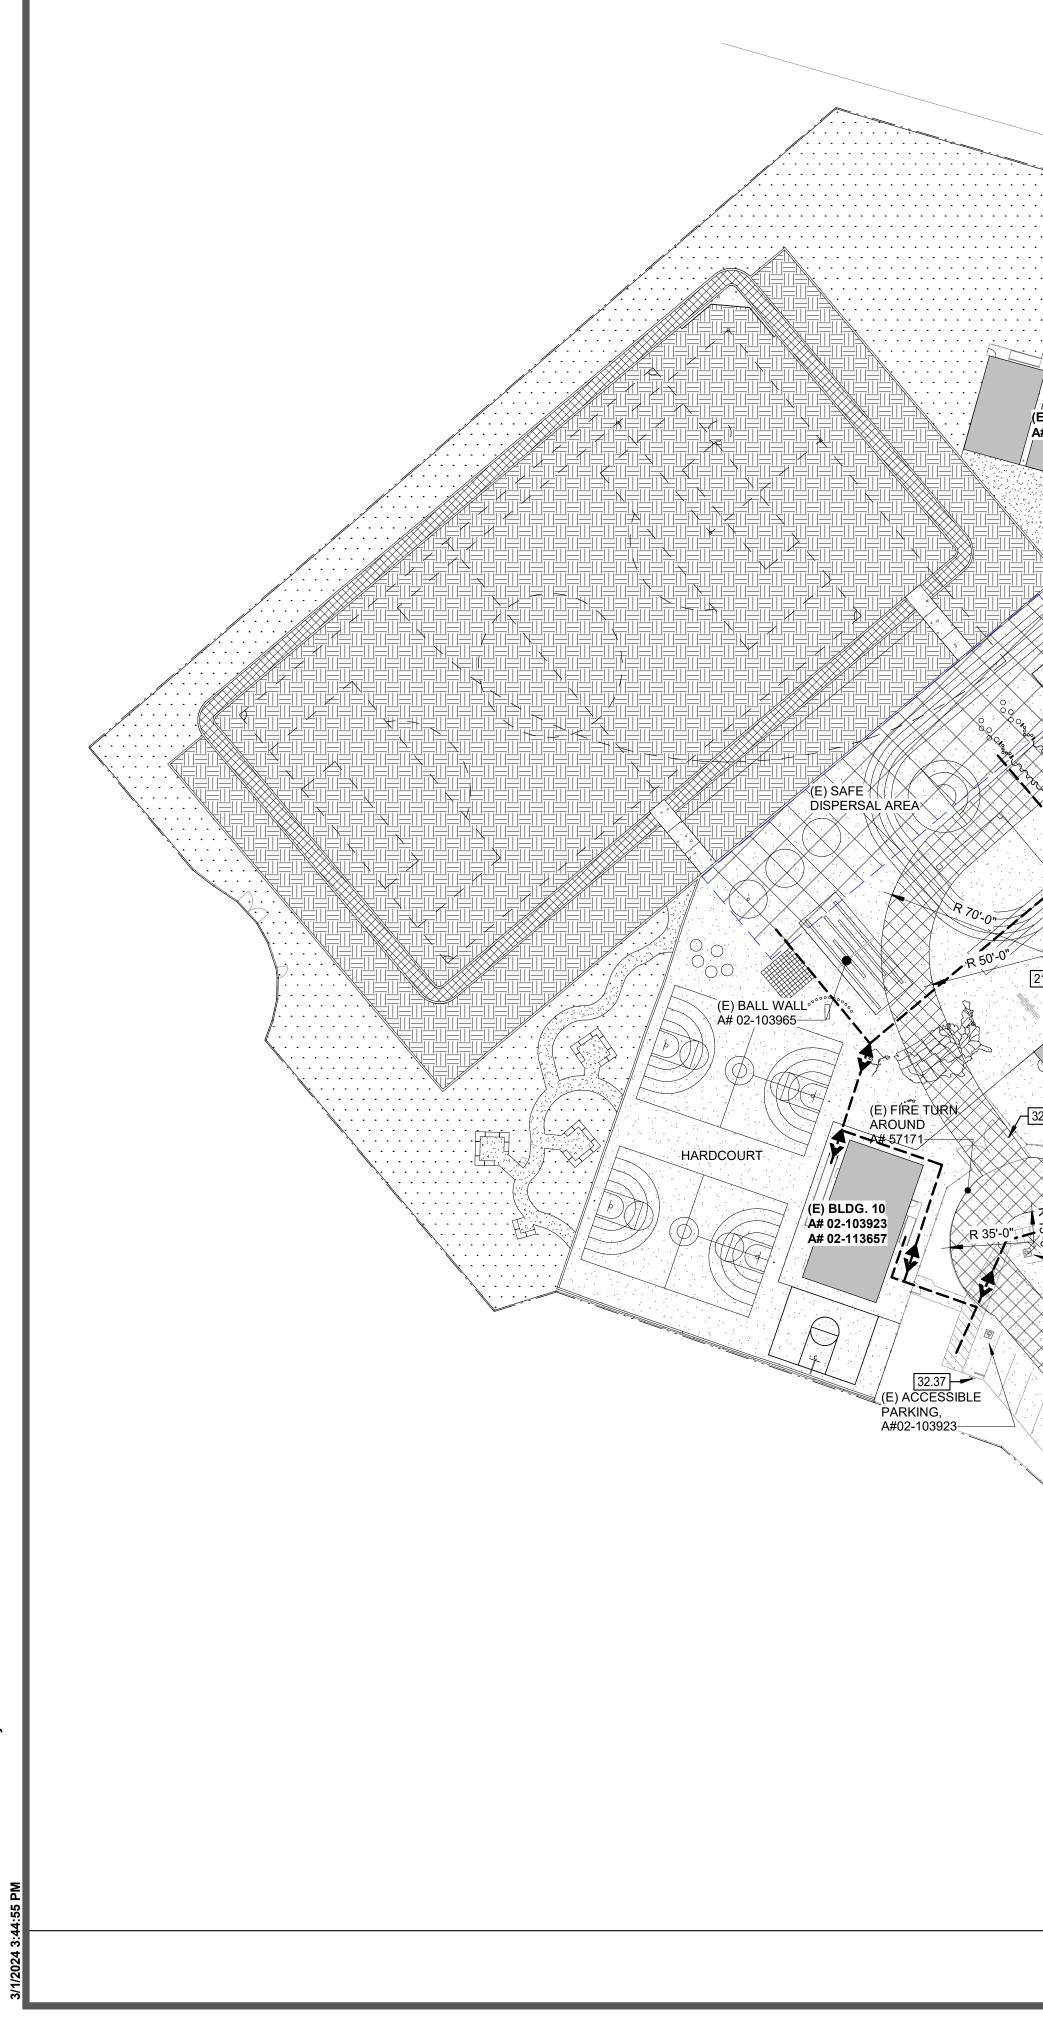

(E) ACCESSIBLE PARKING ST

LOT A TOTAL PARKING STALL COUNT: 33 STALLS ACCESSIBLE PARKING STALLS REQUIRED ACCESSIBLE STALLS: 2 STANDARD (26-50 TOT. REQUIRED VAN ACCESSIBLE STALLS: 1 VAN (1-6 ACCESSIBLE

ACCESSIBLE STALLS PROVIDED: 1 STANDARD AND 1 VAN



STALL CA	LCULATION (TABLE		∢≽	ACCESSIBLE PATH OF TRAVEL / PATH OF TRAVEL TO PUBLIC WAY	
	TOTAL PARKING STALL COUNT: ACCESSIBLE PARKING STALLS	26 STALLS		ASSUMED PROPERTY LINE	
TAL STALLS) E STALLS)	REQUIRED ACCESSIBLE STALLS: REQUIRED VAN ACCESSIBLE STALLS:			EXISTING BUILDINGS IN SCOPE OF WORK	
Ν	ACCESSIBLE STALLS PROVIDED:	1 STANDARD AND 1 VAN		EXISTING ACCESSIBLE RESTROOMS	
				SAFE DISPERSAL AREA	Sa
			Pa	= EXISTING PARKING LOT	UNI
			в	= EXISTING BOYS RESTROOM	
			G	= EXISTING GIRLS RESTROOM	
			U	= EXISTING UNISEX RESTROOM	HMC Arc
			DF	= EXISTING DRINKING FOUNTAIN	3186-070-00
				CONCRETE PAVEMENT	2101 CAPITOL AVENUE, SACRAMENTO, CA, 958 916 368 7990 / www.hmca
			$ \begin{array}{c} \sum_{i=1}^{N} \sum_{j=1}^{N} \sum_{j=1}^{N} \sum_{j=1}^{N} \sum_{i=1}^{N} \sum_{j=1}^{N} \sum_{j=1}^{N} \sum_{j=1}^{N} \sum_{i=1}^{N} \sum_{j=1}^{N} \sum_{j=1}^{N} \sum_{j=1}^{N} \sum_{i=1}^{N} \sum_{j=1}^{N} \sum_{j=1}^{N$	ASPHALT	A DESCRIPTION 1 ADDENDUM #1
				PLANTING, SEE LANDSCAPE DWGS	
				GRASS, SEE LANDSCAPE DWGS	
				DECOMPOSED GRANITE, SEE LANDSCAPE DWGS	
				SYNTHETIC RUBBERIZED RUNNING TRACK, SEE CIVIL DWGS	KEYNOTES
				PAINTED FIRE LANE NO PARKING LINE 'FIRE LANE -NO PARKING' SEE DETAILS 12 / A10.01 AND 13 / A10.01	32.18 (E) ACC 32.21 DROP 32.23 (E) KNO 32.35 (E) PAF 32.37 (E) VAN
RN AROUND			{	EXISTING CHAIN LINK FENCE	
				EXISTING DECORATIVE METAL FENCE	
		/			
(E) ACCESSIBL PARKING, A#57171	E				
					NOTES
32.35					
21.01				RAVEL STATEMENT	
			FREE ACCESS ROU CHANGES EXCEEDII SLOPE EXCEPT LEV	TE WITHOUT ANY ABRUPT VERTICAL NG 1/2" BEVELED AT 1:2 MAXIMUM 'EL CHANGES THAT DO NOT EXCEED	
			WITH SLIP RESISTAI SMOOTH. CROSS-SI	PATH OF TRAVEL IS AT LEAST 48" WIDE NT SURFACE, STABLE, FIRM AND LOPE DOES NOT EXCEED 2% AND CTION OF TRAVEL IS LESS THAN 5%	
			UNLESS OTHERWIS SHALL BE MAINTAIN OBSTRUCTION TO 8	E INDICATED. THE PATH OF TRAVEL IED FREE OF OVERHANGING 30" A.F.F. MINIMUM AND WALL	
			27" AND 80" A.F.F. M WITH THE BOTTOM	S WITH THE BOTTOM EDGE BETWEEN INIMUM AND WALL MOUNTED OBJECTS EDGE BETWEEN 27" AND 80" A.F.F. NO MORE THAN 4" INTO THE	
			THAT ALL BARRIERS REMOVED OR WILL	ILATION AREA. ARCHITECT TO VERIFY S IN THE PATH OF TRAVEL HAVE BEEN BE REMOVED UNDER PROJECT, AND OMPLIES WITH CBC 1133B.	
			DESIGN PROFESSIC CHARGE STATEMEN	ONAL IN GENERAL RESPONSIBLE	
			DOCUMENTS IS COM APPLICABLE CALIFC	ED IN THESE CONSTRUCTION MPLIANT WITH THE CURRENT ORNIA BUILDING CODE ACCESSIBILITY ATH OF TRAVEL REQUIREMENTS FOR	
			AS PART OF THE DE WAS EXAMINED AND	DITIONS AND STRUCTURAL REPAIRS. SIGN OF THIS PROJECT, THE P.O.T. D ANY ELEMENTS, COMPONENTS OR	
			NONCOMPLIANT 1) I CORRECTIVE WORK	P.O.T. THAT WERE DETERMINED TO BE HAVE BEEN IDENTIFIED AND 2) THE < NECESSARY TO BRING THEM INTO BEEN INCLUDED WITHIN THE SCOPE	
			OF THIS PROJECT'S DRAWINGS, AND SP THESE CONSTRUCT	WORK THROUGH DETAILS, PECIFICATIONS INCORPORATED INTO FION DOCUMENTS. ANY EMENTS, COMPONENTS, OR PORTIONS	
			OF THE P.O.T. THAT BY THIS PROJECT B LIMITATIONS OR A F	WILL NOT BE CORRECTED ASED ON VIOLATION OF THRESHOLD INDING OF UNREASONABLE HARDSHIP	FACILITY:
			ARE SO INDICATED DOCUMENTS.	IN THESE CONSTRUCTION	MATSUYAMA ELEI 7680 WINDBRIDGE
			SCOPE OF THE PRC COMPLIANT ARE FO BEYOND REASONAE	CTION, IF P.O.T. ITEMS WITHIN THE DJECT PRESENTED AS CODE DUND TO BE NONCONFORMING BLE CONSTRUCTION TOLERANCES,	SACRAMENTO, CA
				DUGHT INTO COMPLIANCE WITH THE	PROJECT: MATSUYAMA ELEI
					SHEET NAME: CODE SITE PLAN
		TN			DSA SUBMIT
					DATE: 01/04/2024 SHEET:
		S SITE PLAN 1 1" = 40'-0"			



CLIENT PROJ NO: 3186-070-000

UBMITTAL

AMA ELEMENTARY SCHOOL MODERNIZATION

AMA ELEMENTARY SCHOOL IDBRIDGE DRIVE ENTO, CA 95831

Sacramento City \sim Architects)70-000 C-25193 REN.07/31/25 DL AVENUE, SUITE 100, TO, CA, 95816 / www.hmcarchitects.com

(E) FIRE HYDRANT

DROP OFF AREA (E) KNOX BOX

(E) ACCESSIBLE PARKING SIGN

(E) PARKING LOT ENTRANCE SIGN (E) VAN ACCESSIBLE PARKING SIGN

THE TYPES, LOCATIONS, SIZES, AND/OR DEPTHS OF EXISTING UNDERGROUND UTILITIES AS SHOWN ON THESE PLANS WERE OBTAINED FROM SOURCES OF VARYING RELIABILITY. THE CONTRACTOR IS CAUTIONED THAT ONLY ACTUAL EXCAVATION WILL REVEAL THE TYPES, EXTENT, SIZES, LOCATIONS AND DEPTHS OF SUCH UNDERGROUND UTILITIES. A REASONABLE EFFORT HAS BEEN MADE TO LOCATE AND DELINEATE ALL KNOWN UNDERGROUND UTILITIES. HOWEVER, WARREN CONSULTING ENGINEERS CAN ASSUME NO RESPONSIBILITY FOR THE COMPLETENESS OR ACCURACY OF ITS DELINEATION OF SUCH UNDERGROUND UTILITIES, NOR FOR THE EXISTENCE OF OTHER BURIED OBJECTS OR UTILITIES WHICH MAY BE ENCOUNTERED BUT WHICH ARE NOT SHOWN ON THESE PLANS. THE CONTRACTOR OR ANY SUBCONTRACTOR FOR THIS CONTRACT SHALL NOTIFY MEMBERS OF UNDERGROUND SERVICE ALERT (USA) TWO (2) WORKING DAYS IN ADVANCE OF PERFORMING ANY EXCAVATION WORK BY CALLING TOLL FREE 1-800-227-2600. OR 811.



- WARREN CONSULTING ENGINEERS, INC. (WCE) ASSUMES NO RESPONSIBILITY FOR ERRORS IN PHYSICAL LOCATION OF IMPROVEMENTS, HORIZONTAL OR VERTICAL, IF STAKED BY OTHERS. IN ADDITION, ANY SUCH ERRORS IN PHYSICAL LOCATION MAY AFFECT THE INTENDED DESIGN OF SUCH IMPROVEMENTS AND WCE CANNOT BE HELD RESPONSIBLE FOR SUCH CONDITIONS WHICH ARE A RESULT OF ERRORS IN SURVEYING OR IMPROPER CONSTRUCTION.
- 3. IF SUBSURFACE CULTURAL RESOURCES, REMAINS, AND/OR ARTIFACTS ARE UNCOVERED DURING PROJECT CONSTRUCTION, ALL WORK IN THE VICINITY SHALL BE STOPPED UNTIL SUCH ITEMS CAN BE ASSESSED BY AN APPROPRIATE MEMBER OF THE COUNTY ENVIRONMENTAL IMPACT SECTION STAFF.
- 4. CONTRACTOR AGREES THAT HE/SHE SHALL ASSUME SOLE AND COMPLETE RESPONSIBILITY FOR JOB SITE CONDITIONS DURING THE COURSE OF CONSTRUCTION OF THIS PROJECT, INCLUDING SAFETY OF ALL PERSONS AND PROPERTY: THAT THIS REQUIREMENT SHALL APPLY CONTINUOUSLY AND SHALL NOT BE LIMITED TO NORMAL WORKING HOURS: AND THAT THE CONTRACTOR SHALL DEFEND, INDEMNIFY AND HOLD THE OWNER AND ENGINEER HARMLESS FROM ANY AND ALL LIABILITY, REAL OR ALLEGED, IN CONNECTION WITH THE PERFORMANCE OF WORK ON THIS PROJECT, EXCEPTING FOR LIABILITY ARISING FROM THE SOLE NEGLIGENCE OF THE OWNER OR ENGINEER.
- 5. THE CONTRACTOR SHALL OBTAIN AN EXCAVATION PERMIT FROM THE STATE OF CALIFORNIA DEPARTMENT OF INDUSTRIAL SAFETY FOR ALL EXCAVATIONS OF 5 FEET OR MORE IN DEPTH.
- 6. IT SHALL BE THE CONTRACTOR'S RESPONSIBILITY TO MAKE ALL NECESSARY PRE-BID AND PRE-CONSTRUCTION SITE INSPECTION, AND/OR OBSERVATIONS ON THE SITE TO PRE-DETERMINE ALL HIS/HER MEANS AND METHODS NECESSARY TO COMPLETE THE IMPROVEMENTS SHOWN ON THESE PLANS AND PER THE PROJECT SPECIFICATIONS. IT IS THE CONTRACTORS RESPONSIBILITY TO DETERMINE, AND INCLUDE IN HIS/HER CONTRACT, ALL MEANS AND METHODS NECESSARY TO PERFORM A COMPLETE AND ACCEPTABLE JOB.
- WHERE IMPROVEMENTS LIE WITHIN AN EXISTING DEVELOPED AREA, CONTRACTOR SHALL USE CAUTION WHEN ACCESSING THE SITE THROUGH THESE EXISTING IMPROVEMENTS. IT IS THE CONTRACTORS RESPONSIBILITY TO PROTECT ANY SUCH EXISTING IMPROVEMENTS OUTSIDE THE PROJECT BOUNDARY, OR EXISTING IMPROVEMENTS WITHIN THE BOUNDARY WHICH ARE TO REMAIN. PROPER PRECAUTIONS SHALL BE PROVIDED AND MAINTAINED THROUGHOUT CONSTRUCTION. ANY DAMAGE SHALL BE REPAIRED OR REPLACED TO THE SATISFACTION OF THE OWNER.
- 8. IT IS THE RESPONSIBILITY OF THE CONTRACTOR TO KEEP DETAILED RECORDS OF MINOR CHANGES OR ADJUSTMENTS MADE DURING CONSTRUCTION (WHICH WERE NOT FORMALLY ISSUED). UPON PROJECT COMPLETION, THESE RECORDS AND/OR INFORMATION SHALL BE PROVIDED TO THE OWNER AND WARREN CONSULTING ENGINEERS, INC. UNLESS AN OFFICIAL "AS-BUILT" SET OF PLANS IS A REQUIREMENT OF THE CONTRACT. IF AS-BUILT PLANS ARE A REQUIREMENT OF THE CONTRACT, REFER TO SPECIFICATIONS FOR AS-BUILT DELIVERABLE REQUIREMENTS.
- IN VEHICULAR PATHWAYS, EXISTING ASPHALTIC AND/OR CONCRETE SURFACES SHALL BE CUT TO A NEAT AND STRAIGHT LINE, PARALLEL OR PERPENDICULAR TO THE VEHICULAR TRAVELED PATH. THIS IS TYPICALLY THE ROADWAY CENTERLINE, BUT MAY VARY. THAT SAWCUT EDGE SHALL BE PROTECTED FROM DAMAGE DURING CONSTRUCTION SO A CLEAN EDGE REMAINS FOR PATCH BACK .. IF EDGE IS DAMAGED, A NEW SAW CUT WILL BE REQUIRED. THE EXPOSED EDGE SHALL BE "TACKED" WITH EMULSION PRIOR TO PAVING.
- 10. NO BURNING OR BLASTING SHALL BE ALLOWED ONSITE UNLESS SPECIFICALLY ADDRESSED ON PLANS, OR SPECIFICALLY APPROVED AND COORDINATED WITH THE ARCHITECT, ENGINEER, AND LOCAL AGENCY OR OTHER ADMINISTRATIVE AUTHORITY.
- SUBGRADE AND RESULTING FINISHED GRADE SHALL BE CONSTRUCTED SMOOTH AND UNIFORM BETWEEN 11. SPOT ELEVATIONS, CONTOURS OR OTHER STRUCTURE ELEVATIONS SHOWN ON GRADING OR OTHER PLANS. IO MOUNDS, RUTS, DEPRESSIONS OR OTHER GRADING DEFICIENCIES WILL BE ALLOWED UNLESS SPECIFICALLY SHOWN ON PLANS.
- 12. ON NEW WATER SYSTEMS, SERVICE LATERALS SHALL BE MADE USING APPROPRIATE "TEE" AND "WYE" FITTINGS. SADDLE TAPS WILL ONLY BE ALLOWED WHEN MAKING CONNECTIONS TO EXISTING WATER MAINS.
- 13. CURING COMPOUND SHALL BE APPLIED IN A CONTINUOUS SOLID WET FLOWING COAT. ANY "SPOTTY" APPLICATIONS SHALL BE RECOATED IMMEDIATELY. APPLICATION SHALL BE INSPECTED BY PROJECT INSPECTOR DURING APPLICATION.
- EMBEDMENT OF FEATURES IN CONCRETE PAVING, CURBS, OR WALLS, SUCH AS SQUARE OR ROUND TUBING, 14. POSTS, OR COLUMNS, STEEL BOLTED PLATES, OR OTHER STRUCTURES, SHALL REQUIRE ADDITIONAL SCORE OR EXPANSION JOINTS TO PREVENT UNCONTROLLED CRACKING. THOSE ADDITIONAL JOINTS MAY OR MAY NOT BE SPECIFICALLY SHOWN ON PLANS BUT SHALL BE PROVIDED BY THE CONTRACTOR.
- 15. EMBEDMENT OF FEATURES IN CONCRETE PAVING, CURBS, OR WALLS, SUCH AS SQUARE OR ROUND TUBING, POSTS, OR COLUMNS, STEEL BOLTED PLATES, OR OTHER STRUCTURES, SHALL REQUIRE A MINOR ADJUSTMENT OF REBAR WITHIN CONCRETE TO ALLOW FOR SUCH STRUCTURE. THAT REBAR ADJUSTMENT MAY NOT BE SPECIFICALLY SHOWN ON PLANS.
- 16. NO MORE THAN 1 GALLON OF WATER PER YARD OF CONCRETE CAN BE ADDED TO THE TRUCK AFTER ARRIVAL TO PROJECT SITE. THE ADDITION OF WATER CAN ONLY BE ADDED UNDER THE SUPERVISION OF THE CONCRETE INSPECTOR OR LABORATORY TECHNICIAN.
- WHEN PUMPING CONCRETE FOR PLACEMENT, ABSOLUTELY NO WATER IS TO BE ADDED TO PUMP HOPPER. 17. ANY WATER ADDED TO HOPPER WILL BE REASON FOR CONCRETE REJECTION AT THE CONTRACTORS EXPENSE.
- 18. ALL CONTRACTION/CONSTRUCTION JOINTS "CJ" SHALL BE 1/4 THE SLAB THICKNESS DEEP, BUT NO LESS THAN 1" FOR CONTROLLING OF CRACKING. CONTRACTOR SHALL EXERCISE CAUTION WHEN FINAL TROWELING OF CONCRETE SO AS NOT TO FILL IN THESE JOINTS WITH CONCRETE CREAM. ANY CRACKS OUTSIDE OF JOINTS WHICH WERE CONSTRUCTED LESS THAN 1" DEEP, SHALL BE CAUSE FOR CONCRETE SLAB(S) TO BE REMOVED AND REPLACE AT CONTRACTORS EXPENSE.
- 19. ANY SCREED BOARDS SET WITHIN CONCRETE SLABS SHALL BE AN "OVERHEAD SCREED" SO THERE IS NO INTERFERENCE WITH THE PLACEMENT AND ALIGNMENT OF SLAB REINFORCING.
- 20. 3-1/2" FELT JOINTS WILL NOT BE ACCEPTED. PROVIDE A FULL 4" FELT JOINT FOR 4" SLAB CONSTRUCTION, AND A 6" FELT JOINT FOR A 6" SLAB SLAB CONSTRUCTION.
- 21. SHOULD ANY SHRINKAGE CRACKS OCCUR OUTSIDE OF EITHER THE EXPANSION JOINTS OR CRACK CONTROL JOINTS, THEN THE CONCRETE SLAB SHALL BE SAWCUT AT THE NEAREST JOINTS ON EACH SIDE OF THE CRACK AND THE CONCRETE SECTION SHALL BE, REMOVED AND REPLACED. NEW CONCRETE SHALL BE DOWELED INTO EXISTING CONCRETE PER DRAWING DETAIL.
- 22. ALL AREAS DISTURBED BY GRADING OPERATIONS WHETHER SHOWN ON THE DRAWINGS OR NOT SHALL BE HYDRO SEEDED UNLESS OTHERWISE NOTED. HYDRO SEEDING SHALL CONFORM TO LOCAL CITY/COUNTY STANDARDS.
- 23. REPAIR OR PATCHING OF GALVANIZED METALS, SUCH AS AFTER WELDING GALVANIZED COMPONENTS, SHALL BE MADE USING A ZINC COMPOSITION "HOT STICK" APPLICATION PER ASTM A 780-01. GALVANIZING PAINTS WILL NOT BE ALLOWED.

GENERAL PAVING SURFACE NOTES:

1. PROVIDE EQUIVALENT OF MEDIUM BROOM FINISH AT SLOPES UP TO 5.99%, TYPICAL. PROVIDE EQUIVALENT OF HEAVY BROOM FINISH AT SLOPES 6% AND GREATER. REFER TO SPECIFICATIONS.

- 2. ALL NEW PEDESTRIAN WALKWAYS (NON-RAMP) SHALL BE SLOPED NO GREATER THAN 2.0%, AND NO LESS THAN 0.75% IN ANY DIRECTION, UNLESS SPECIFICALLY LABELED OTHERWISE. ALL CONCRETE SHALL MEET THE FOLLOWING SLOPE REQUIREMENTS: - NO GREATER THAN 5% SLOPE IN THE DIRECTION OF TRAVEL.
- NO GREATER THAN 2% SLOPE CROSSING THE DIRECTION OF TRAVEL - NO GREATER THAN 2% SLOPE IN ANY DIRECTION IN COURTYARD OR PLAZA AREAS.

CIVIL SHEET INDEX

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	ABBREVIATIONS	L	<u>EGEND</u>	
IOTE:			L SYMBOLS MAY These plans.	
Αĭ	BE USED ON THESE PLANS. AGGREGATE BASE		& DRAINAGE SYMBOLS:	
	ASPHALTIC CONCRETE AREA DRAIN		STORM DRAIN LINE	
	ASSESSOR'S PARCEL NUMBER AIR RELEASE VALVE		(SIZE AND FLOW SHOWN)	
	AGGREGATE SUB-BASE BLOW-OFF VALVE		STORM DRAIN MANHOLE (SDMH)	
	BUTTERFLY VALVE BACK OF WALK		CATCH BASIN (CB)	
	CENTERLINE CATCH BASIN			
	CLASS CORRUGATED METAL PIPE		DROP INLET (DI)	
V	CABLE TELEVISION CLEANOUT		AREA DRAIN (AD)	
М С.	COMMUNICATION CONCRETE		PLANTER DRAIN (PD) OR FLOOR DRAIN (FD)	
ST.	CONSTRUCT CURB RETURN	o co	STORM DRAIN CLEANOUT	
	CONCRETE SURFACE DOUBLE CHECK VALVE	99.99	ELEVATION	
	DOUBLE DETECTOR CHECK VALVE DECOMPOSED GRANITE	FF=100.00	FINISHED FLOOR ELEVATION	
	DROP INLET	PAD=99.33	BUILDING PAD ELEVATION	HMC /
	DIAMETER DUCTILE IRON PIPE		CONCRETE SIDEWALK	
	DRAWING DOWNSPOUT		GRADED DIRECTION FOR	3186-07
-	ELECTRIC EDGE OF PAVEMENT		DRAINAGE FLOW	
Т	EASEMENT EXISTING	$\rightarrow \cdots \rightarrow$	SWALE	2101 CAPITOL SACRAMENTO
	FIRE SERVICE LINE FIRE DEPARTMENT CONNECTION		SLOPE	
	FLOWLINE SANITARY SEWER FORCE MAIN	\sim	TREE TO BE REMOVED	ISSUE
	FINISHED FLOOR ELEVATION FIRE HYDRANT		RETAINING WALL	<u>A</u> DESCRIPT 1 ADDENDU
	GAS GRATE ELEVATION	PROPOSED SANITAR	Y SEWER SYMBOLS:	
	GRADE ELEVATION GATE VALVE	6" SS	SANITARY SEWER LINE (SIZE AND FLOW SHOWN)	
_	HOSE BIBB HEADER BOARD		SANITARY SEWER	
E	HIGH DENSITY POLYETHYLENE PIPE HIGH POINT		MANHOLE (SSMH)	
	PIPE INVERT ELEVATION JOINT UTILITY POLE	o CO	SEWER CLEANOUT	
	LINEAL FEET LIP OF GUTTER		FLUSHER BRANCH	
	LEFT MOWSTRIP	PROPOSED WATER S		
	NOT TO SCALE OVERHEAD BODTLAND, CEMENT, CONCRETE	8" W	WATER LINE & SIZE	
	PORTLAND CEMENT CONCRETE PLANTER DRAIN	8" FS	FIRE LINE & SIZE	
	POST INDICATOR VALVE PROPERTY LINE	8" DW	DOMESTIC WATER LINE & SIZE	
	POWER POLE PUBLIC UTILITY EASEMENT	8"_RW]	RECLAIMED WATER LINE & SIZE	
	POLYVINYL CHLORIDE REINFORCED CONCRETE PIPE	8" IRR	IRRIGATION SERVICE LINE & SIZE	
	RADIUS MANHOLE RIM ELEVATION (SOLID COVER)	8" NP	NON POTABLE WATER LINE & SIZE	
	REDUCED PRESSURE BACKFLOW PREVENTER RIGHT OF WAY	8" SP	FIRE SPRINKLER SERVICE LINE & SIZE	
	SCHEDULE STORM DRAIN	→→	GATE VALVE	
Н	STORM DRAIN MANHOLE SUBGRADE ELEVATION	M	WATER METER	
н	SANITARY SEWER SANITARY SEWER MANHOLE	─── ► ● FH	FIRE HYDRANT ASSEMBLY	
	STANDARD SIDEWALK	Y FDC <u>DC</u>	FIRE DEPARTMENT CONNECTION	
	TELEPHONE TOP OF CURB		DETECTOR CHECK VALVE	
3	TRENCH DRAIN TRENCH DRAIN CATCH BASIN	RP	DOUBLE DETECTOR CHECK VALVE	
	TELEPHONE POLE TOP OF RETAINING WALL		REDUCED PRESSURE BACKFLOW PREVENTER	
	TOP OF SEAT WALL TOP OF WALK ELEVATION	\v_	BUTTERFLY VALVE	
	UTILITY UNDERGROUND		AIR RELEASE VALVE + SIZE	
	UNLESS OTHERWISE NOTED VITRIFIED CLAY PIPE	1"	BLOW-OFF VALVE + SIZE	
	WATER	PIV		
1	WITH WITHOUT		POST INDICATOR VALVE	

DEMOLITION GENERAL NOTES

1. IN THE EVENT THAT ANY UNUSUAL CONDITIONS NOT COVERED BY THE GEOTECHNICAL INVESTIGATION REPORT OR ARE ENCOUNTERED DURING GRADING OPERATIONS THE GEOTECHNICAL ENGINEER AND THE ARCHITECT SHALL BE IMMEDIATELY NOTIFIED FOR DIRECTIONS.

2. NO BURNING OR BLASTING SHALL BE PERMITTED.

ADDITIONAL DEMOLITION INFORMATION MAY BE SHOWN ON THE GRADING, DRAINAGE, AND UTILITY PLANS, AND THOSE PLANS PREPARED BY OTHER DISCIPLINES FOR THIS PROJECT.

4. ALL DEMOLISHED ITEMS SHALL BE DISPOSED OF OFFSITE AT A SUITABLE, LEGAL, DUMP SITE OR OTHER FACILITY.

ALL DISPOSED OF MATERIALS SHALL BE RECYCLED IF POSSIBLE.

6. THE TYPES, LOCATIONS, SIZES AND/OR DEPTHS OF EXISTING UNDERGROUND UTILITIES AS SHOWN IN THESE PLANS WERE OBTAINED FROM SOURCES OF VARYING RELIABILITY. THE CONTRACTOR IS CAUTIONED THAT ONLY ACTUAL EXCAVATION WILL REVEAL THE TYPES, EXTENT, SIZES, LOCATIONS, AND DEPTHS OF SUCH UNDERGROUND UTILITIES. A REASONABLE EFFORT HAS BEEN MADE TO LOCATE AND DELINEATE ALL KNOWN UNDERGROUND UTILITIES. HOWEVER, WARREN CONSULTING ENGINEERS CAN ASSUME NO RESPONSIBILITY FOR THE COMPLETENESS OR ACCURACY OF ITS DELINEATION OF SUCH UNDERGROUND UTILITIES, NOR FOR THE EXISTENCE OF OTHER BURIED OBJECTS OR UTILITIES WHICH MAY BE ENCOUNTERED BUT WHICH ARE NOT SHOWN ON THESE DRAWINGS. THE CONTRACTOR OR ANY SUBCONTRACTOR FOR THIS CONTRACT SHALL NOTIFY THE DISTRICT TWO (2) WORKING DAYS IN ADVANCE OF PERFORMING ANY EXCAVATION WORK IN ORDER TO VERIFY TO THE GREATEST EXTENT POSSIBLE THE EXISTING UTILITY LINES, CONFLICTS AND PROPOSED UTILITY CONNECTION POINTS.

7. THE SCHOOL DISTRICT SHALL HAVE SALVAGE RIGHTS TO ANY DEMOLISHED ITEMS SHOWN HEREON. THE CONTRACTOR SHALL GIVE THE DISTRICT NOTICE 7 DAYS PRIOR TO THE START OF DEMOLITION. THE DISTRICT SHALL MOVE ANY RETAINED ITEMS OUT OF THE CONTRACTORS WORK AREA. UNLESS ANOTHER ARRANGEMENT IS MADE WITH THE CONTRACTOR. ANY REMAINING ITEMS BECOME THE PROPERTY OF THE CONTRACTOR AND SHALL BE REMOVED FROM THE SITE. ANY ITEMS NOT SHOWN FOR REMOVAL SHALL REMAIN AND SHALL BE PROTECTED FROM DAMAGE DURING CONSTRUCTION TO A REASONABLE EXTEND.

8. EXISTING UTILITY STRUCTURES IN AREAS OF NEW PAVING SHALL BE REMOVED AND REPLACED WITH NEW BOX/COVER AT NEW GRADE UNLESS SPECIFICALLY NOTED OTHERWISE.

9. ITEMS OUTSIDE THE LIMITS OF DEMOLITION SHALL REMAIN AND BE PROTECTED FROM DAMAGE DURING CONSTRUCTION.

10. EXISTING UTILITY STRUCTURES AND PIPING NOT SHOWN ON DEMOLITION PLAN TO BE REMOVED SHALL REMAIN AND BE PROTECTED.

CONCRETE SAWCUT NOTE SAWCUTS AND SUBSEQUENT PATCH BACK OF CONCRETE WALKS, SHALL BE TO THE EXISTING CONCRETE JOINT BEYOND THE NEAREST LOCATION OF DEMOLITION AS SHOWN. A REASONABLE EFFORT HAS BEEN MADE TO LOCATE, SHOW AND COORDINATE WITH EXISTING JOINTS, HOWEVER IF FIELD CONDITIONS ARE OTHERWISE, IT IS UNDERSTOOD TO REMOVE AND PATCH BACK TO THE NEAREST JOINTS BEYOND DEMOLITION.

UTILITY VERIFICATION NOTE PRIOR TO THE START OF CONSTRUCTION, LOCATE AND POTHOLE ALL UTILITY POINTS OF CONNECTION FOR LOCATION. DEPTH. AND SIZE. IF CONFLICT IS FOUND. CONTACT THE ENGINEER IMMEDIATELY FOR DIRECTION.

IRRIGATION DEMOLITION NOTE WITHIN LANDSCAPE AREAS TO BE DEMOLISHED THERE MAY BE EXISTING IRRIGATION LINES NOT SHOWN ON THIS PLAN. CONTRACTOR SHALL REMOVE LATERAL LINES AND HEADS ENCOUNTERED. MAIN LINES AND CONTROL WIRES MAY ONLY BE REMOVED PROVIDED THAT ROUTING IS KNOWN AND REMOVAL WILL NOT DEACTIVATE AN IRRIGATION SYSTEMS INTENDED TO REMAIN. IF CONFLICT IS FOUND, CONTACT THE ENGINEER FOR DIRECTION.





FACILITY:

7680 WINDBRIDGE DR.

PROJECT: MATSUYAMA ELEMENTARY SCHOOL MODERNIZATION

SHEET NAME:



DATE: 12/20/2023 SHEET:



CLIENT PROJ NO: -

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CIVIL GENERAL NOTES AND ABBREVIATIONS

MATSUYAMA ELEMENTARY SCHOOL SACRMANETO, CA 95831

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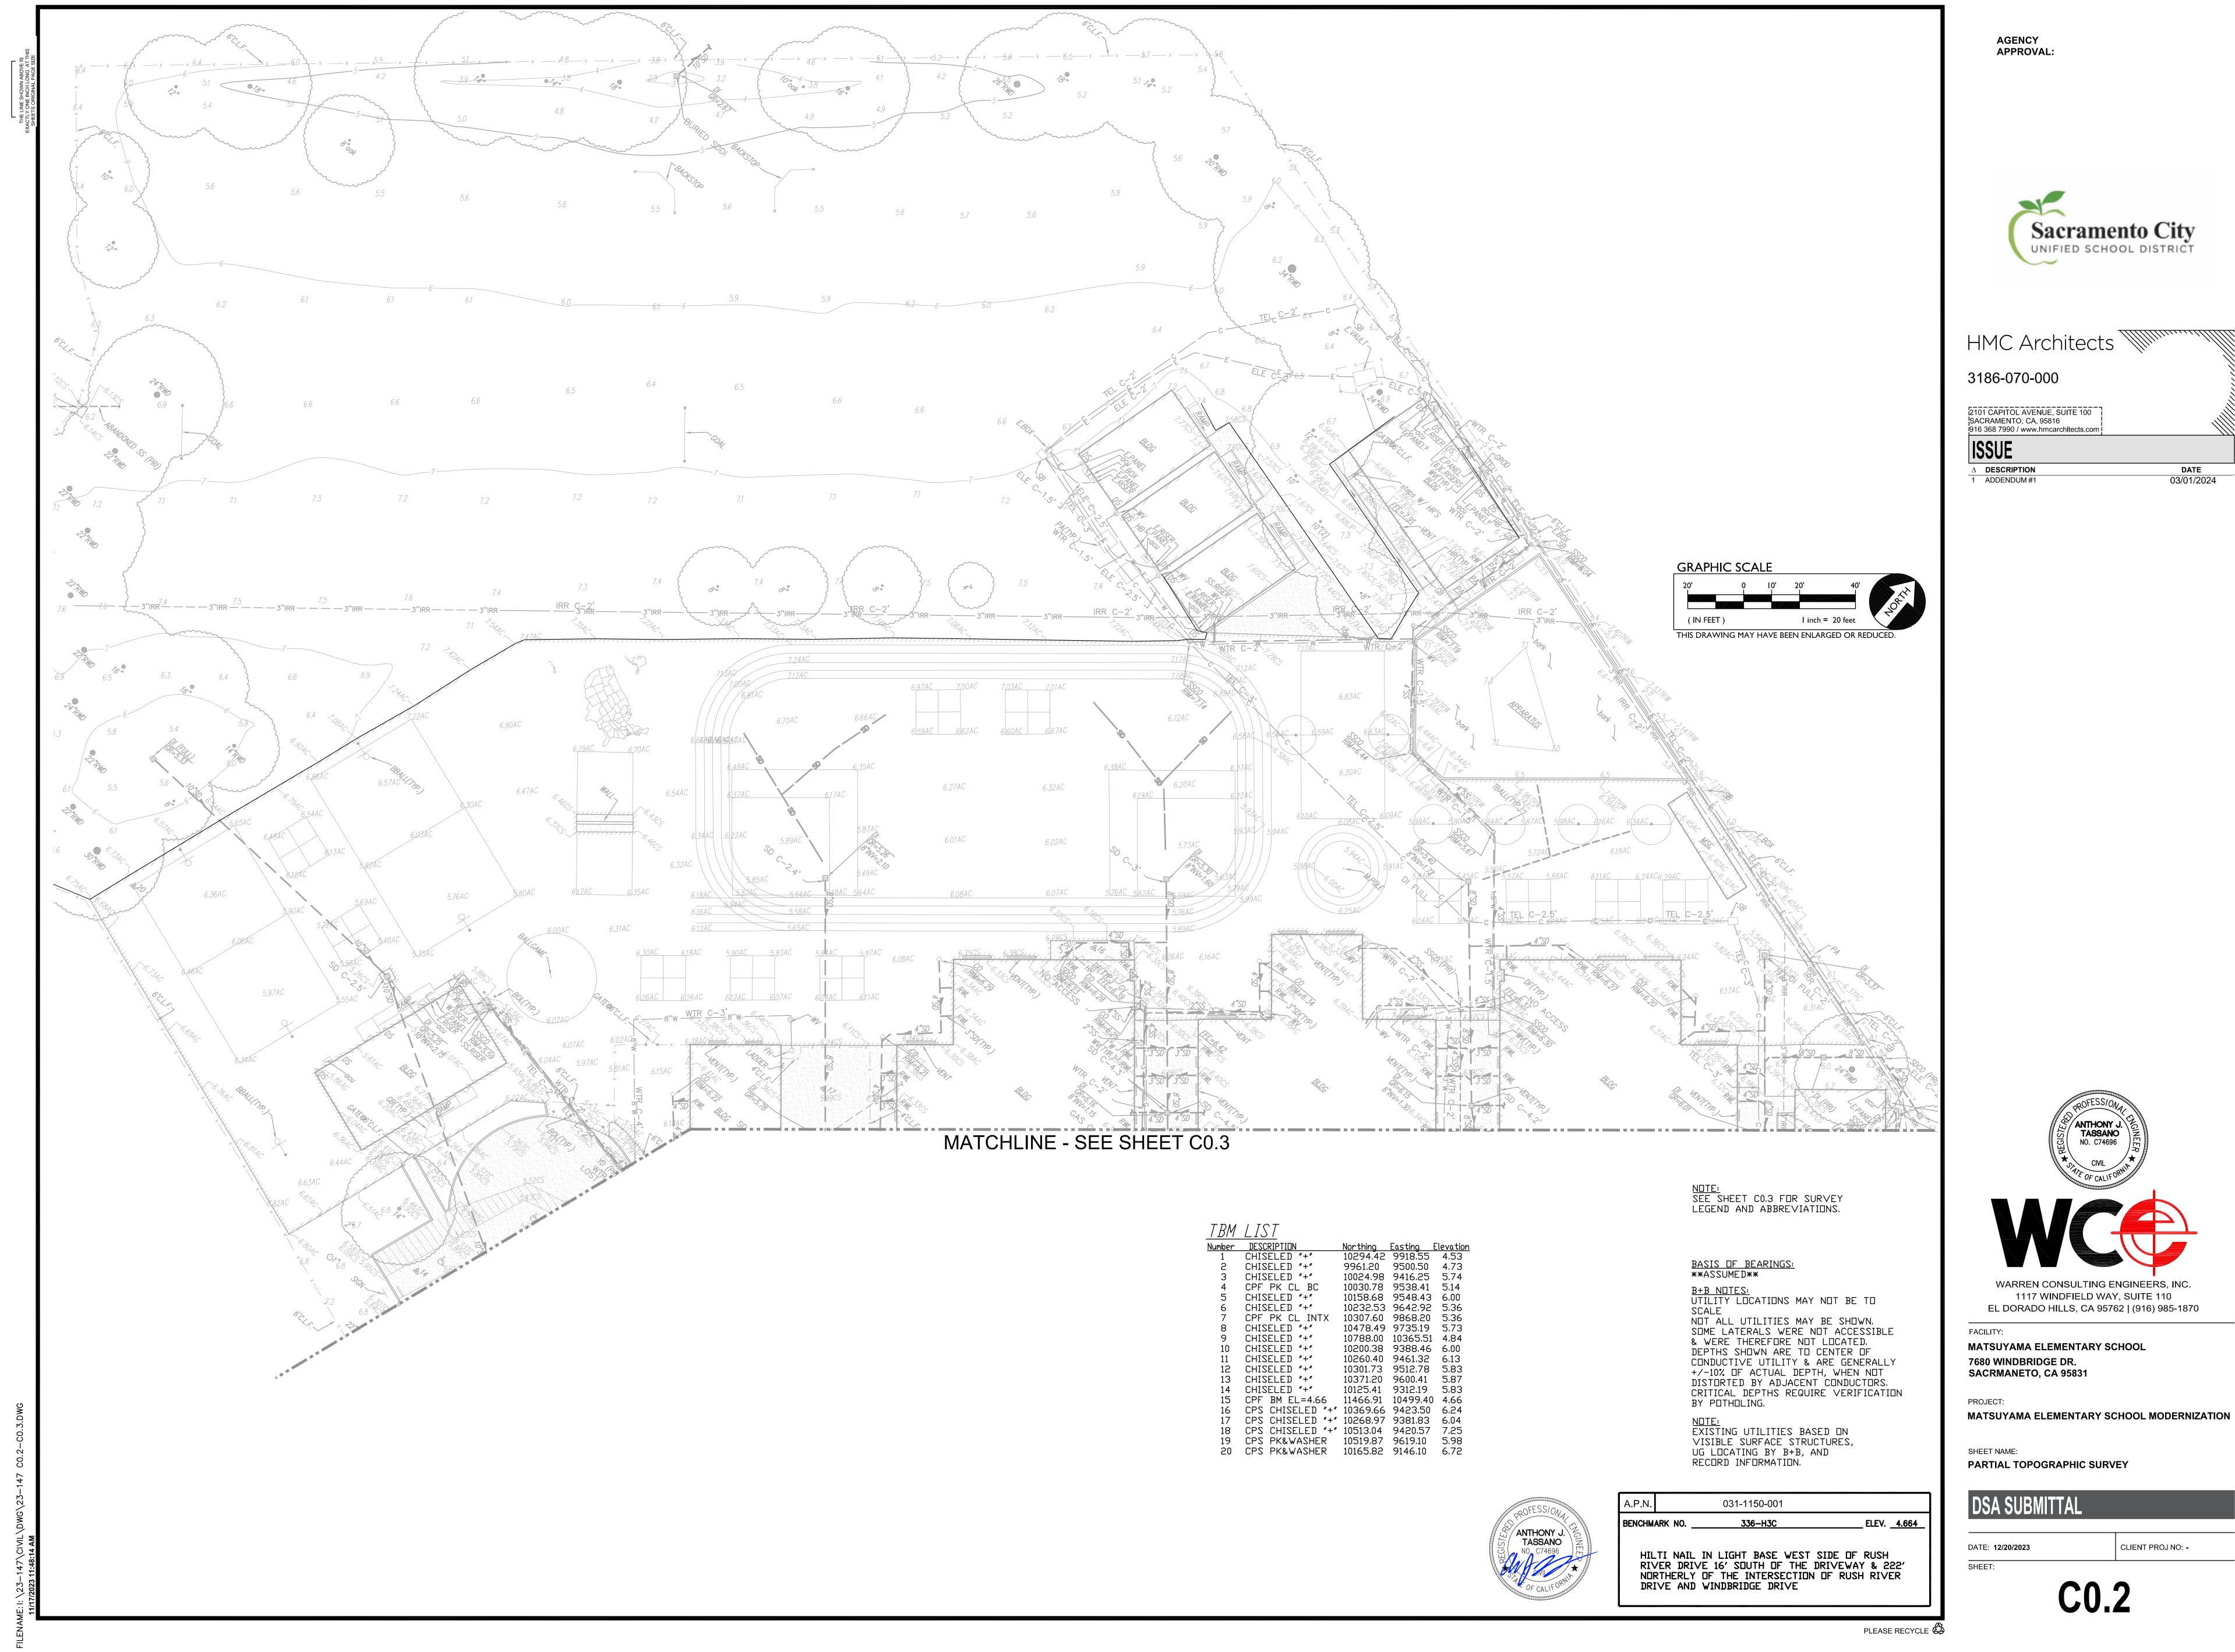




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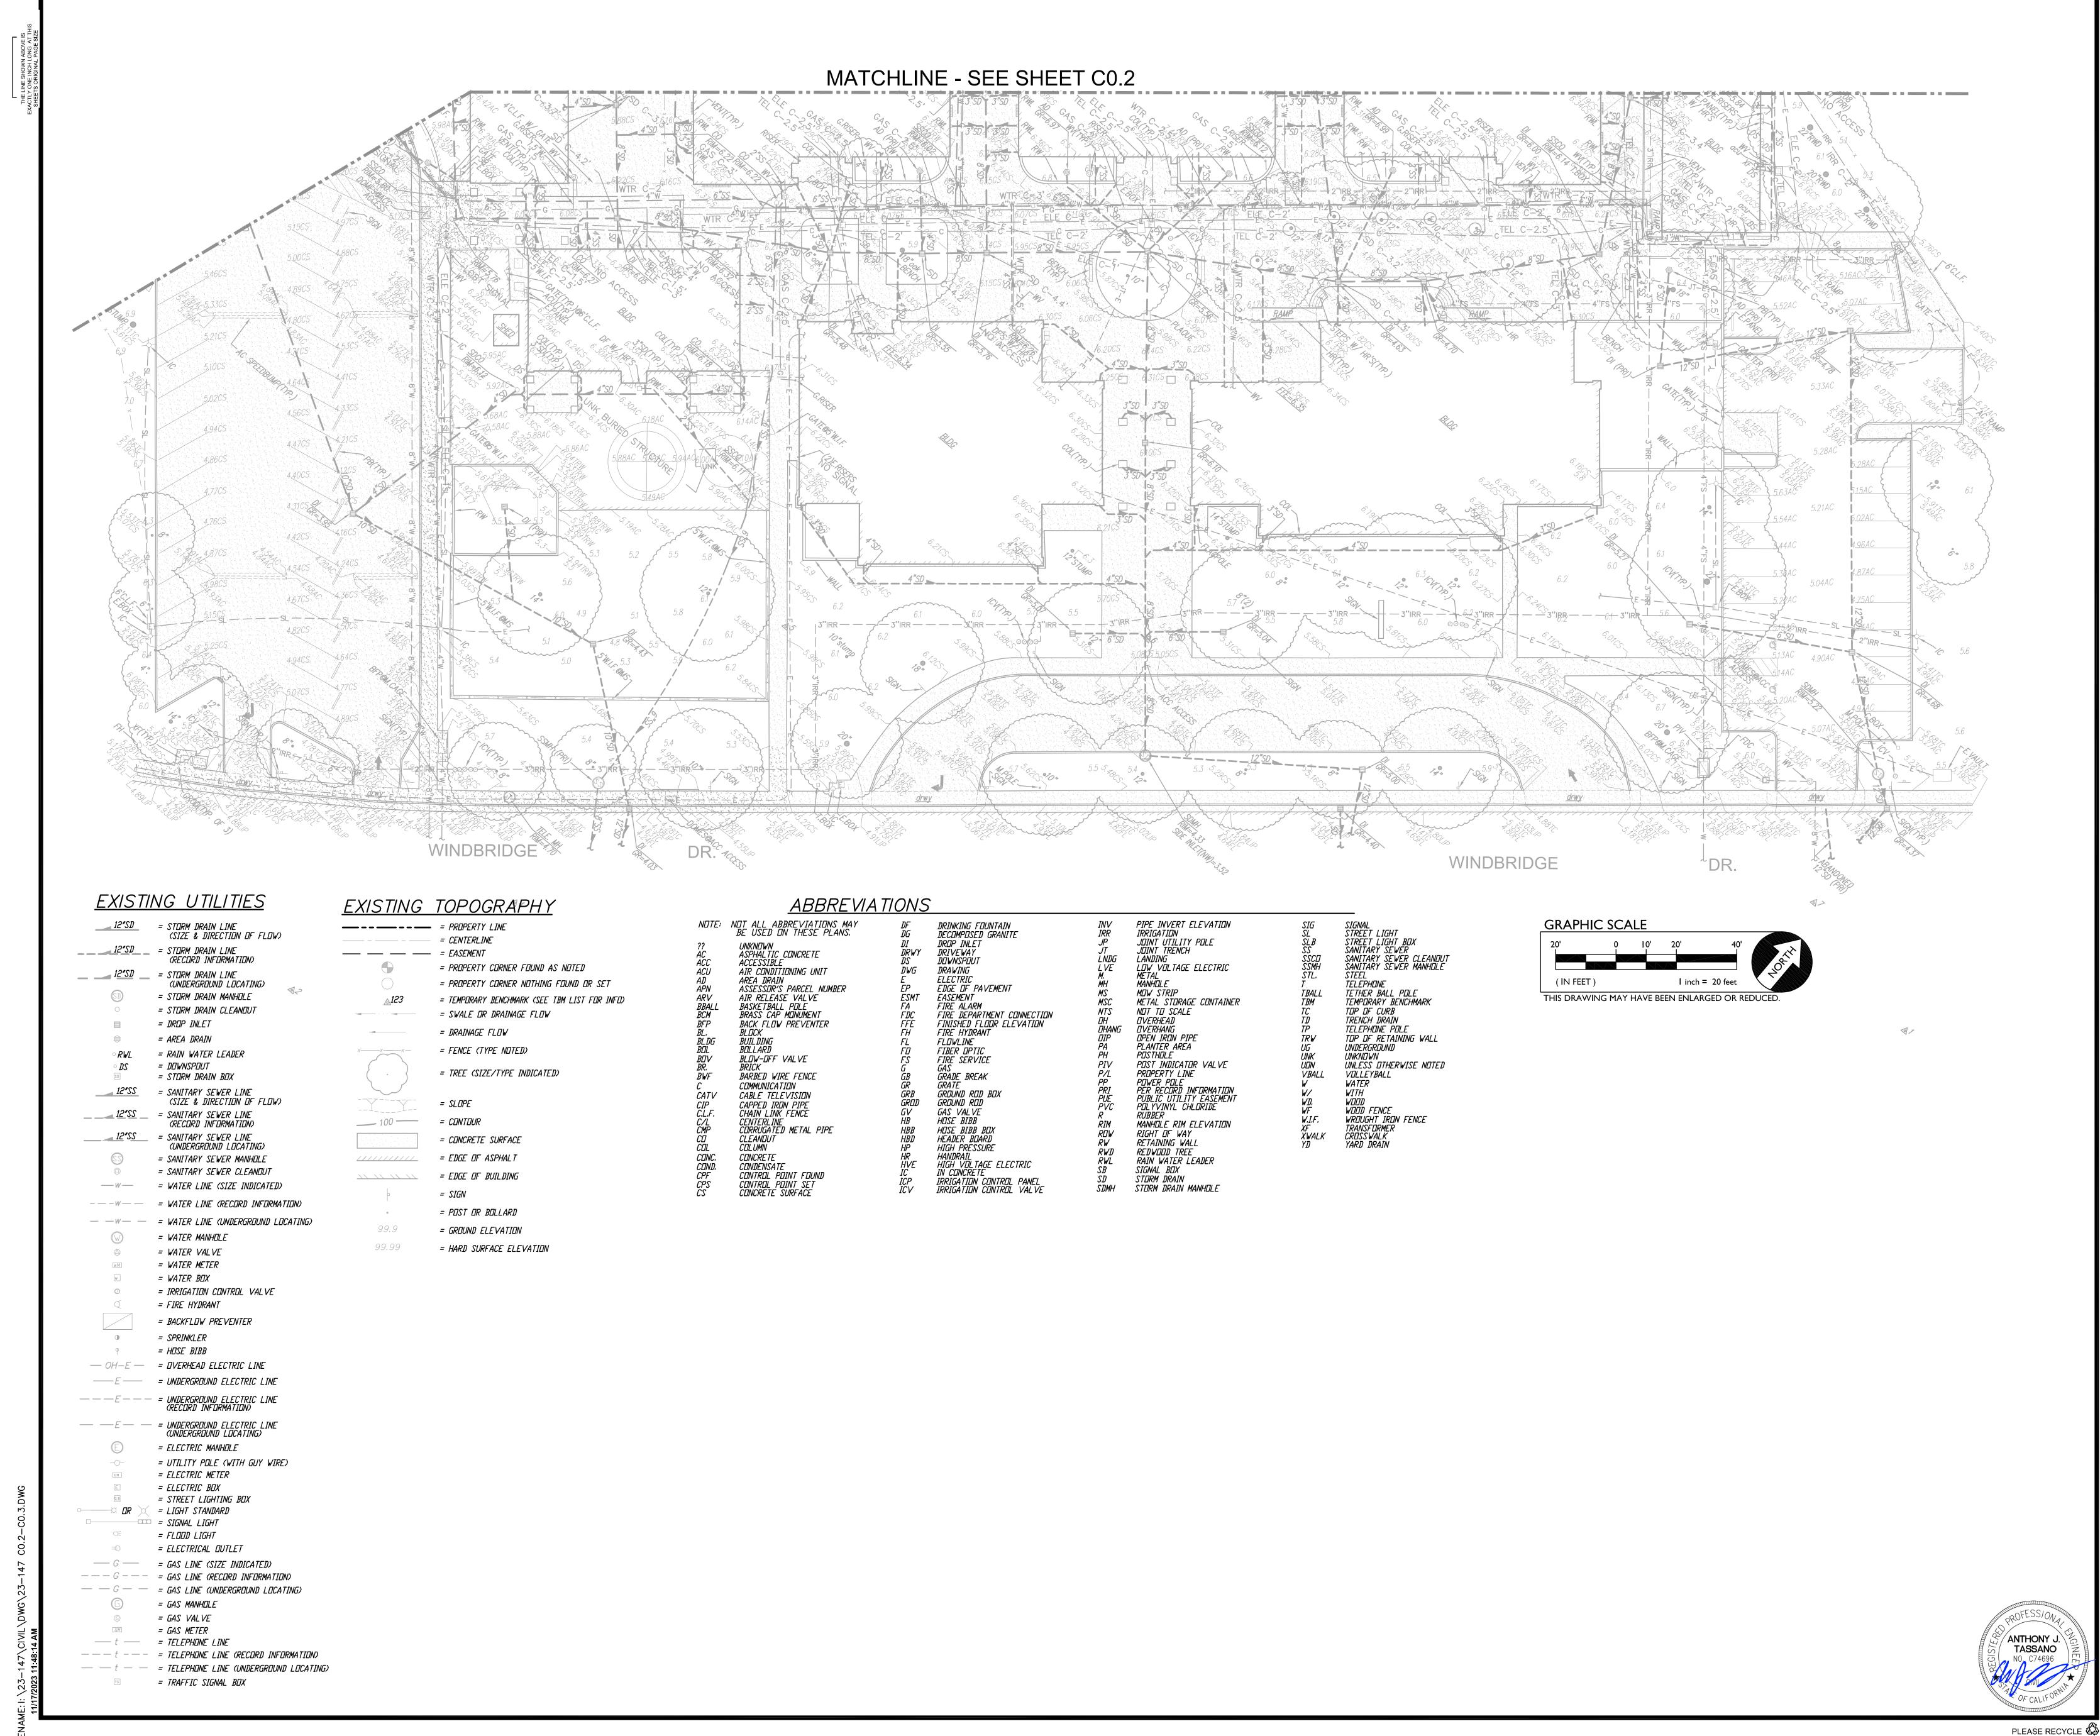


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18	CPS CHISELED "-
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20	CPS PK&WASHER



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FACILITY:

MATSUYAMA ELEMENTARY SCHOOL 7680 WINDBRIDGE DR. SACRMANETO, CA 95831

PROJECT: MATSUYAMA ELEMENTARY SCHOOL MODERNIZATION

SHEET NAME: PARTIAL TOPOGRAPHIC SURVEY



DATE: 12/20/2023 SHEET:




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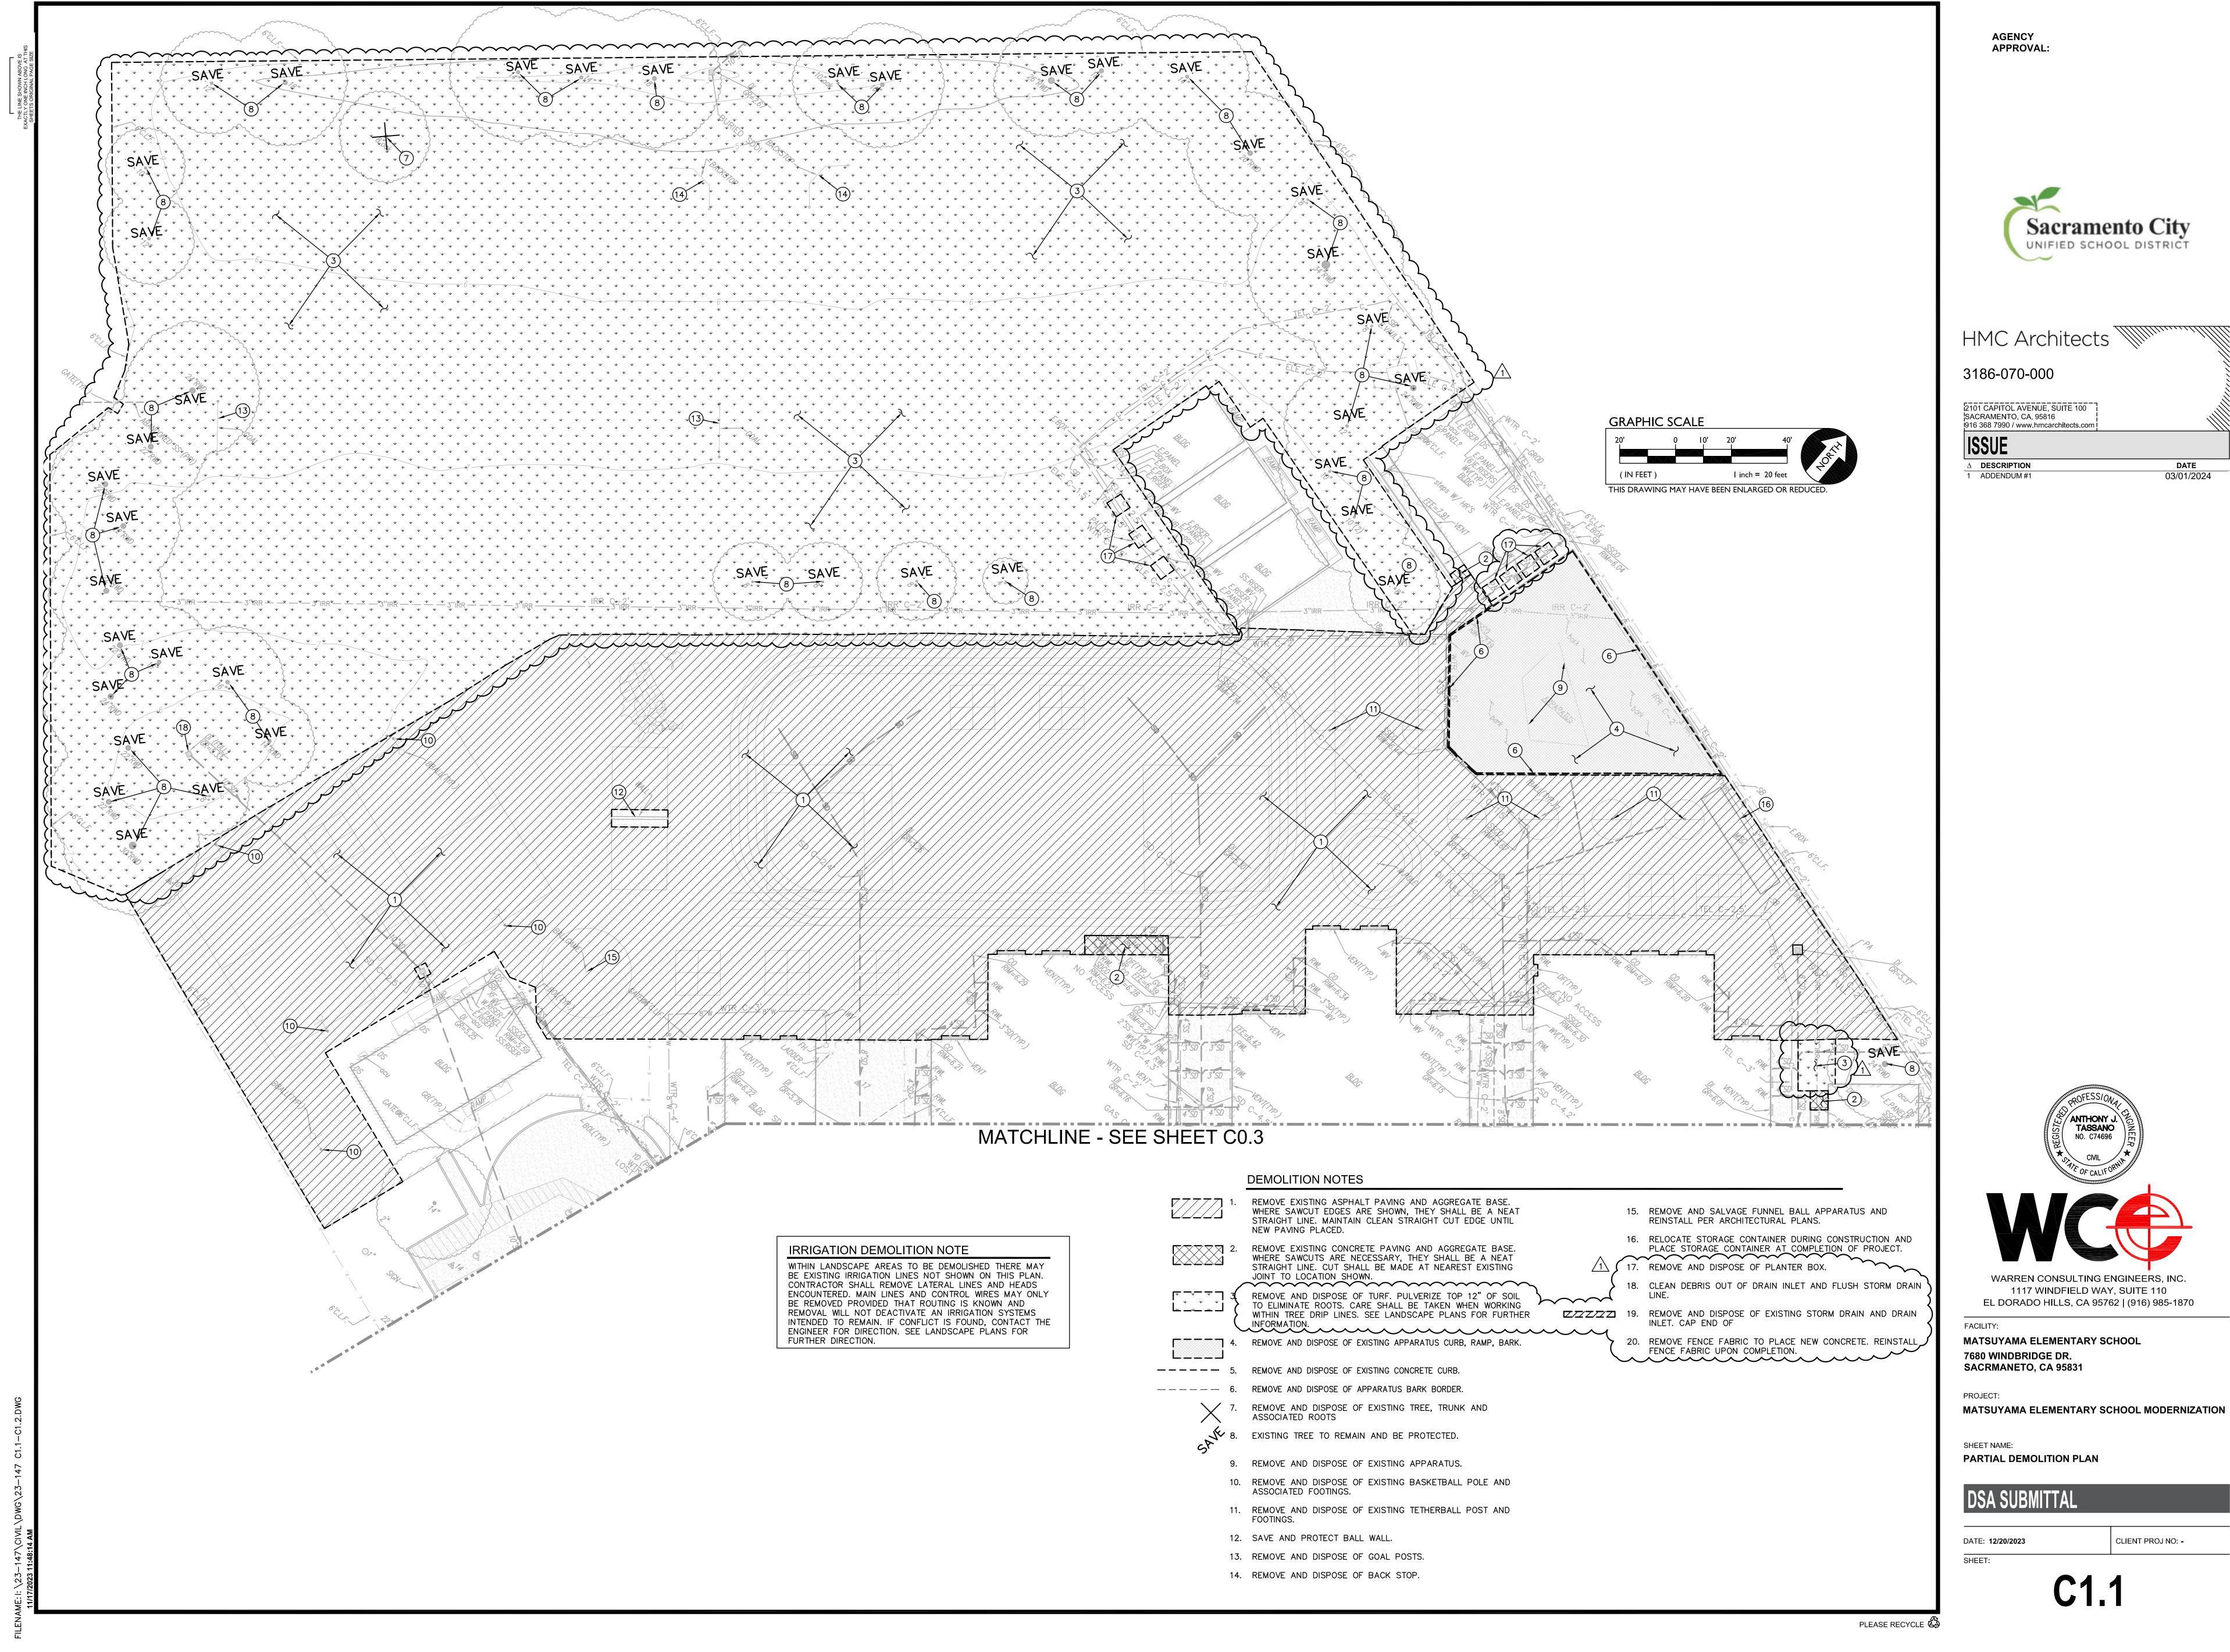
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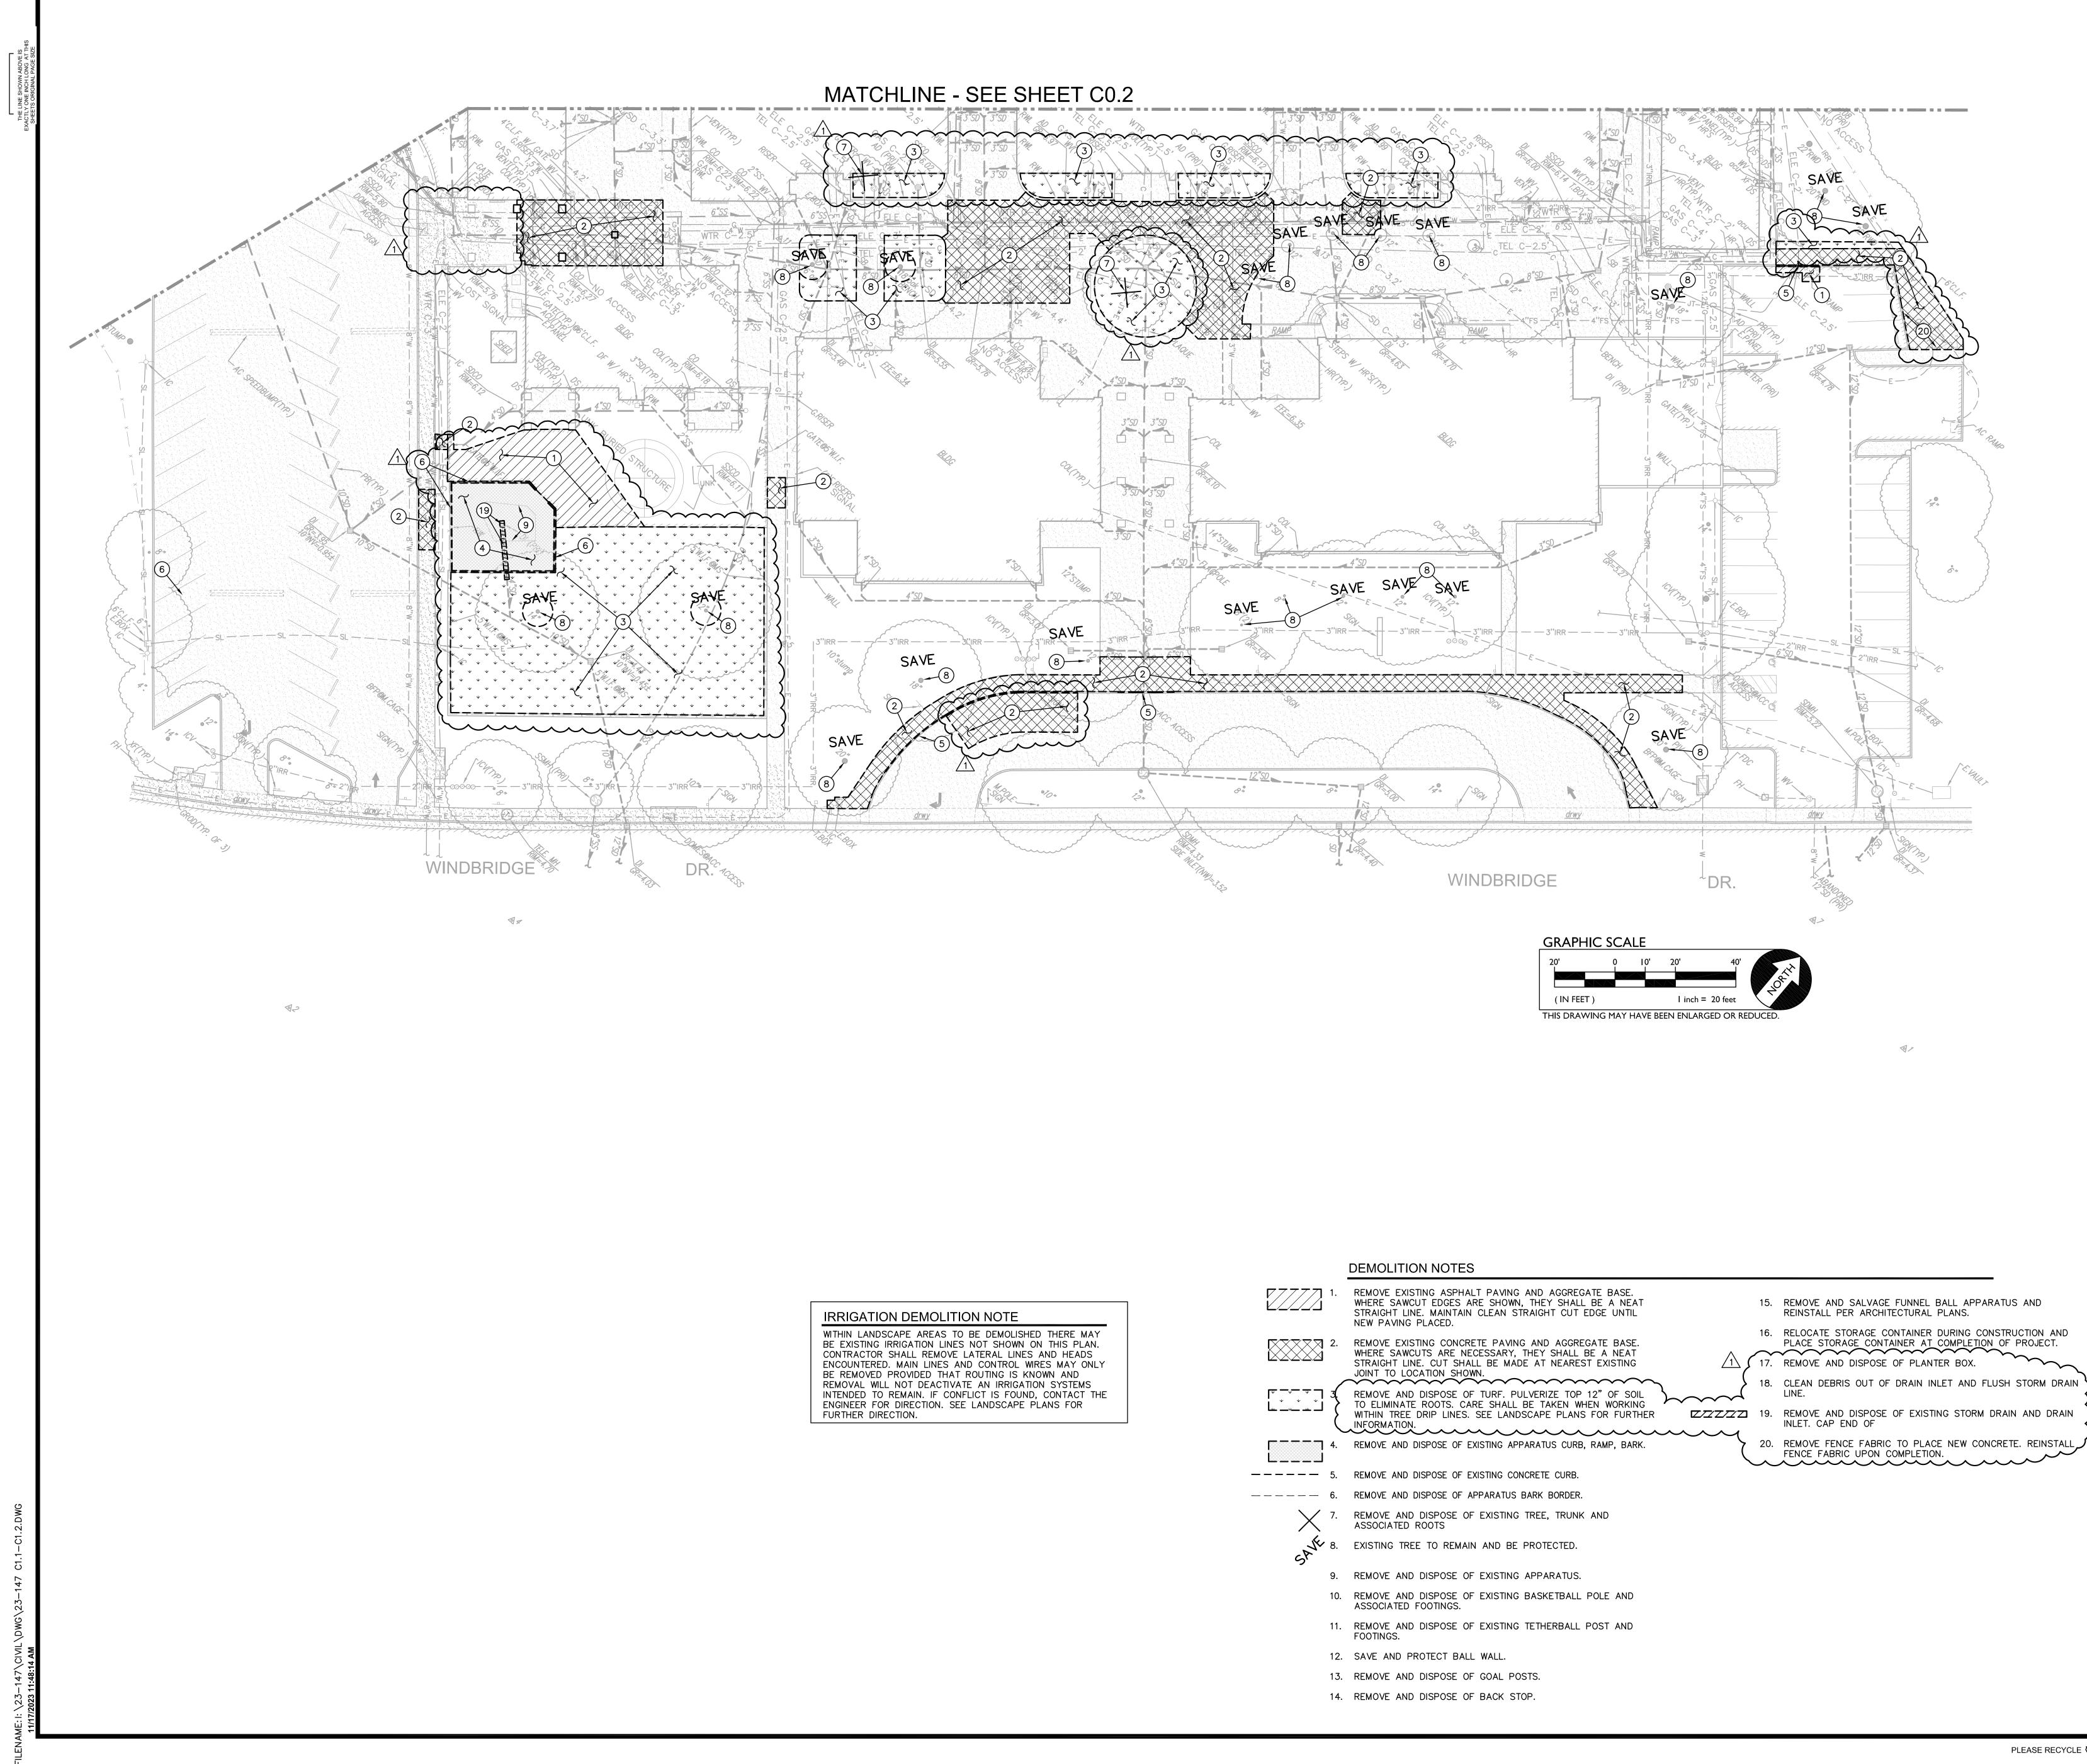
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BE EXISTING CONTRACTOR ENCOUNTERE BE REMOVED REMOVAL WIL INTENDED TC	IRRIGATION LINES N SHALL REMOVE LA D. MAIN LINES AND PROVIDED THAT RC L NOT DEACTIVATE REMAIN. IF CONFLIC R DIRECTION. SEE L	E DEMOLISHED THERE MAY OT SHOWN ON THIS PLAN. TERAL LINES AND HEADS CONTROL WIRES MAY ONLY UTING IS KNOWN AND AN IRRIGATION SYSTEMS CT IS FOUND, CONTACT THE ANDSCAPE PLANS FOR

		DEMOLITION
	1.	REMOVE EXISTIN WHERE SAWCUT STRAIGHT LINE. NEW PAVING PL
	2.	REMOVE EXISTIN WHERE SAWCUTS STRAIGHT LINE. JOINT TO LOCAT
 	E	REMOVE AND DI TO ELIMINATE R WITHIN TREE DR INFORMATION.
	4.	REMOVE AND DISF
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SAVE	8.	EXISTING TREE
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	10.	REMOVE AND DI ASSOCIATED FO
	11.	REMOVE AND DI FOOTINGS.
	12.	SAVE AND PROT
	13.	REMOVE AND DI



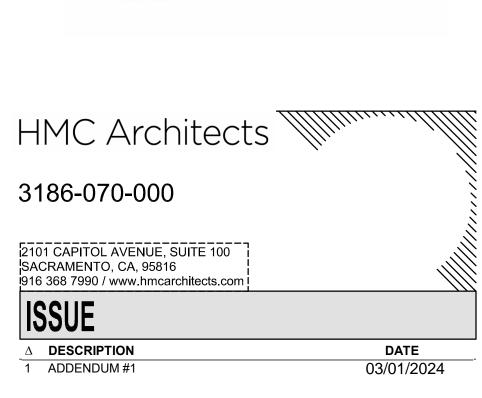

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PROJECT:

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PARTIAL DEMOLITION PLAN

MATSUYAMA ELEMENTARY SCHOOL MODERNIZATION

CLIENT PROJ NO: -

MATSUYAMA ELEMENTARY SCHOOL SACRMANETO, CA 95831


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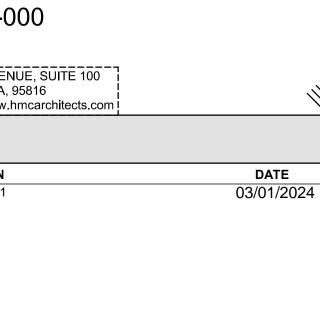



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FACILITY:

7680 WINDBRIDGE DR.

PROJECT: MATSUYAMA ELEMENTARY SCHOOL MODERNIZATION

SHEET NAME:

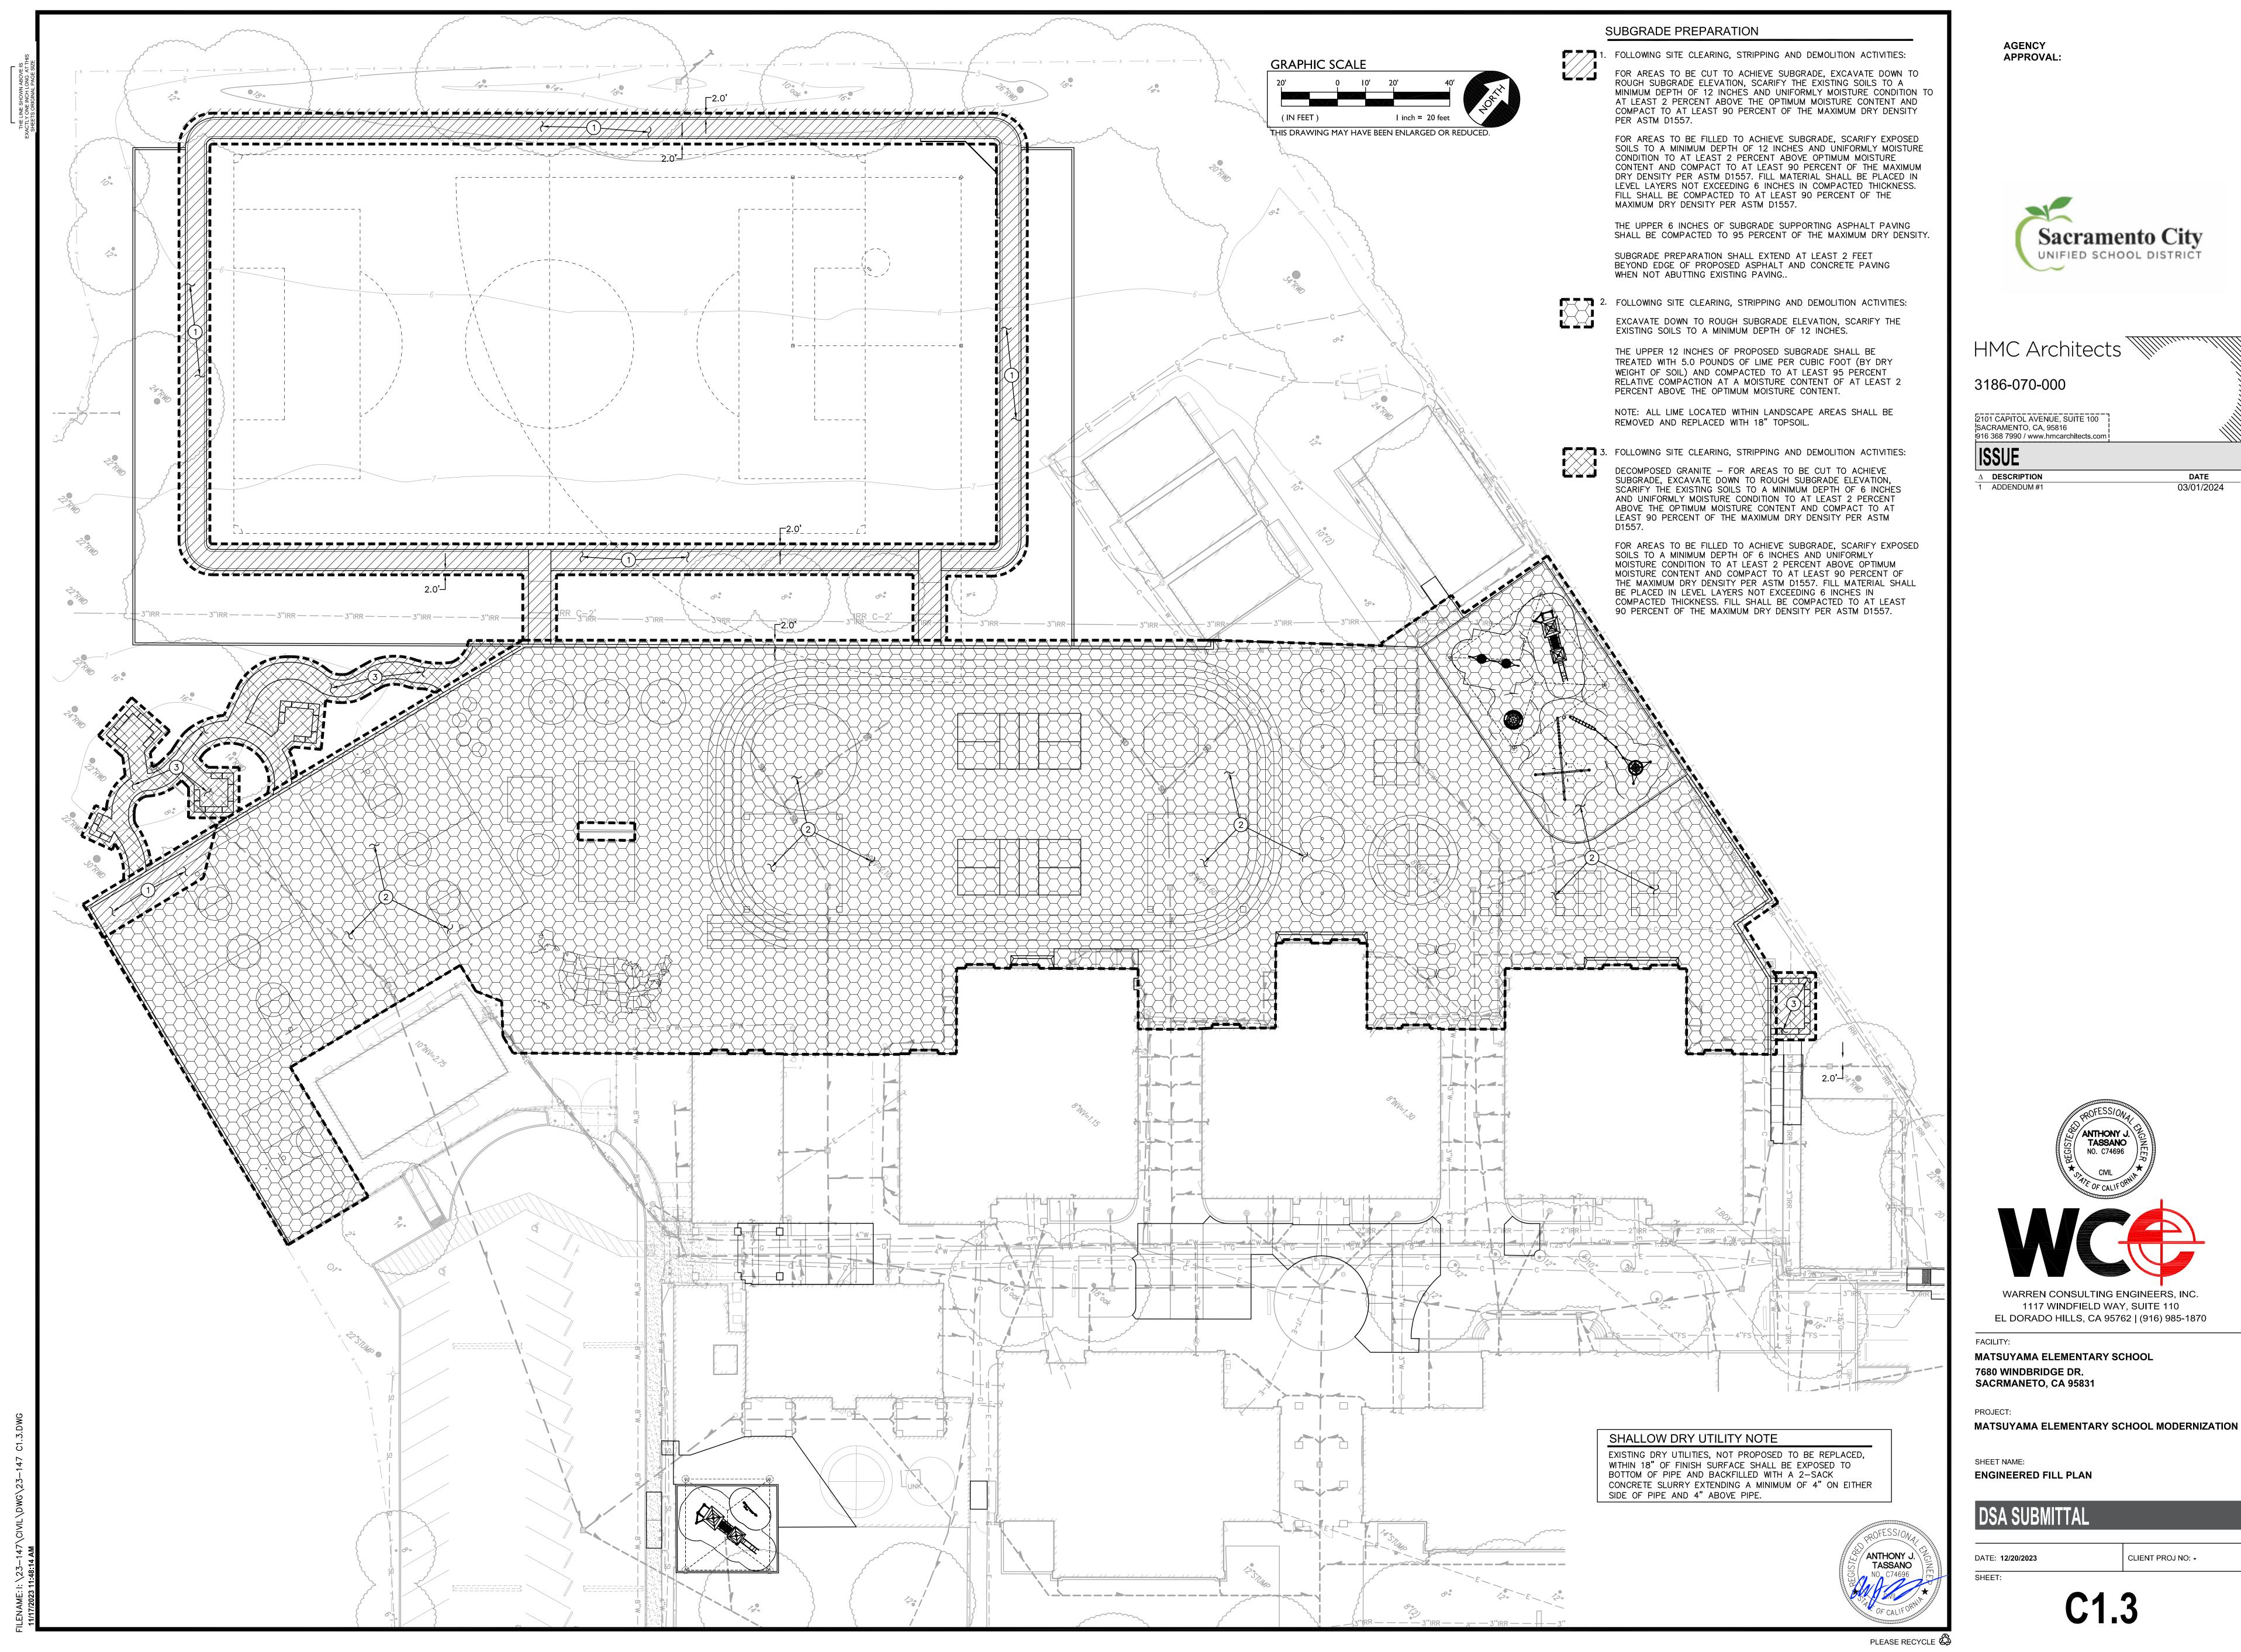
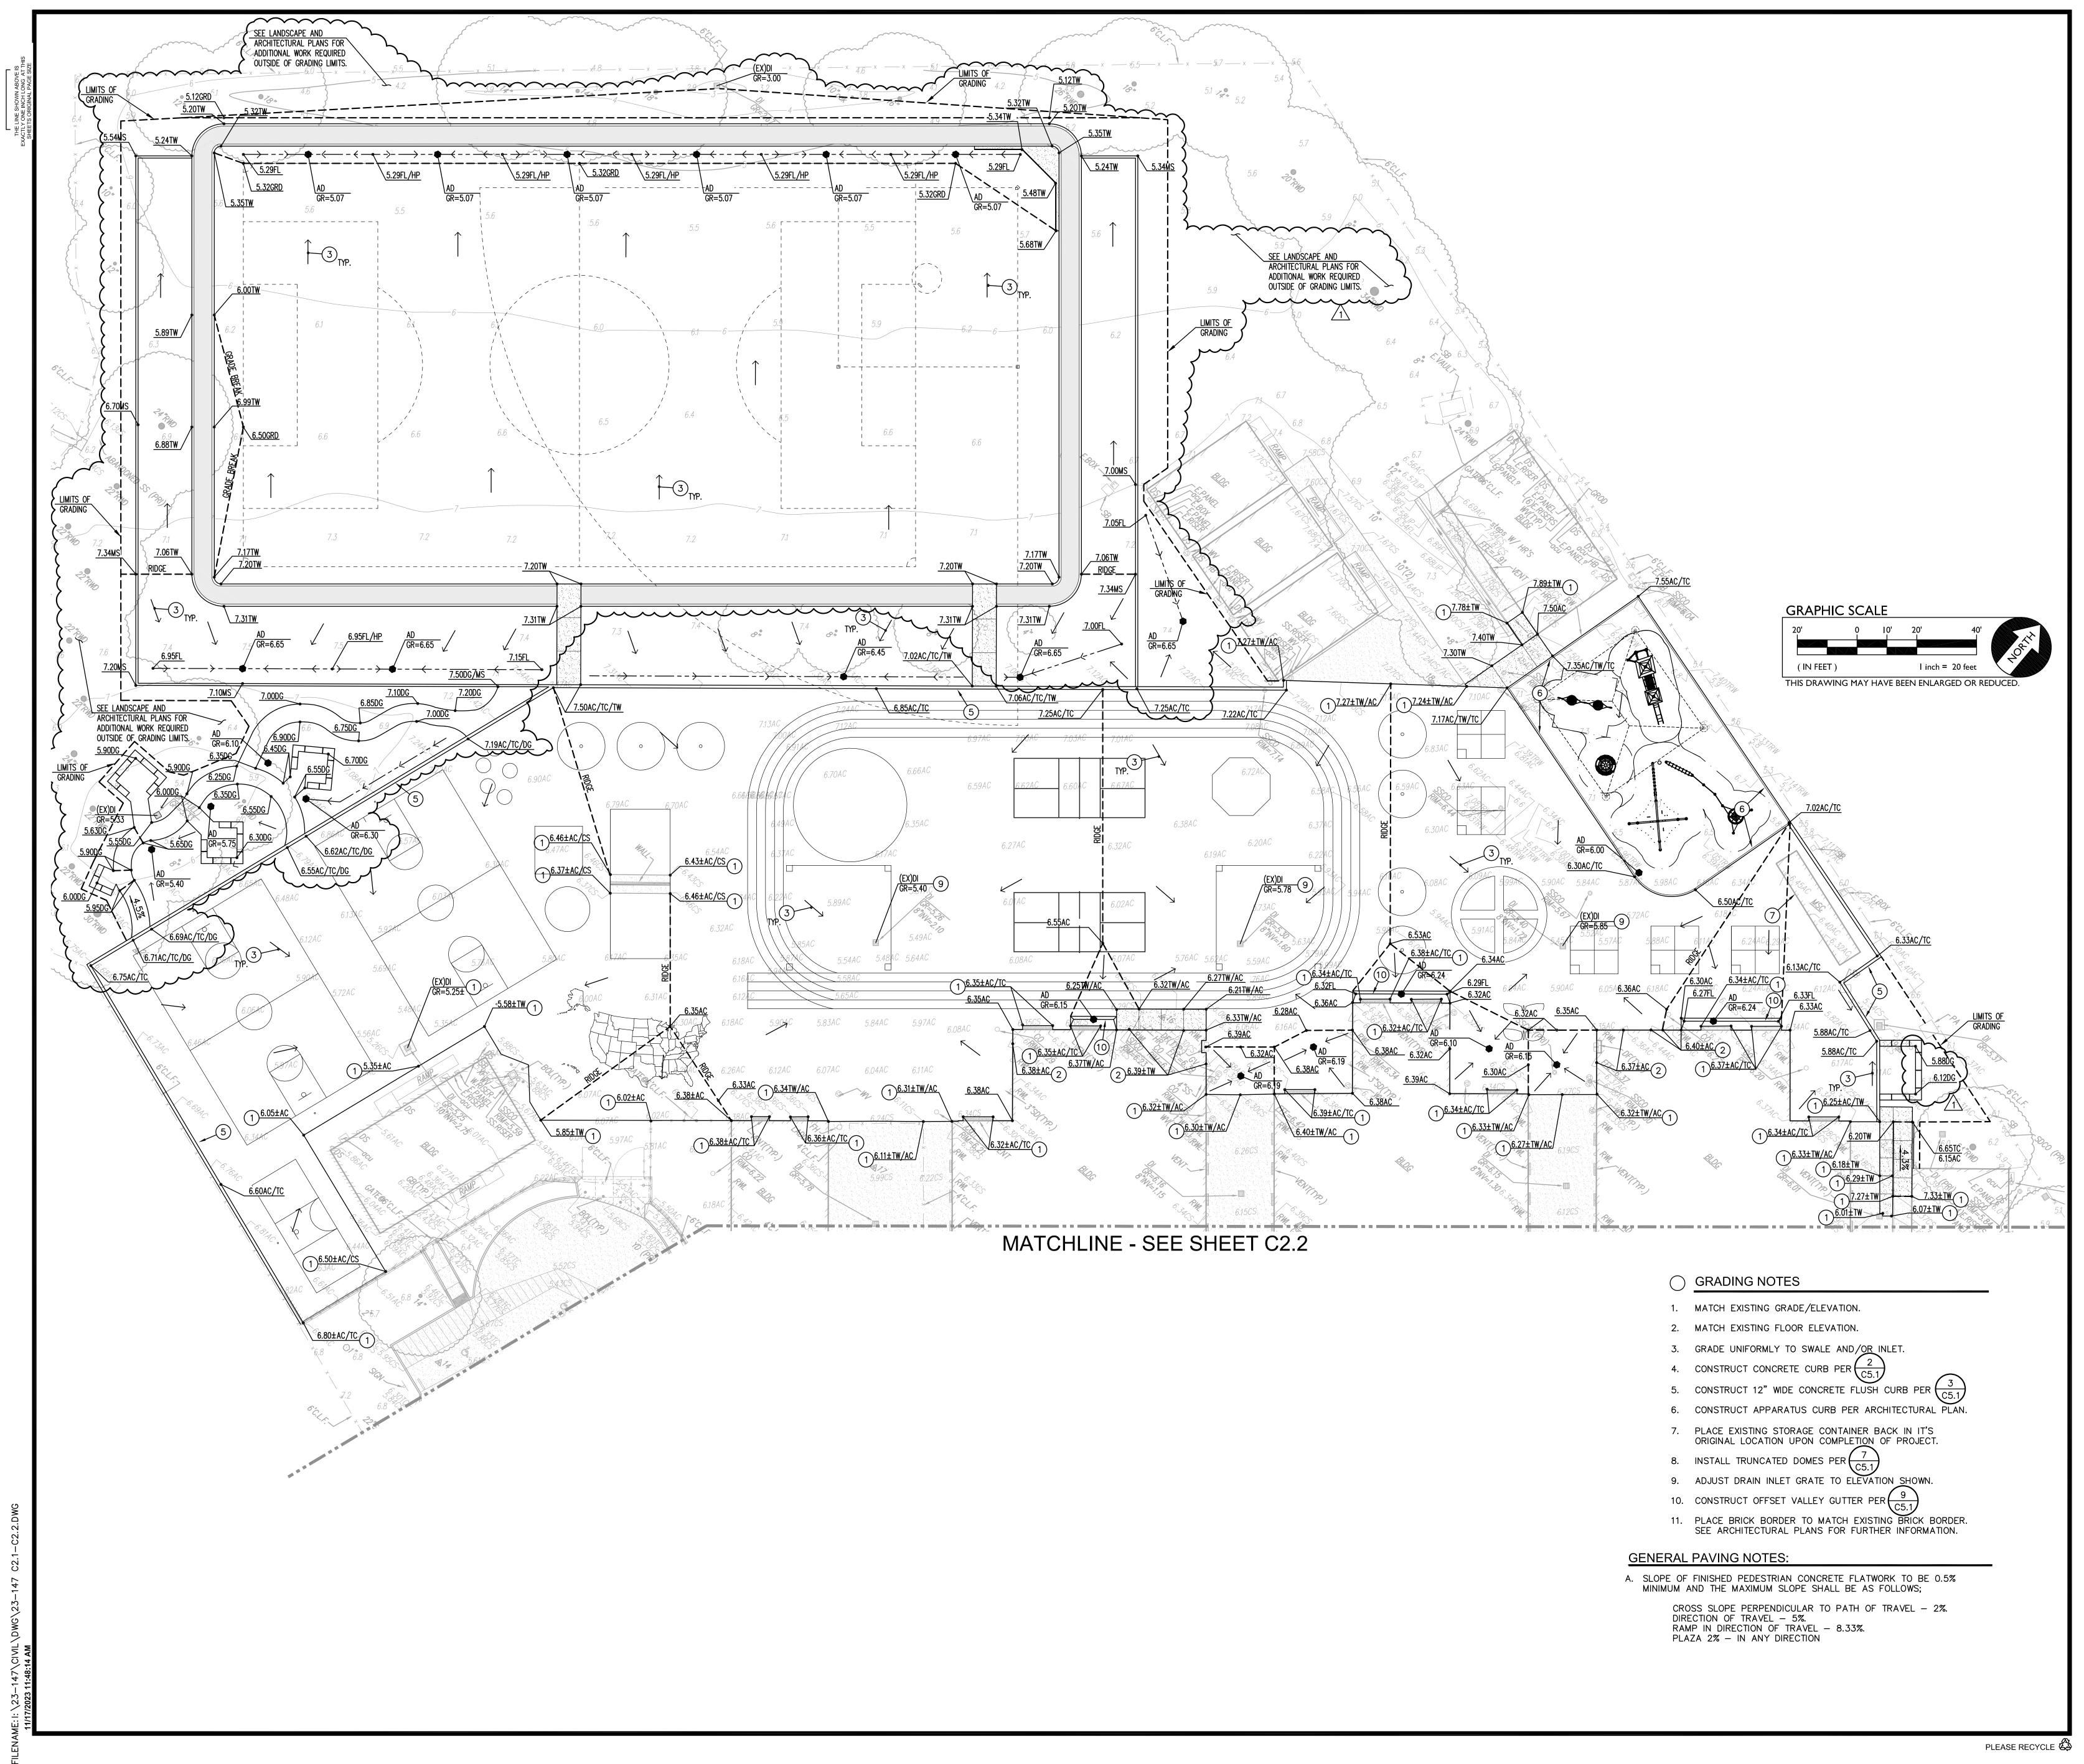
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PARTIAL GRADING PLAN

MATSUYAMA ELEMENTARY SCHOOL SACRMANETO, CA 95831

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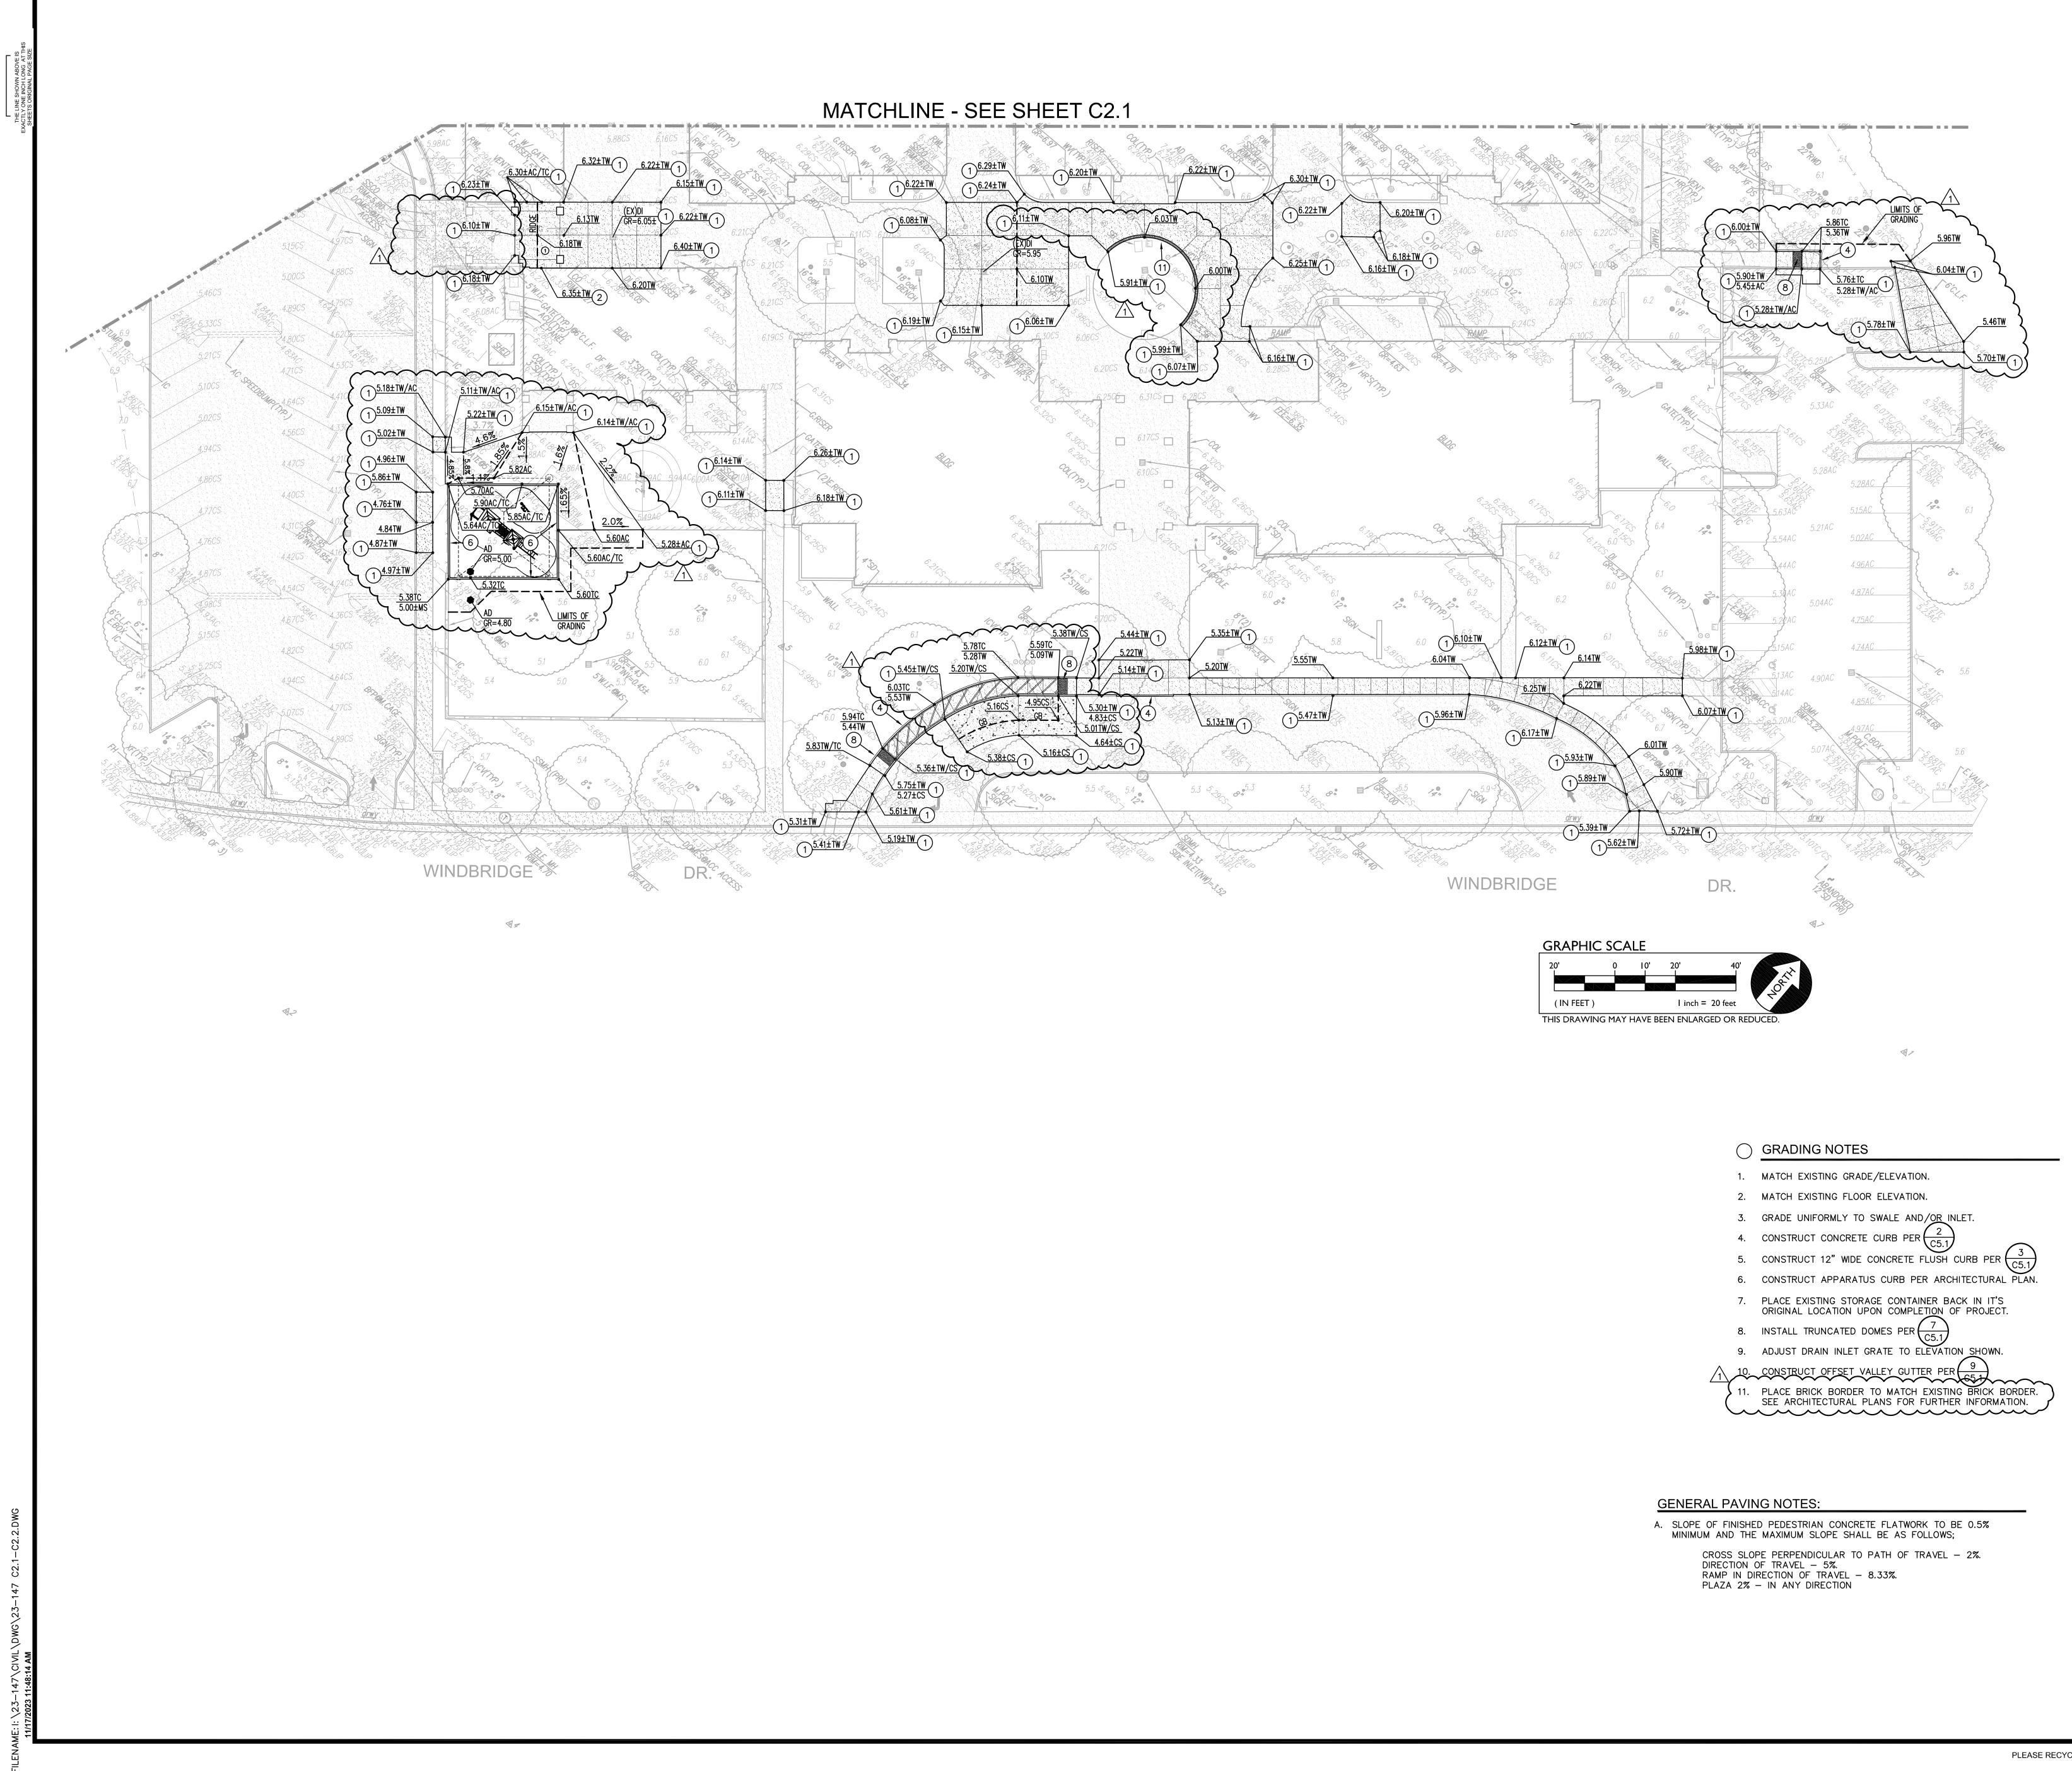


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SHEET NAME: PARTIAL GRADING PLAN



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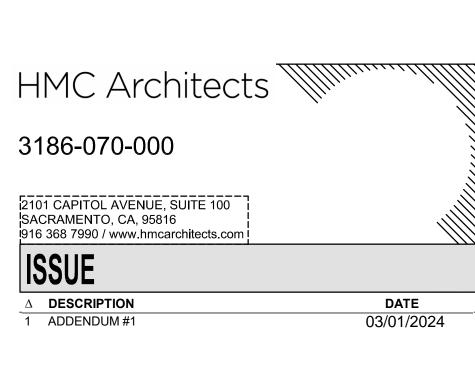
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MATSUYAMA ELEMENTARY SCHOOL MODERNIZATION

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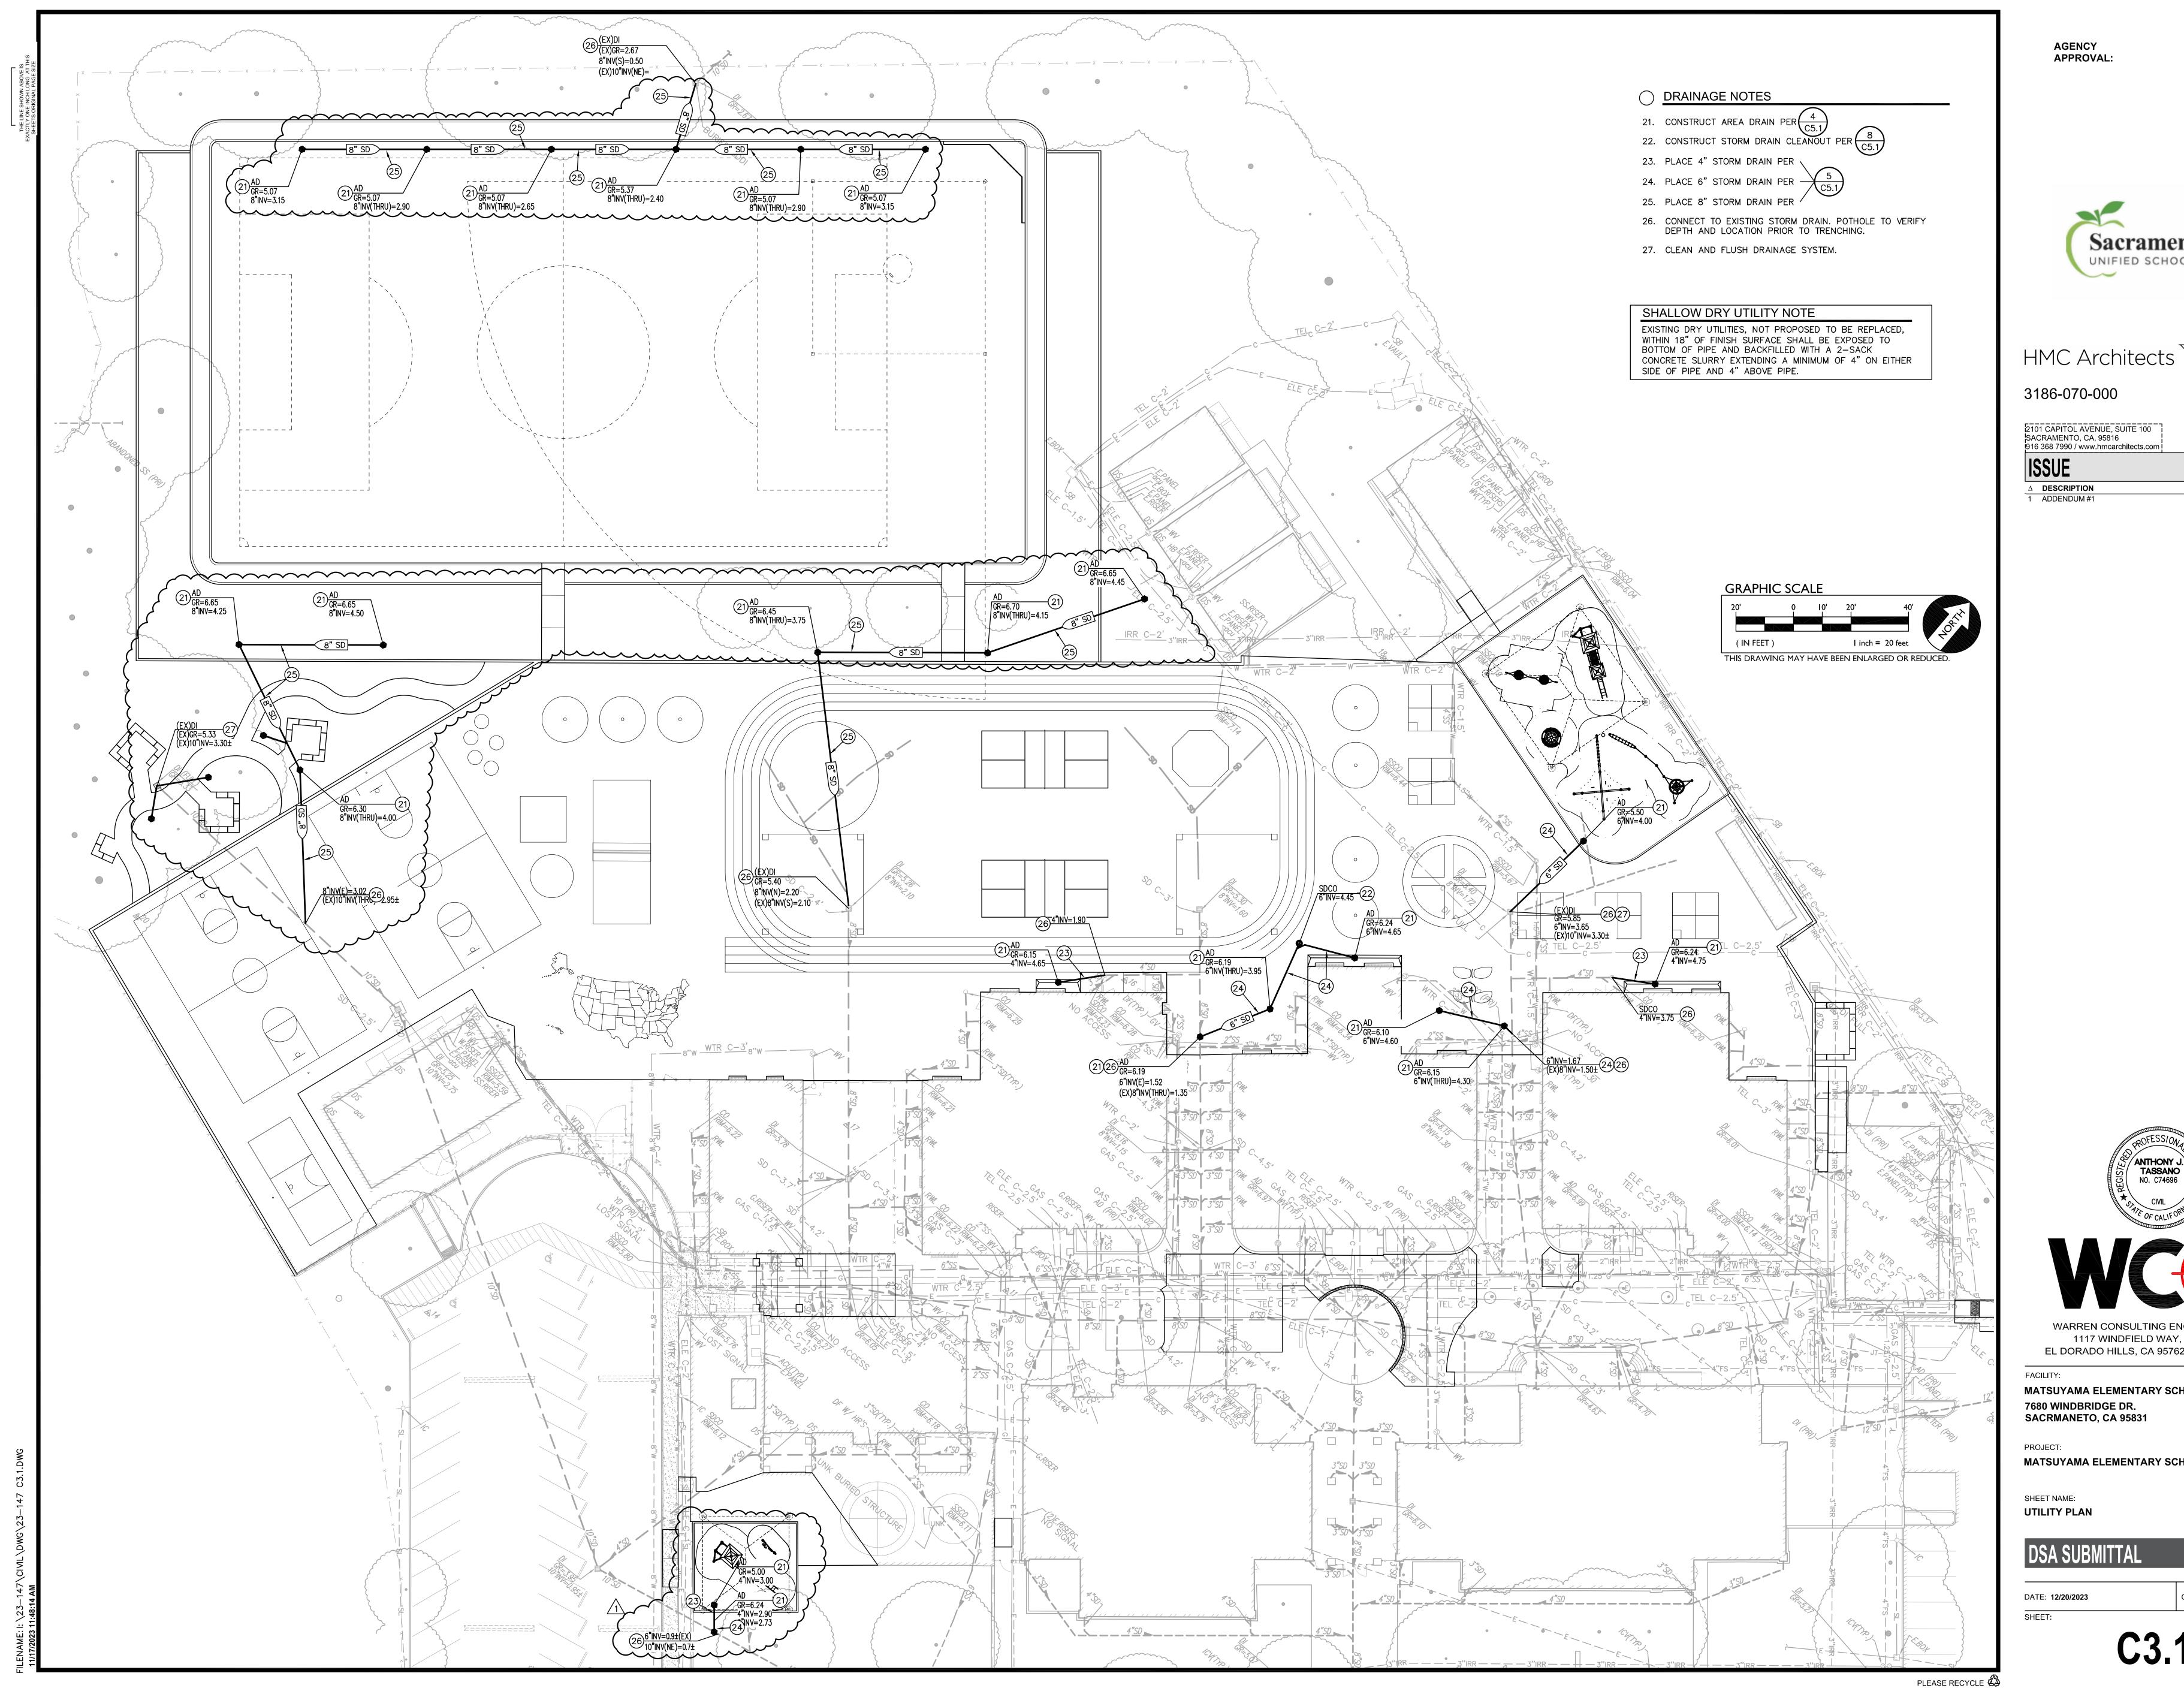
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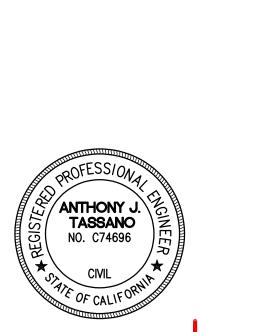
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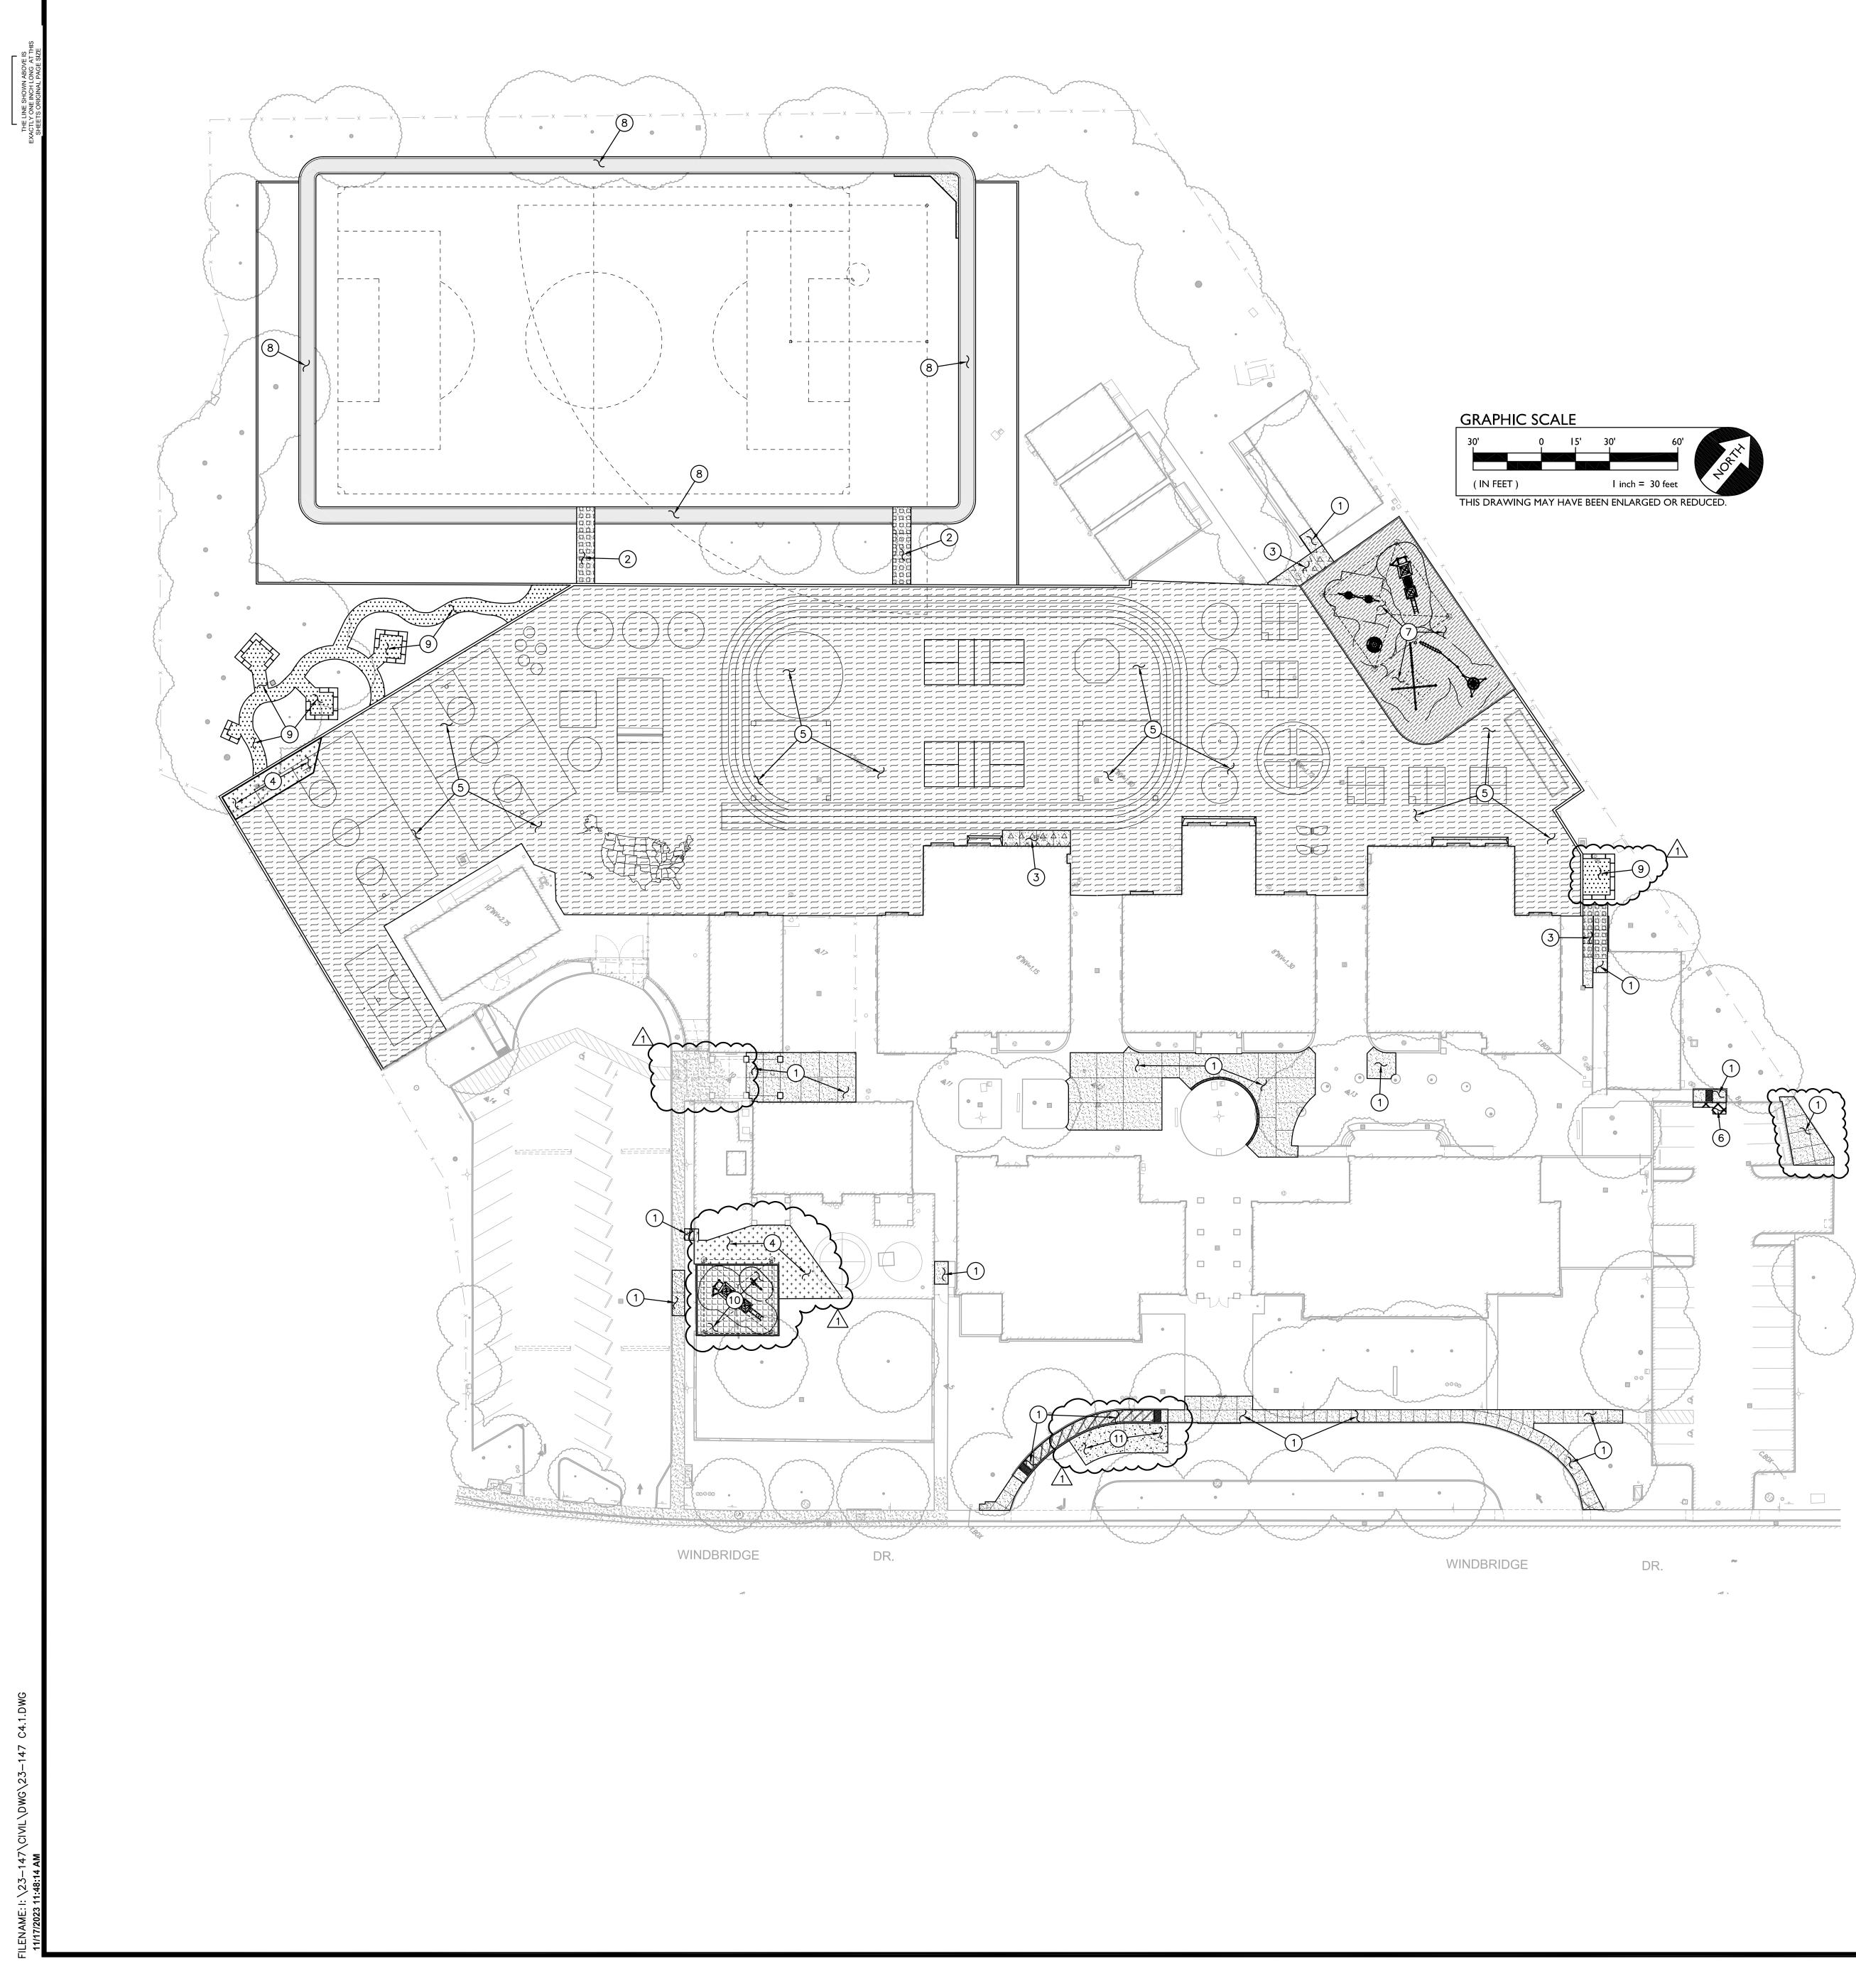
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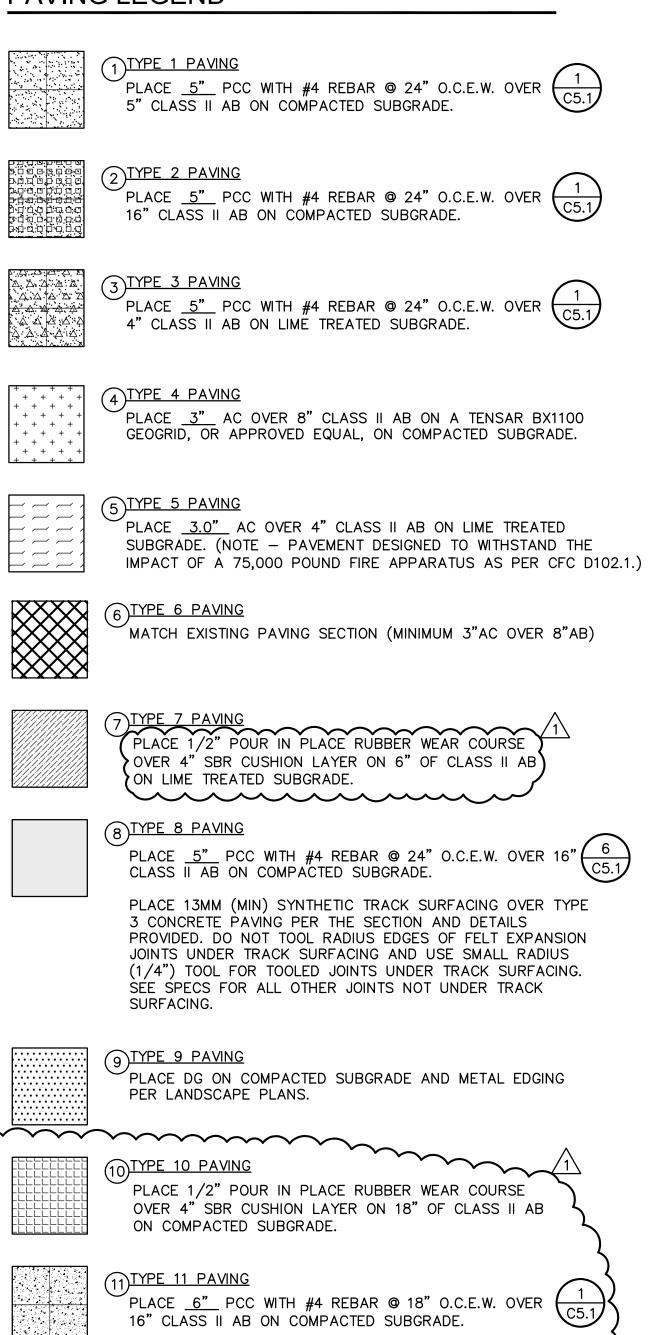


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ANTHONY V TASSANO

FACILITY: 7680 WINDBRIDGE DR.

PROJECT: MATSUYAMA ELEMENTARY SCHOOL MODERNIZATION

SHEET NAME: **PAVING PLAN**



DATE: 12/20/2023 SHEET:



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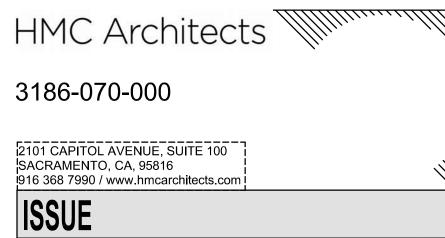
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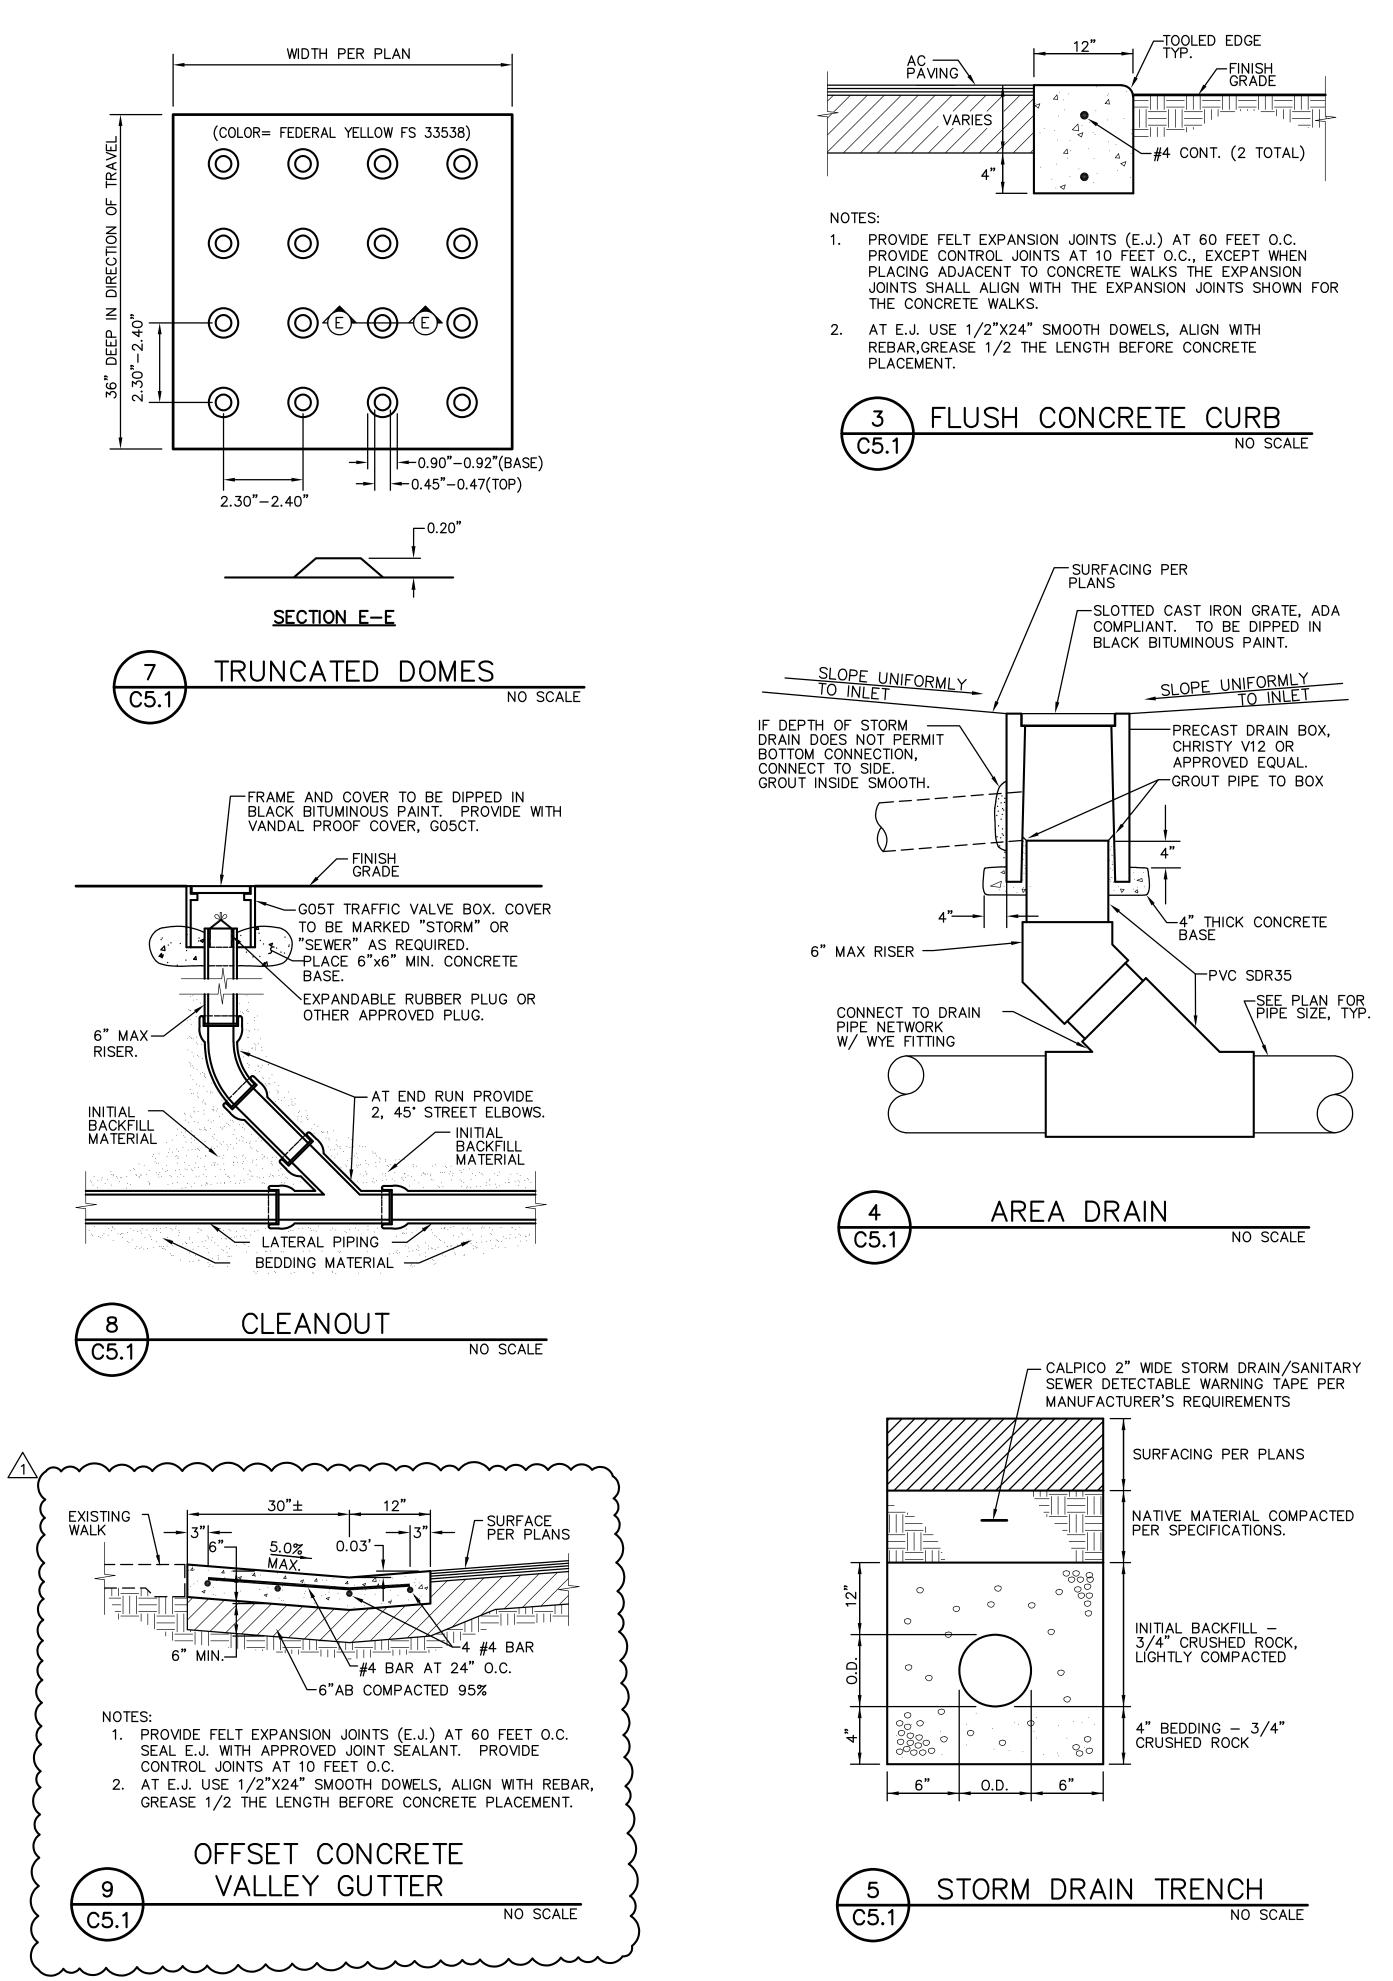



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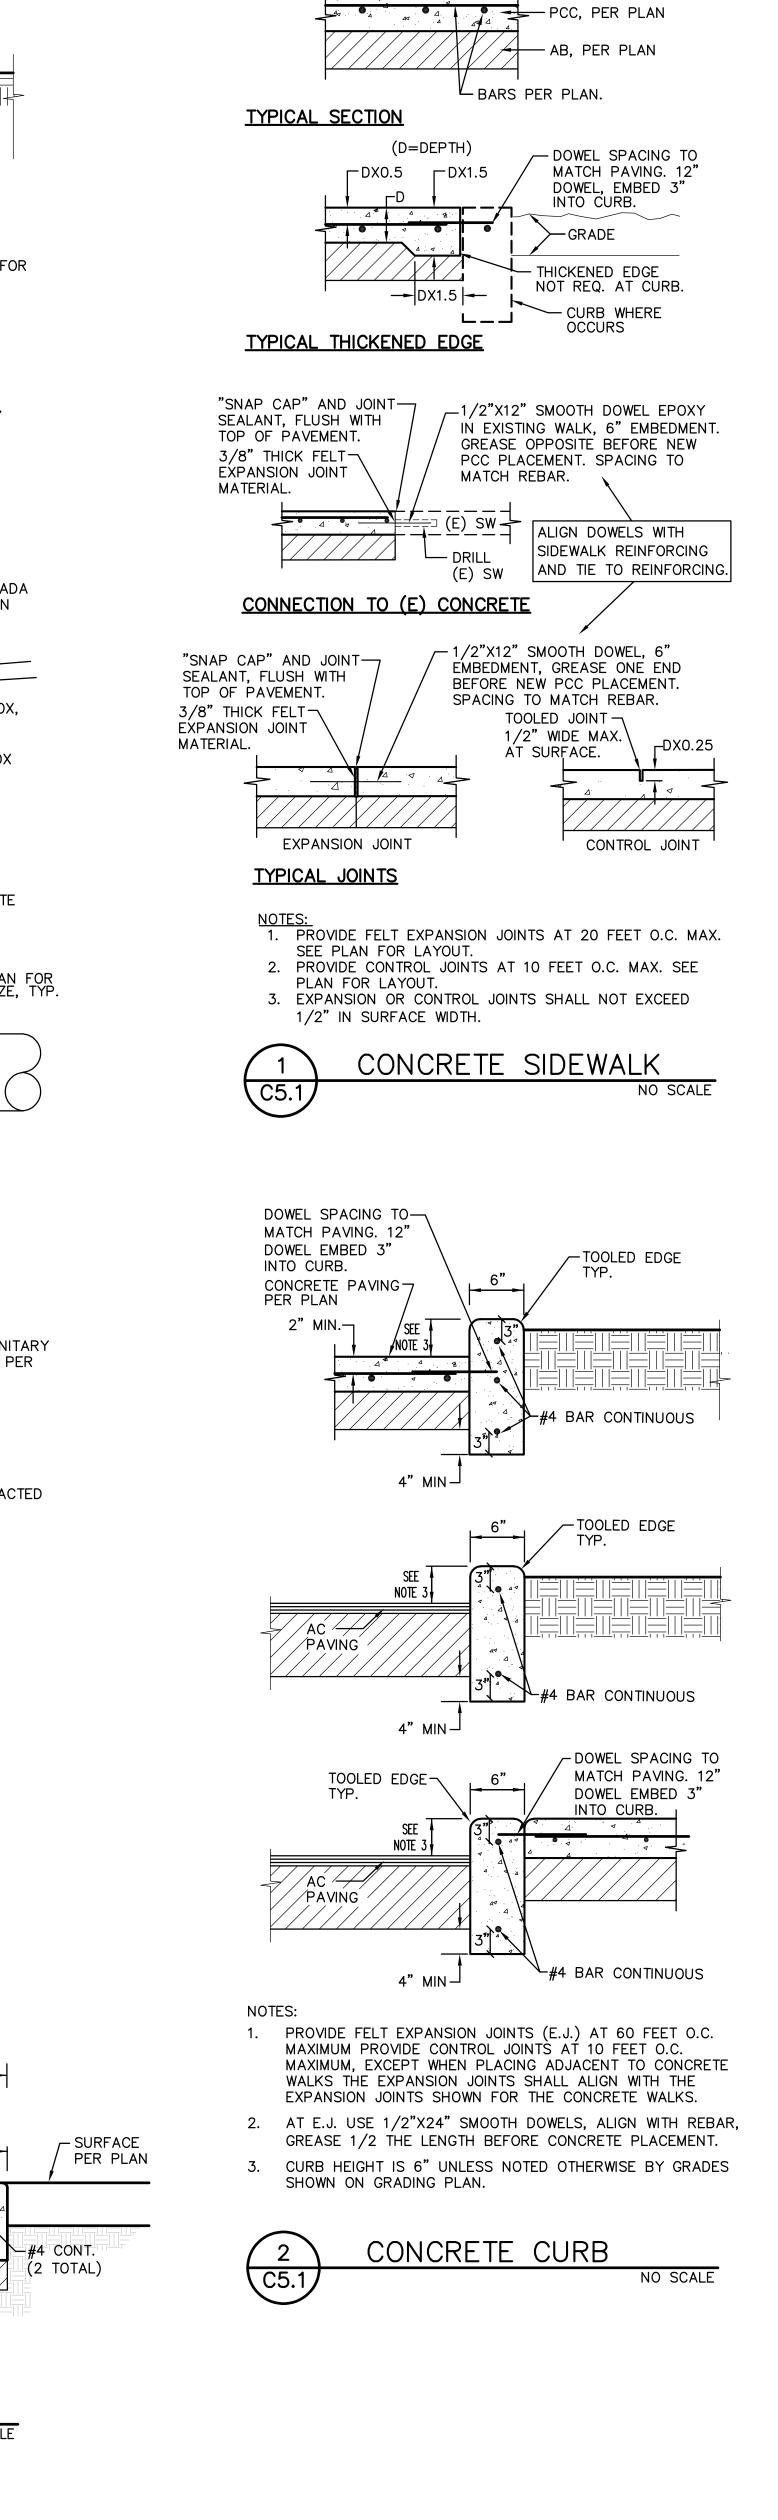
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PROJECT: MATSUYAMA ELEMENTARY SCHOOL MODERNIZATION


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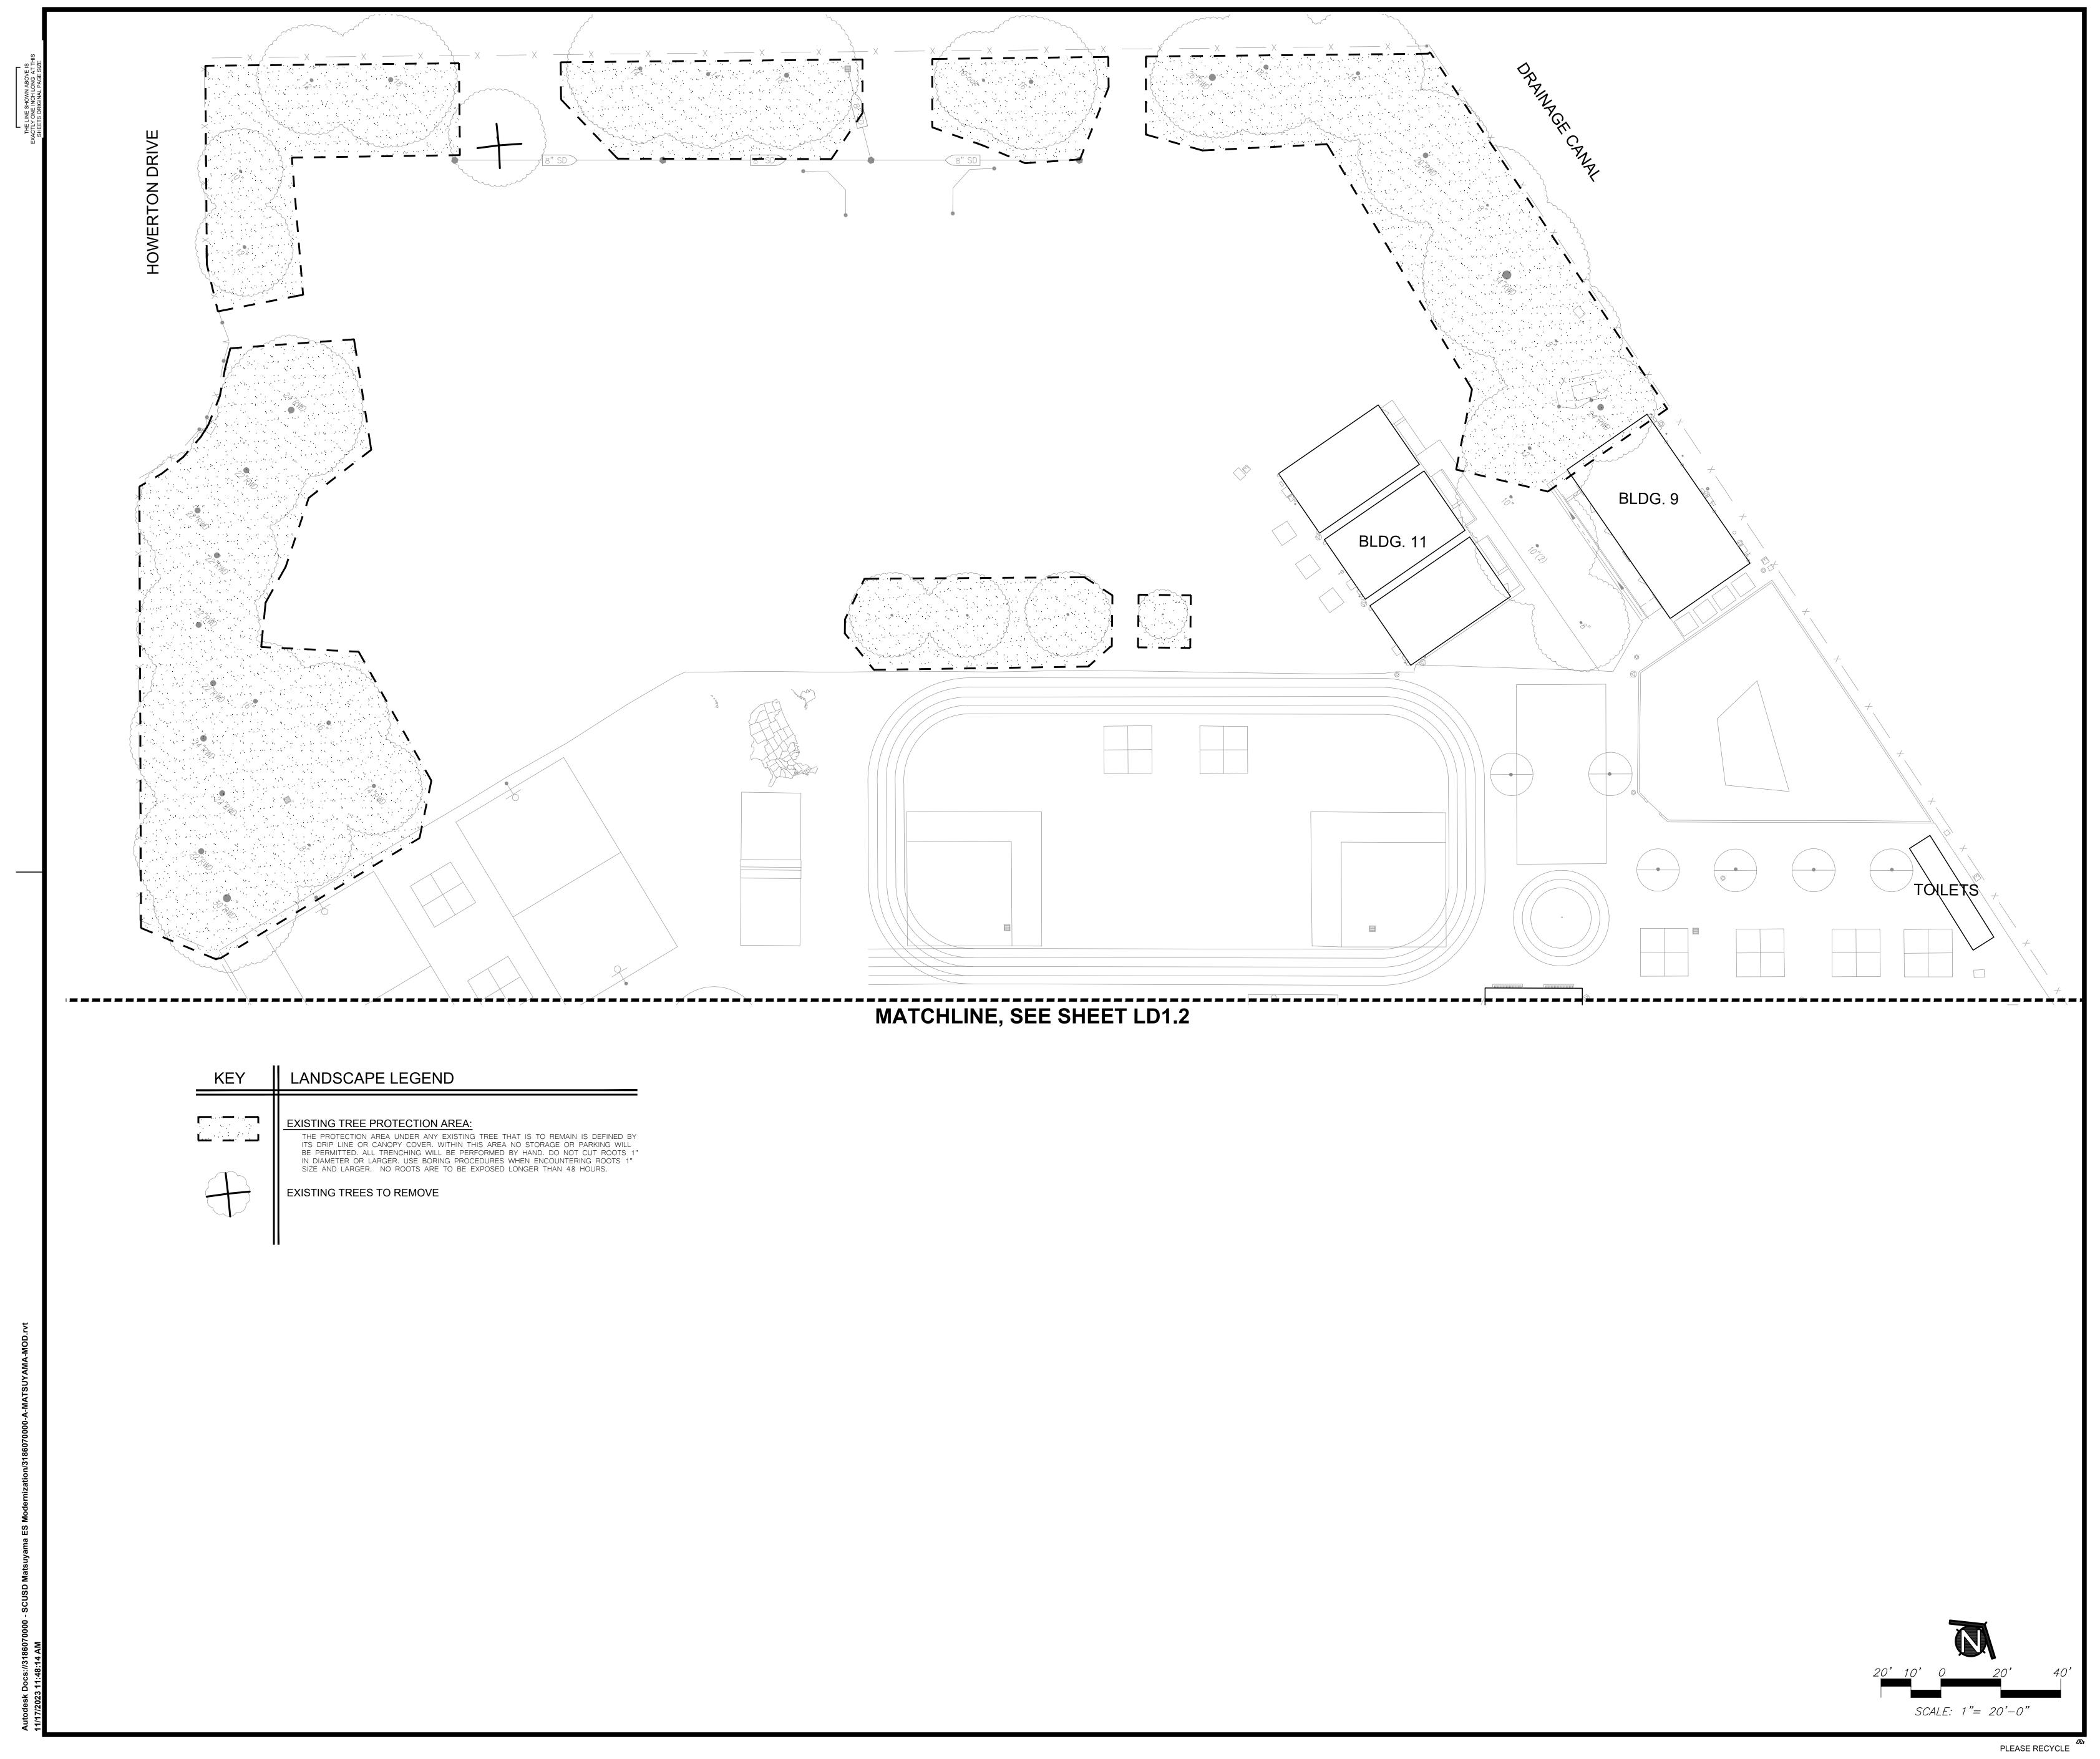
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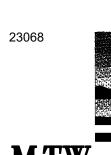
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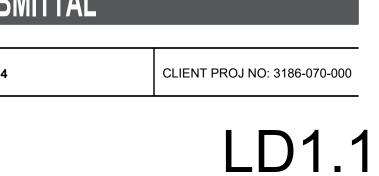
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PROJECT: MATSUYAMA ELEMENTARY SCHOOL MODERNIZATION

SHEET NAME:



DATE: 02/27/2024 SHEET:

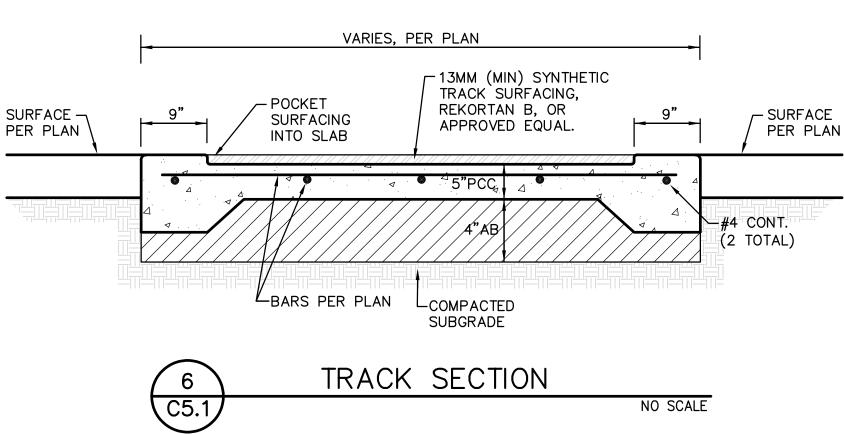

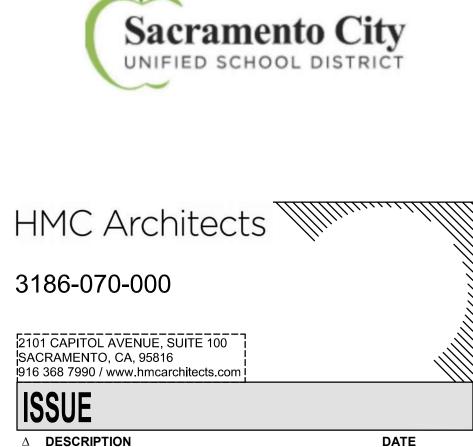TREE PROTECTION PLAN

MATSUYAMA ELEMENTARY SCHOOL 7680 WINDBRIDGE DR. SACRMANETO, CA 95831




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TREE PROTECTION PLAN

MATSUYAMA ELEMENTARY SCHOOL SACRMANETO, CA 95831

Peter D. Larimer




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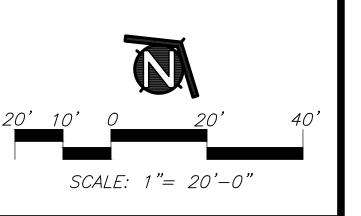


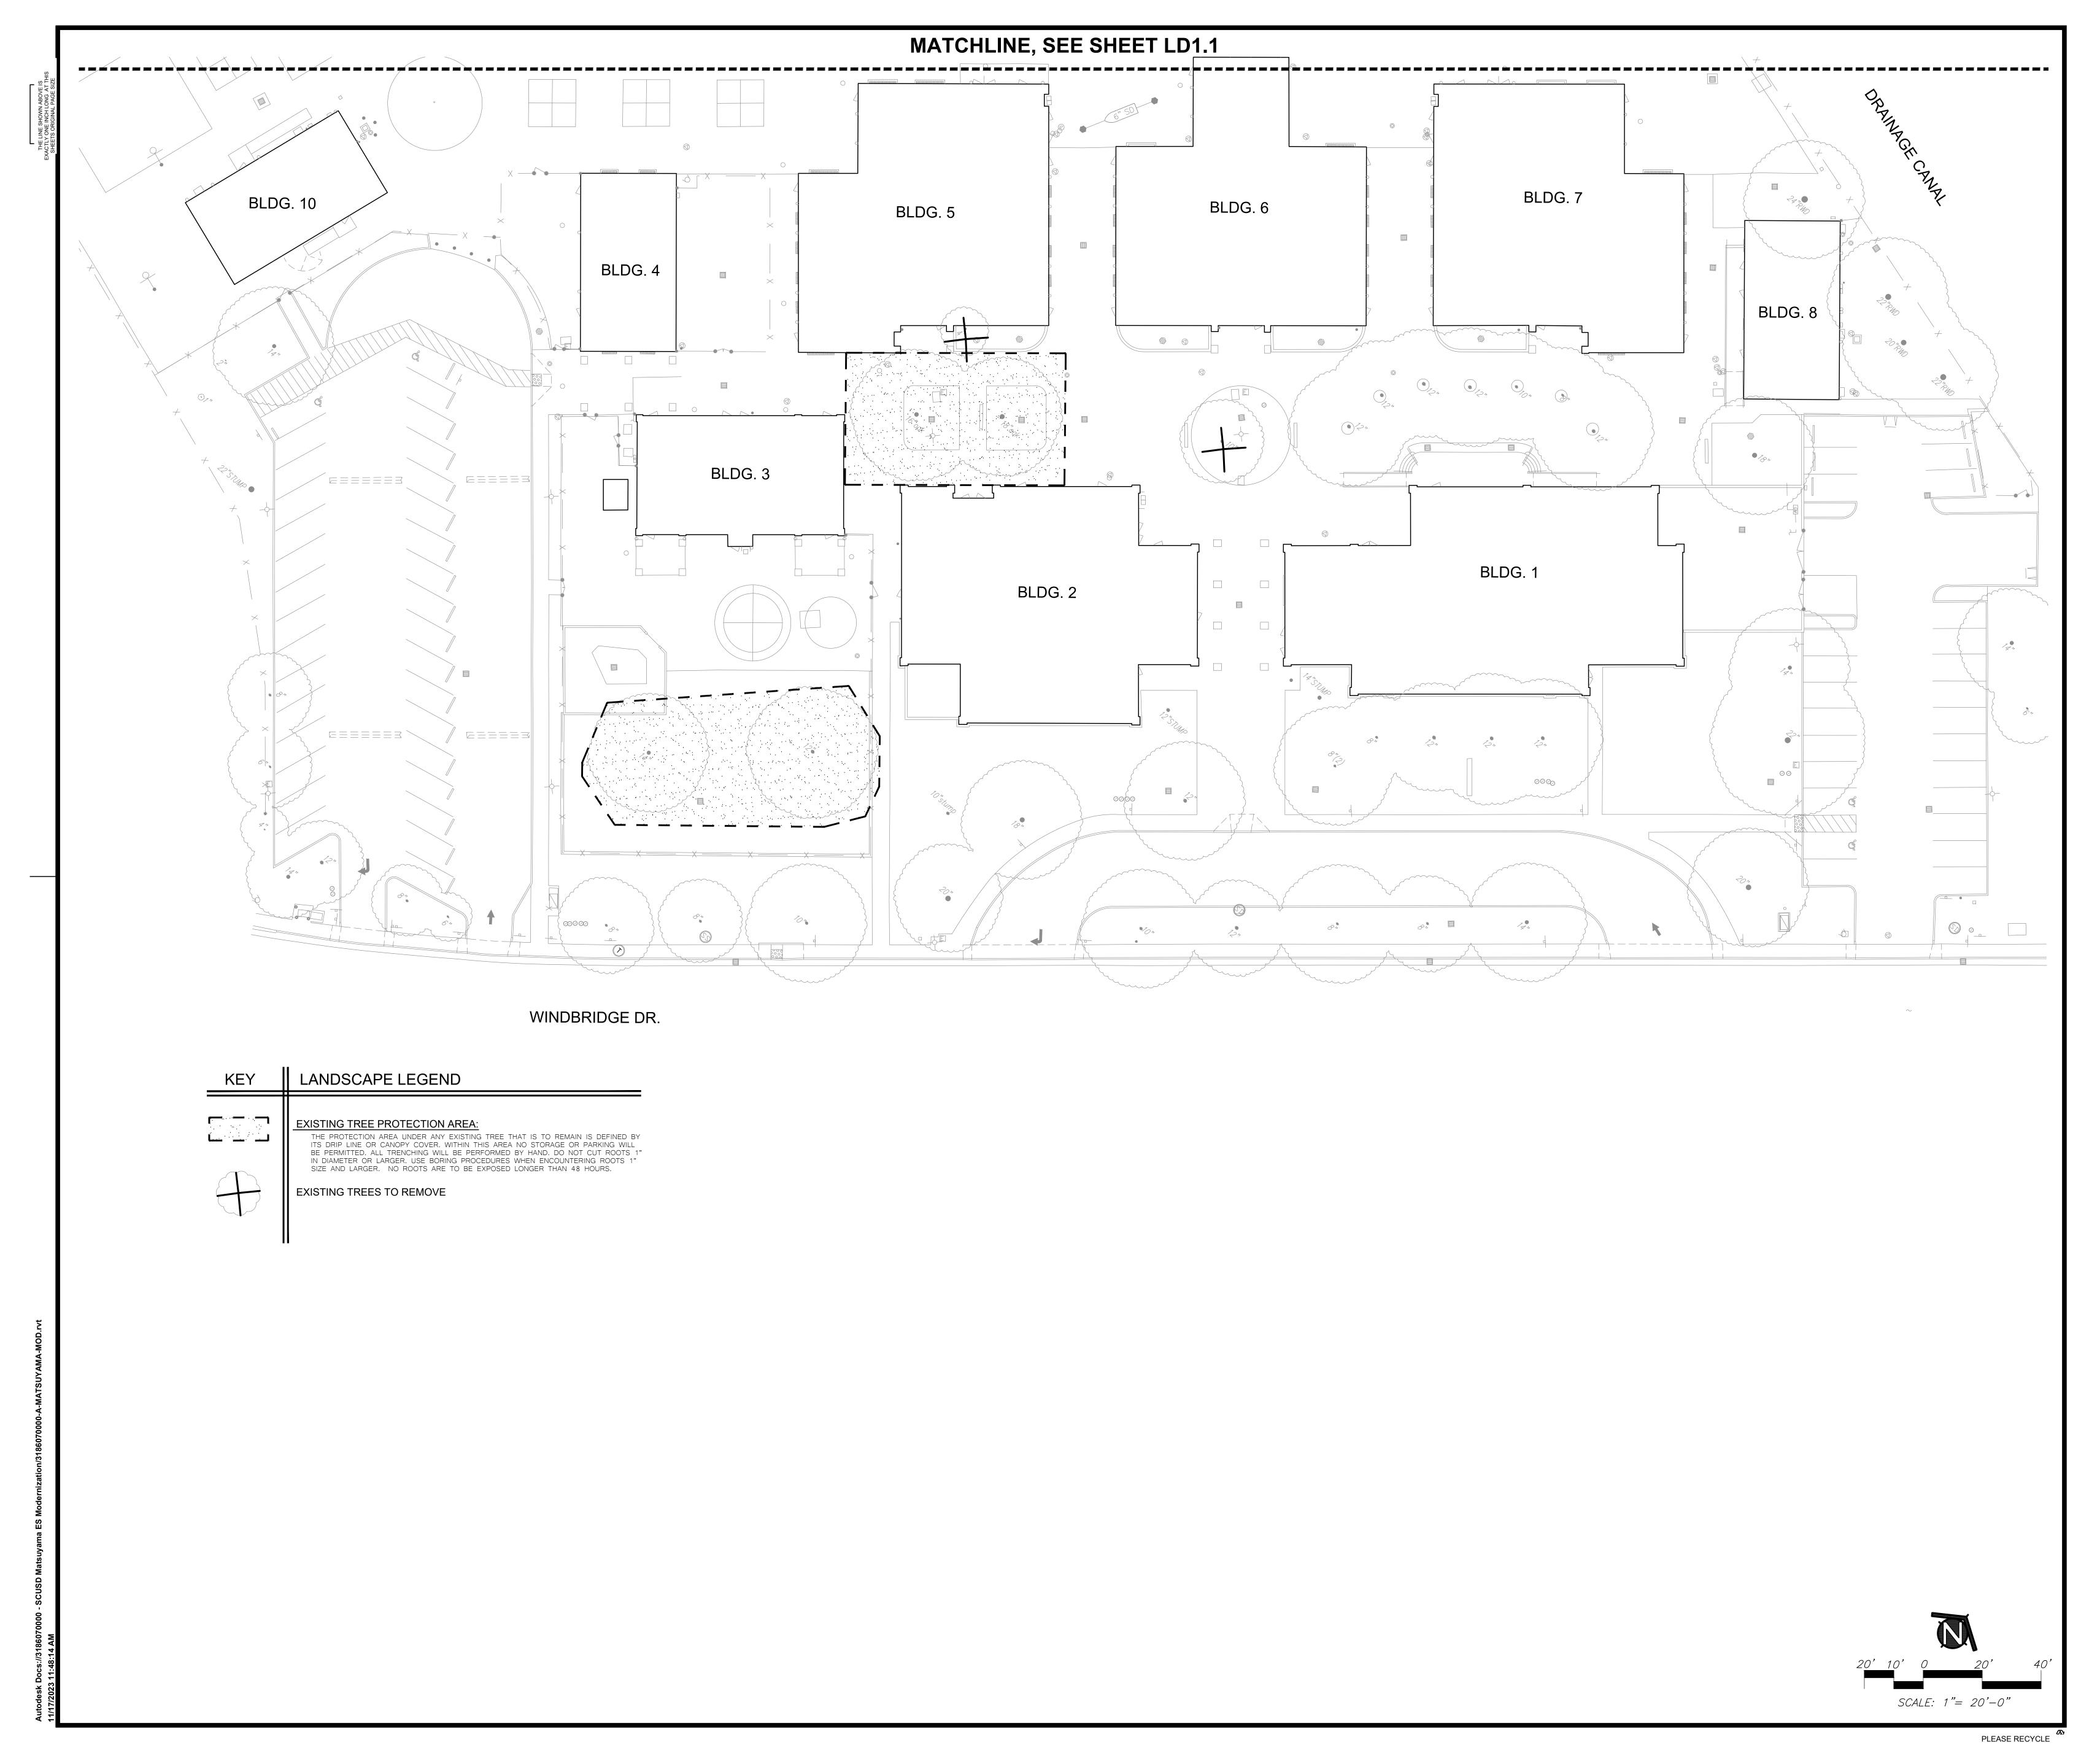


	EXISTING TREE TO REMAIN
	EXISTING TREES TO REMOVE
\boxtimes	EXISTING BOOSTER PUMP TO REMOVE
	EXISTING IRRIGATION CONTROLLER TO BE REMOVED
\otimes	EXISTING REDUCED PRESSURE BACKFLOW PREVENTION DEVICE
С,	EXISTING AUTOMATIC CONTROL VALVE TO REPLACE
¢	EXISTING AUTOMATIC CONTROL VALVE TO REMOVE
0	EXISTING SPRINKLER HEAD TO REMAIN
\bigotimes	EXISTING SPRINKLER HEAD TO REMOVE
	EXISTING IRRIGATION MAINLINE TO REMAIN
 	EXISTING IRRIGATION MAINLINE TO REMOVE
	EXISTING LATERAL LINE TO REMAIN
	EXISTING LATERAL LINE TO REMOVE
A1	- INDICATES CONTROL VALVE AND STATION NUMBER
2"	INDICATES CONTROL VALVE SIZE
-	

Manunia manuna ma Manuna manun

- REMAIN IN ORDER TO PROVIDE WATER TO THE EXISTING LANDSCAPE TO REMAIN. 3. CONTRACTOR TO REMOVE ALL EXISTING PIPE AND SPRINKLER HEADS WHEN THEY ARE IN NEW
- PLANTING AREAS. 4. CONTRACTOR TO RESTORE AND REPAIR ANY EXISTING SPRINKLER IRRIGATION SYSTEM OR
- EXISTING LANDSCAPE WHICH IS IN AREAS TO REMAIN THAT IS DAMAGED BY NEW WORK.
- 5. ALL WORK TO EXISTING SPRINKLER IRRIGATION SYSTEM TO BE COMPLETED PRIOR TO SITE DEMOLITION.

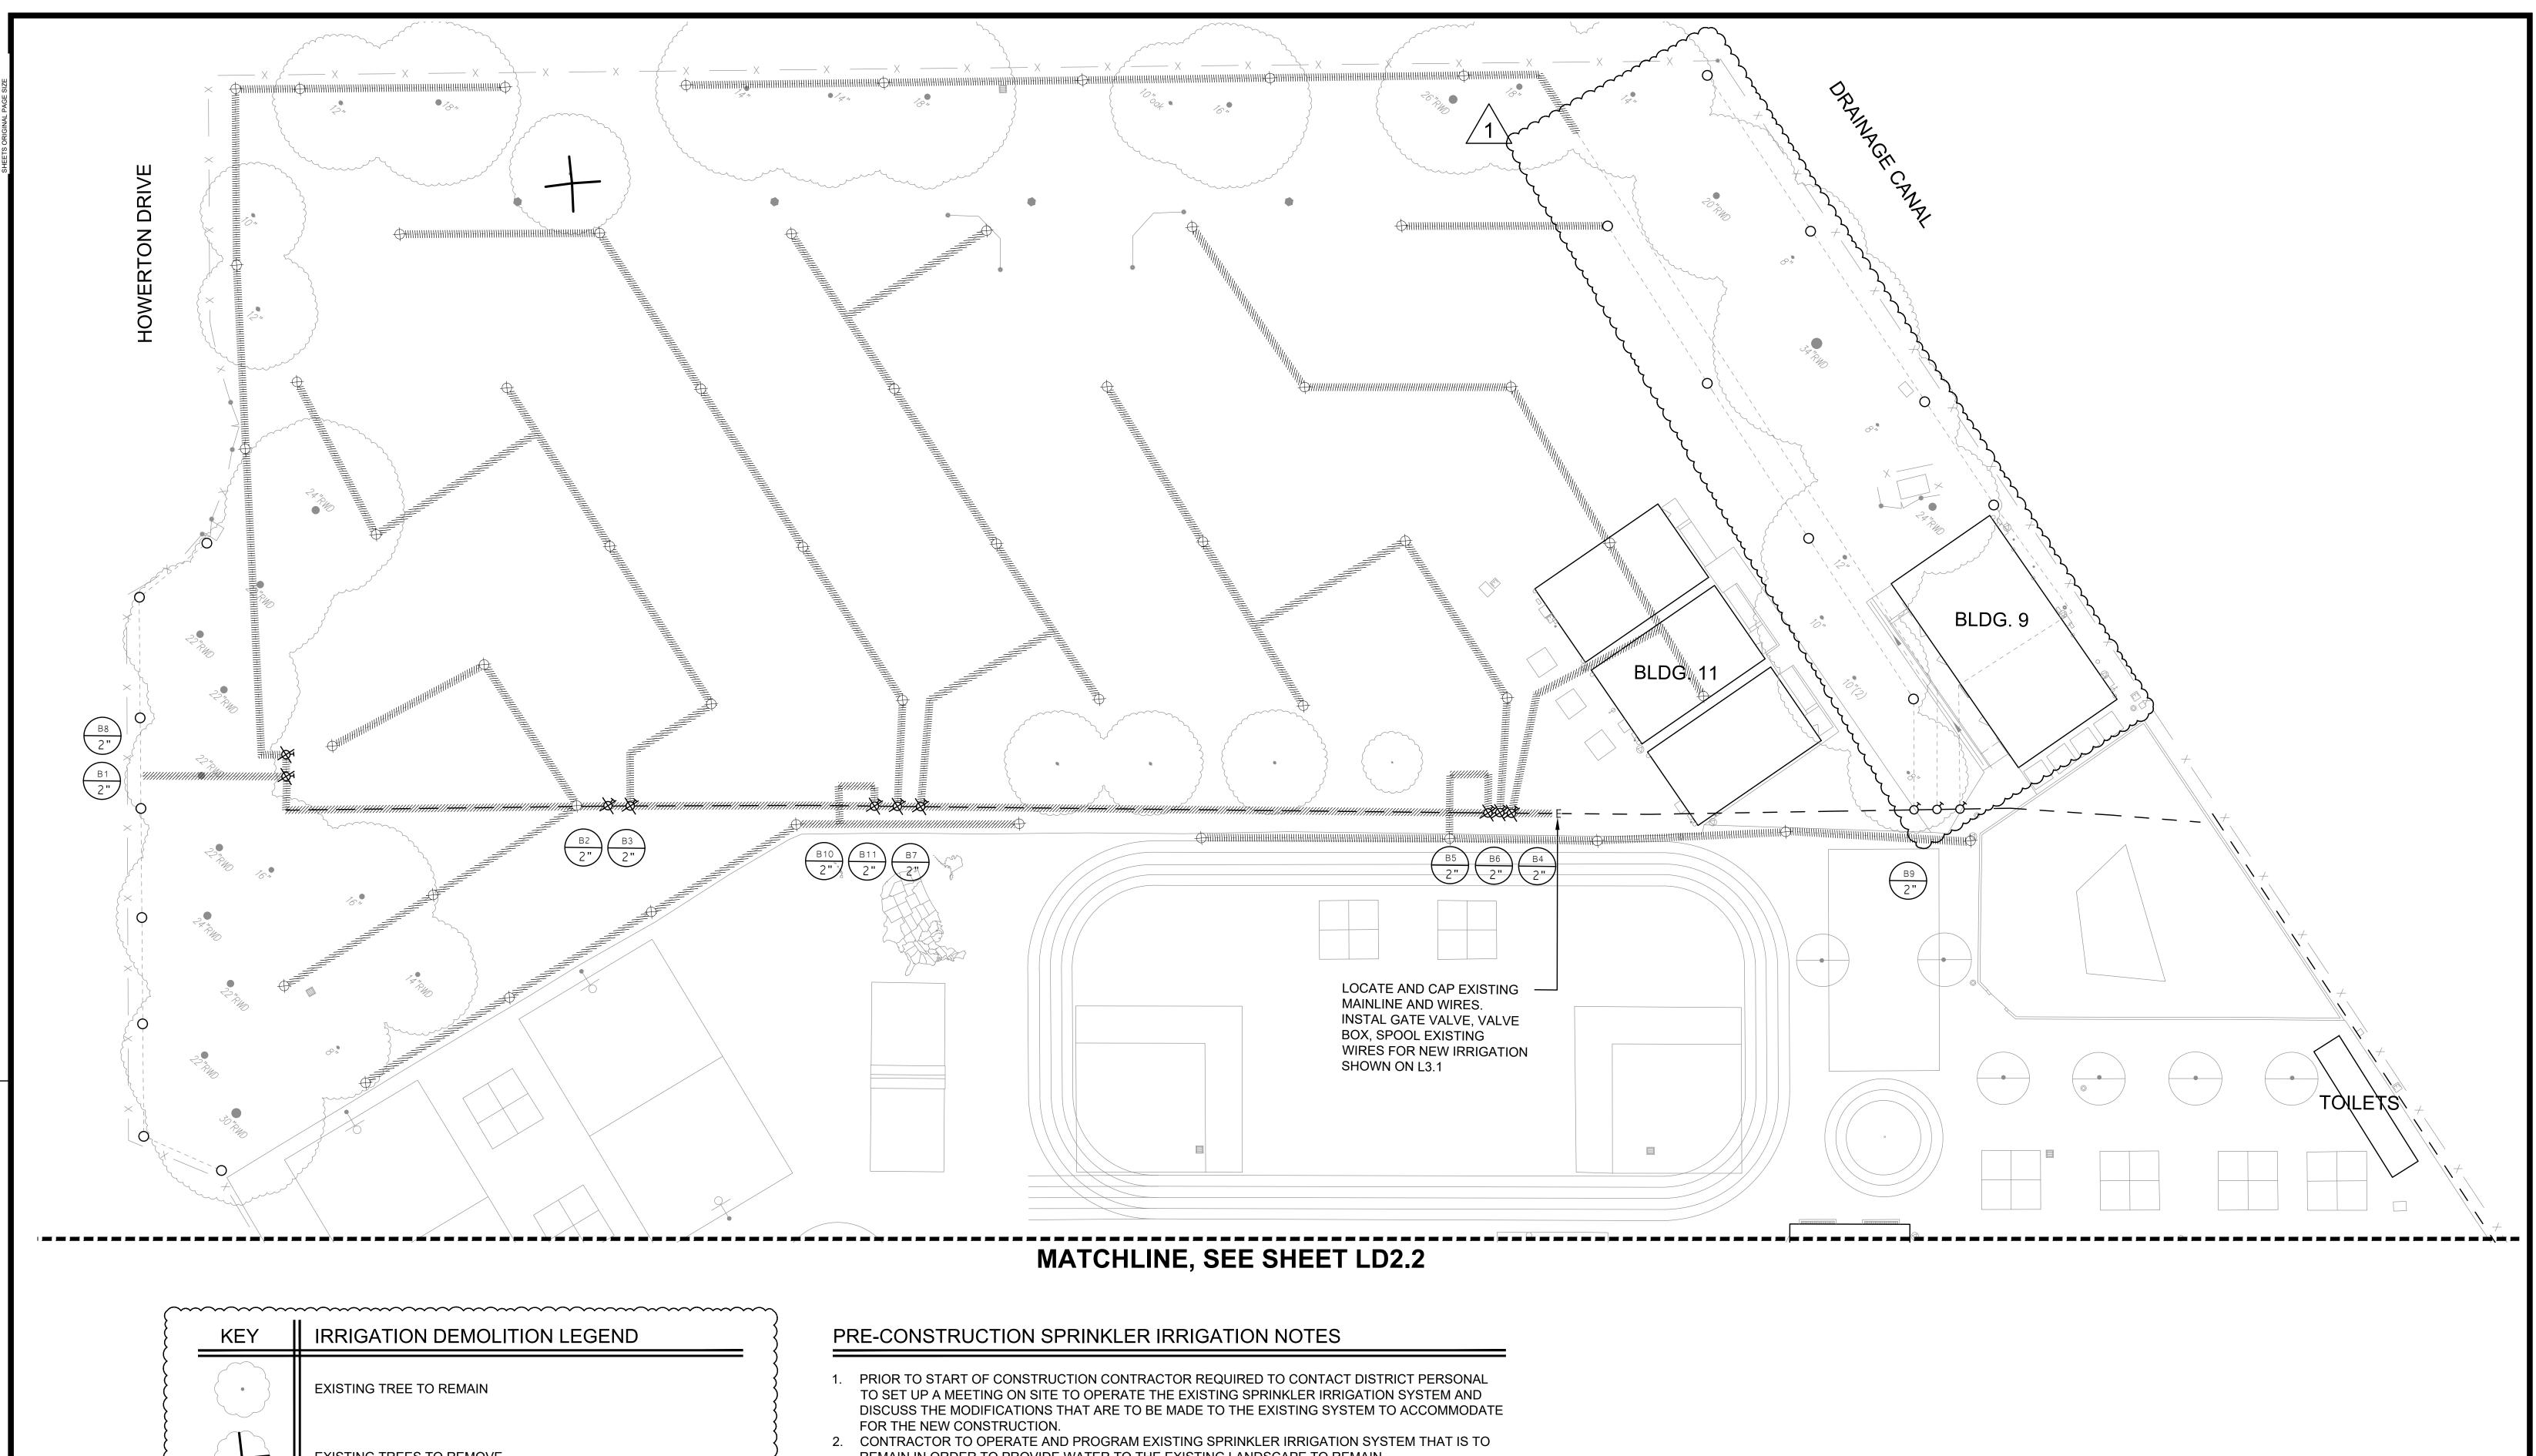

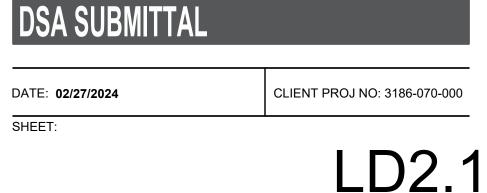

IRRIGATION DEMOLITION PLAN

MATSUYAMA ELEMENTARY SCHOOL MODERNIZATION

MATSUYAMA ELEMENTARY SCHOOL 7680 WINDBRIDGE DR. SACRMANETO, CA 95831

MTW group LANDSCAPE ARCHITECTURE AND PLANNING 2707 K Street, Suite 201 Sacramento, CA 95816 Peter D. Larimer

23068

916 369-3990

FACILITY:

PROJECT:

SHEET NAME:

SHEET:



C-5284



3186-070-000 2101 CAPITOL AVENUE, SUITE 100, SACRAMENTO, CA, 95816 916 368 7990 / www.hmcarchitects.com Δ **DESCRIPTION**

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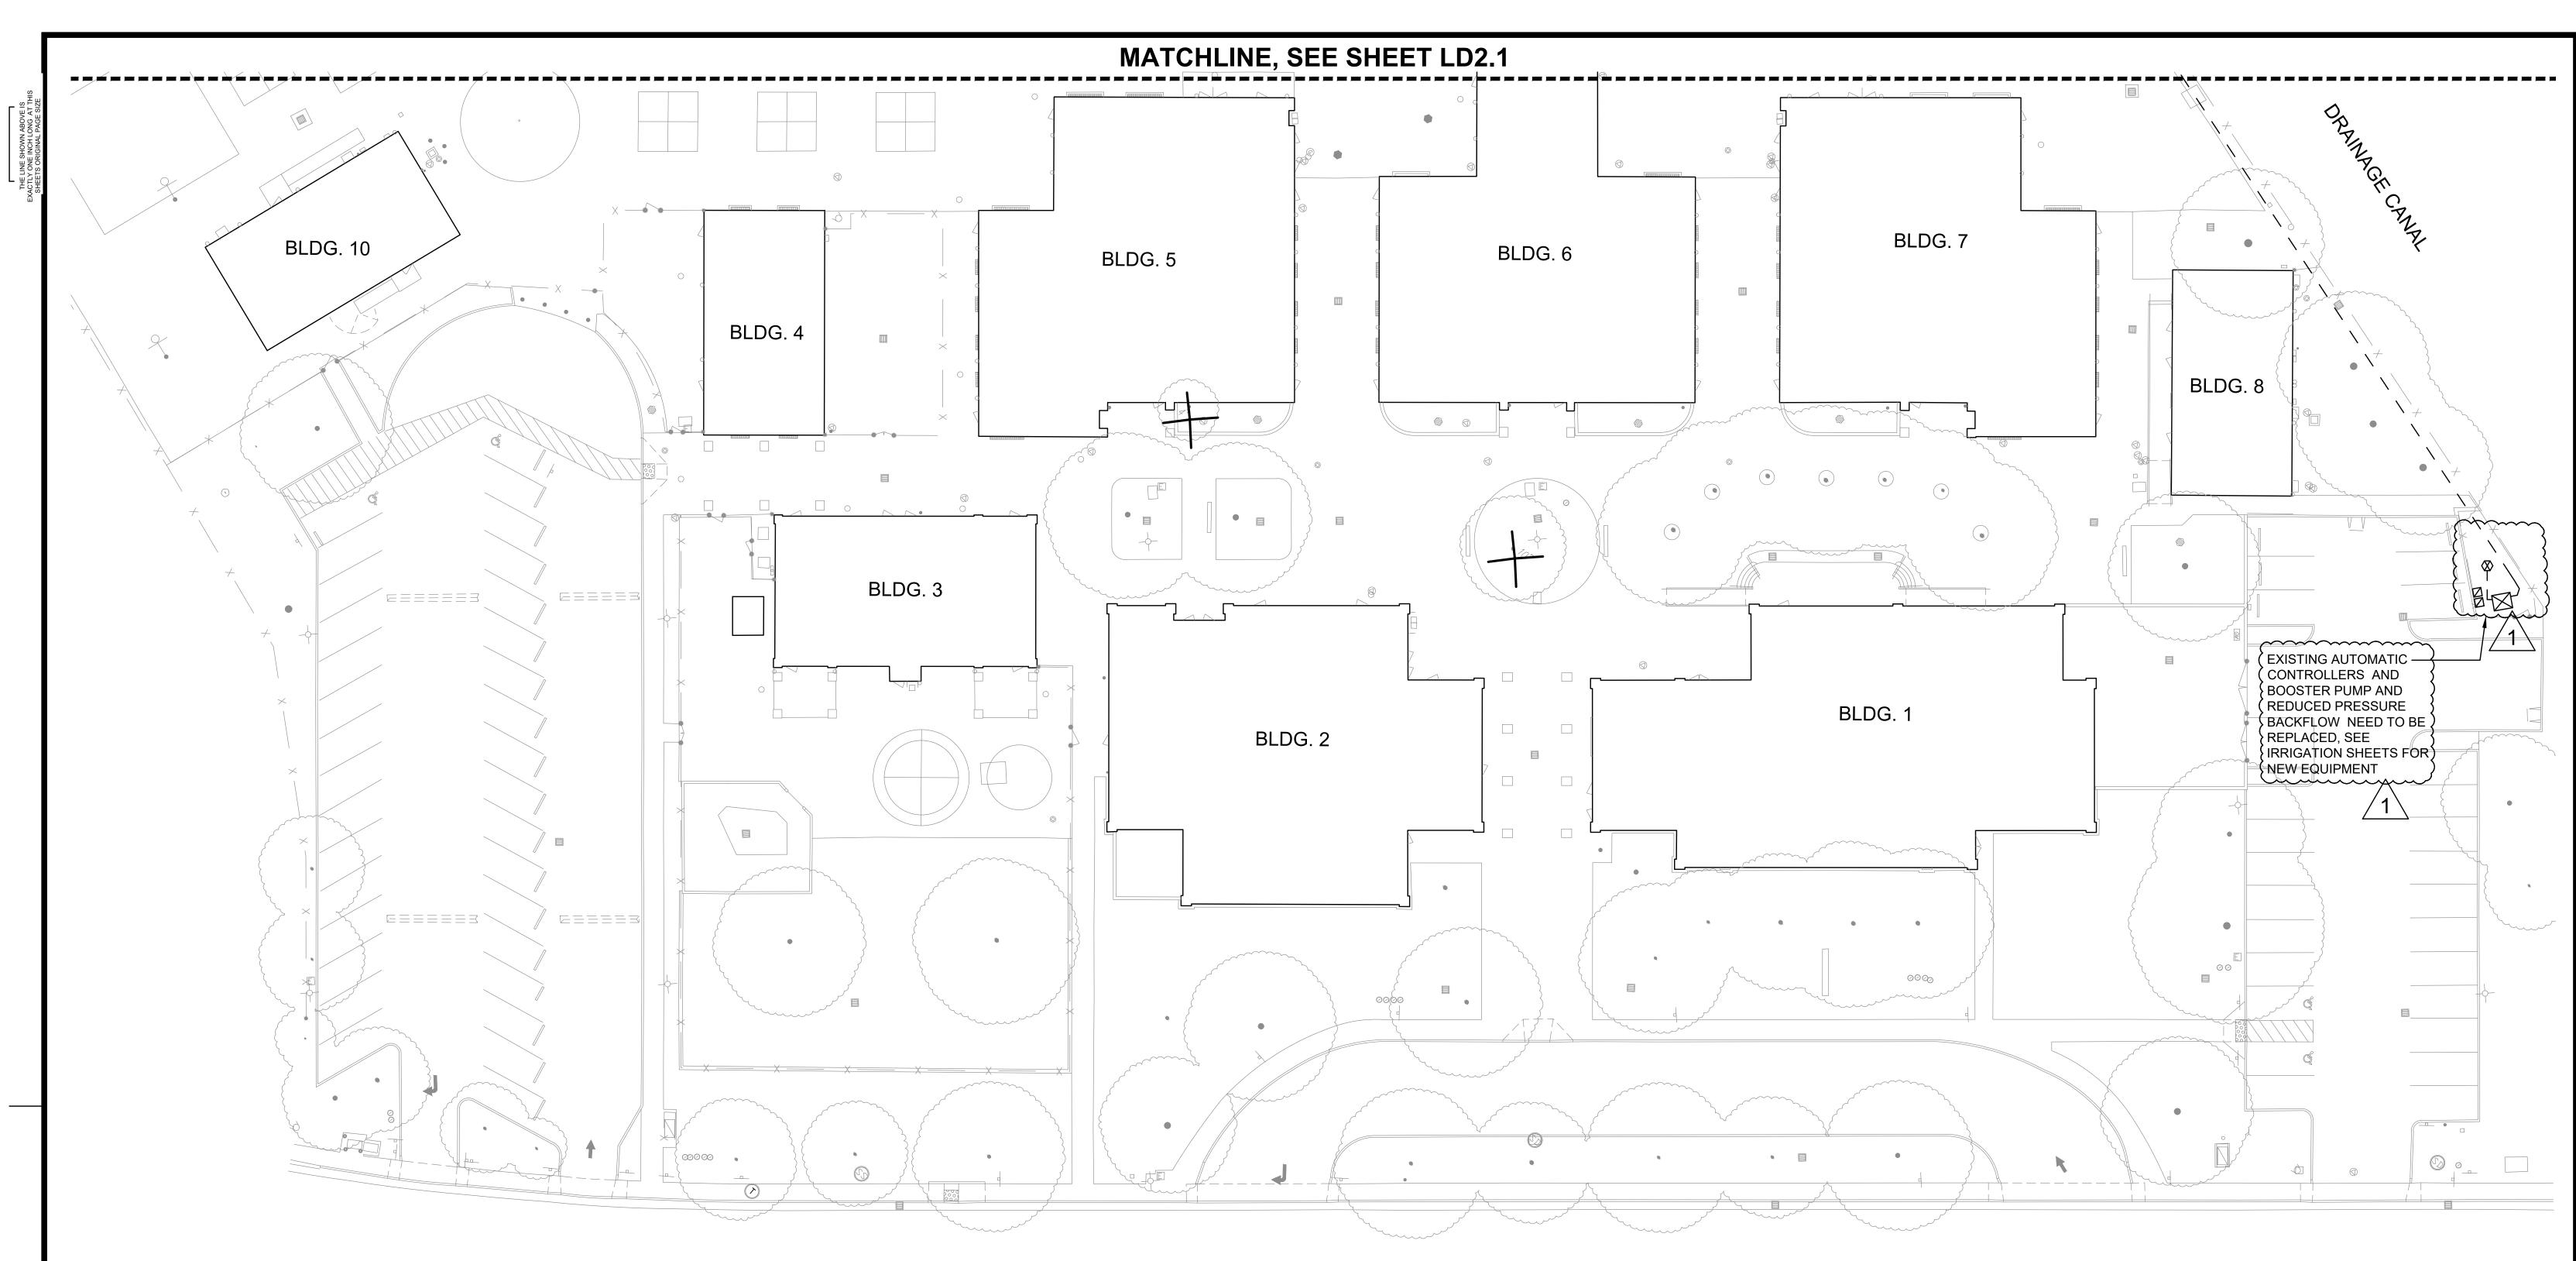
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1 ADDENDUM #1

DATE 03/01/2024

Sacramento City ~





WINDBRIDGE DR.

KEY	IRRIGATION DEMOLITION LEGEND				
	EXISTING TREE TO REMAIN				
	EXISTING TREES TO REMOVE				
\boxtimes	EXISTING BOOSTER PUMP TO REMOVE				
	EXISTING IRRIGATION CONTROLLER TO BE REMOVED				
\otimes	EXISTING REDUCED PRESSURE BACKFLOW PREVENTION DEVICE				
С,	EXISTING AUTOMATIC CONTROL VALVE TO REPLACE				
\$	EXISTING AUTOMATIC CONTROL VALVE TO REMOVE				
0	EXISTING SPRINKLER HEAD TO REMAIN				
\boxtimes	EXISTING SPRINKLER HEAD TO REMOVE				
	EXISTING IRRIGATION MAINLINE TO REMAIN				
4////////////////////////////////////	EXISTING IRRIGATION MAINLINE TO REMOVE				
	EXISTING LATERAL LINE TO REMAIN				
41/11/1/1/1/1/1/1/1/1/	EXISTING LATERAL LINE TO REMOVE				
A1	- INDICATES CONTROL VALVE AND STATION NUMBER				
2"	INDICATES CONTROL VALVE SIZE				

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PRE-CONSTRUCTION SPRINKLER IRRIGATION NOTES

- 1. PRIOR TO START OF CONSTRUCTION CONTRACTOR REQUIRED TO CONTACT DISTRICT PERSONAL TO SET UP A MEETING ON SITE TO OPERATE THE EXISTING SPRINKLER IRRIGATION SYSTEM AND DISCUSS THE MODIFICATIONS THAT ARE TO BE MADE TO THE EXISTING SYSTEM TO ACCOMMODATE FOR THE NEW CONSTRUCTION.
- 2. CONTRACTOR TO OPERATE AND PROGRAM EXISTING SPRINKLER IRRIGATION SYSTEM THAT IS TO REMAIN IN ORDER TO PROVIDE WATER TO THE EXISTING LANDSCAPE TO REMAIN. 3. CONTRACTOR TO REMOVE ALL EXISTING PIPE AND SPRINKLER HEADS WHEN THEY ARE IN NEW
- PLANTING AREAS. 4. CONTRACTOR TO RESTORE AND REPAIR ANY EXISTING SPRINKLER IRRIGATION SYSTEM OR
- EXISTING LANDSCAPE WHICH IS IN AREAS TO REMAIN THAT IS DAMAGED BY NEW WORK.
- 5. ALL WORK TO EXISTING SPRINKLER IRRIGATION SYSTEM TO BE COMPLETED PRIOR TO SITE DEMOLITION.

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1 ADDENDUM #1

23068 MTW group LANDSCAPE ARCHITECTURE

AND PLANNING 2707 K Street, Suite 201 Sacramento, CA 95816 916 369-3990


FACILITY: 7680 WINDBRIDGE DR.

PROJECT: MATSUYAMA ELEMENTARY SCHOOL MODERNIZATION

SHEET NAME:



DATE: 02/27/2024 SHEET:

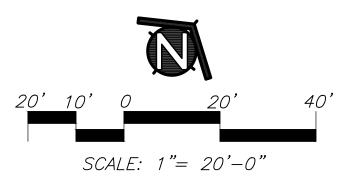



IRRIGATION DEMOLITION PLAN

SACRMANETO, CA 95831

MATSUYAMA ELEMENTARY SCHOOL


Peter D. Larimer




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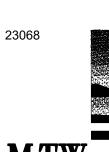


SIZE	QTY.	KEY	BOTANICAL NAME COMMON NAME	
			TREES:	
24" BOX 24" BOX	4 1	ACE.R. CER.	ACER RUBRUM 'OCTOBER GLORY' RED MAPLE CERCIS CANADENSIS RED BUD	MEDIUM LOW

AGENCY

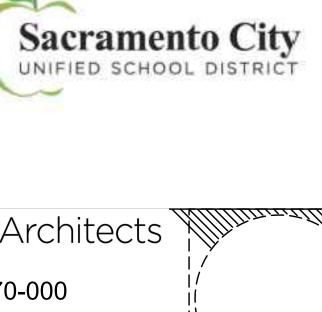3186-070-000
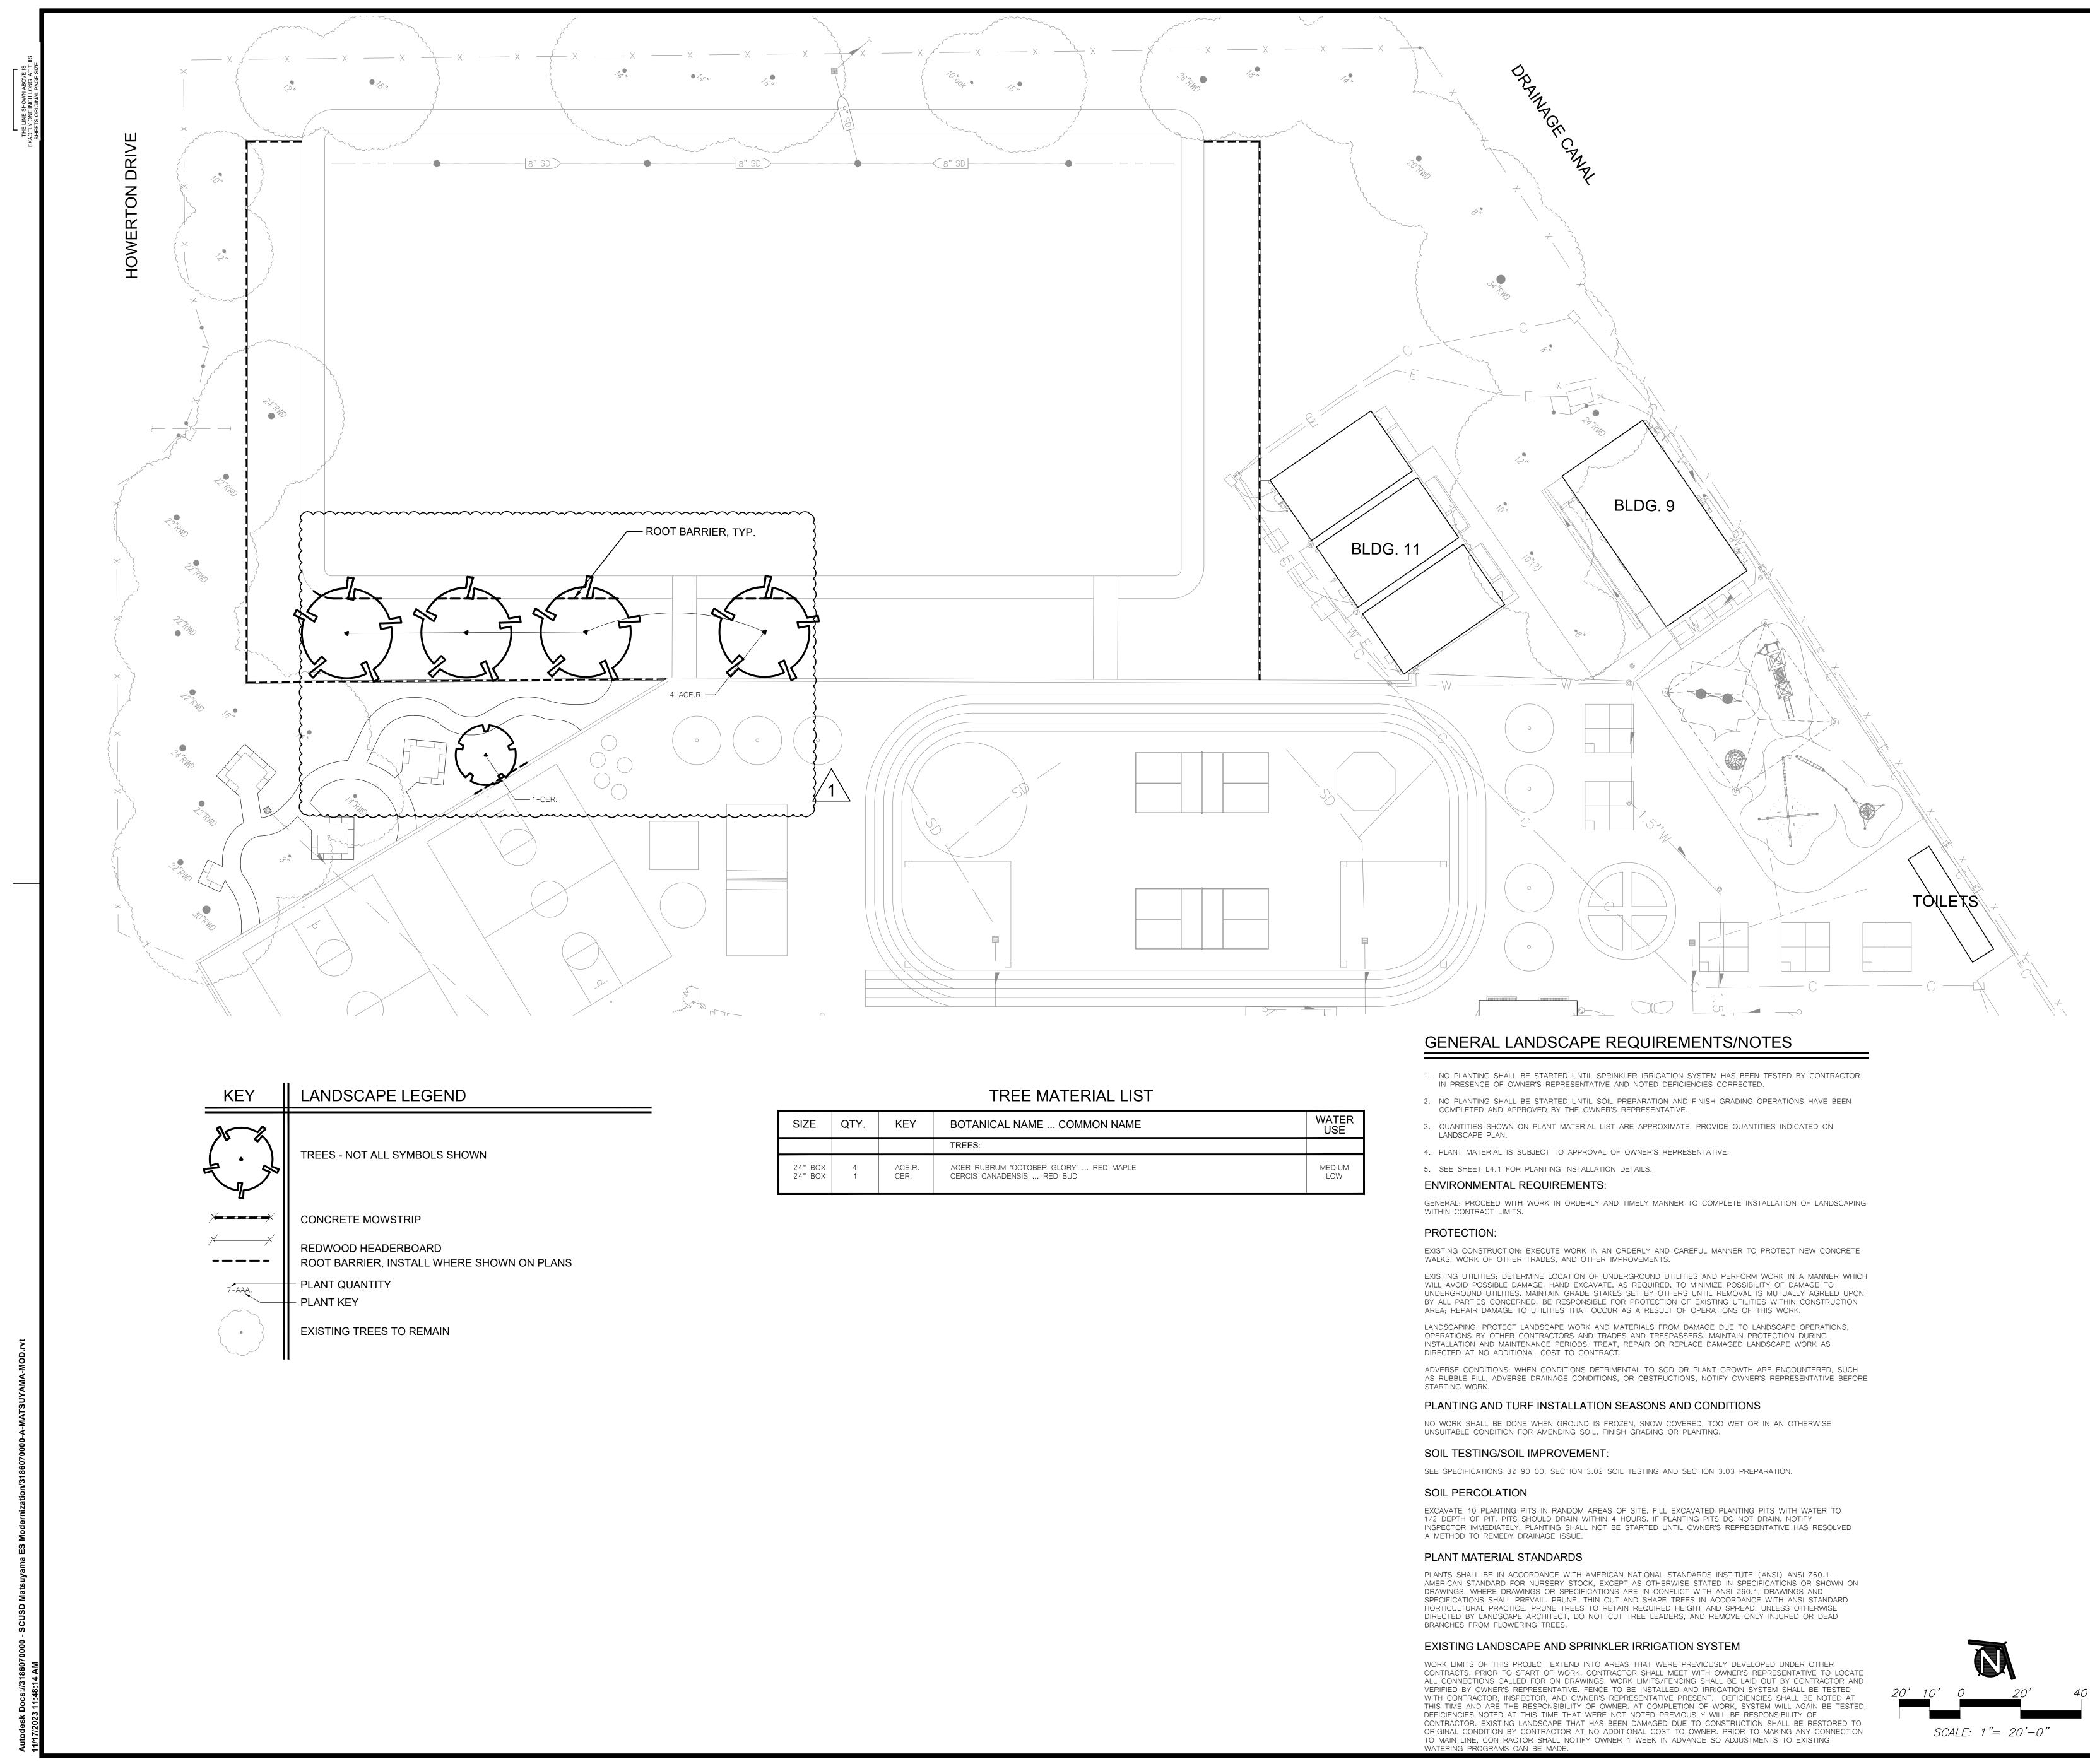
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MTW group LANDSCAPE ARCHITECTURE AND PLANNING 2707 K Street, Suite 201 Sacramento, CA 95816 916 369-3990 Peter D. Larimer


FACILITY: 7680 WINDBRIDGE DR.

PROJECT:

SHEET NAME: TREE PLANTING PLAN



DATE: 02/27/2024 SHEET:

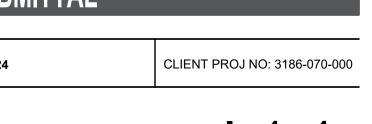


MATSUYAMA ELEMENTARY SCHOOL MODERNIZATION

MATSUYAMA ELEMENTARY SCHOOL SACRMANETO, CA 95831




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MATCHLINE,	SEE S	SHEET	L2.2

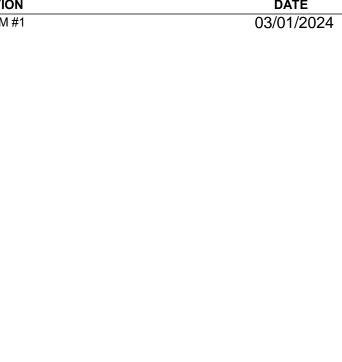SIZE QTY. KEY BOTANICAL NAME COMMON NAME				
			SHRUBS:	
1 G.C.	16	ANI.	ANIGOZANTHOS 'HARMONY' YELLOW KANGAROO PAW	LOW
1 G.C.	10	AZA.	AZALEA (RED) RED EVERGREEN AZALEA	LOW
1 G.C. 1 G.C.	12	CHO. CIS.	CHONDROPETALUM TECTORUM 'EL CAMPO' CISTUS HYBRIDUS WHITE ROCKROSE	LOW
1 G.C.	14	DIE.	DIETES VEGETA FORTNIGHT LILY	LOW
1 G.C.	4	GRE.	GREVILLEA NOELII GREVILLEA	LOW
1 G.C.	8	LAN.	LANTANA 'GOLD RUSH' YELLOW LANTANA	LOW
1 G.C. 1 G.C.	6 14	LOM. LOR.	LOMANDRA 'PLATINUM BEAUTY' PLATINUM BEAUTY LOMANDRA LOROPETALUM CHINENSE 'RUBRUM' CHINESE FRINGE FLOWER	LOW
1 G.C.	14	NAN.	NANDINA DOMESTICA 'GULF STREAM' DWARF HEAVENLY BAMBOO	LOW
1 G.C.	1	SAL.L.	SALVIA LEUCANTHA MEXICAN BUSH SAGE	LOW
1 G.C.	16	SAL.H.	SALVIA MICROPHYLLA 'HOT LIPS' HOT LIPS SAGE	LOW

TÒĮLEŢS GENERAL LANDSCAPE REQUIREMENTS/NOTES 1. NO PLANTING SHALL BE STARTED UNTIL SPRINKLER IRRIGATION SYSTEM HAS BEEN TESTED BY CONTRACTOR IN PRESENCE OF OWNER'S REPRESENTATIVE AND NOTED DEFICIENCIES CORRECTED. 2. NO PLANTING SHALL BE STARTED UNTIL SOIL PREPARATION AND FINISH GRADING OPERATIONS HAVE BEEN COMPLETED AND APPROVED BY THE OWNER'S REPRESENTATIVE. 3. QUANTITIES SHOWN ON PLANT MATERIAL LIST ARE APPROXIMATE. PROVIDE QUANTITIES INDICATED ON LANDSCAPE PLAN. 4. PLANT MATERIAL IS SUBJECT TO APPROVAL OF OWNER'S REPRESENTATIVE. 5. SEE SHEET L4.1 FOR PLANTING INSTALLATION DETAILS. ENVIRONMENTAL REQUIREMENTS: GENERAL: PROCEED WITH WORK IN ORDERLY AND TIMELY MANNER TO COMPLETE INSTALLATION OF LANDSCAPING WITHIN CONTRACT LIMITS. PROTECTION: EXISTING CONSTRUCTION: EXECUTE WORK IN AN ORDERLY AND CAREFUL MANNER TO PROTECT NEW CONCRETE WALKS, WORK OF OTHER TRADES, AND OTHER IMPROVEMENTS. EXISTING UTILITIES: DETERMINE LOCATION OF UNDERGROUND UTILITIES AND PERFORM WORK IN A MANNER WHICH WILL AVOID POSSIBLE DAMAGE. HAND EXCAVATE, AS REQUIRED, TO MINIMIZE POSSIBILITY OF DAMAGE TO UNDERGROUND UTILITIES. MAINTAIN GRADE STAKES SET BY OTHERS UNTIL REMOVAL IS MUTUALLY AGREED UPON BY ALL PARTIES CONCERNED. BE RESPONSIBLE FOR PROTECTION OF EXISTING UTILITIES WITHIN CONSTRUCTION AREA; REPAIR DAMAGE TO UTILITIES THAT OCCUR AS A RESULT OF OPERATIONS OF THIS WORK.

LANDSCAPING: PROTECT LANDSCAPE WORK AND MATERIALS FROM DAMAGE DUE TO LANDSCAPE OPERATIONS, OPERATIONS BY OTHER CONTRACTORS AND TRADES AND TRESPASSERS. MAINTAIN PROTECTION DURING INSTALLATION AND MAINTENANCE PERIODS. TREAT, REPAIR OR REPLACE DAMAGED LANDSCAPE WORK AS DIRECTED AT NO ADDITIONAL COST TO CONTRACT.

ADVERSE CONDITIONS: WHEN CONDITIONS DETRIMENTAL TO SOD OR PLANT GROWTH ARE ENCOUNTERED, SUCH AS RUBBLE FILL, ADVERSE DRAINAGE CONDITIONS, OR OBSTRUCTIONS, NOTIFY OWNER'S REPRESENTATIVE BEFORE STARTING WORK.

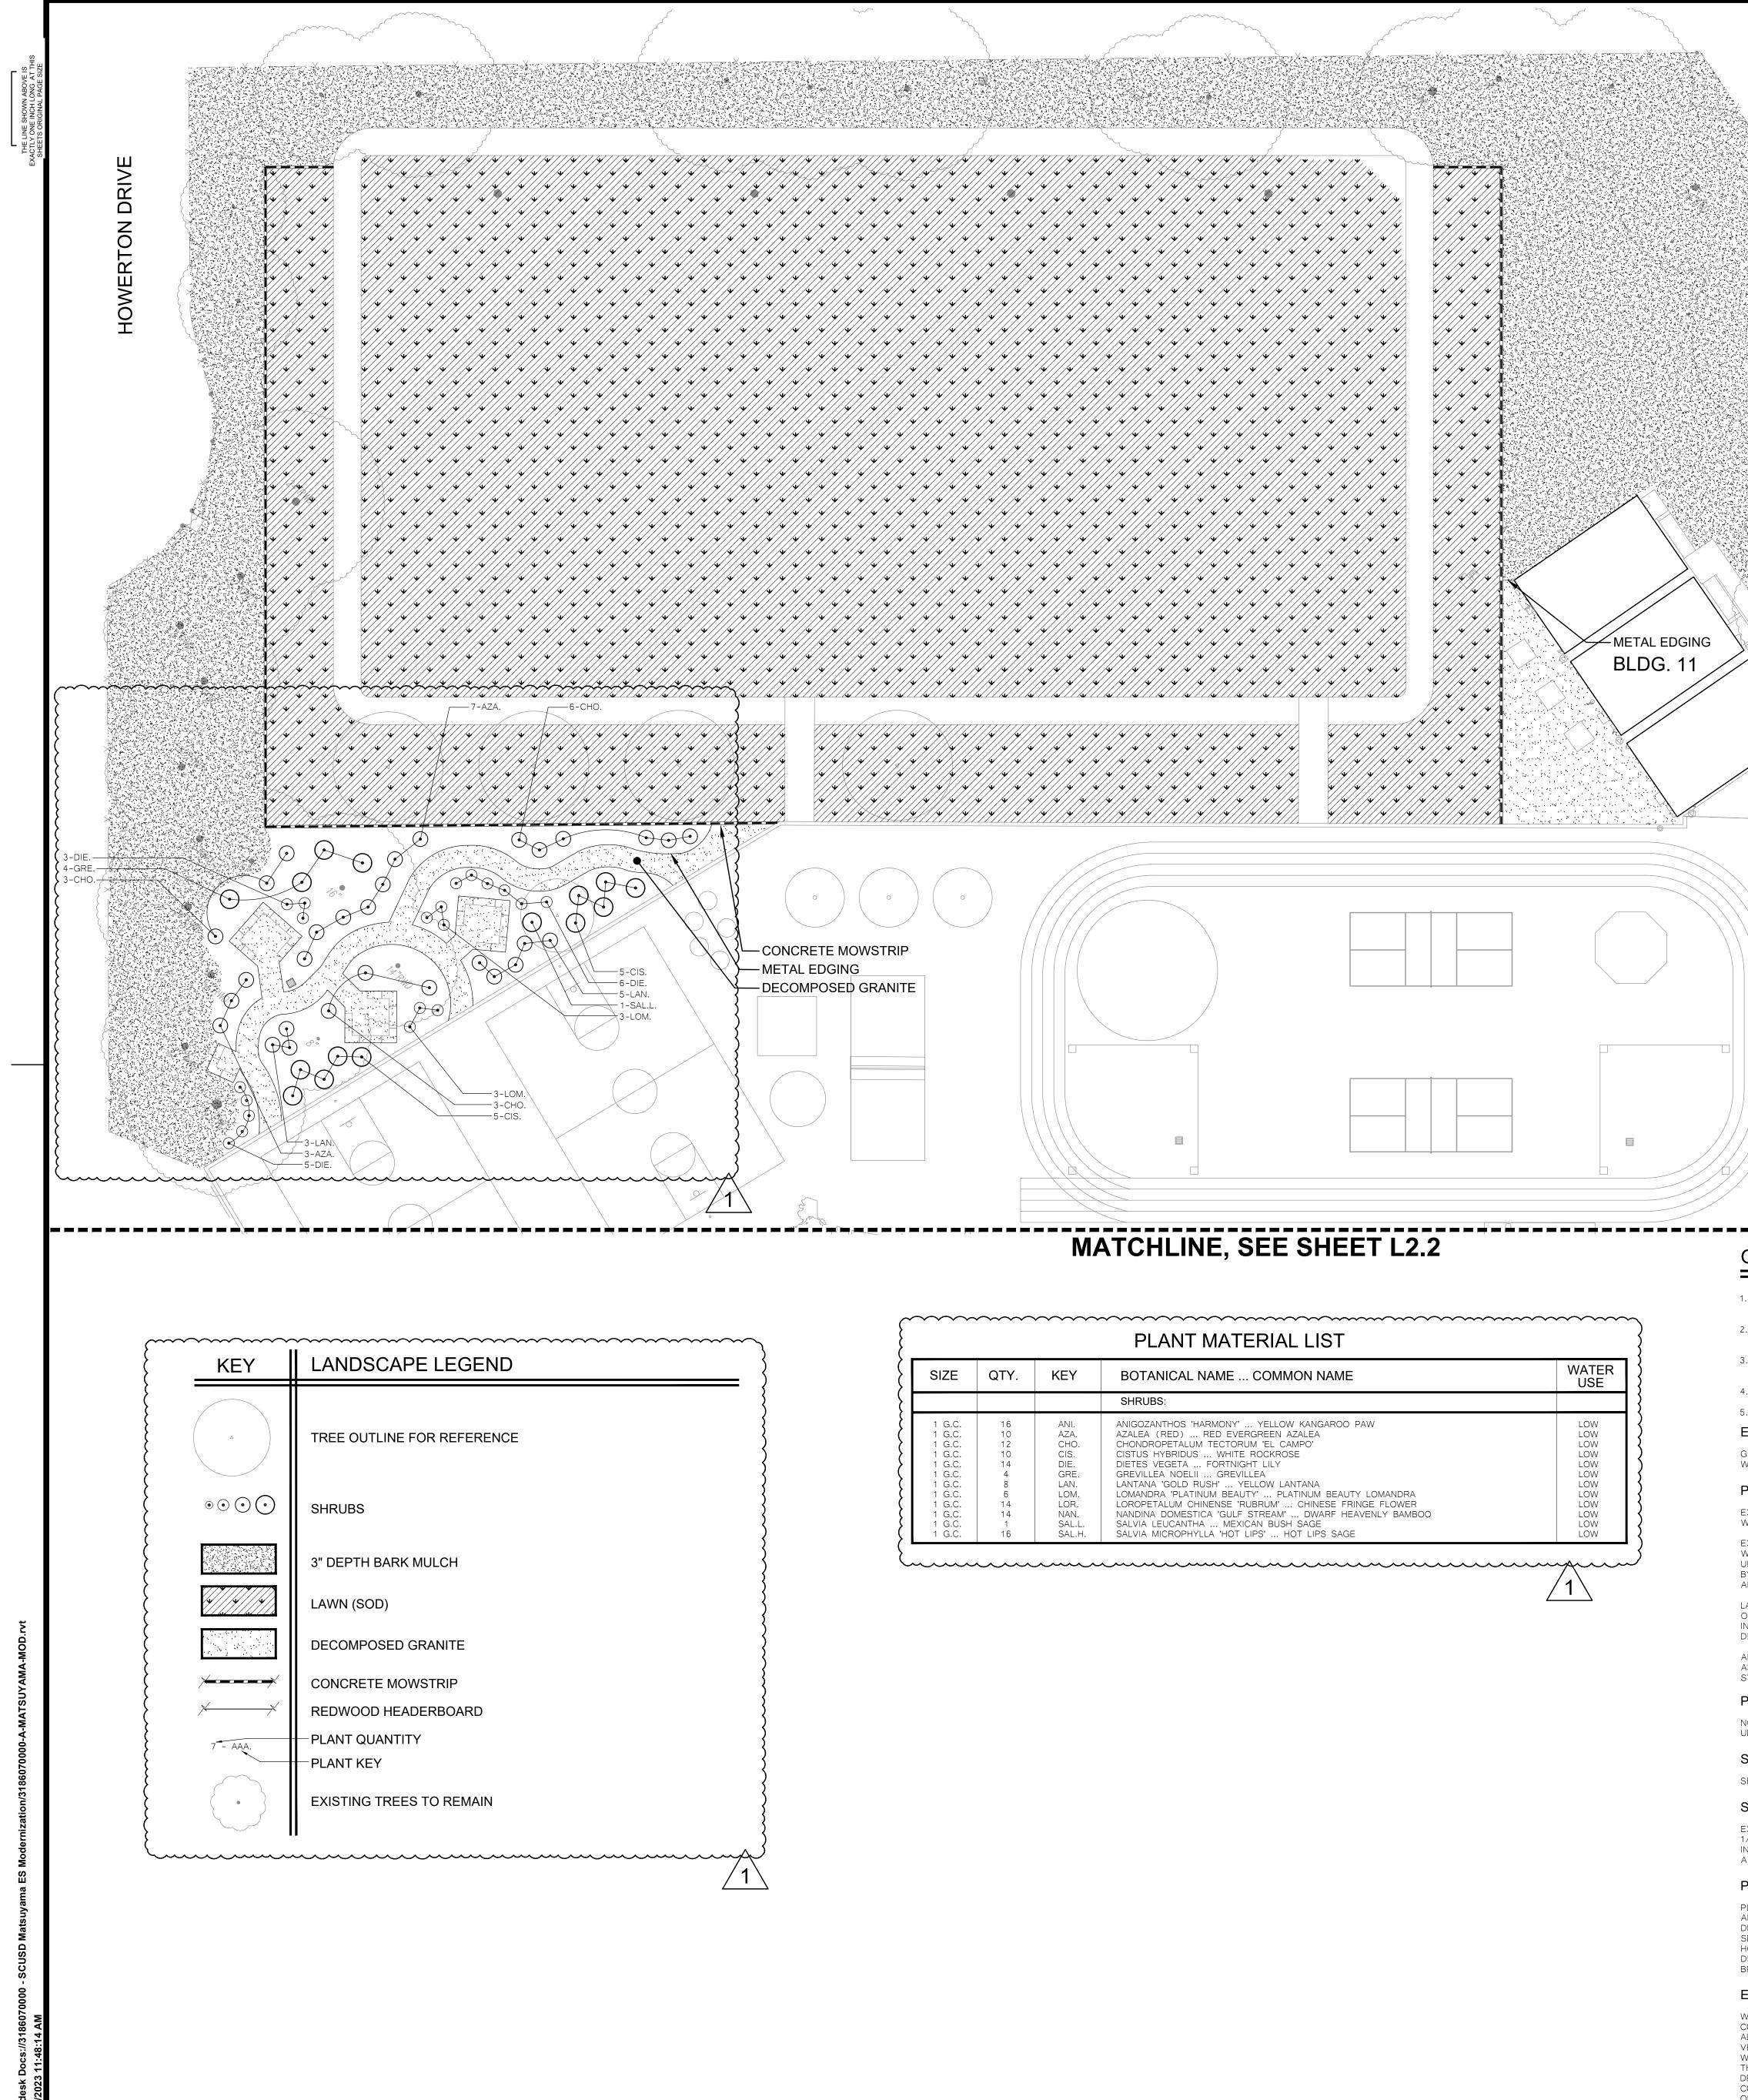PLANTING AND TURF INSTALLATION SEASONS AND CONDITIONS

NO WORK SHALL BE DONE WHEN GROUND IS FROZEN, SNOW COVERED, TOO WET OR IN AN OTHERWISE UNSUITABLE CONDITION FOR AMENDING SOIL, FINISH GRADING OR PLANTING.

SOIL TESTING/SOIL IMPROVEMENT:

SEE SPECIFICATIONS 32 90 00, SECTION 3.2 SOIL TESTING AND SECTION 3.3 PREPARATION.

BLDG. 9

SOIL PERCOLATION

EXCAVATE 10 PLANTING PITS IN RANDOM AREAS OF SITE. FILL EXCAVATED PLANTING PITS WITH WATER TO 1/2 DEPTH OF PIT. PITS SHOULD DRAIN WITHIN 4 HOURS. IF PLANTING PITS DO NOT DRAIN, NOTIFY INSPECTOR IMMEDIATELY. PLANTING SHALL NOT BE STARTED UNTIL OWNER'S REPRESENTATIVE HAS RESOLVED A METHOD TO REMEDY DRAINAGE ISSUE.

PLANT MATERIAL STANDARDS


WATERING PROGRAMS CAN BE MADE.

PLANTS SHALL BE IN ACCORDANCE WITH AMERICAN NATIONAL STANDARDS INSTITUTE (ANSI) ANSI Z60.1-AMERICAN STANDARD FOR NURSERY STOCK, EXCEPT AS OTHERWISE STATED IN SPECIFICATIONS OR SHOWN ON DRAWINGS. WHERE DRAWINGS OR SPECIFICATIONS ARE IN CONFLICT WITH ANSI Z60.1, DRAWINGS AND

SPECIFICATIONS SHALL PREVAIL. PRUNE, THIN OUT AND SHAPE TREES IN ACCORDANCE WITH ANSI STANDARD HORTICULTURAL PRACTICE. PRUNE TREES TO RETAIN REQUIRED HEIGHT AND SPREAD. UNLESS OTHERWISE DIRECTED BY LANDSCAPE ARCHITECT, DO NOT CUT TREE LEADERS, AND REMOVE ONLY INJURED OR DEAD BRANCHES FROM FLOWERING TREES.

EXISTING LANDSCAPE AND SPRINKLER IRRIGATION SYSTEM


WORK LIMITS OF THIS PROJECT EXTEND INTO AREAS THAT WERE PREVIOUSLY DEVELOPED UNDER OTHER CONTRACTS. PRIOR TO START OF WORK, CONTRACTOR SHALL MEET WITH OWNER'S REPRESENTATIVE TO LOCATE ALL CONNECTIONS CALLED FOR ON DRAWINGS. WORK LIMITS/FENCING SHALL BE LAID OUT BY CONTRACTOR AND VERIFIED BY OWNER'S REPRESENTATIVE. FENCE TO BE INSTALLED AND IRRIGATION SYSTEM SHALL BE TESTED WITH CONTRACTOR, INSPECTOR, AND OWNER'S REPRESENTATIVE PRESENT. DEFICIENCIES SHALL BE NOTED AT THIS TIME AND ARE THE RESPONSIBILITY OF OWNER. AT COMPLETION OF WORK, SYSTEM WILL AGAIN BE TESTED, DEFICIENCIES NOTED AT THIS TIME THAT WERE NOT NOTED PREVIOUSLY WILL BE RESPONSIBILITY OF CONTRACTOR. EXISTING LANDSCAPE THAT HAS BEEN DAMAGED DUE TO CONSTRUCTION SHALL BE RESTORED TO ORIGINAL CONDITION BY CONTRACTOR AT NO ADDITIONAL COST TO OWNER. PRIOR TO MAKING ANY CONNECTION TO MAIN LINE, CONTRACTOR SHALL NOTIFY OWNER 1 WEEK IN ADVANCE SO ADJUSTMENTS TO EXISTING

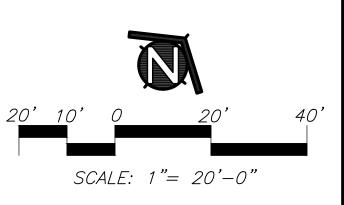

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AND PLANNING 916 369-3990


FACILITY: 7680 WINDBRIDGE DR.

PROJECT:

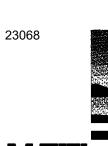SHEET NAME:



DATE: 02/27/2024 SHEET:

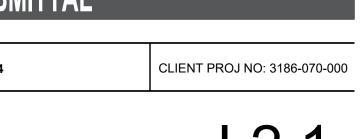

SHRUB/TURF PLANTING PLAN

MATSUYAMA ELEMENTARY SCHOOL MODERNIZATION


MATSUYAMA ELEMENTARY SCHOOL SACRMANETO, CA 95831



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03/01/2024




PLANT MATERIAL LIST						
SIZE QTY. KEY BOTANICAL NAME COMMON NAME USE						
			SHRUBS:			
1 G.C.	16	ANI.	ANIGOZANTHOS 'HARMONY' YELLOW KANGAROO PAW	LOW		
1 G.C.	10	AZA.	AZALEA (RED) RED EVERGREEN AZALEA	LOW		
1 G.C. 1 G.C.	12 10	CHO. CIS.	CHONDROPETALUM TECTORUM 'EL CAMPO' CISTUS HYBRIDUS WHITE ROCKROSE	LOW		
1 G.C.	14	DIE.	DIETES VEGETA FORTNIGHT LILY	LOW		
1 G.C.	4	GRE.	GREVILLEA NOELII GREVILLEA	LOW		
1 G.C.	8	LAN.	LANTANA 'GOLD RUSH' YELLOW LANTANA	LOW		
1 G.C.	6	LOM.	LOMANDRA 'PLATINUM BEAUTY' PLATINUM BEAUTY LOMANDRA	LOW		
1 G.C.	14	LOR.	LOROPETALUM CHINENSE 'RUBRUM' CHINESE FRINGE FLOWER	LOW		
1 G.C.	14	NAN.	NANDINA DOMESTICA 'GULF STREAM' DWARF HEAVENLY BAMBOO	LOW		
1 G.C.		SAL.L.	SALVIA LEUCANTHA MEXICAN BUSH SAGE	LOW		
1 G.C.	16	SAL.H.	SALVIA MICROPHYLLA 'HOT LIPS' HOT LIPS SAGE	LOW		

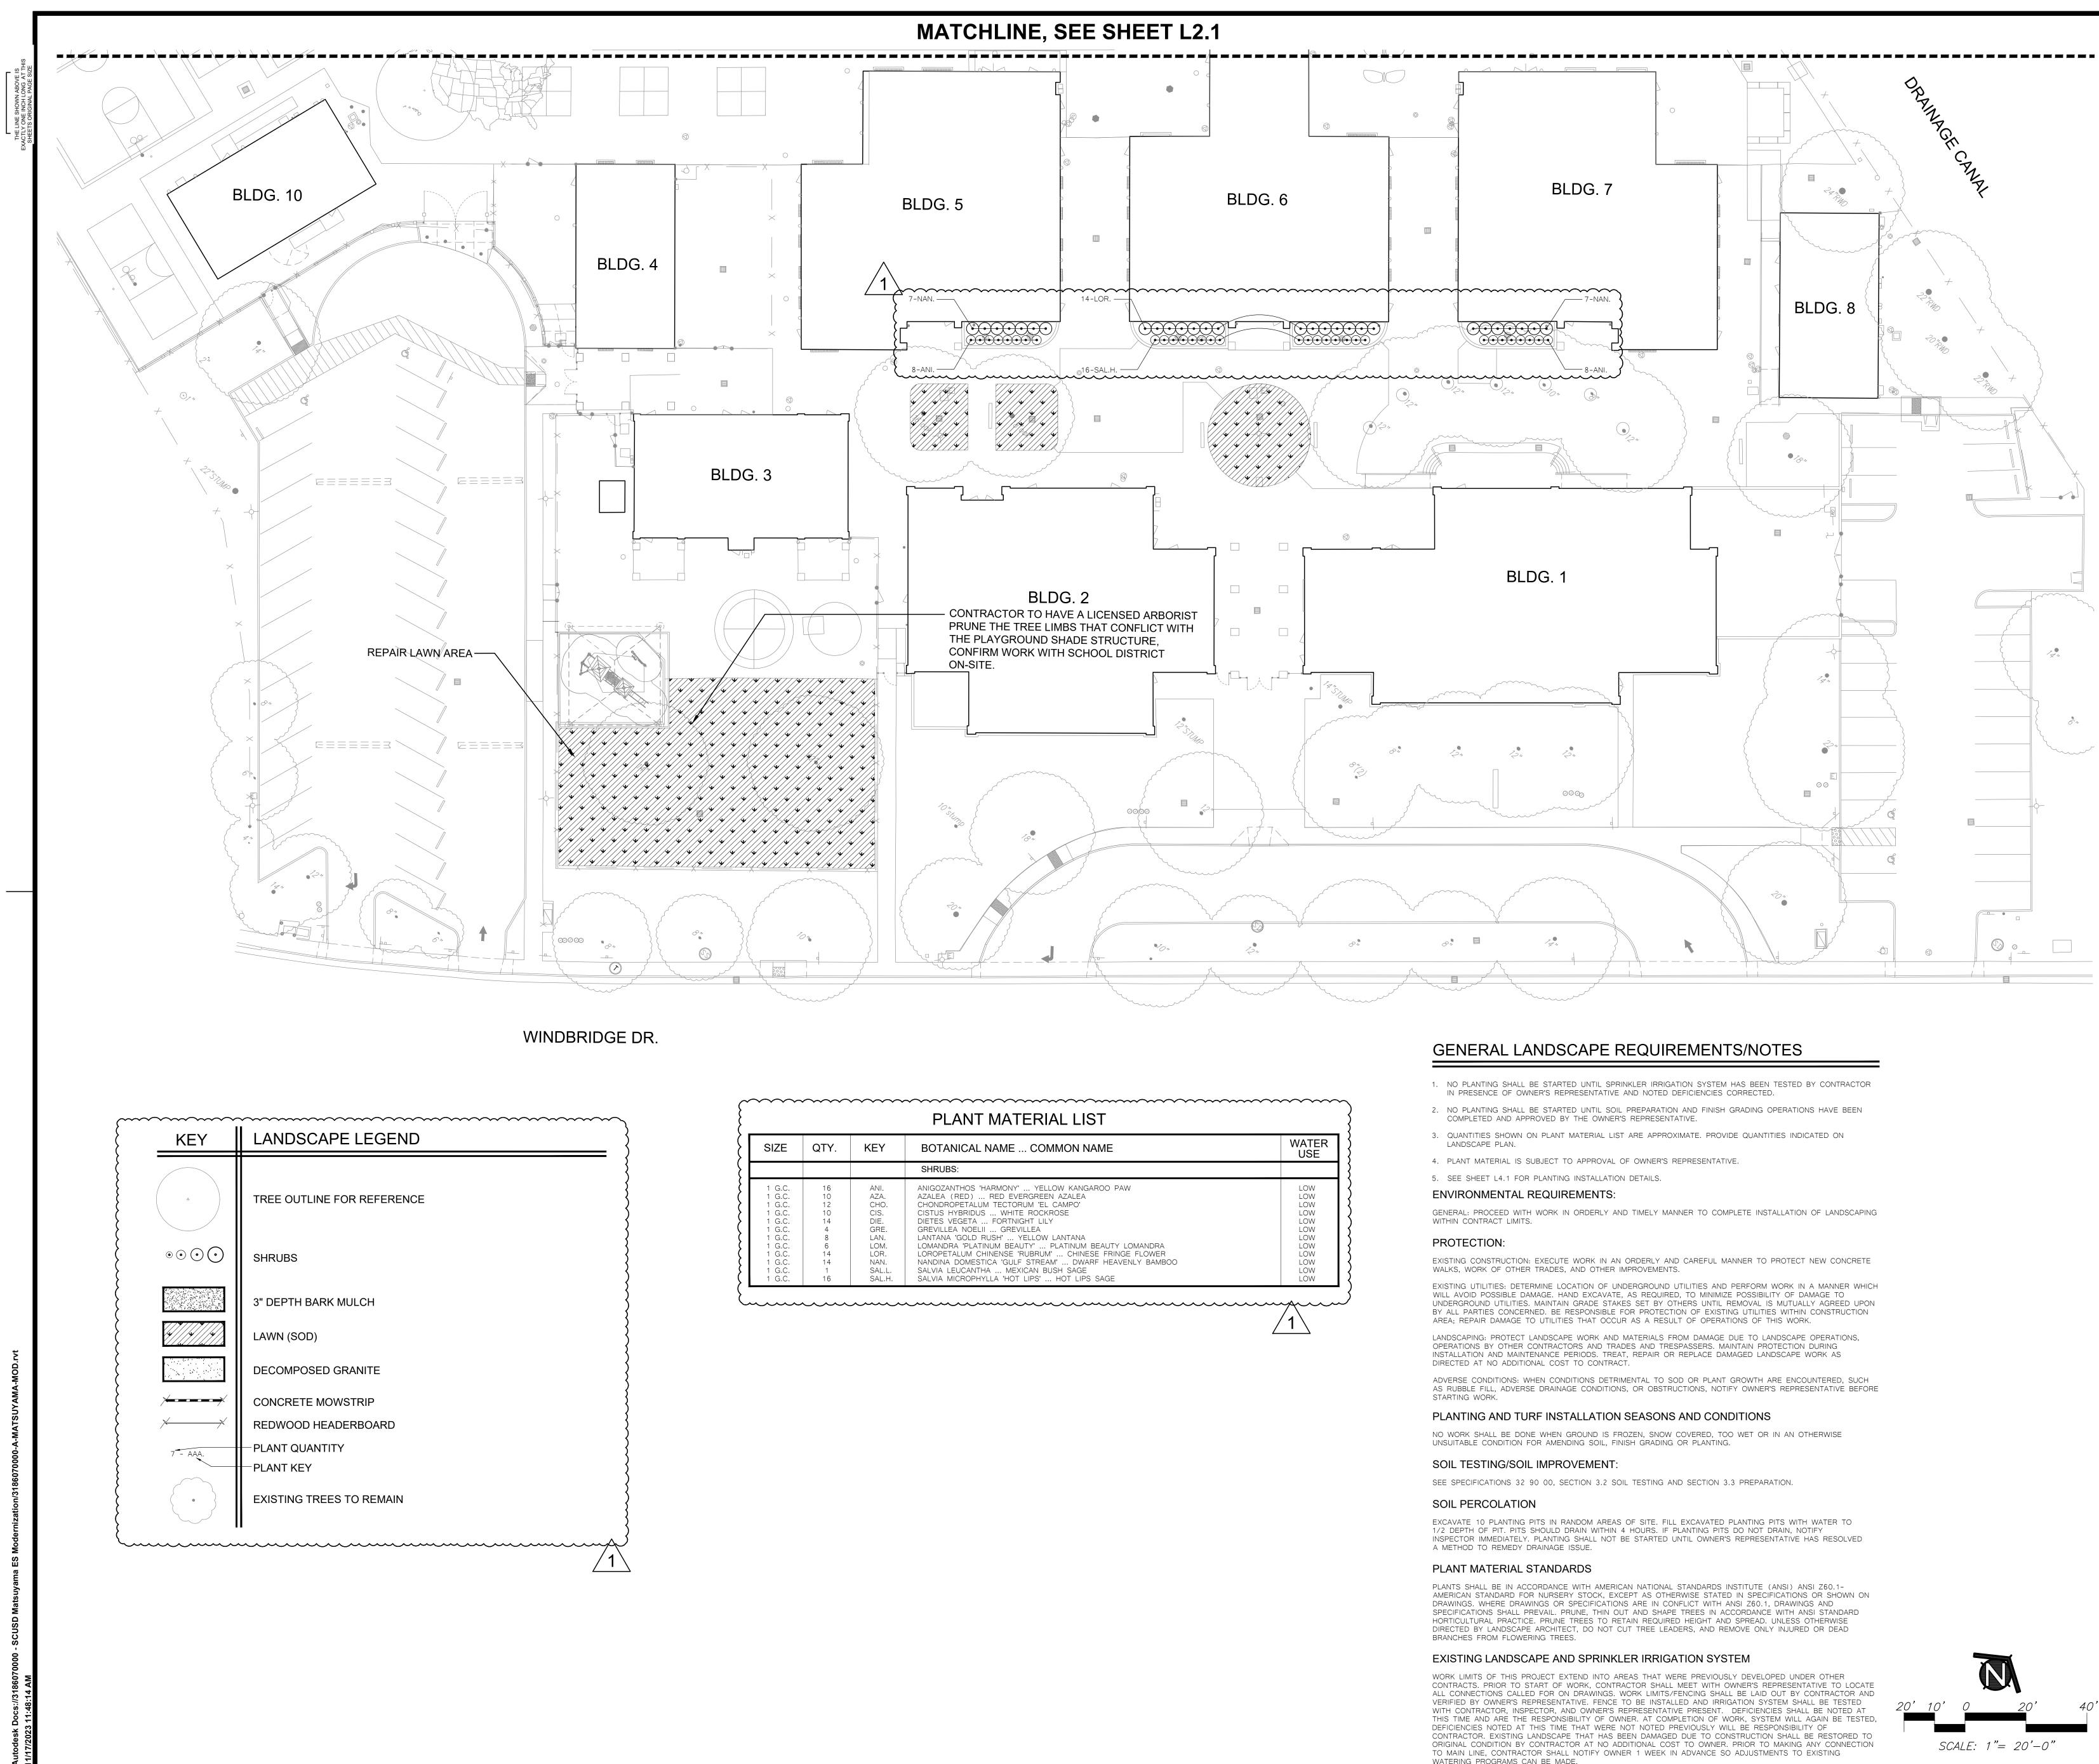AGENCY

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ISSUE Δ **DESCRIPTION** 1 ADDENDUM #1

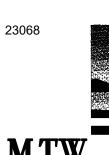

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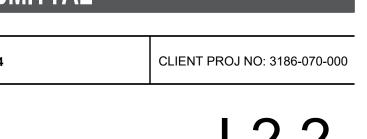
FACILITY: 7680 WINDBRIDGE DR.

PROJECT:

SHEET NAME: SHRUB/TURF PLANTING PLAN



DATE: 02/27/2024 SHEET:



MATSUYAMA ELEMENTARY SCHOOL MODERNIZATION

MATSUYAMA ELEMENTARY SCHOOL SACRMANETO, CA 95831



C-5284




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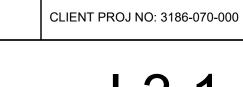
PROJECT: MATSUYAMA ELEMENTARY SCHOOL MODERNIZATION

SHEET NAME:



DATE: 02/27/2024 SHEET:
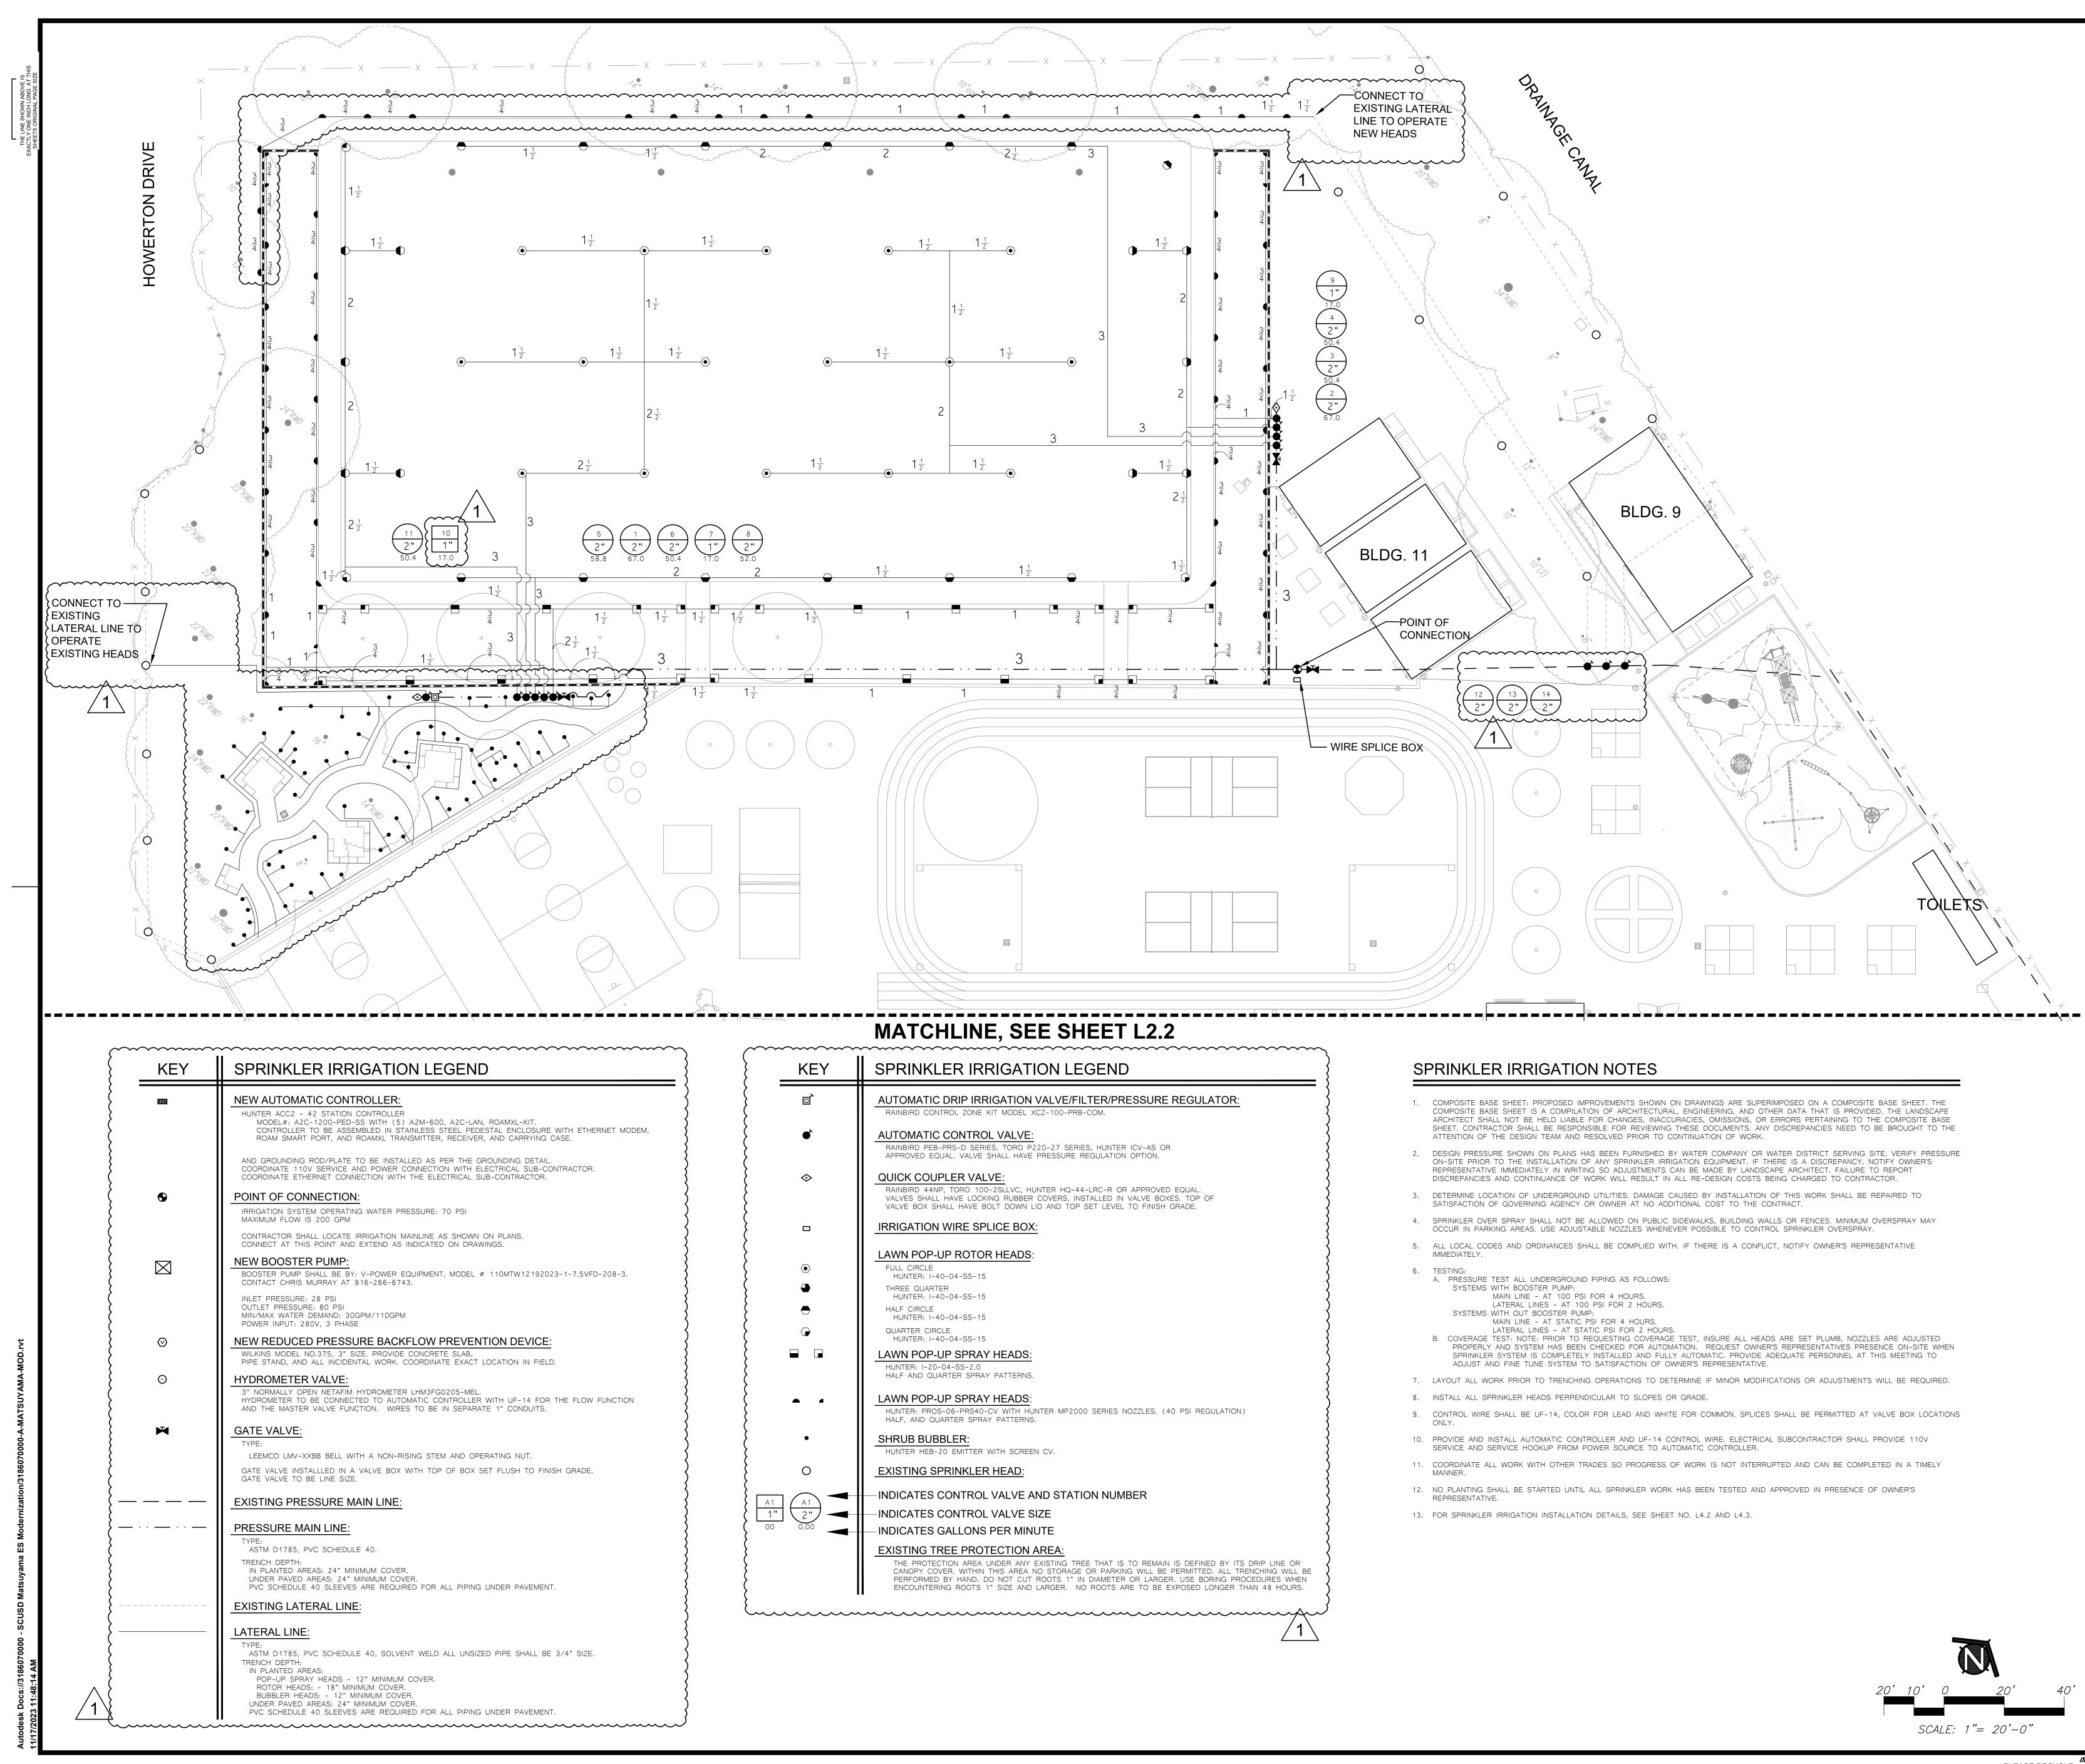
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LANDSCAPE IRRIGATION PLAN

MATSUYAMA ELEMENTARY SCHOOL SACRMANETO, CA 95831



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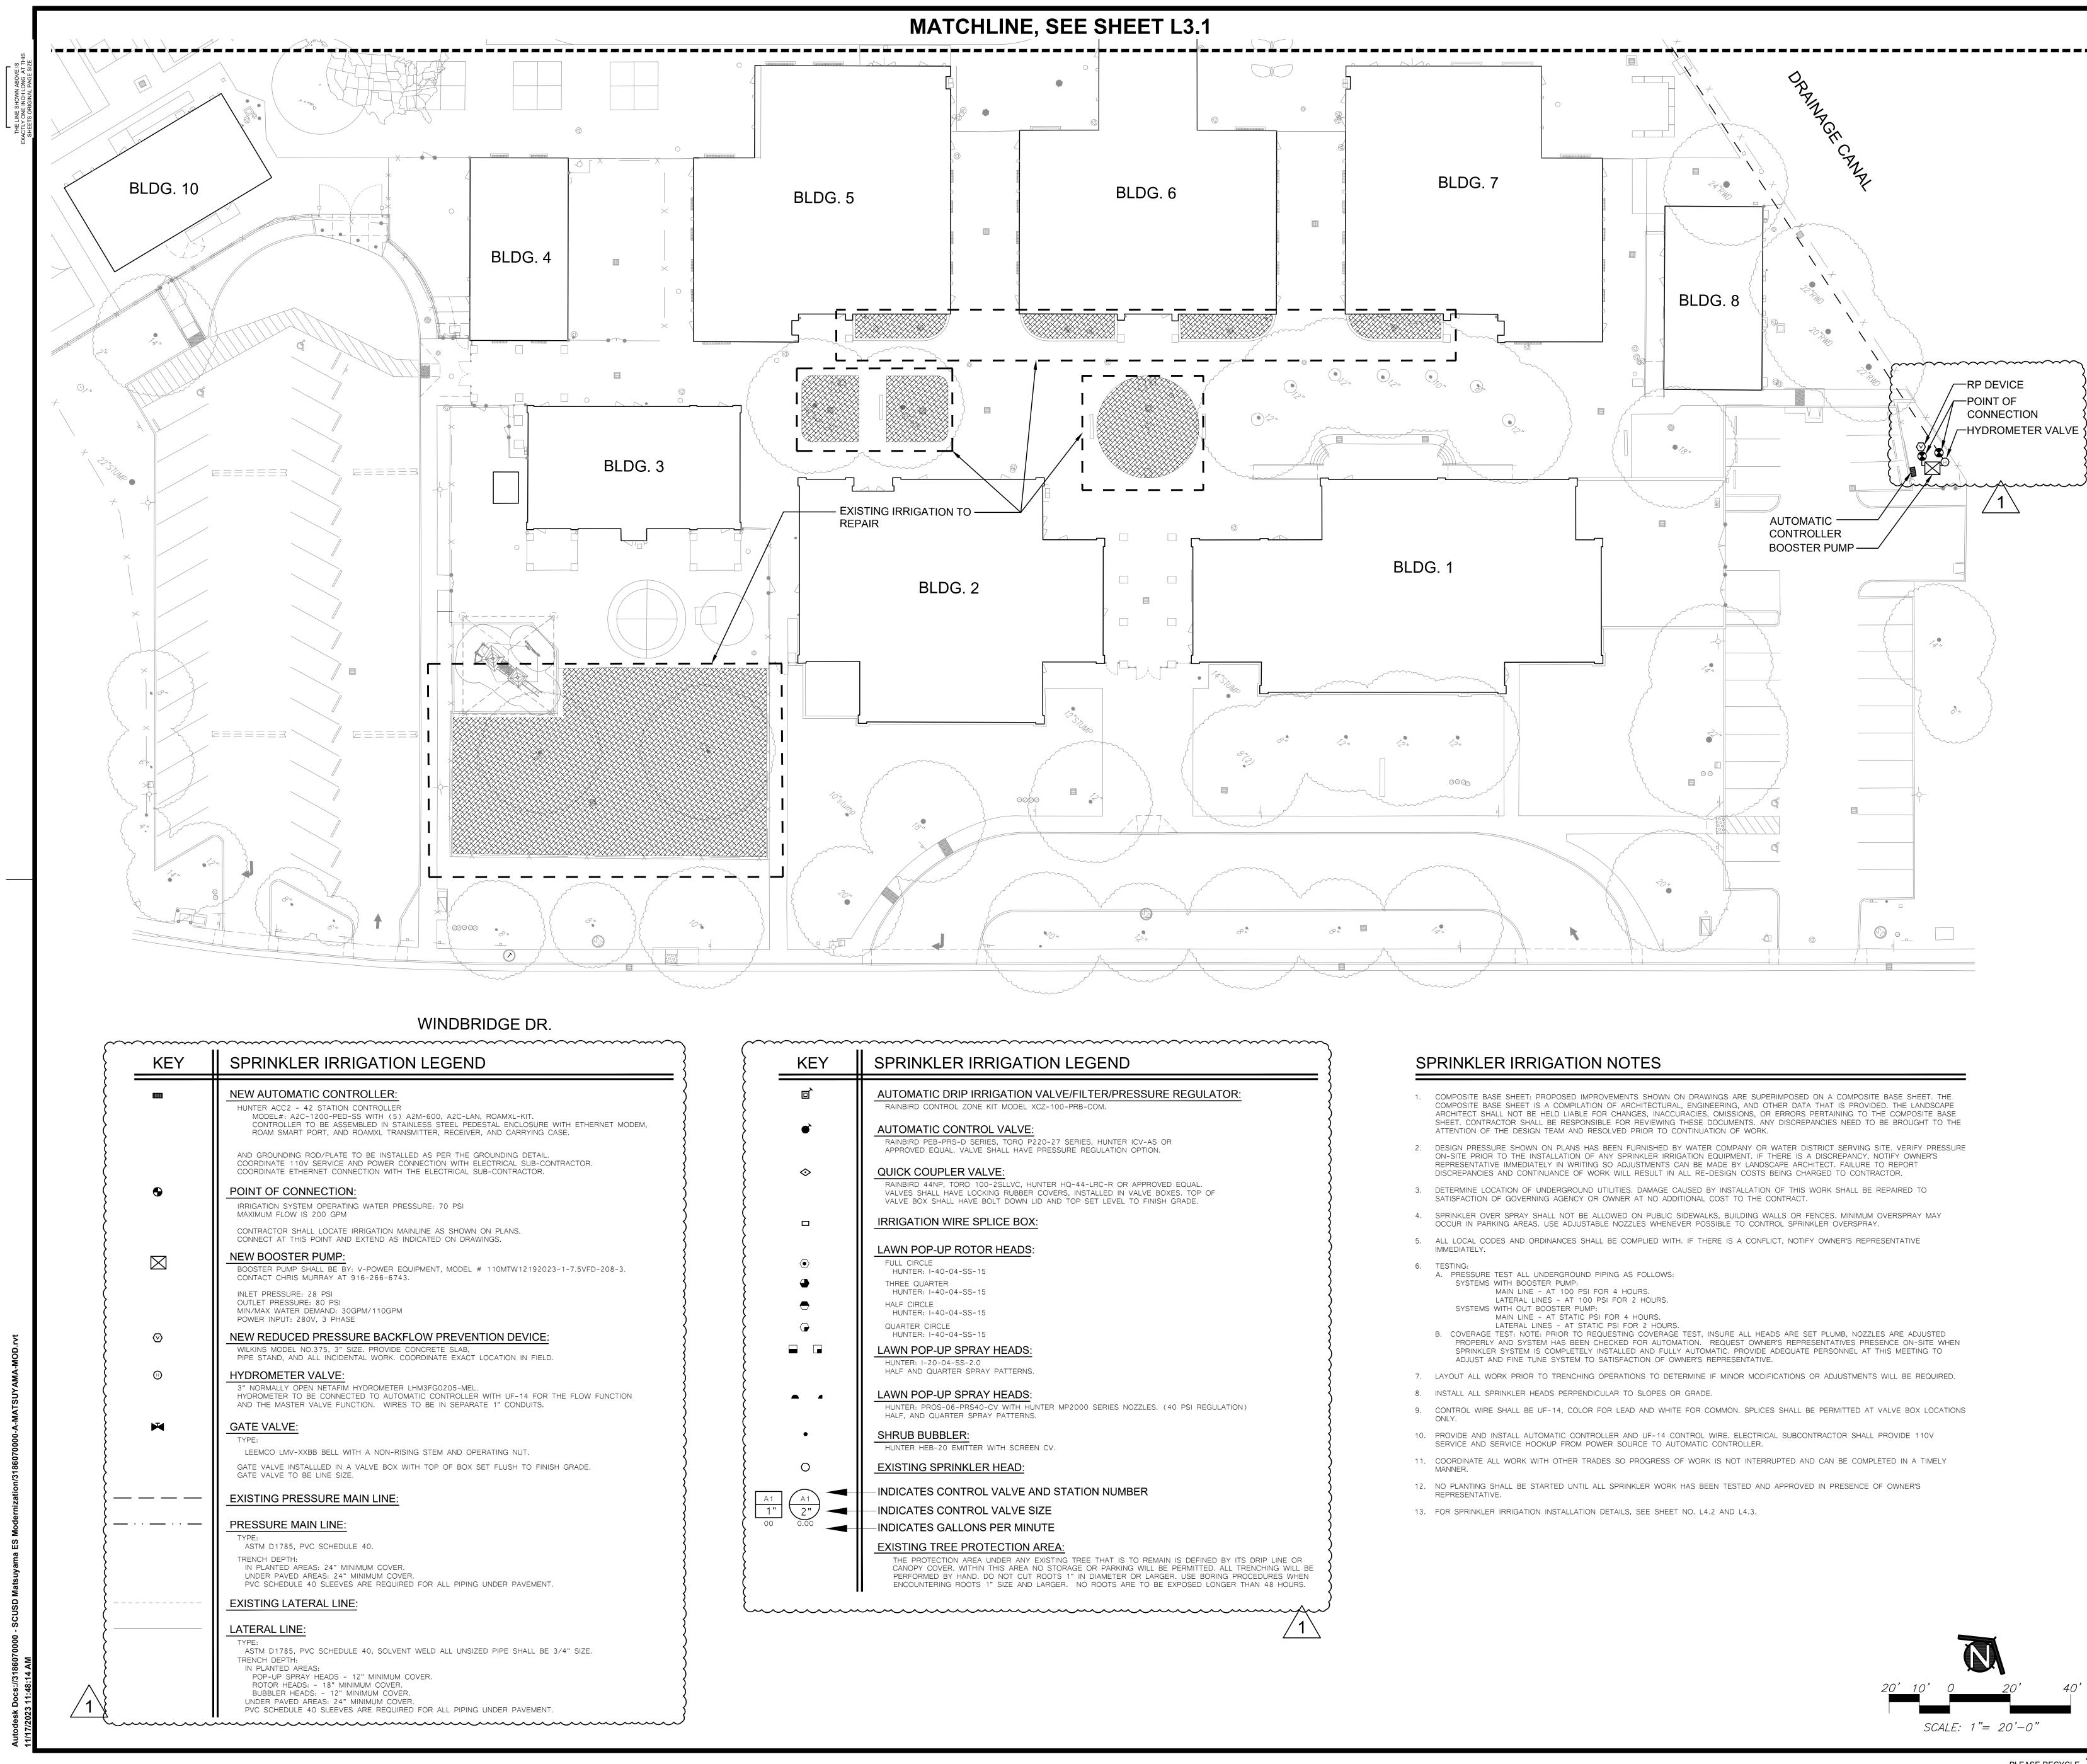
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03/01/2024

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916 369-3990 FACILITY:

7680 WINDBRIDGE DR.

PROJECT:

SHEET NAME:



DATE: 02/27/2024 SHEET:



CLIENT PROJ NO: 3186-070-000

DSA SUBMITTAL

LANDSCAPE IRRIGATION PLAN

MATSUYAMA ELEMENTARY SCHOOL MODERNIZATION

MATSUYAMA ELEMENTARY SCHOOL SACRMANETO, CA 95831




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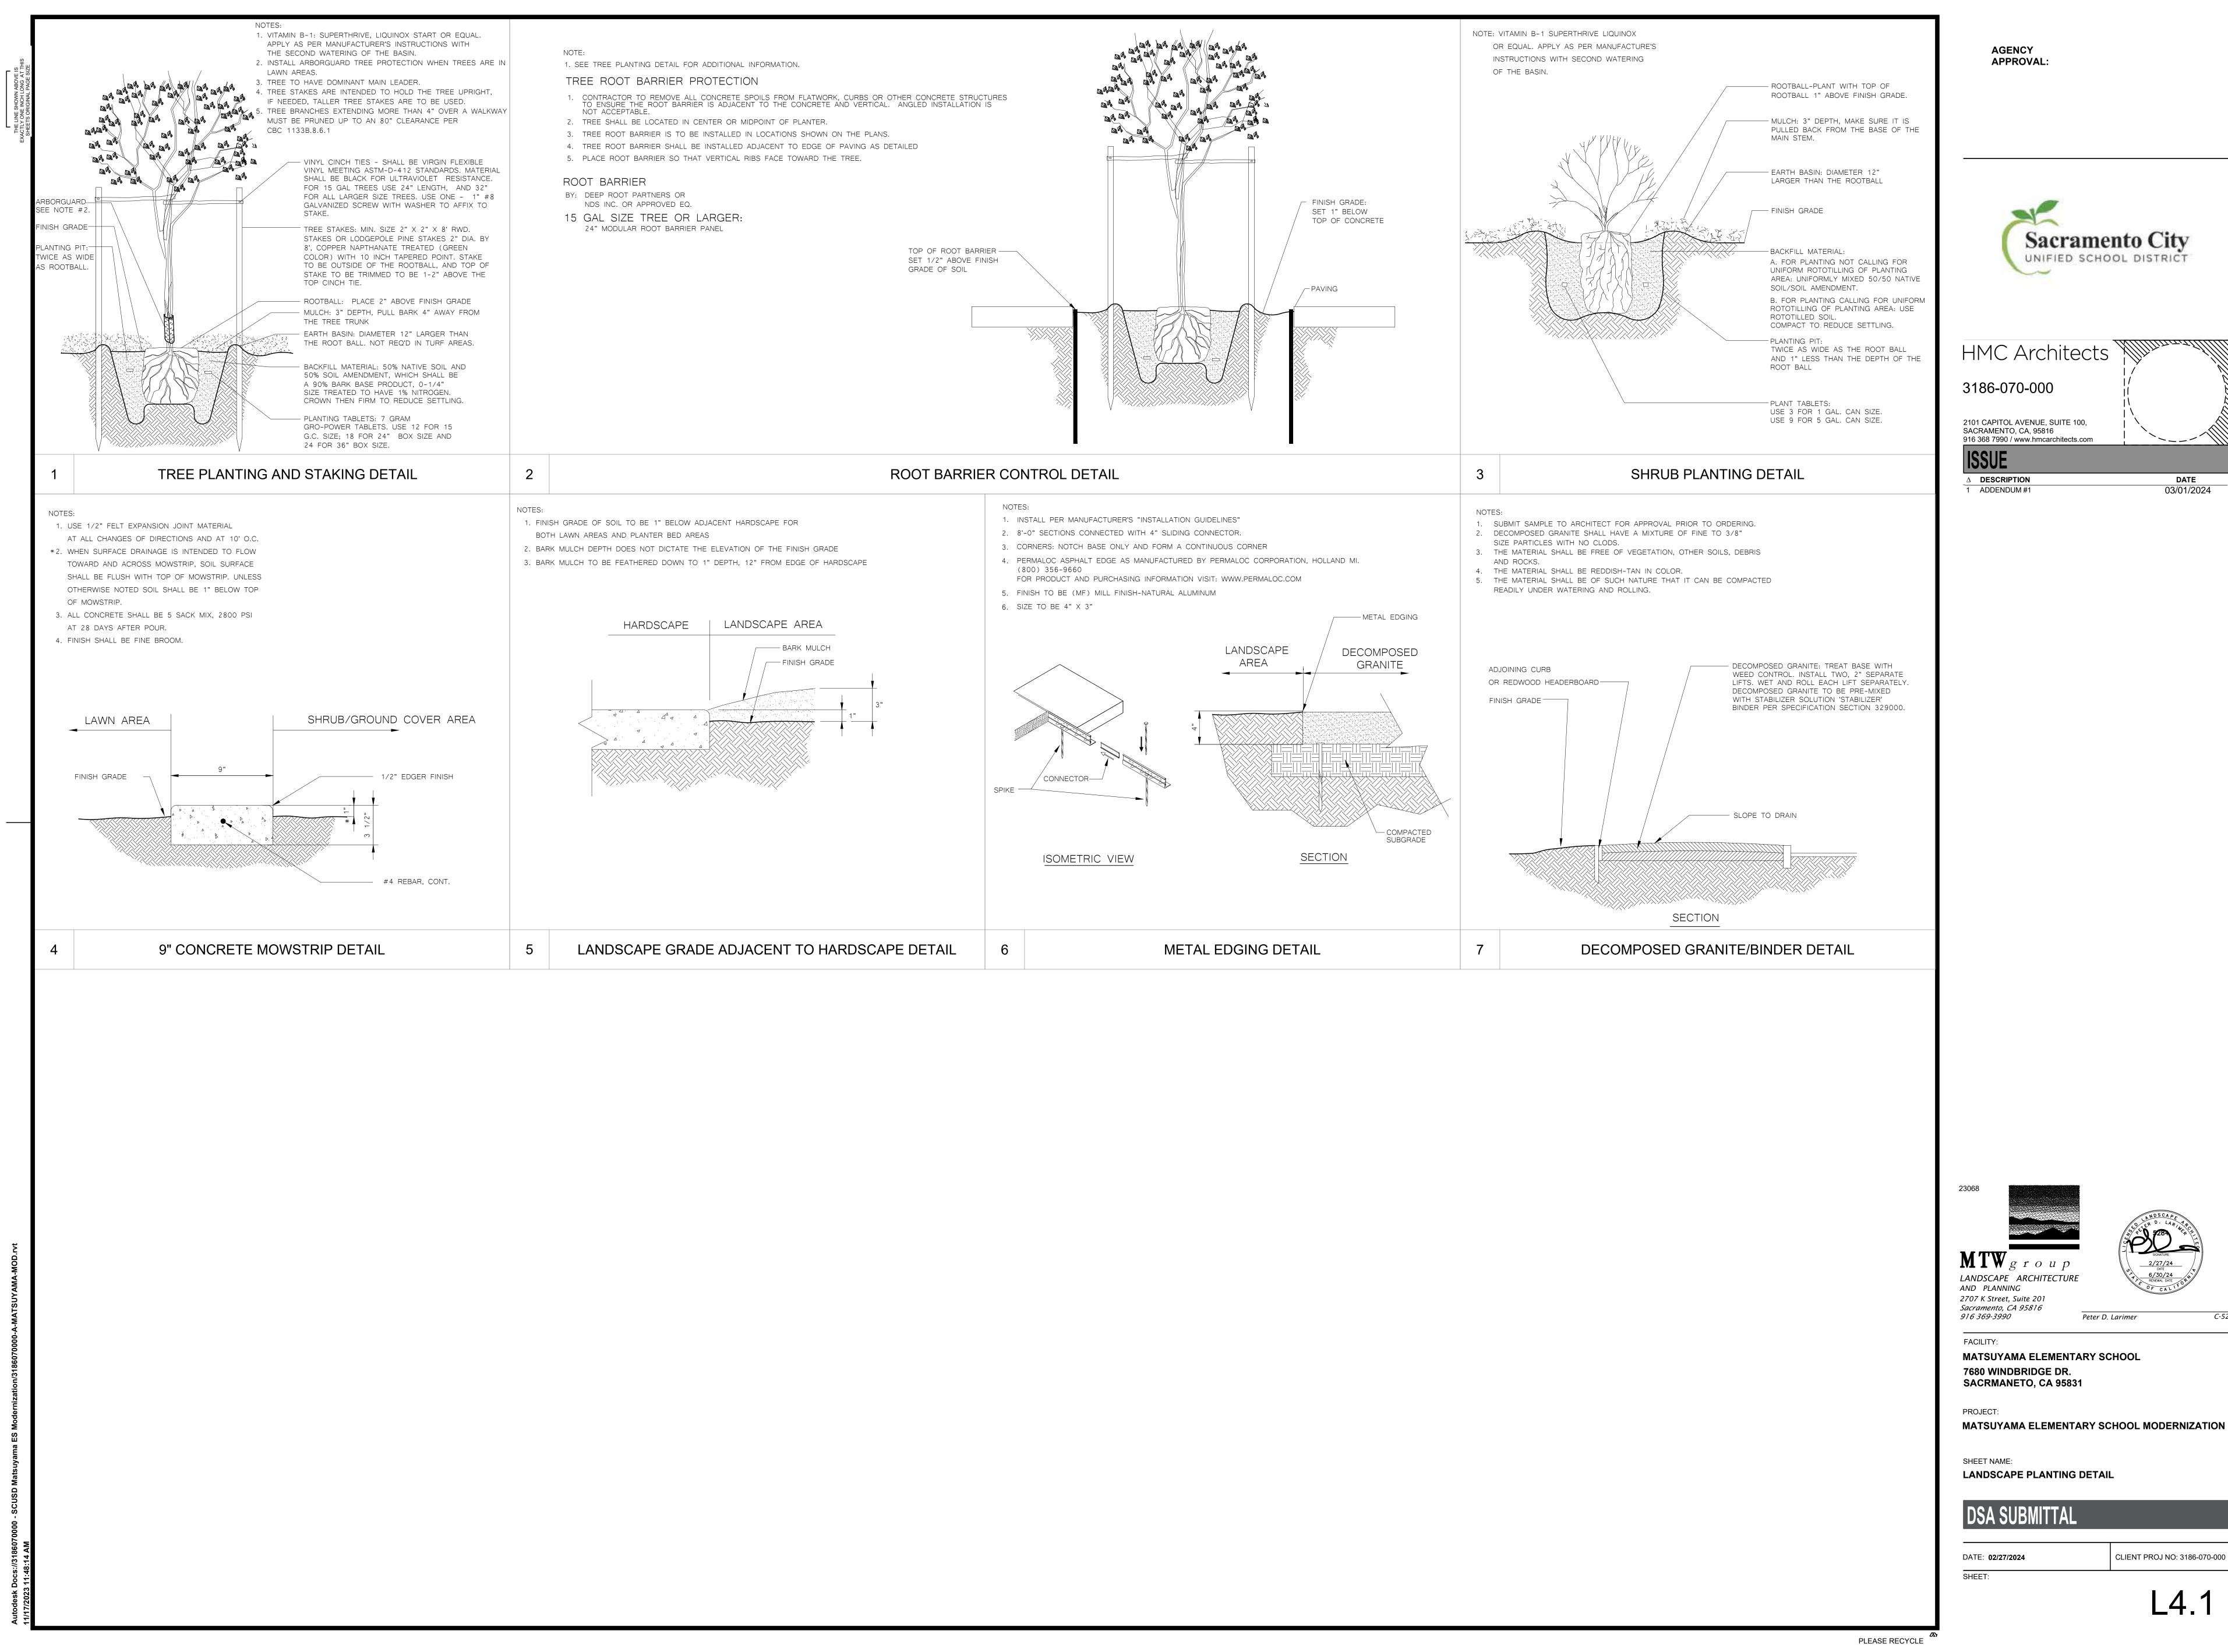
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UNIFIED SCHOOL DISTRIC










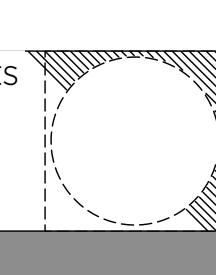

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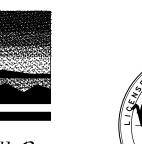
CLIENT PROJ NO: 3186-070-000

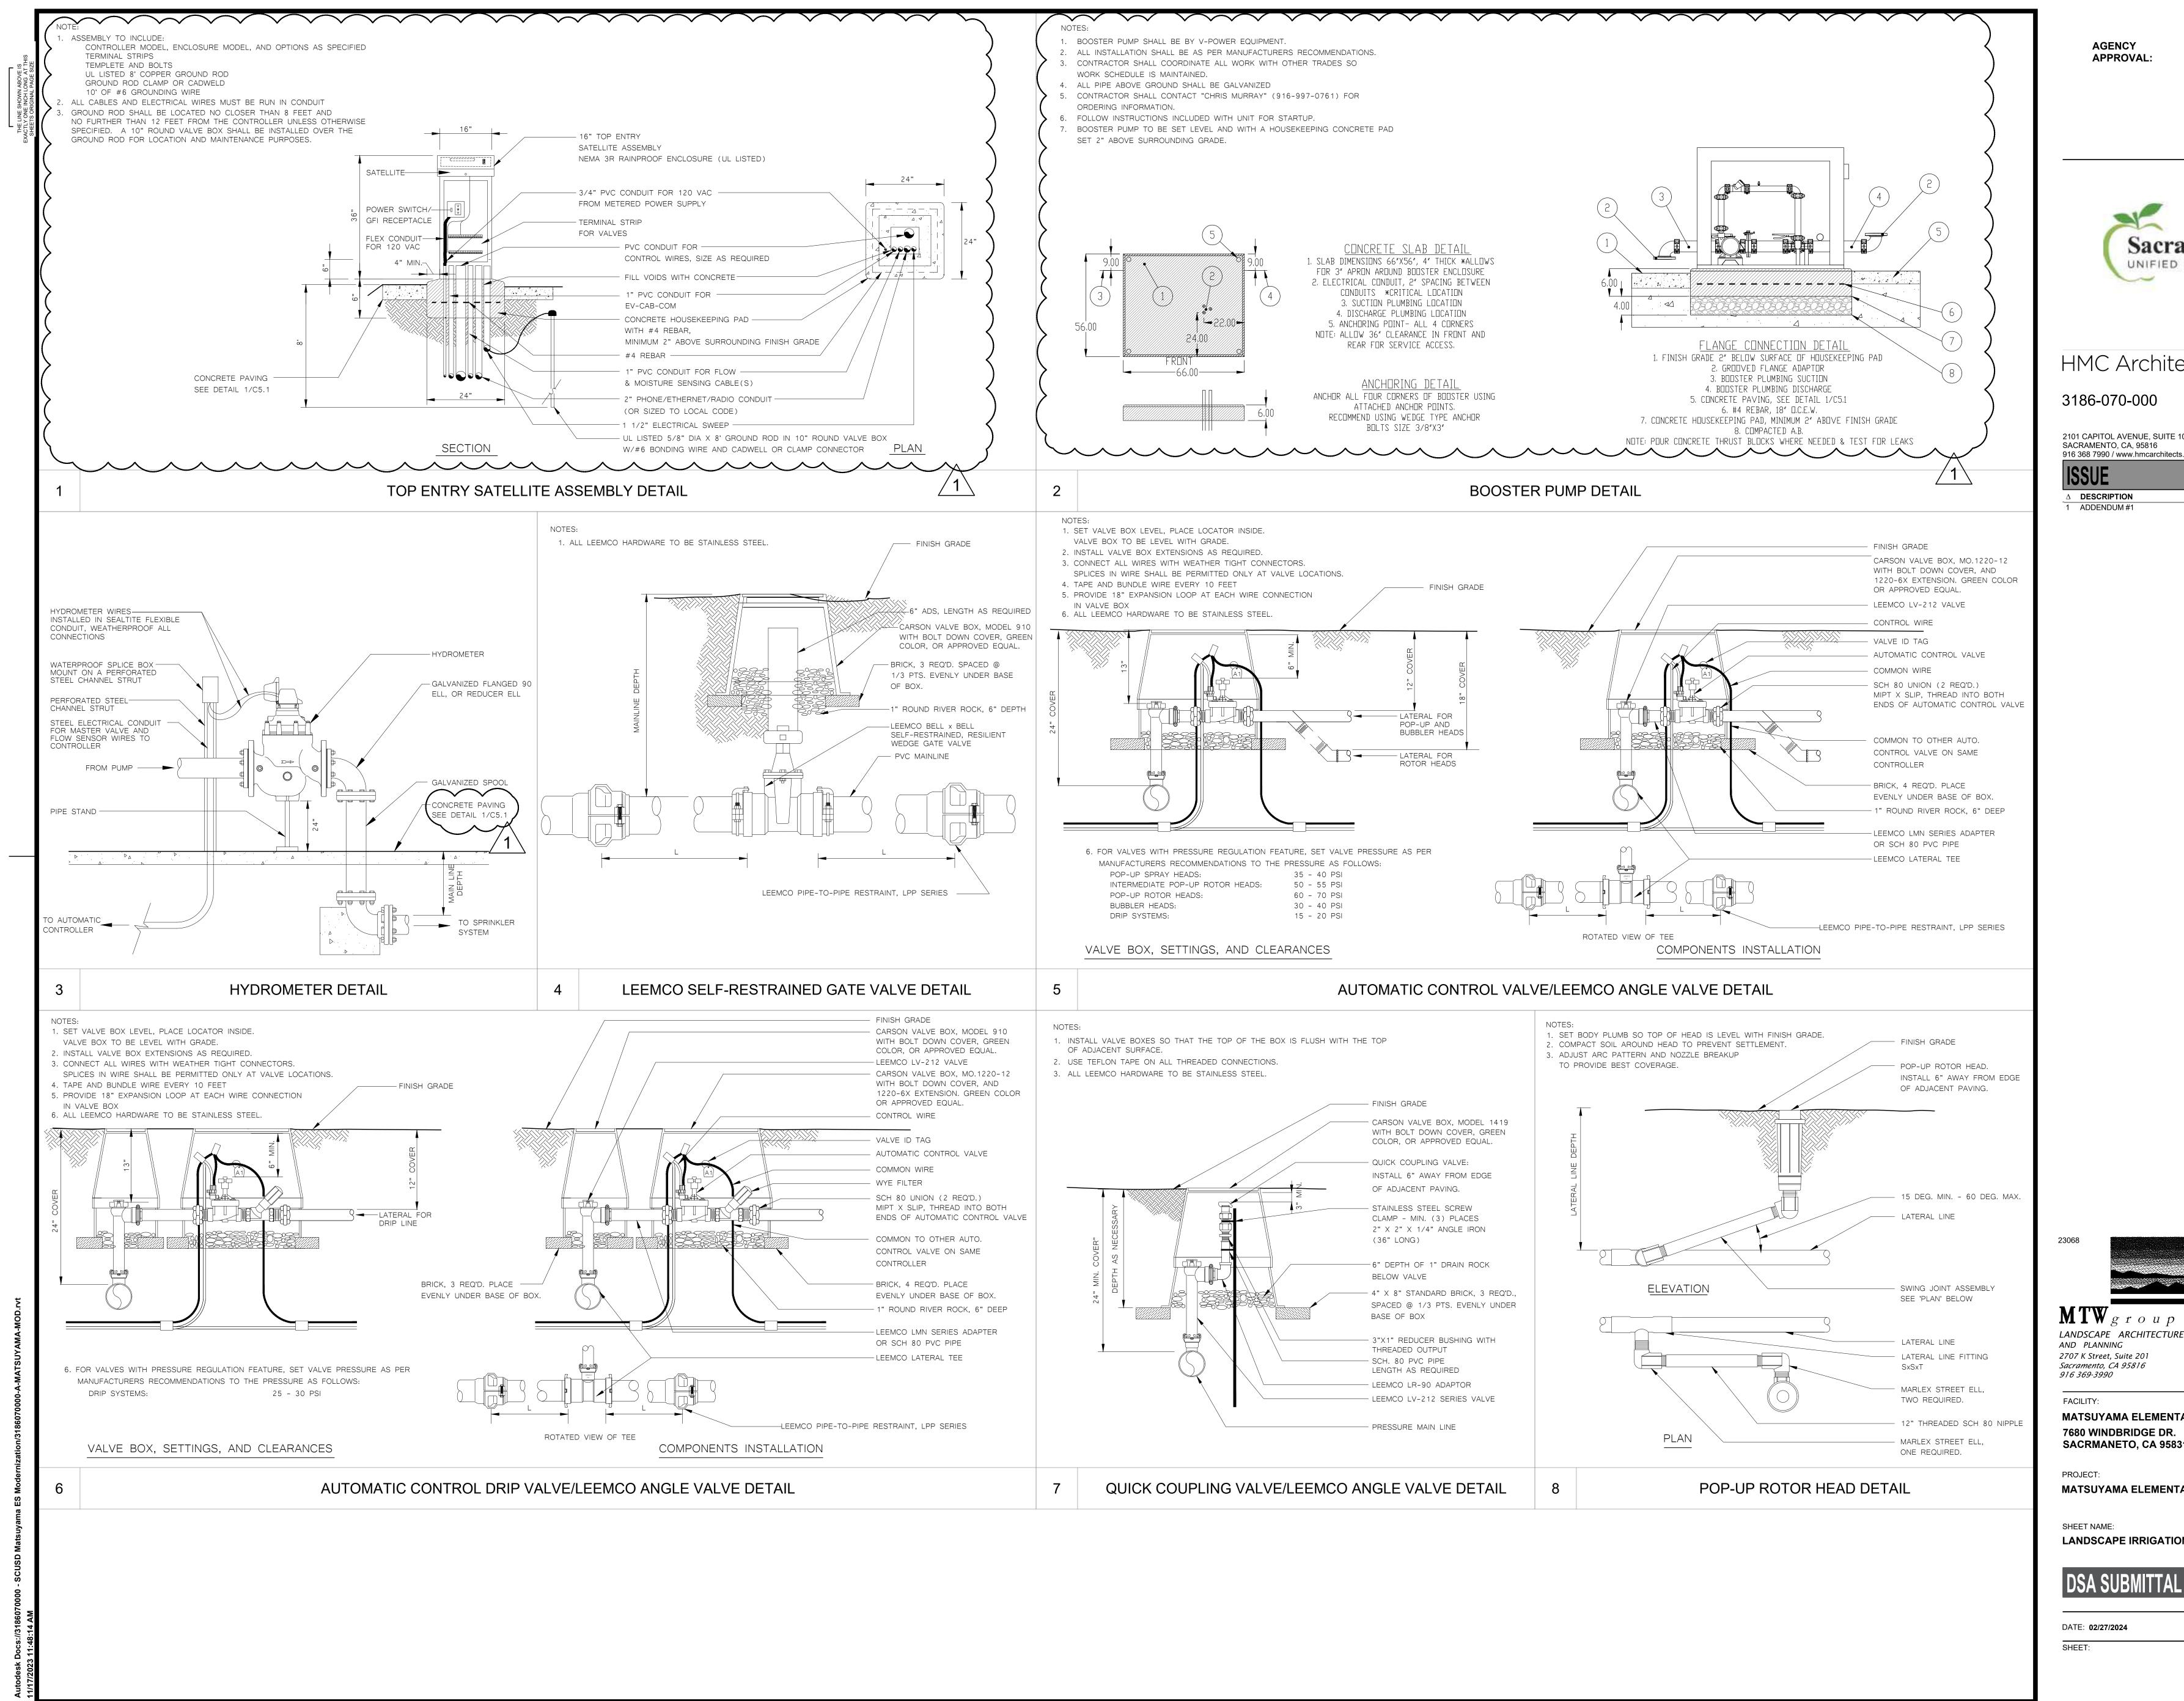LANDSCAPE IRRIGATION DETAIL

MATSUYAMA ELEMENTARY SCHOOL MODERNIZATION

MATSUYAMA ELEMENTARY SCHOOL SACRMANETO, CA 95831

LANDSCAPE ARCHITECTURE Peter D. Larimer





C-5284




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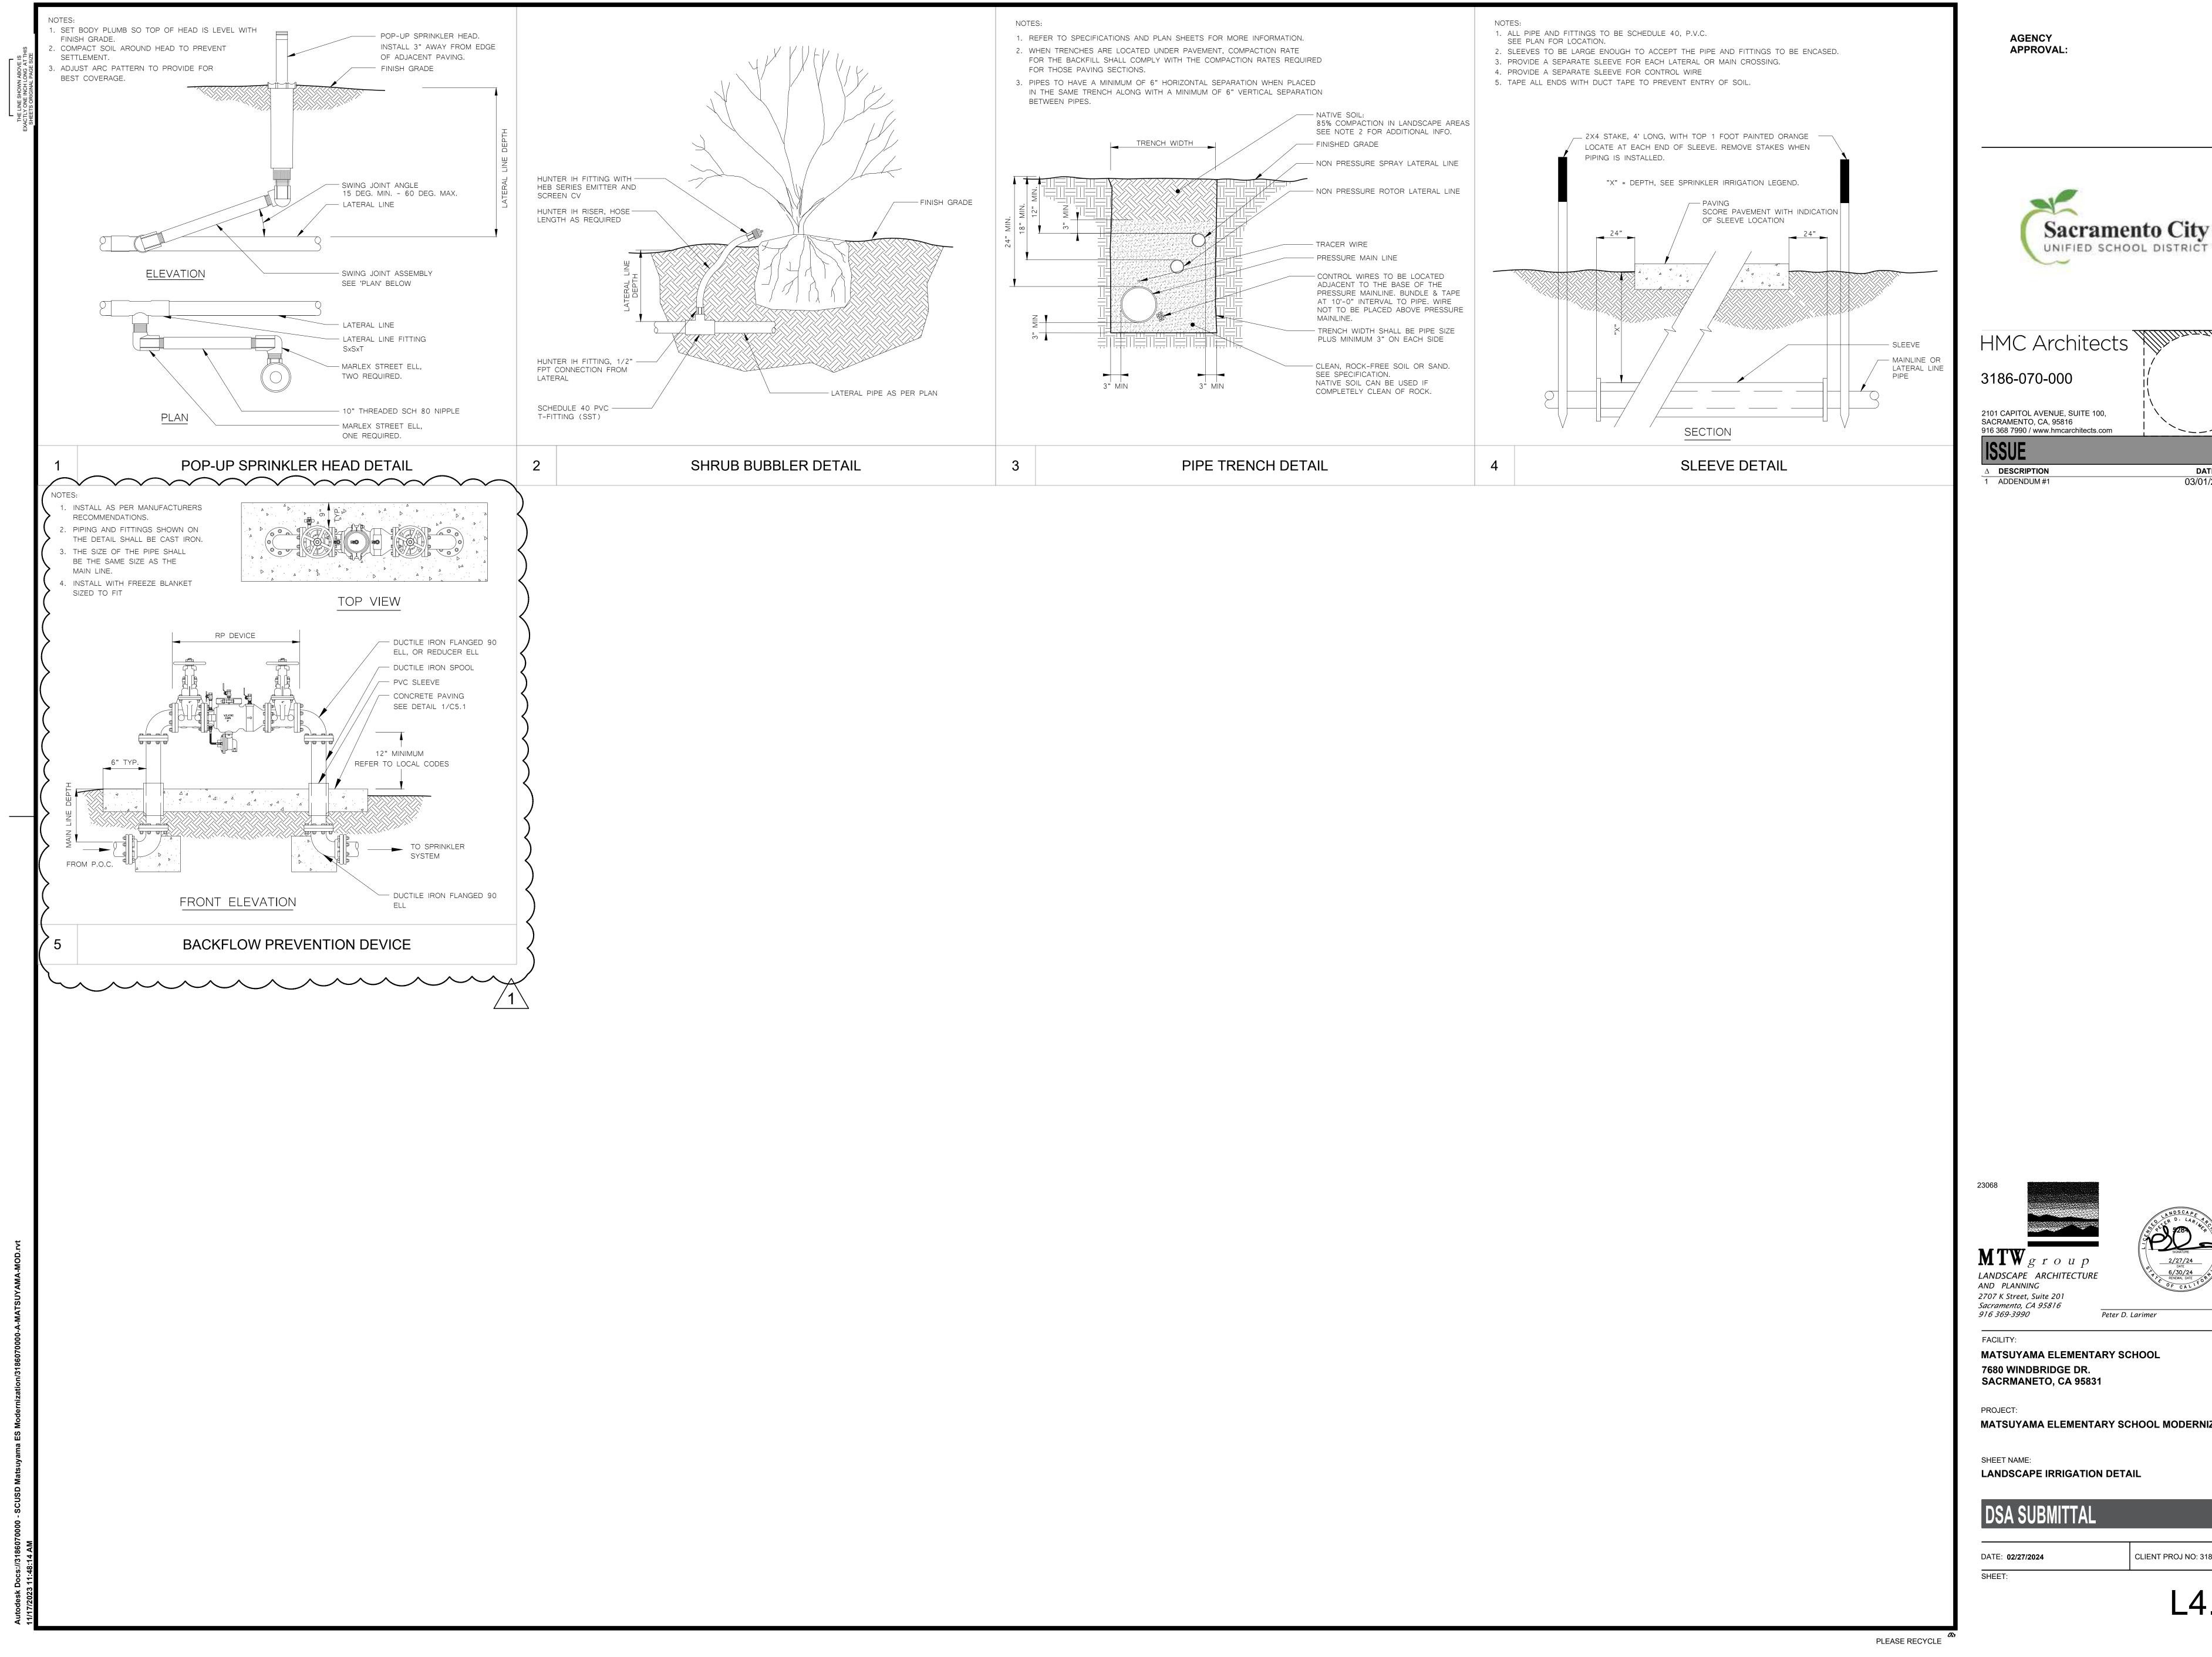
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DATE 03/01/2024

Sacramento City UNIFIED SCHOOL DISTRICT





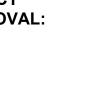

CLIENT PROJ NO: 3186-070-000

LANDSCAPE IRRIGATION DETAIL

MATSUYAMA ELEMENTARY SCHOOL MODERNIZATION

MATSUYAMA ELEMENTARY SCHOOL SACRMANETO, CA 95831

Peter D. Larimer



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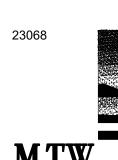
DATE 03/01/2024

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STATION #/HYDROZONE	PLANT WATER USE TYPE	PLANT FACTOR (PF)	HYDROZONE AREA (HA) (SQ.FT.)	PF x HA (SQ.FT.)	IRRIGATION EFFICIENCY (IE)	ETWU (GALLONS)			
1-9	LAWN - HIGH-SLA	0.8	55,226	44180.8	0.75	1,895,533			
10	SHRUB - LOW	0.2	4,368	873.6	0.81	34,705			
		TOTAL AREA	59,594		ETWU TOTAL	1,930,238			
		TOTAL AREA (SLA)	55,226						
Eto (Sacramento)	51.9								
		ESTIMATED TOTAL WATE	ER USAGE (ETWU) = (ETo)(0.62)((PF)(H	HA)/IE+SLA) = GAL/YEAR					
	MAXIMUM APPLIED WATER ALLOWANCE (MAWA) = (ETo)(0.62)[(0.45 x LA)+(0.55 x SLA)] = GAL/YEAR								
					MAWA TOTAL	1,840,311			

Plant Water Use Type	Plant Factor
Very Low	0 - 0.1
Low	0.2 - 0.3
Medium	0.4 - 0.6
High	0.7 - 1.0
SLA	1.0
Irrigation Efficiency	IE
Overhead	0.75
Drip	0.81

IRRIGATION HYDROZONE INFORMATION TABLE



LANDSCAPE ARCHITECTURE AND PLANNING 2707 K Street, Suite 201 Sacramento, CA 95816 916 369-3990

FACILITY:

PROJECT: MATSUYAMA ELEMENTARY SCHOOL MODERNIZATION

SHEET NAME: IRRIGATION CHARTS AND SHADING CALCULATION



DATE: 02/27/2024 SHEET:

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CLIENT PROJ NO: 3186-070-000

DSA SUBMITTAL

7680 WINDBRIDGE DR. SACRMANETO, CA 95831

MATSUYAMA ELEMENTARY SCHOOL

MTW group Peter D. Larimer



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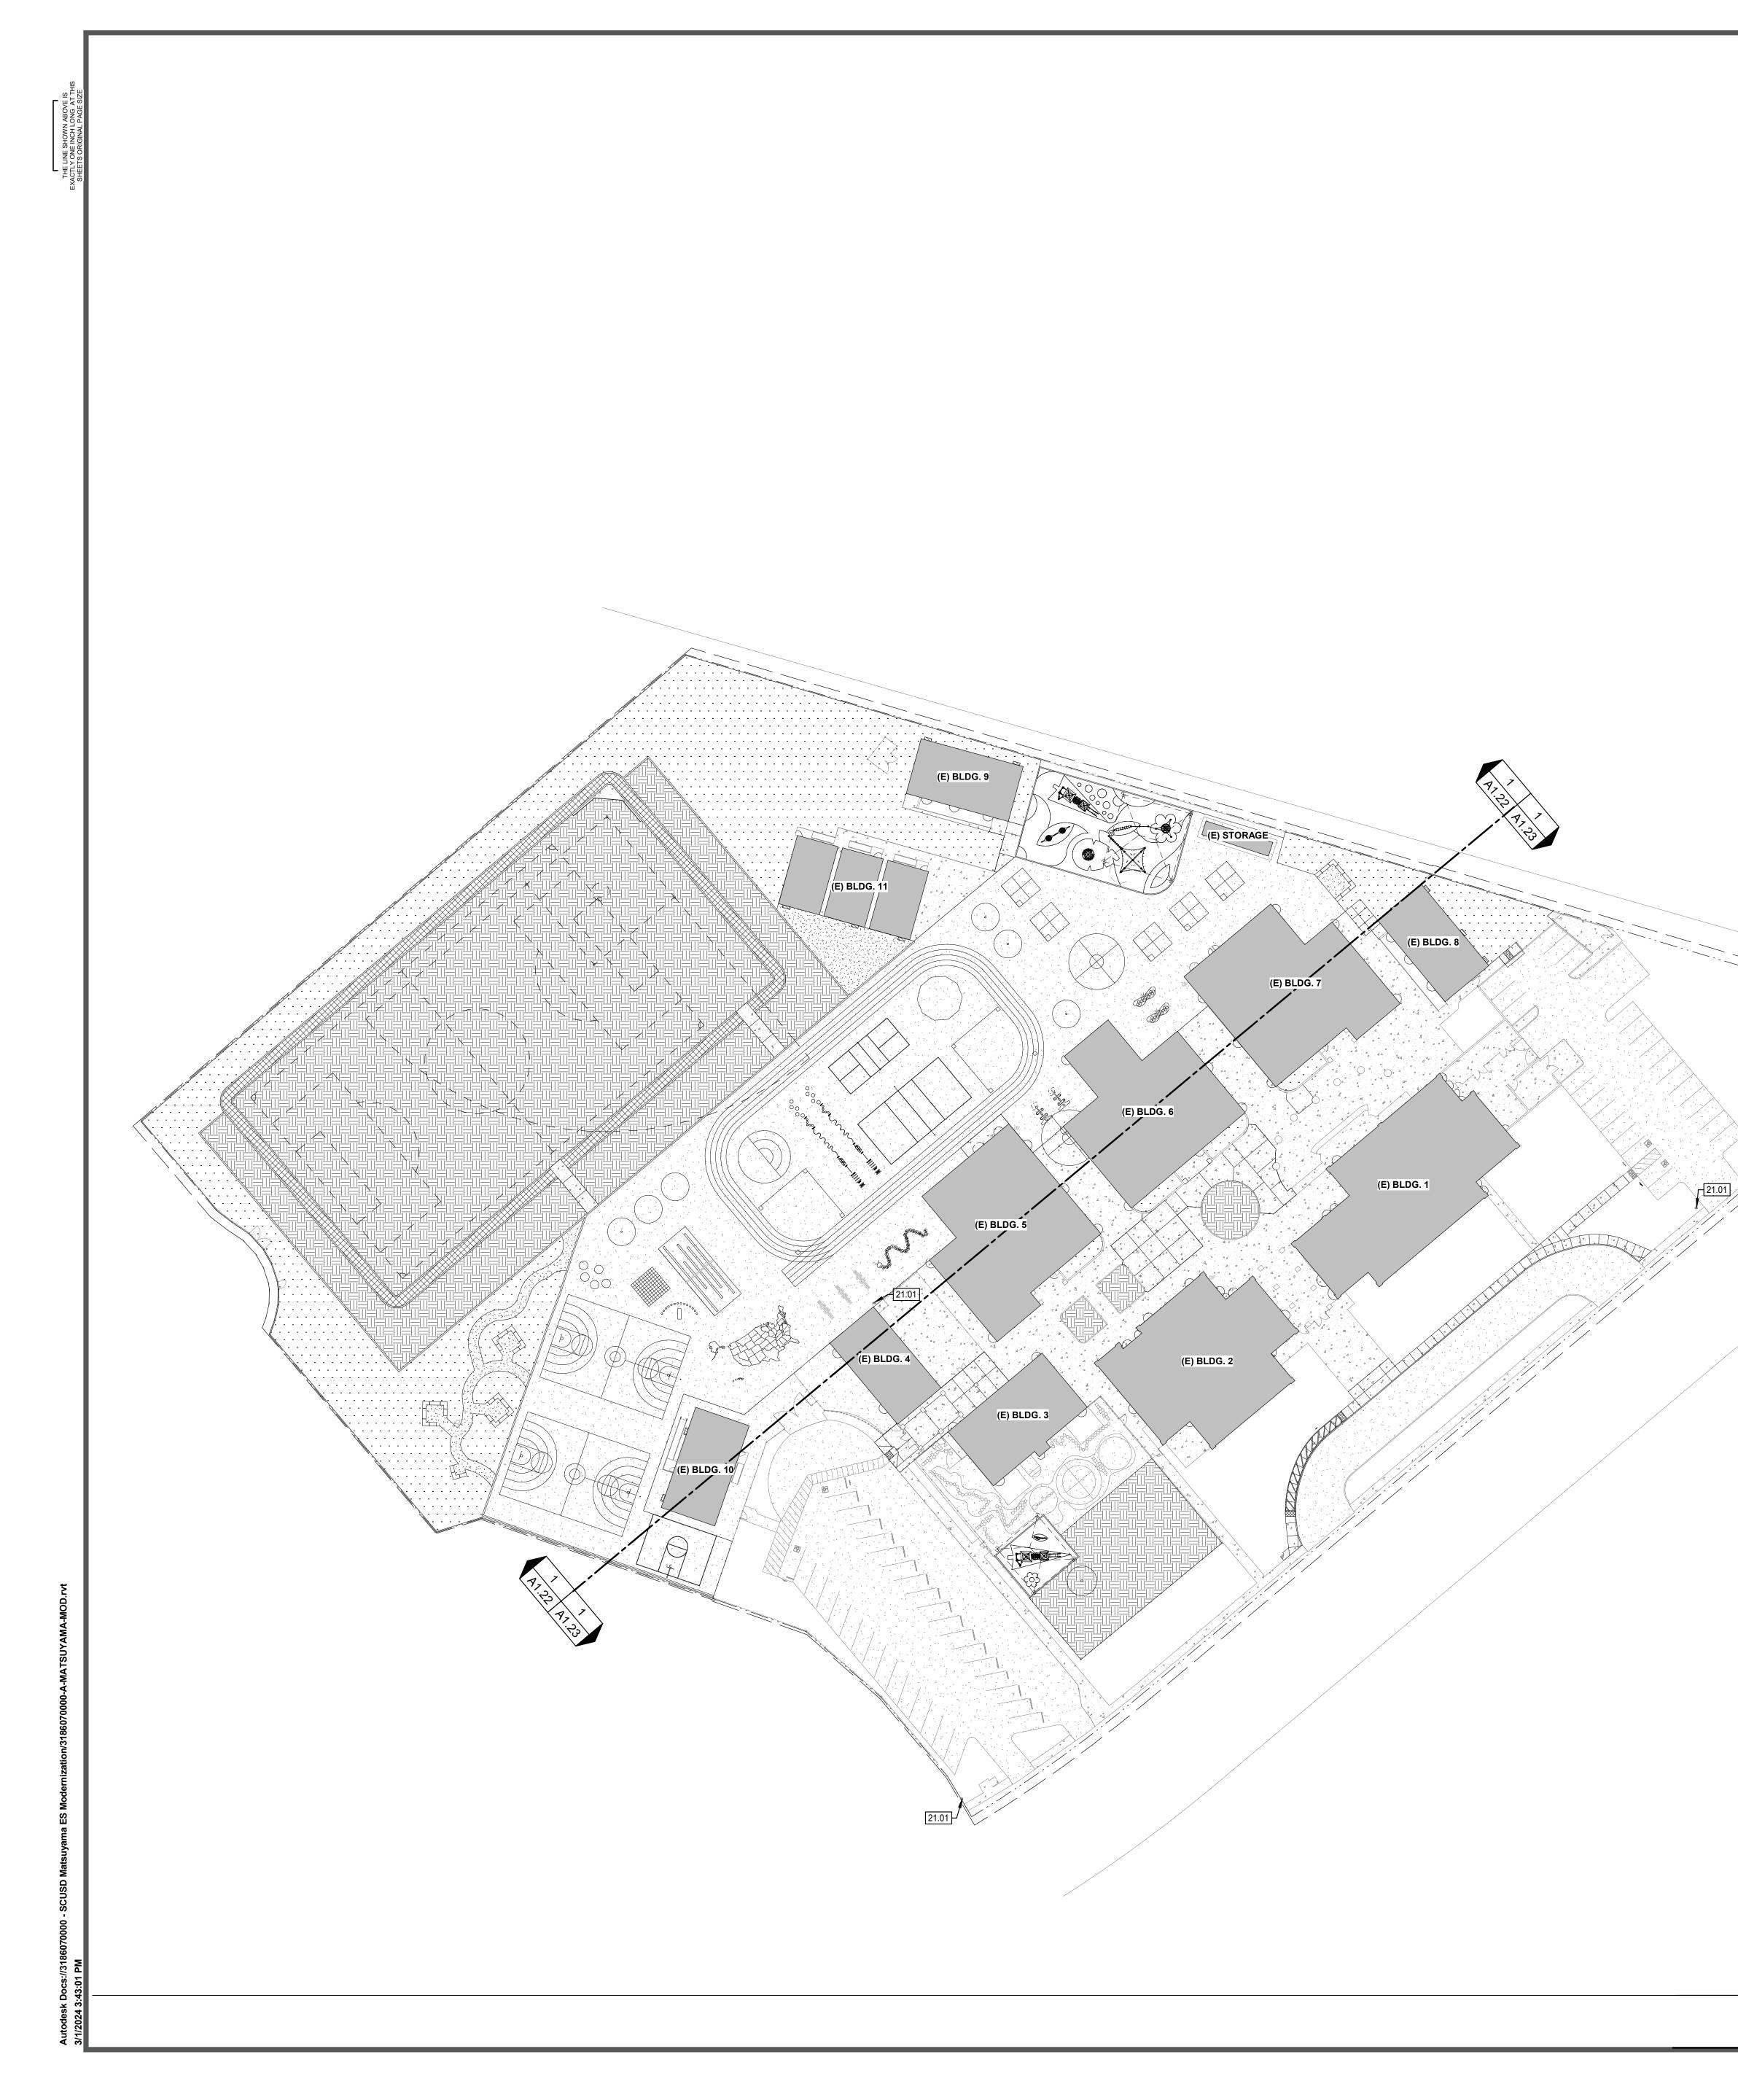
	_		
	<u>LEGEND</u>	APPROXIMATE LIMIT OF WORK. REFER TO ADDITIONAL DRAWINGS FOR WORK WHICH MAY EXTEND BEYOND THIS APPROXIMATE LIMIT OF WORK LINE.	
		PROPERTY LINE	
			Sacramento City
			HMC Architects 3186-070-000 C-25193 REN. 07/31/25
			2101 CAPITOL AVENUE, SUITE 100, SACRAMENTO, CA, 95816 916 368 7990 / www.hmcarchitects.com ISSUE <u>A</u> DESCRIPTION DATE 1 ADDENDUM #1 03/01/2024
			KEYNOTES
			02.01(E) ASPHALTIC CONCRETE PAVING TO REMAIN; PROTECT IN PLACE02.03REMOVE (E) CONCRETE CURB02.05(E) BALL WALL TO REMAIN; PROTECT IN PLACE02.08REMOVE (E) PLANTERS02.10REMOVE PORTION OF (E) ASPHALTIC CONCRETE PAVEMENT02.11REMOVE AND REINSTALL (E) RAMP PER CODE AFTER HARD COURT COMPLETION. APPLY NEW COATING ON RAMP.02.12REMOVE (E) SOCCER GOAL POST02.13REMOVE (E) CHAIN LINK BACKSTOP02.14REMOVE (E) PLAYGROUND APPARATUS02.15REMOVE (E) TREE02.16REMOVE PORTION OF (E) CONCRETE PAVEMENT SEE CIVIL DWGS
			02.17 REMOVE (E) ASPHALT HARDCOURT 02.18 REMOVE (E) ASPHALT PAVEMENT 02.72 REMOVE (E) BASKETBALL HOOP & FOOTING 02.73 REMOVE (E) PLAYGROUND POST & FOOTING 21.01 (E) FIRE HYDRANT
21.01			
			FACILITY: MATSUYAMA ELEMENTARY SCHOOL 7680 WINDBRIDGE DRIVE SACRAMENTO, CA 95831
			PROJECT: MATSUYAMA ELEMENTARY SCHOOL MODERNIZATION SHEET NAME:
TN			SITE DEMOLITION PLAN
			DATE: 01/04/2024 CLIENT PROJ NO: 3186-070-00 SHEET:
ARCHITECTURAL DEMOLITION SITE PLAN 1" = 40'-0"			A1.01



JBMITTAL







			1
		APPROXIMATE LIMIT OF WORK. REFER TO ADDITIONAL DRAWINGS FOR WORK WHICH MAY EXTEND BEYOND THIS APPROXIMATE LIMIT OF WORK LINE.	
		PROPERTY LINE	
		EXISTING BUILDING CONCRETE PAVEMENT	Sacramento City
		ASPHALT	UNIFIED SCHOOL DISTRICT
		BARK AND PLANTING, SEE LANDSCAPE DWGS GRASS, SEE LANDSCAPE DWGS	HMC Architects
		DECOMPOSED GRANITE, SEE LANDSCAPE DWGS	ATCHILECUS 3186-070-000 2101 CAPITOL AVENUE, SUITE 100, SACRAMENTO, CA, 95816 016 268 7000 (unum henographitoete com
		SYNTHETIC RUBBERIZED RUNNING TRACK, SEE CIVIL DWGS BARD UNIT TO BE REPLACED, SEE MECHANICAL AND ELECTRICAL DWGS FOR FULL SCOPE	916 368 7990 / www.hmcarchitects.com
		EXISTING CHAIN LINK FENCE	
			KEYNOTES 21.01 (E) FIRE HYDRANT
			NOTES 1. REFER TO SHEET 60.11 FOR TYPICAL SYMBOLS AND ABBREVIATIONS 2. REFER TO LANDSCAPE DRAWINGS FOR PAVING AND PLANTING INFORMATION 3. REFER TO MECHANICAL, ELECTRICAL, AND PLUMBING DRAWINGS FOR UTILITY INFORMATION 3. CONTRACTOR IS RESPONSIBLE FOR REPAIR REPLACEMENT OF ALL HARDSCAPE/PLANTING GUTS OF LIMIT OF WORK LINE FOR CONNECTION OF UNDERGROUND UTILITIES 3. REFER TO PARTIAL PLANS FOR MORE INFORMATION OVERALL PLANS ARE INTENDED TO PROVIDE CONTE FOR PARTIAL PLANS ARE INTENDED TO PROVIDE CONTE
			FACILITY: MATSUYAMA ELEMENTARY SCHOOL 7680 WINDBRIDGE DRIVE SACRAMENTO, CA 95831 PROJECT: MATSUYAMA ELEMENTARY SCHOOL MODERNIZA
TN			SHEET NAME: PROJECT SITE PLAN DSA SUBMITTAL
			DATE: 01/04/2024 CLIENT PROJ NO: 3186 SHEET:
ARCHITECTURAL SITE PLAN 1" = 40'-0"	1		A1.



CLIENT PROJ NO: 3186-070-000


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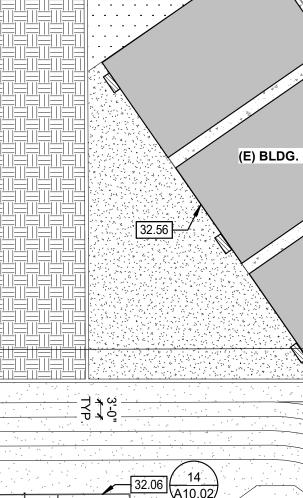
SITE PLAN

A ELEMENTARY SCHOOL MODERNIZATION

BRIDGE DRIVE NTO, CA 95831

FER TO SHEET G0.11 FOR TYPICAL SYMBOLS AND BREVIATIONS BREVIATIONS EFER TO LANDSCAPE DRAWINGS FOR PAVING AND ANTING INFORMATION EFER TO MECHANICAL, ELECTRICAL, AND PLUMBING RAWINGS FOR UTILITY INFORMATION DNTRACTOR IS RESPONSIBLE FOR REPAIR/ EPLACEMENT OF ALL HARDSCAPE/PLANTING OUTSIDE F LIMIT OF WORK LINE FOR CONNECTION OF NDERGROUND UTILITIES EFER TO PARTIAL PLANS FOR MORE INFORMATION. VERALL PLANS ARE INTENDED TO PROVIDE CONTEXT DR PARTIAL PLANS. AINT ALL (E) DECORATIVE METAL FENCE EFER TO SITE DETAIL SHEETS FOR PLAYGROUND IRIPING DIMENSIONS RCHITECT TO PROVIDE GRAPHICS FOR ALL THE AYGROUND STRIPINGS ESTRIPE ALL (E) EXTERIOR DOOR OPENINGS IROUGHOUT CAMPUS



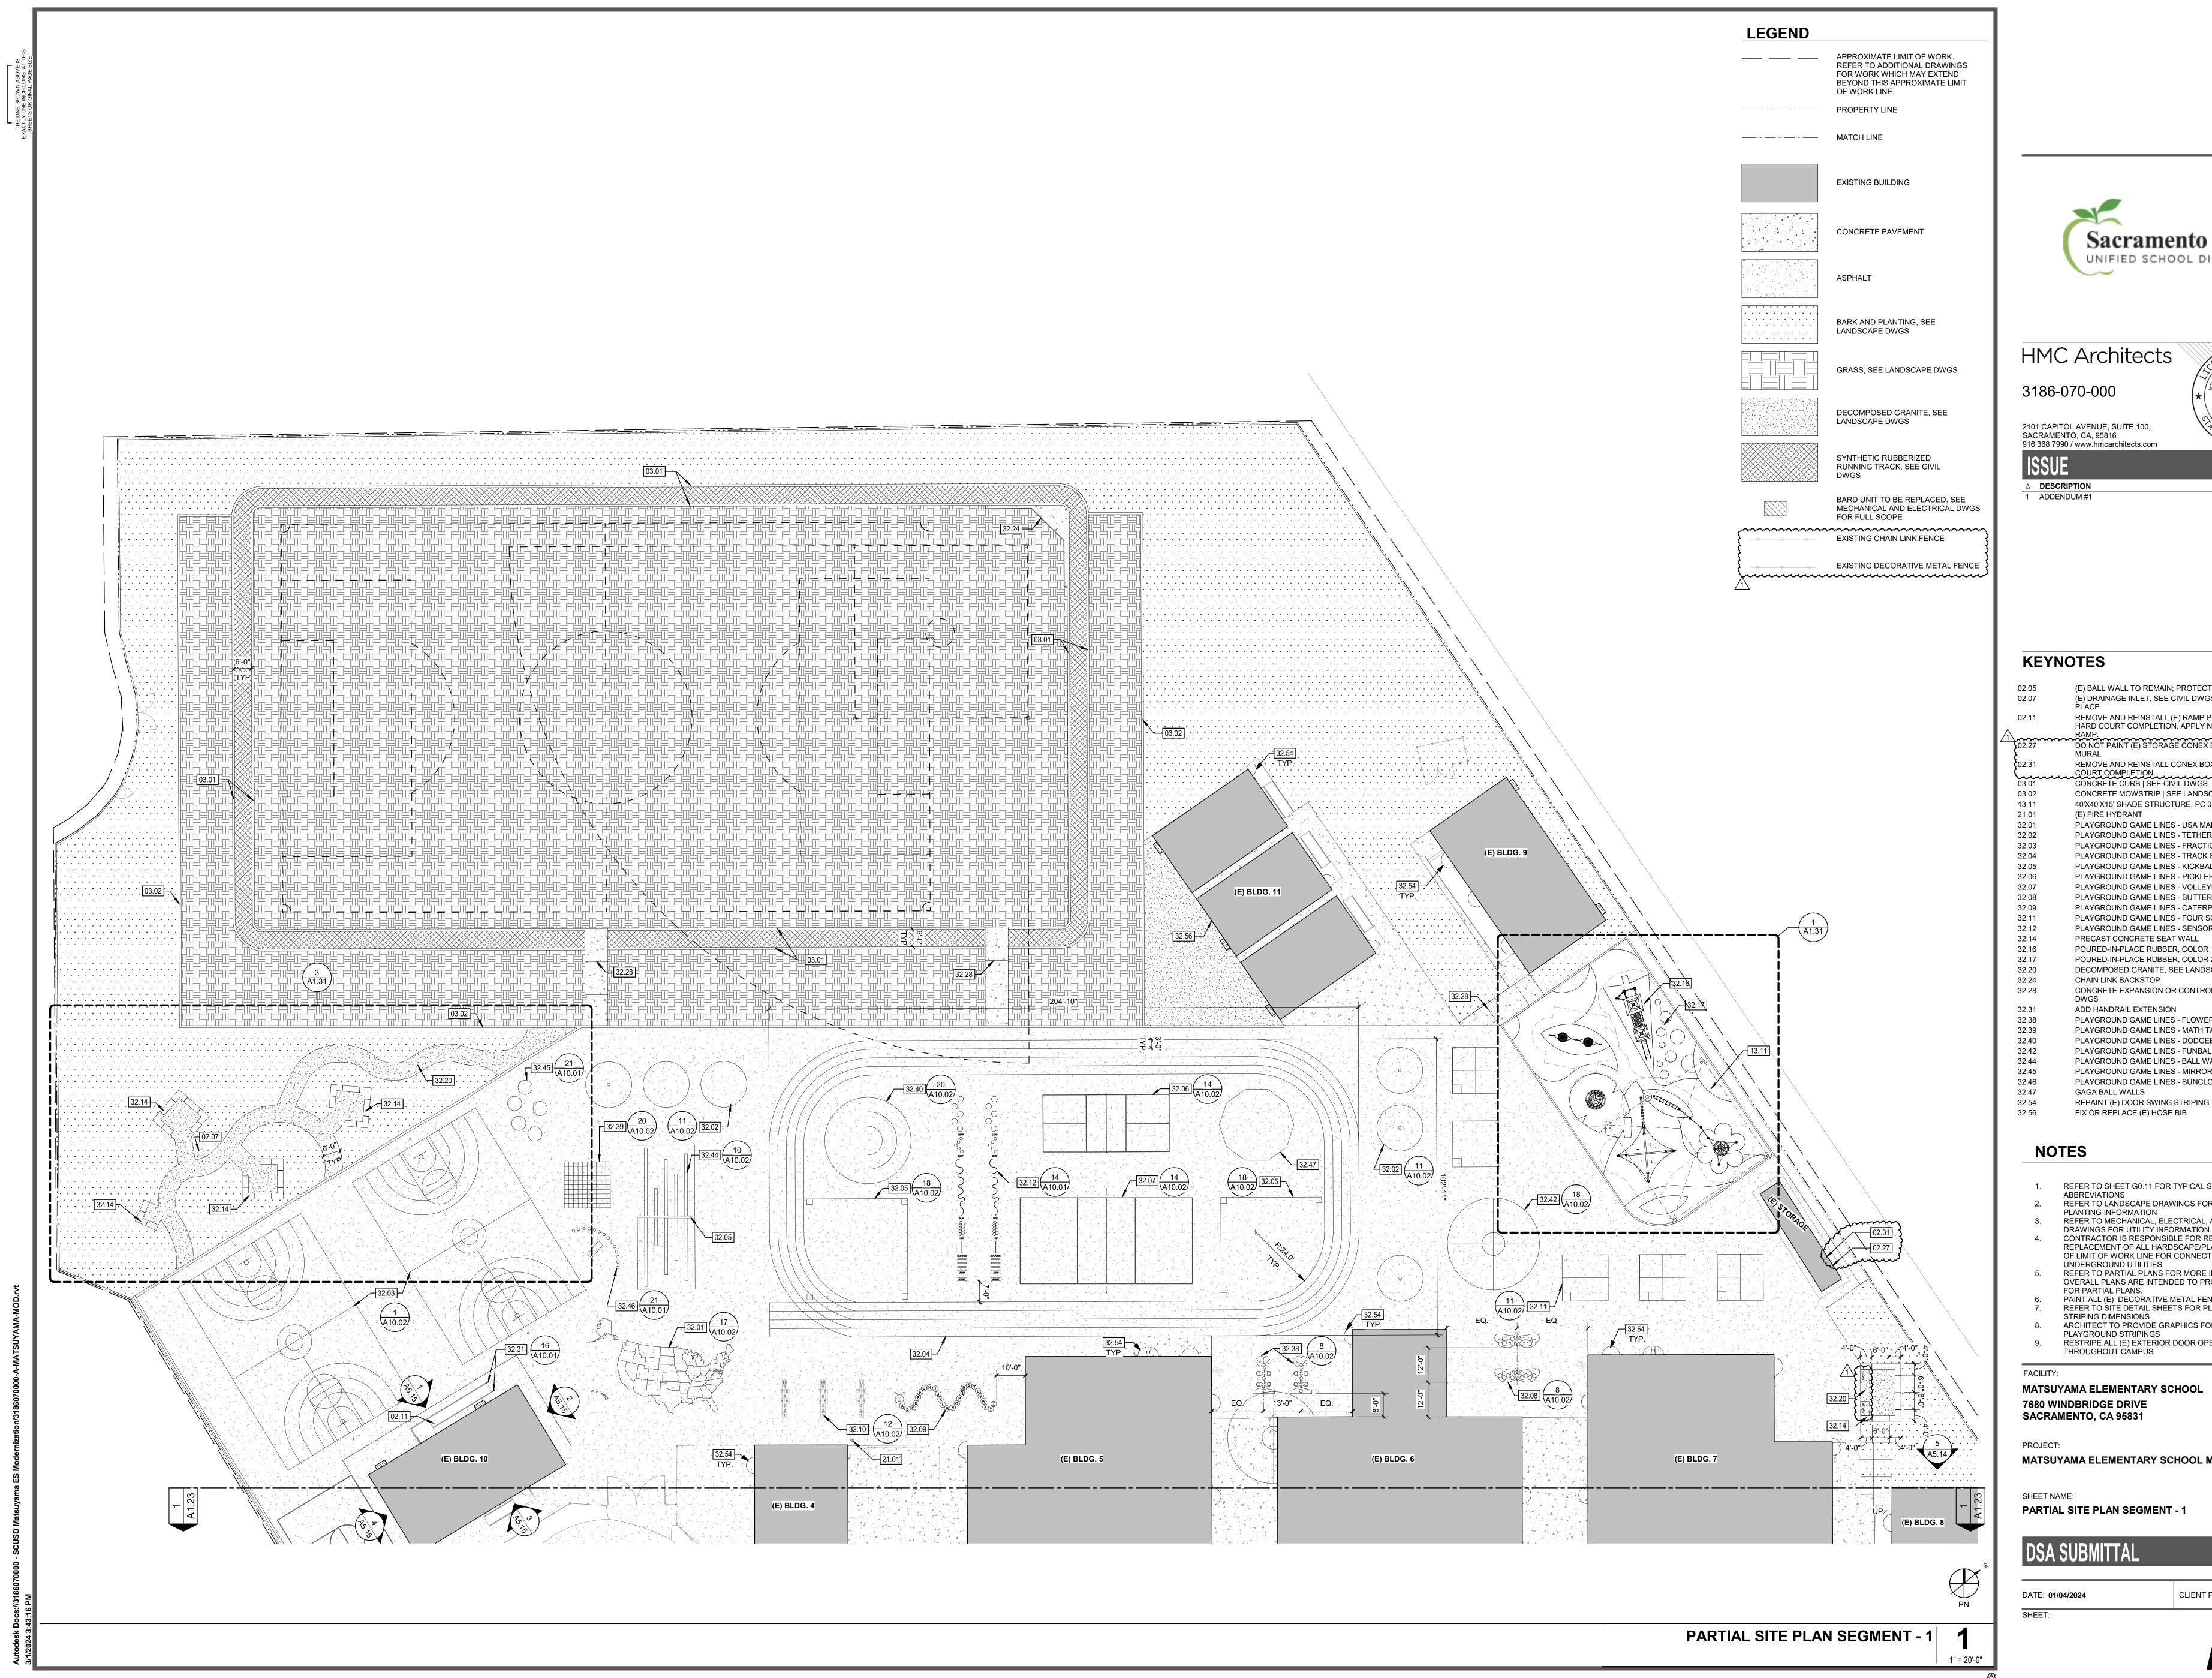

PLEASE RECYCLE



CLIENT PROJ NO: 3186-070-00

DSA SUBMITTAL

PARTIAL SITE PLAN SEGMENT - 1

MATSUYAMA ELEMENTARY SCHOOL MODERNIZATION

7680 WINDBRIDGE DRIVE SACRAMENTO, CA 95831

MATSUYAMA ELEMENTARY SCHOOL

THROUGHOUT CAMPUS

PLAYGROUND STRIPINGS RESTRIPE ALL (E) EXTERIOR DOOR OPENINGS

FOR PARTIAL PLANS. PAINT ALL (E) DECORATIVE METAL FENCE REFER TO SITE DETAIL SHEETS FOR PLAYGROUND STRIPING DIMENSIONS ARCHITECT TO PROVIDE GRAPHICS FOR ALL THE

CONTRACTOR IS RESPONSIBLE FOR REPAIR/ REPLACEMENT OF ALL HARDSCAPE/PLANTING OUTSIDE OF LIMIT OF WORK LINE FOR CONNECTION OF UNDERGROUND UTILITIES REFER TO PARTIAL PLANS FOR MORE INFORMATION. OVERALL PLANS ARE INTENDED TO PROVIDE CONTEXT

REFER TO SHEET G0.11 FOR TYPICAL SYMBOLS AND ABBREVIATIONS REFER TO LANDSCAPE DRAWINGS FOR PAVING AND PLANTING INFORMATION REFER TO MECHANICAL, ELECTRICAL, AND PLUMBING DRAWINGS FOR UTILITY INFORMATION


COURT COMPLETION. CONCRETE CURB | SEE CIVIL DWGS CONCRETE MOWSTRIP | SEE LANDSCAPE DWGS 40'X40'X15' SHADE STRUCTURE, PC 04-121917 (E) FIRE HYDRANT PLAYGROUND GAME LINES - USA MAP PLAYGROUND GAME LINES - TETHERBALL PLAYGROUND GAME LINES - FRACTION BALL PLAYGROUND GAME LINES - TRACK STRIPING PLAYGROUND GAME LINES - KICKBALL STRIPING PLAYGROUND GAME LINES - PICKLEBALL PLAYGROUND GAME LINES - VOLLEYBALL PLAYGROUND GAME LINES - BUTTERFLY HOPSCOTCH PLAYGROUND GAME LINES - CATERPILLAR PLAYGROUND GAME LINES - FOUR SQUARE PLAYGROUND GAME LINES - SENSORY PATH PRECAST CONCRETE SEAT WALL POURED-IN-PLACE RUBBER, COLOR 1 POURED-IN-PLACE RUBBER, COLOR 2 DECOMPOSED GRANITE, SEE LANDSCAPE DWGS CHAIN LINK BACKSTOP CONCRETE EXPANSION OR CONTROL JOINT, SEE CIVIL DWGS ADD HANDRAIL EXTENSION PLAYGROUND GAME LINES - FLOWER PLAYGROUND GAME LINES - MATH TABLE PLAYGROUND GAME LINES - DODGEBALL PLAYGROUND GAME LINES - FUNBALL PLAYGROUND GAME LINES - BALL WALL PLAYGROUND GAME LINES - MIRROR ME PLAYGROUND GAME LINES - SUNCLOCK GAGA BALL WALLS

(E) BALL WALL TO REMAIN; PROTECT IN PLACE (E) DRAINAGE INLET, SEE CIVIL DWGS; PROTECT IN PLACE REMOVE AND REINSTALL (E) RAMP PER CODE AFTER HARD COURT COMPLETION. APPLY NEW COATING ON DO NOT PAINT (E) STORAGE CONEX BOX, PROTECT (E) MURAI REMOVE AND REINSTALL CONEX BOX AFTER HARD

HMC Architects C-25193 REN.07/31/25


Sacramento City

UNIFIED SCHOOL DISTRICT

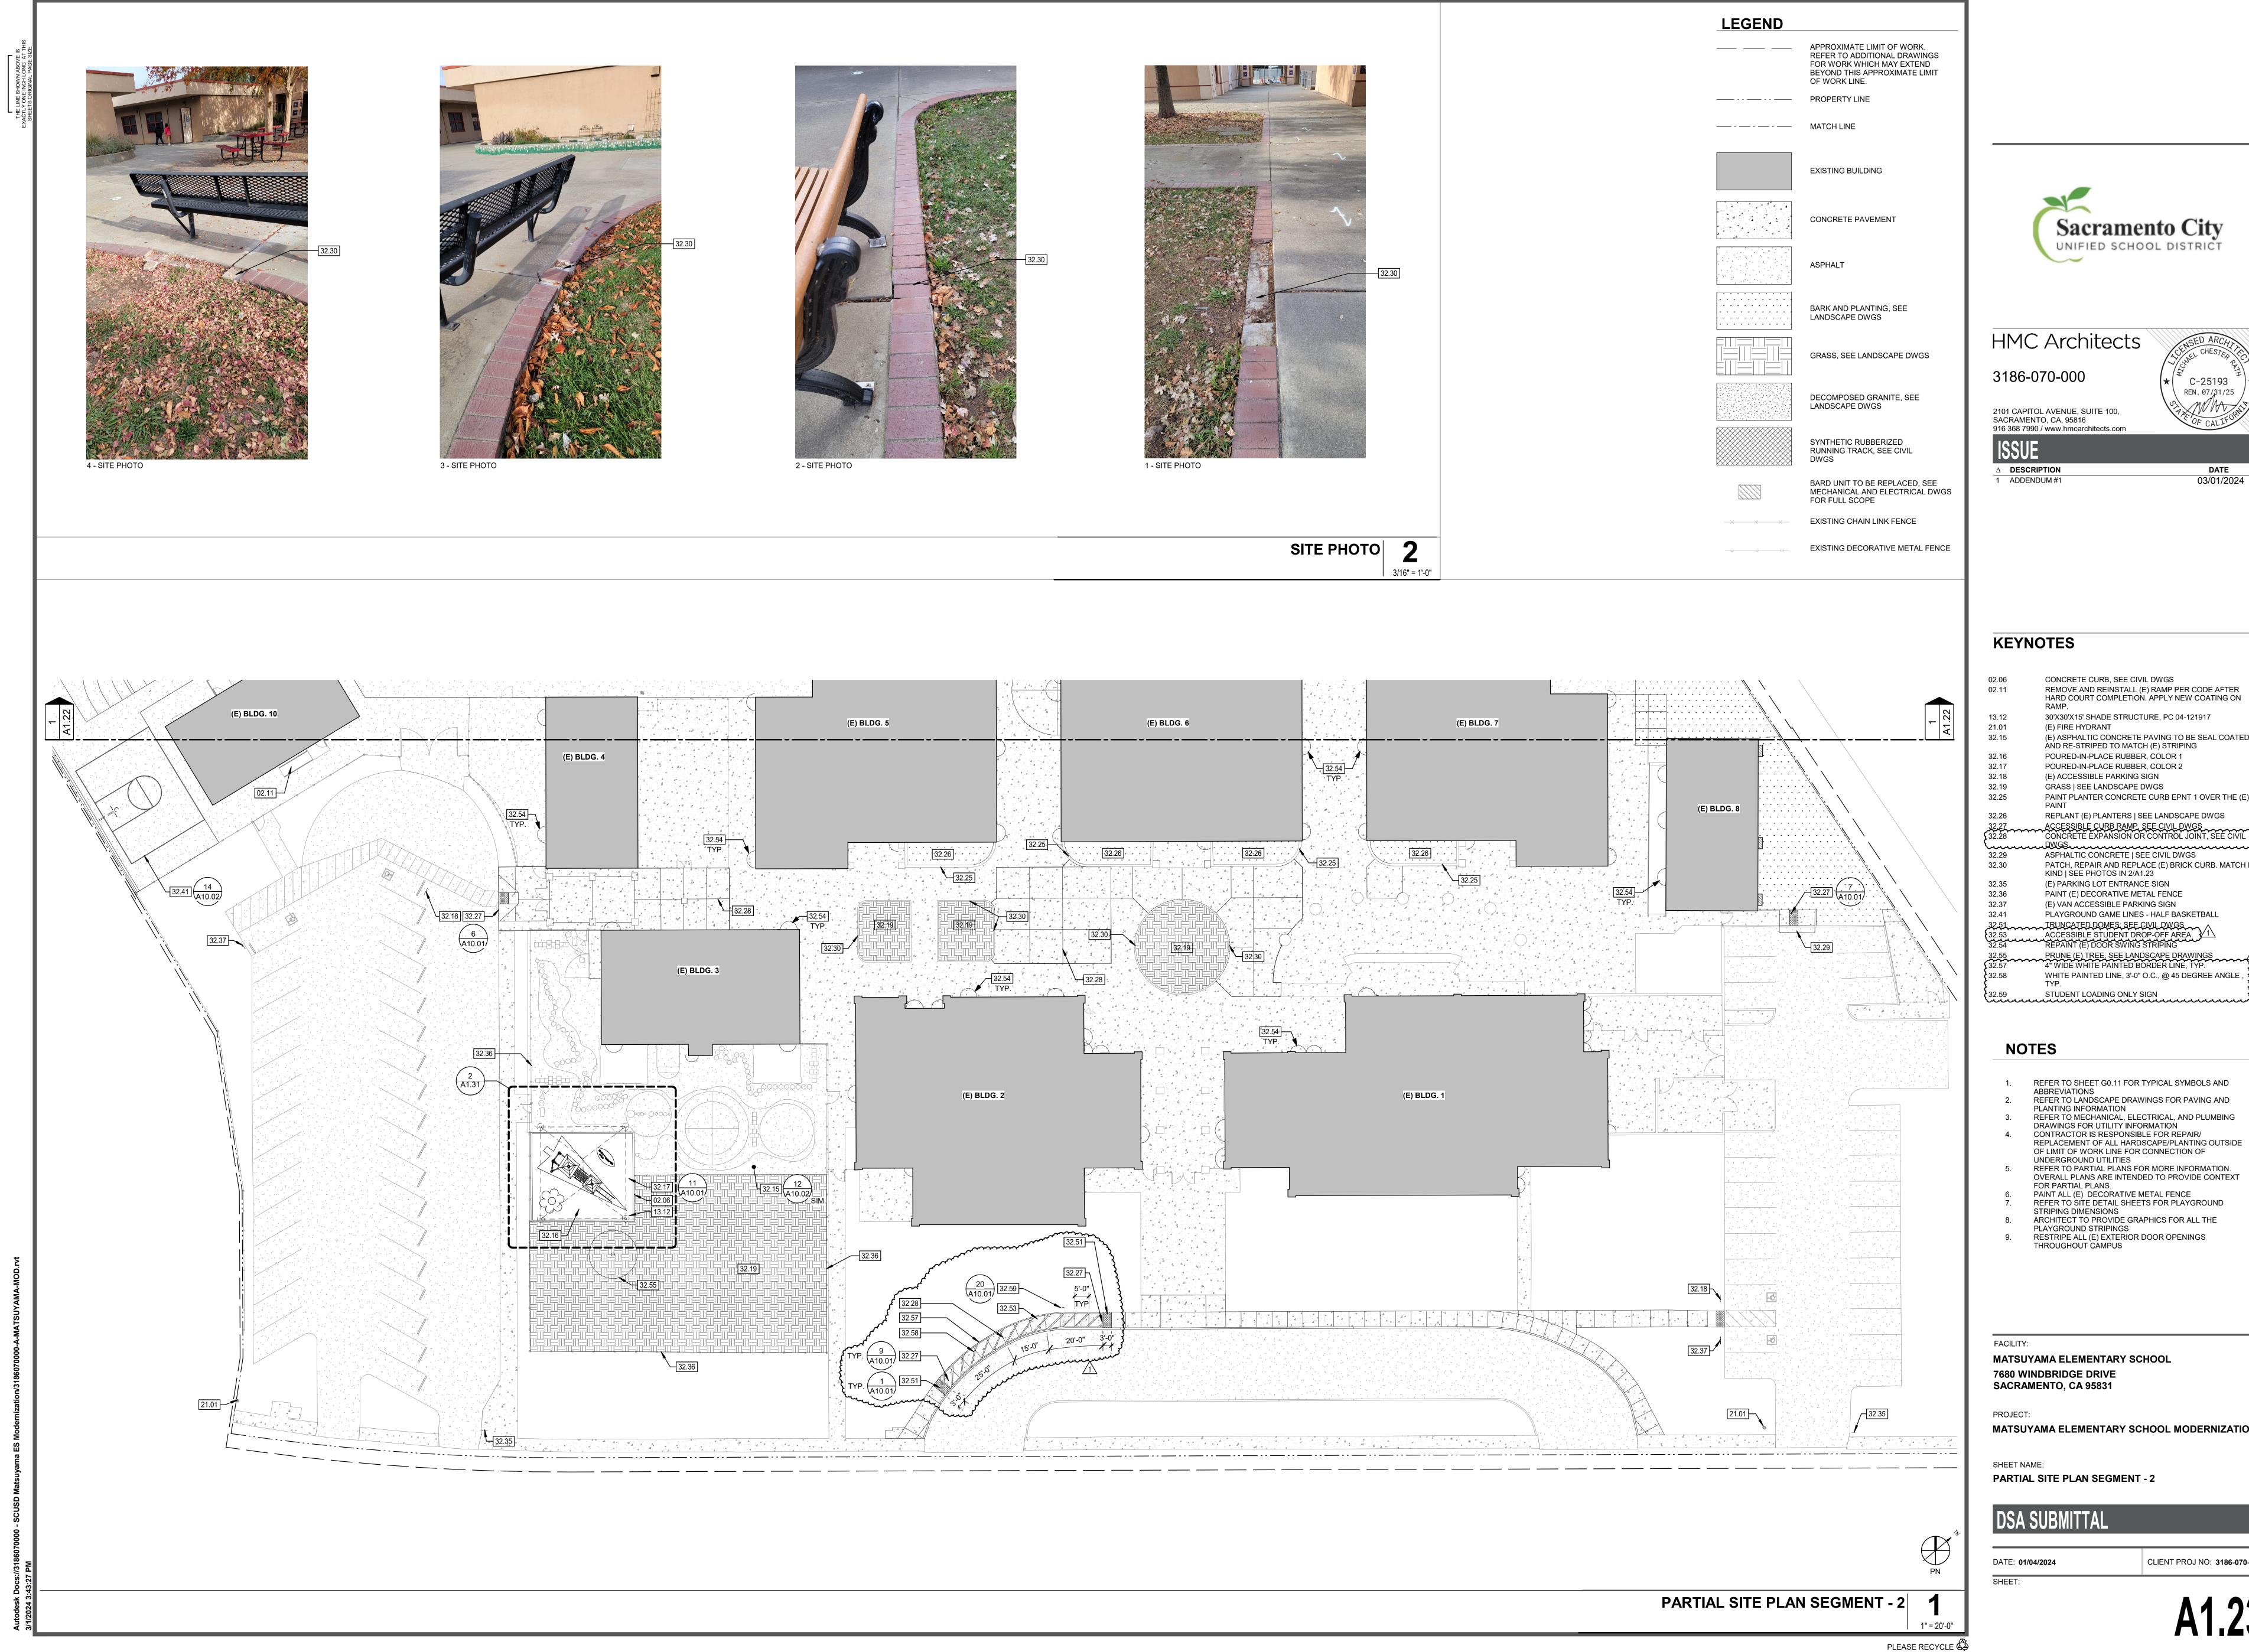





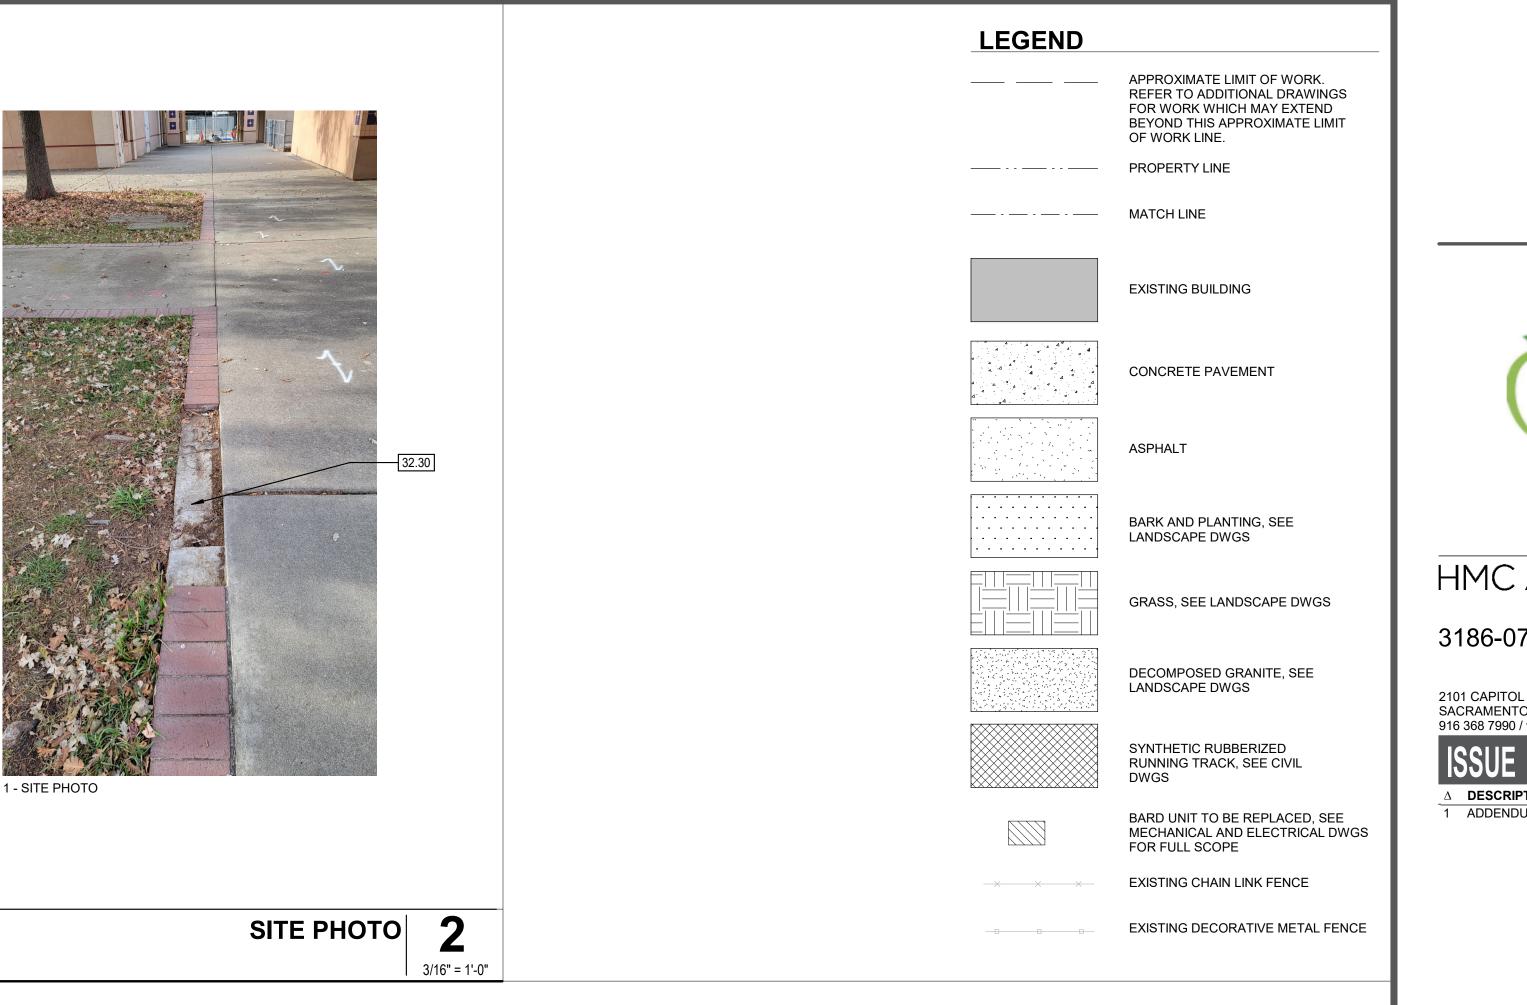



CLIENT PROJ NO: 3186-070-00

DSA SUBMITTAL

PARTIAL SITE PLAN SEGMENT - 2

MATSUYAMA ELEMENTARY SCHOOL MODERNIZATION

7680 WINDBRIDGE DRIVE SACRAMENTO, CA 95831

MATSUYAMA ELEMENTARY SCHOOL

REFER TO SHEET G0.11 FOR TYPICAL SYMBOLS AND ABBREVIATIONS REFER TO LANDSCAPE DRAWINGS FOR PAVING AND PLANTING INFORMATION REFER TO MECHANICAL, ELECTRICAL, AND PLUMBING DRAWINGS FOR UTILITY INFORMATION CONTRACTOR IS RESPONSIBLE FOR REPAIR/ REPLACEMENT OF ALL HARDSCAPE/PLANTING OUTSIDE OF LIMIT OF WORK LINE FOR CONNECTION OF UNDERGROUND UTILITIES REFER TO PARTIAL PLANS FOR MORE INFORMATION. OVERALL PLANS ARE INTENDED TO PROVIDE CONTEXT FOR PARTIAL PLANS. PAINT ALL (E) DECORATIVE METAL FENCE REFER TO SITE DETAIL SHEETS FOR PLAYGROUND STRIPING DIMENSIONS ARCHITECT TO PROVIDE GRAPHICS FOR ALL THE PLAYGROUND STRIPINGS RESTRIPE ALL (E) EXTERIOR DOOR OPENINGS THROUGHOUT CAMPUS

32.29 ASPHALTIC CONCRETE | SEE CIVIL DWGS PATCH, REPAIR AND REPLACE (E) BRICK CURB. MATCH IN KIND | SEE PHOTOS IN 2/A1.23 (E) PARKING LOT ENTRANCE SIGN PAINT (E) DECORATIVE METAL FENCE (E) VAN ACCESSIBLE PARKING SIGN PLAYGROUND GAME LINES - HALF BASKETBALL ACCESSIBLE STUDENT DROP-OFF AREA REPAINT (E) DOOR SWING STRIPING PRUNE (E) TREE, SEE LANDSCAPE DRAWINGS 4" WIDE WHITE PAINTED BORDER LINE, TYP. WHITE PAINTED LINE, 3'-0" O.C., @ 45 DEGREE ANGLE , STUDENT LOADING ONLY SIGN

30'X30'X15' SHADE STRUCTURE, PC 04-121917 (E) FIRE HYDRANT (E) ASPHALTIC CONCRETE PAVING TO BE SEAL COATED ÀND RE-STRIPED TO MATCH (E) STRIPING POURED-IN-PLACE RUBBER, COLOR 1 POURED-IN-PLACE RUBBER, COLOR 2 (E) ACCESSIBLE PARKING SIGN GRASS | SEE LANDSCAPE DWGS PAINT PLANTER CONCRETE CURB EPNT 1 OVER THE (E) PAINT REPLANT (E) PLANTERS | SEE LANDSCAPE DWGS




Sacramento City

UNIFIED SCHOOL DISTRICT







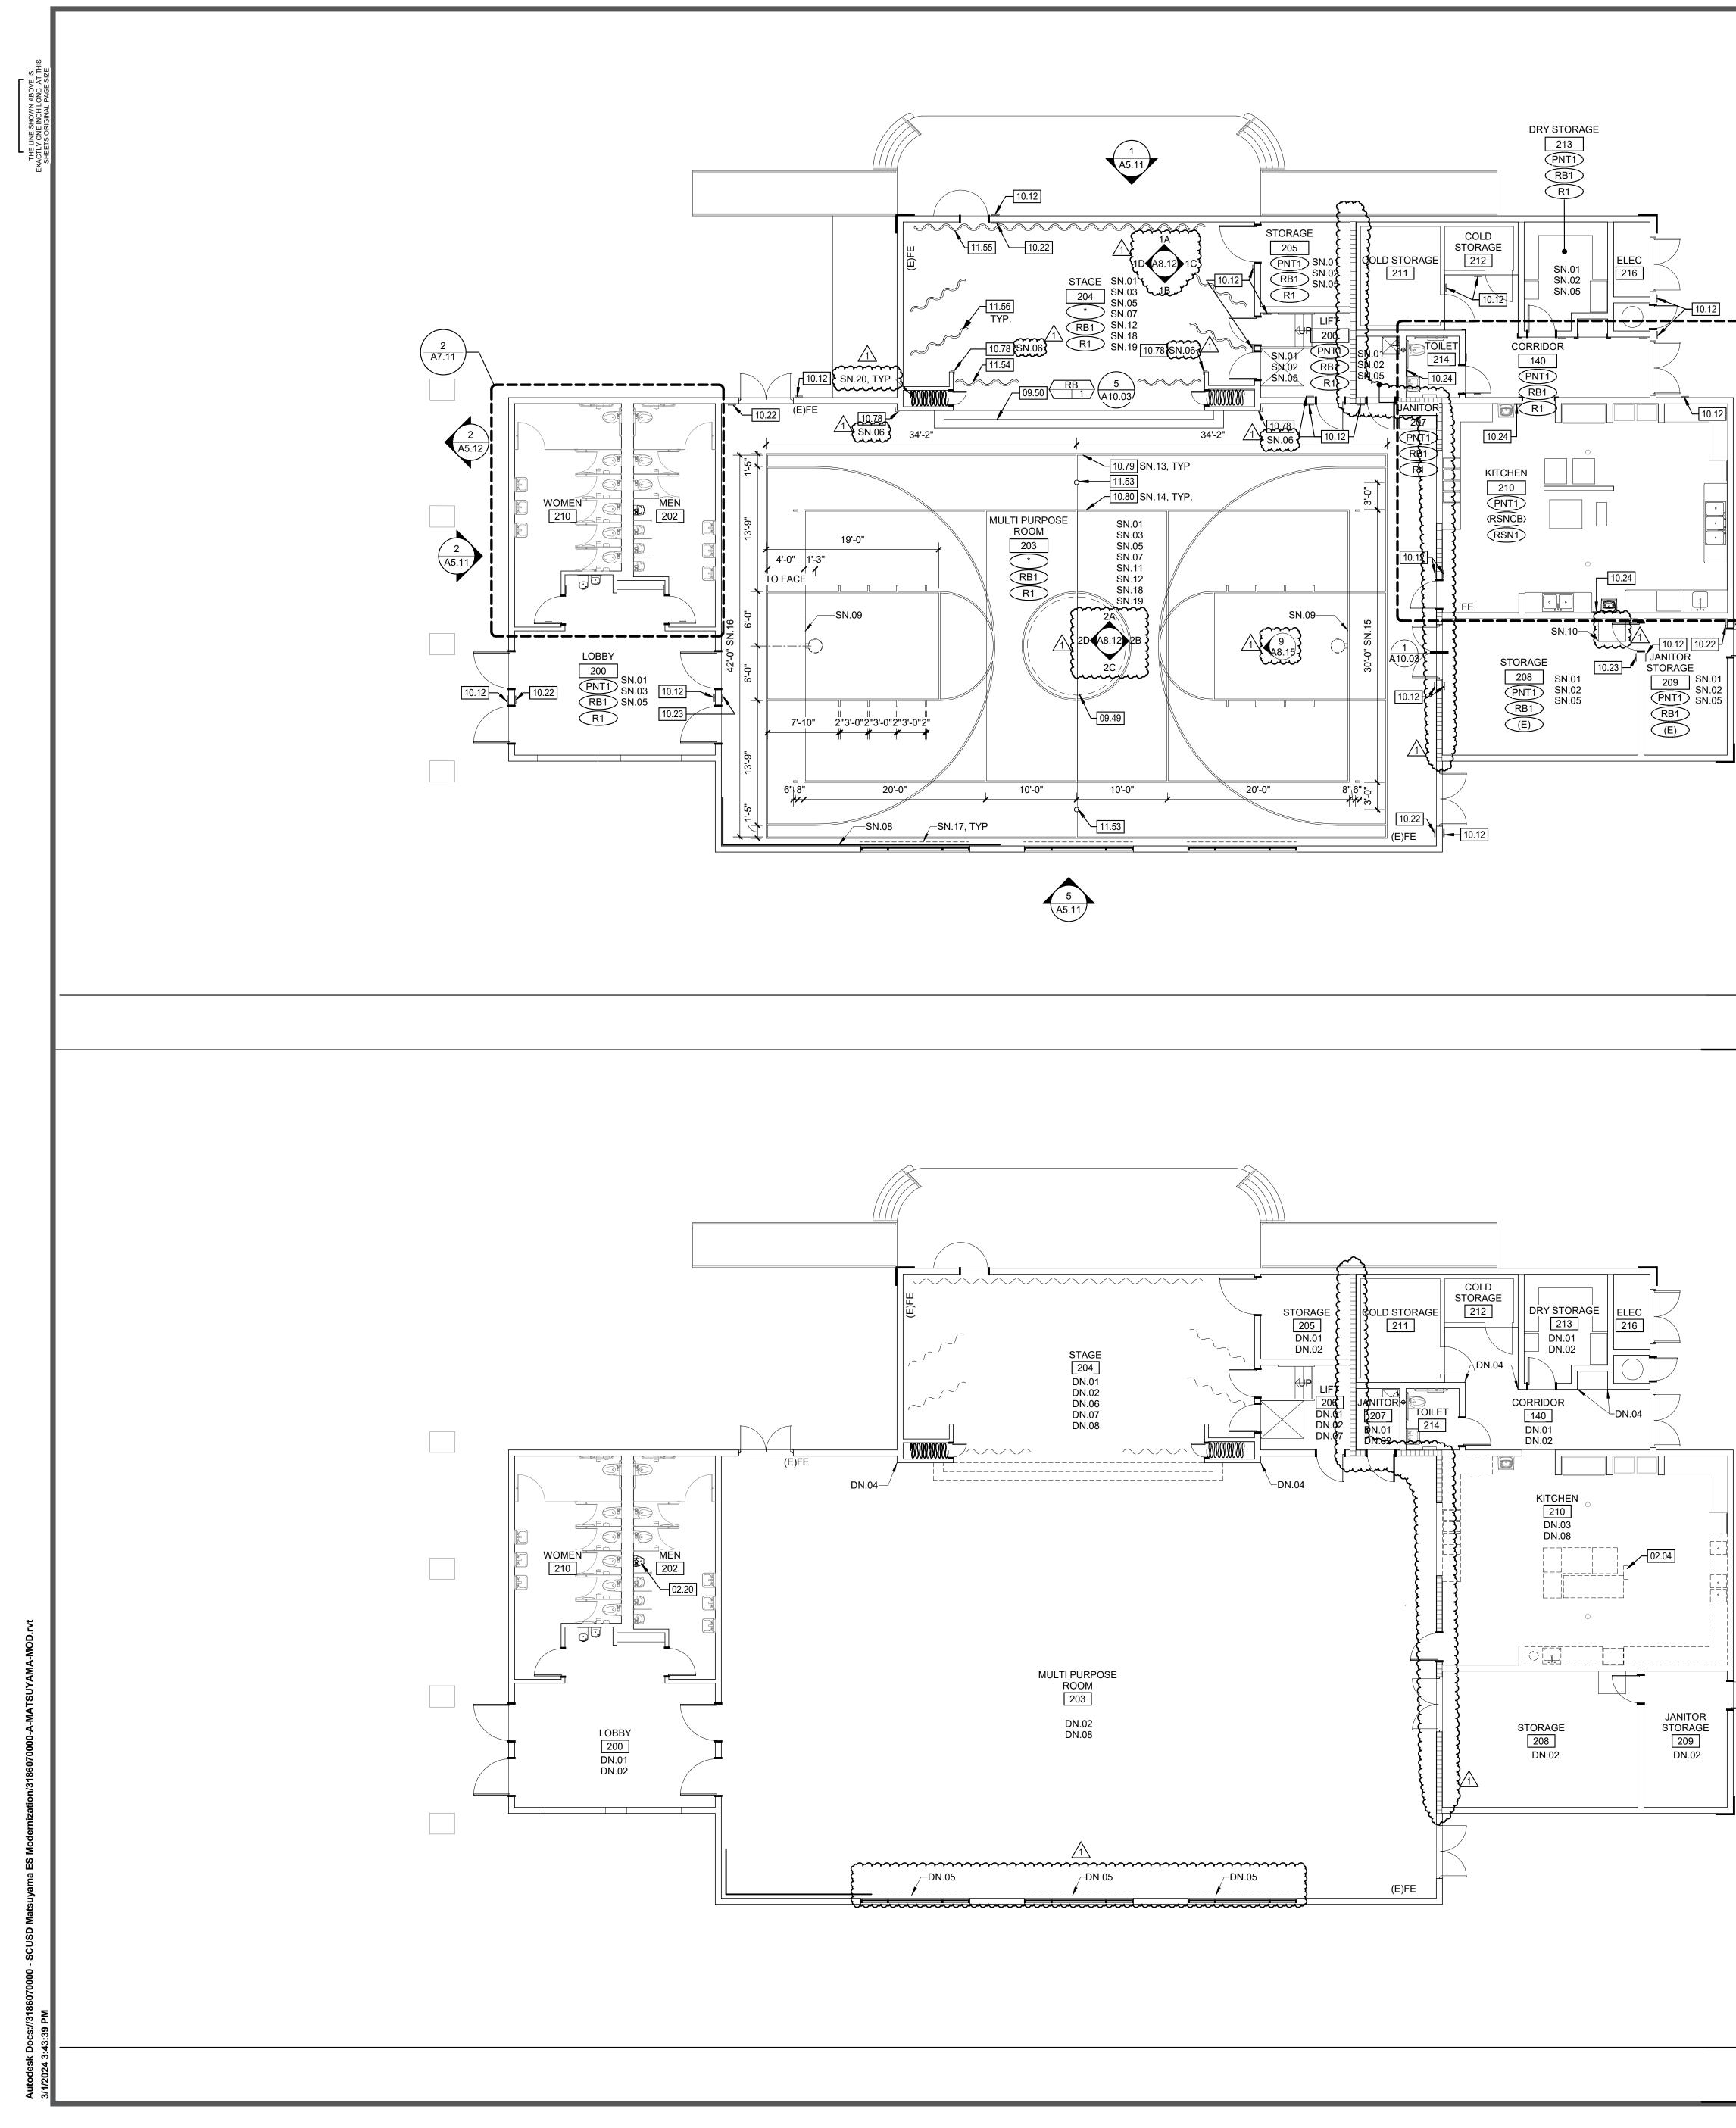

	EXISTING ELEMENT TO REMAIN EXISTING ELEMENT TO BE DEMOLISHED EXISTING ONE HOUR OCCUPANCY SEPARATION WALL ROOM NAME 101 ROOM NUMBER WF WF WF WF FF HOUR OCCUPANCY SEPARATION WALL 101 ROOM NUMBER WALL FINISH - SEE FINISH SCHEDULE FF FLOOR FINISH - SEE FINISH SCHEDULE	
	 BENERAL NOTES PATCH AND REPAIR ANY DAMAGED GYPSUM WALLBOARD PRIOR TO PAINTING, AS NEEDED PATCH AND REGLUE ANY LOOSE WALLCOVERING PRIOR TO PAINTING ALL (E) GLUE UP ACOUSTICAL PANELS TO BE PAINTED WITH NON-BRIDGING PAINT REMOVE ALL (E) ABANDONED WIRE MOLD PROTECT ALL (E) TAGS ON DOORS AND WALLS. DO NOT PAINT. PAINT ALL INTERIOR AND EXTERIOR (E) NON-WOOD DOORS AND WINDOW FRAMES (PNT2). (E) WOOD DOORS TO REMAIN AS IS. DEMO ALL (E) ROOM ID & RESTROOM SIGNAGE. NEW SIGNAGE TO BE PROVIDED ALL (E) CASEWORK TO REMAIN. PROTECT DURING CONSTRUCTION UNO ALL (E) SIGNAGE TO BE REPLACED IN THE SAME LOCATION, SEE PLAN FOR SIGN TYPE THE ROOM NAMES AND NUMBERS INDICATED ON THE FLOOR PLANS ARE SOLELY FOR REFERENCE IN CONSTRUCTION DOCUMENTS. THE CONTRACTOR TO PROVIDE COMPLETE CHART OF ACTUAL BUILDING ROOM USES SIGNATED N. THE ARCHTOR SIGNAGE TO HE PROVADE. WHERE SIGNS MOUNTED ON GLASS, IF POSSIBLE MOM SIGNAGE TO BE NEPROVAL. WHERE SIGNS MOUNTED ON GLASS, IF POSSIBLE MOM SIGNAGE NEESINATION TO THE DISTRICT FOR REVIEW AND APPROVAL. WHERE SIGNS MOUNTED ON GLASS, IF POSSIBLE MOM SIGNAGE DO SIGNA TON THE ARCHTOR SIGN TON THE ARCHTOR SIGNARE DATES AND MAKE EQUAL SIZE. WHERE NO SECOND SIGN IS PRESENT, PROVIDE A BLANK SIGN TO COVER ADHESIVE. 	Image: Constraint of the end of t
IMPROVEMENT FLOOR PLAN - BLDG 1		EXPENSION EXPENSION 02.04REMOVE (E) WALL CAP (ABOVE CEILING I SEE PLU ABOVE CEILING I SEE PLU ABOVE CEILING I SEE PLU OP.4909.49SCHOOL LOGO TO BE INN LOGO TO BE PROVIDED E09.50RUBBER STAIR TREADS10.12ROOM ID SIGN 9/A10.0410.23TACTILE "EXIT" SIGN 8/10.24HAND WASH SIGN10.79BASKETBALL STRIPING10.79BASKETBALL STRIPING11.53ATHLETIC EQUIPMENT IF11.54THEATRICAL DRAPERIES11.55THEATRICAL DRAPERIES11.56THEATRICAL DRAPERIES
		DEMOLITION NOTES DN.01 (E) VCT TO BE REMOVED IN ITS E DN.02 (E) RUBBER BASE TO BE REMOVE DN.03 (E) TILE FLOORING & BASE TO BE DN.04 (E) CORNER GUARD TO BE REMOVE DN.05 (E) MOTORIZED DRAPERY TO BE DN.06 (E) THEATRICAL DRAPERY TO BE DN.06 (E) THEATRICAL DRAPERY TO BE DN.07 (E) STAIR TREADS TO BE REMOVE DN.08 (E) CLOCKS AND WALL MOUNTED TO BE REMOVED AND STORED SN.01 (E) GYPSUM WALLBOARD AND WALL PAINTED SN.02 (E) GYPSUM WALLBOARD CEILING SN.03 (E) GLUE UP TILES ON WALLS AND PAINTED SN.05 INSTALL RUBBER BASE SN.06 INSTALL RUBBER BASE SN.06 INSTALL 8'-0" CORNER GUARDS SN.07 (E) WALL PANELING TO BE PAINTIS SN.08 PROTECT (E) ROCK CLIMBING WA MONO9 (E) BASKETBALL SUPPORTS TO BE SN.10 (E) IDF BOX ABOVE. PROTECT DU SN.11 (E) WOOD TRIM TO BE PAINTED SN.12 ALL (E) CEILING MOUNTED DEVIC AND REINSTALLED IN SAME LOCA NEW CEILING TILES SN.13 2" WIDE (U.N.0.) COURT MARKING SN.14 2" WIDE (U.N.0.) COURT MARKING SN.15 TO OUTSIDE OF STRIPE SN.16 TO INSIDE OF STRIPE SN.17 REPLACE (E) DRAPERY WITH NEW SN.18 (E) CLOCKS AND WALL MOUNTED TO BE REINSTALLED IN SAME LOCA NEW CEILING TILES SN.13 2" WIDE (U.N.0.) COURT MARKING SN.14 2" WIDE (U.N.0.) COURT MARKING SN.15 TO OUTSIDE OF STRIPE SN.16 TO INSIDE OF STRIPE SN.17 REPLACE (E) DRAPERY WITH NEW SN.18 (E) CLOCKS AND WALL MOUNTED TO BE REINSTALLED IN SAME LOCA NEW CEILING TILES SN.13 (E) CLOCKS AND WALL MOUNTED TO BE REINSTALLED IN SAME LOCA NEW CEILING TILES SN.13 (E) CLOCKS AND WALL MOUNTED TO BE REINSTALLED IN SAME LOCA NEW CEILING TILES SN.13 (E) CLOCKS AND WALL MOUNTED TO BE REINSTALLED IN SAME LOCA NEW CEILING TILES SN.13 (E) CLOCKS AND WALL MOUNTED TO BE REINSTALLED IN SAME LOCA SN.19 REFER TO INTERIOR ELEVATIONS INFORMATION SN.20 (E) THEATRICAL CURTAINS TO RE SN.20 (E)
DEMOLITION FLOOR PLAN - BLDG 1		



TES REMOVE (E) WALL. CAP (E) GAS LINE AND UTILITIES ABOVE CEILING | SEE PLUMBING DWGS REMOVE (E) URINAL SCHOOL LOGO TO BE INLAID IN RUBBER FLOORING LOGO TO BE PROVIDED BY ARCHITECT RUBBER STAIR TREADS ROOM ID SIGN | 9/A10.04 TACTILE "EXIT" SIGN | 8/A10.04 TACTILE "EXIT ROUTE" SIGN | 8/A10.04 HAND WASH SIGN CORNER GUARD - PLASTIC CG1 | 6/A10.03 BASKETBALL STRIPING VOLLEYBALL STRIPING ATHLETIC EQUIPMENT : FLOOR SLEEVE THEATRICAL DRAPERIES : TRAVELER CURTAIN THEATRICAL DRAPERIES : REAR CURTAIN THEATRICAL DRAPERIES : LEG CURTAINS

TION NOTES

TO BE REMOVED IN ITS ENTIRETY BBER BASE TO BE REMOVED IN ITS ENTIRETY FLOORING & BASE TO BE REMOVED IN THEIR ENTIRETY RNER GUARD TO BE REMOVED. PATCH AND REPAIR ORIZED DRAPERY TO BE REMOVED IN ITS ENTIRETY ATRICAL DRAPERY TO BE REMOVED IN THEIR ENTIRETY IR TREADS TO BE REMOVED IN THEIR ENTIRETY CKS AND WALL MOUNTED HAND SANITIZER DISPENSER

NOTES

SUM WALLBOARD AND WALLCOVERING TO BE PSUM WALLBOARD CEILING TO BE PAINTED (PNT1) JE UP TILES ON WALLS AND CEILINGS TO BE PAINTED

L RUBBER BASE L 8'-0" CORNER GUARDS L PANELING TO BE PAINTED CT (E) ROCK CLIMBING WALL DURING CONSTRUCTION SKETBALL SUPPORTS TO BE DEEP CLEANED BOX ABOVE. PROTECT DURING CONSTRUCTION. CEILING MOUNTED DEVICES TO BE REMOVED, STORED, INSTALLED IN SAME LOCATION AFTER INSTALLATION OF EILING TILES (U.N.O.) COURT MARKING: COLOR 1 E (U.N.O.) COURT MARKING: COLOR 2 TSIDE OF STRIPE DE OF STRIPE CE (E) DRAPERY WITH NEW ROLLER WINDOW SHADES


CKS AND WALL MOUNTED HAND SANITIZER DISPENSERS REINSTALLED IN SAME LOCATION TO INTERIOR ELEVATIONS FOR ADDITIONAL MATION EATRICAL CURTAINS TO REMAIN


MA ELEMENTARY SCHOOL BRIDGE DRIVE NTO, CA 95831

MA ELEMENTARY SCHOOL MODERNIZATION

ON AND IMPROVEMENT FLOOR PLANS -

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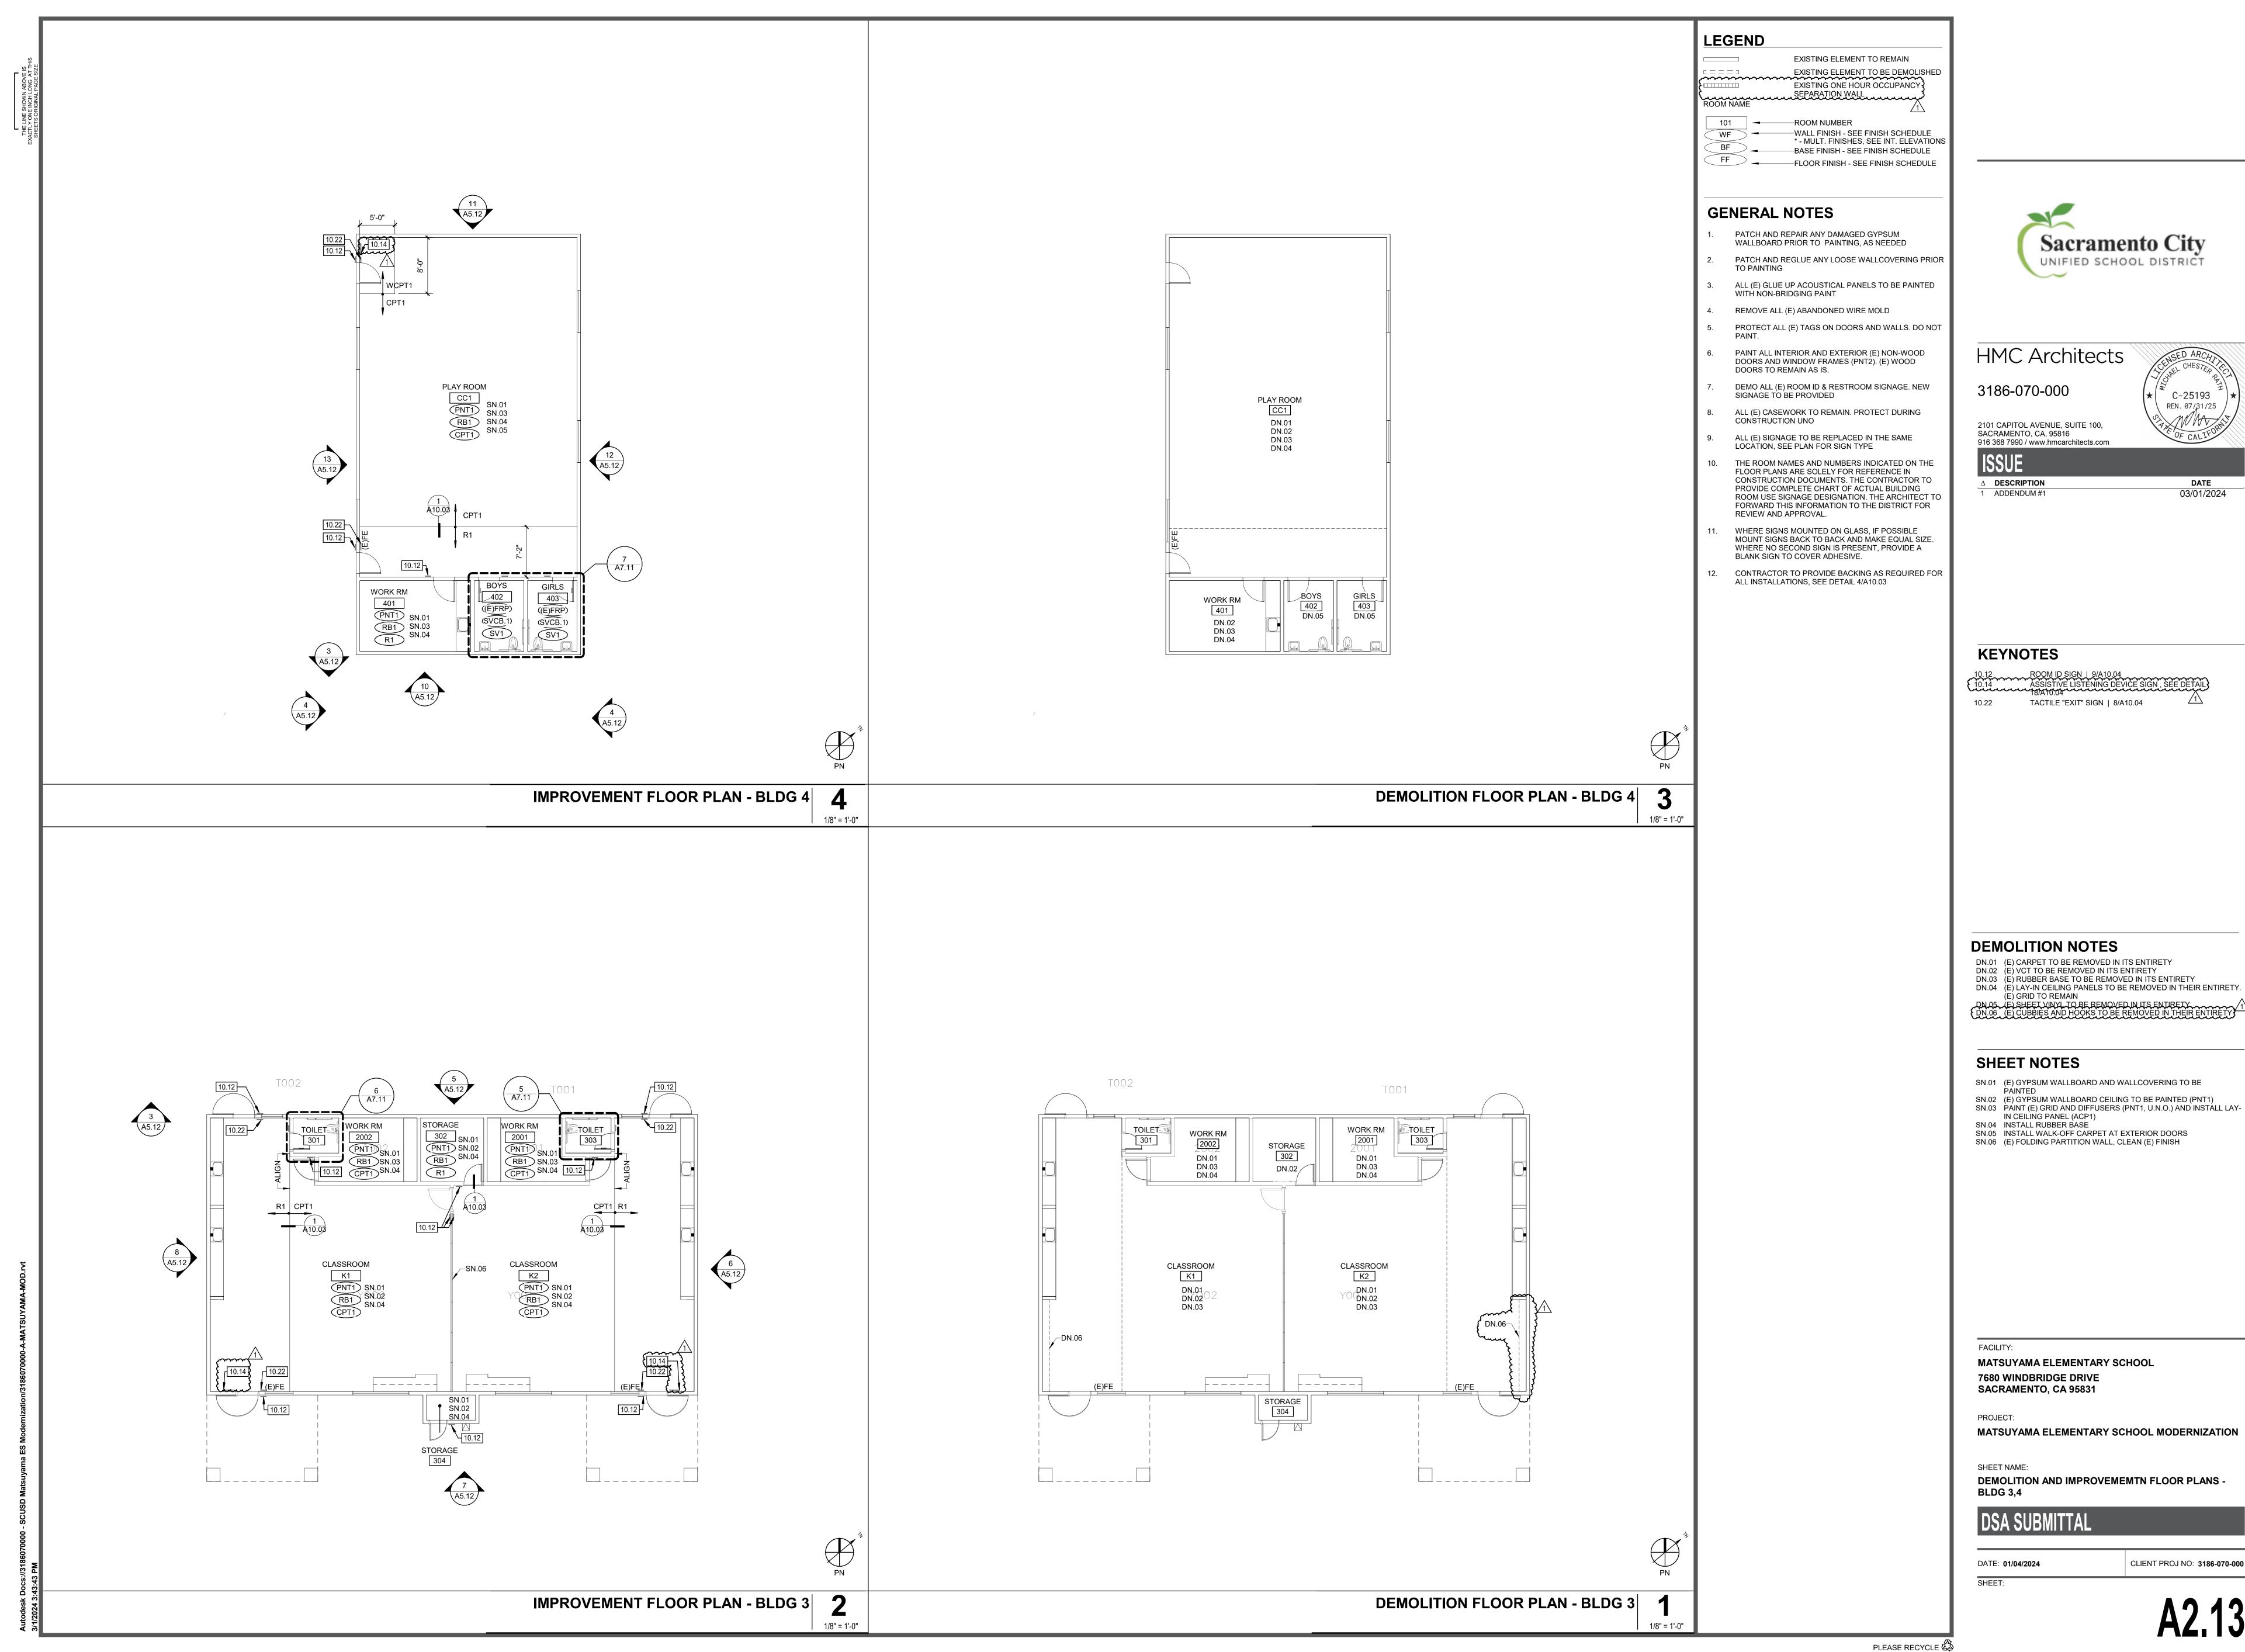


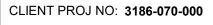

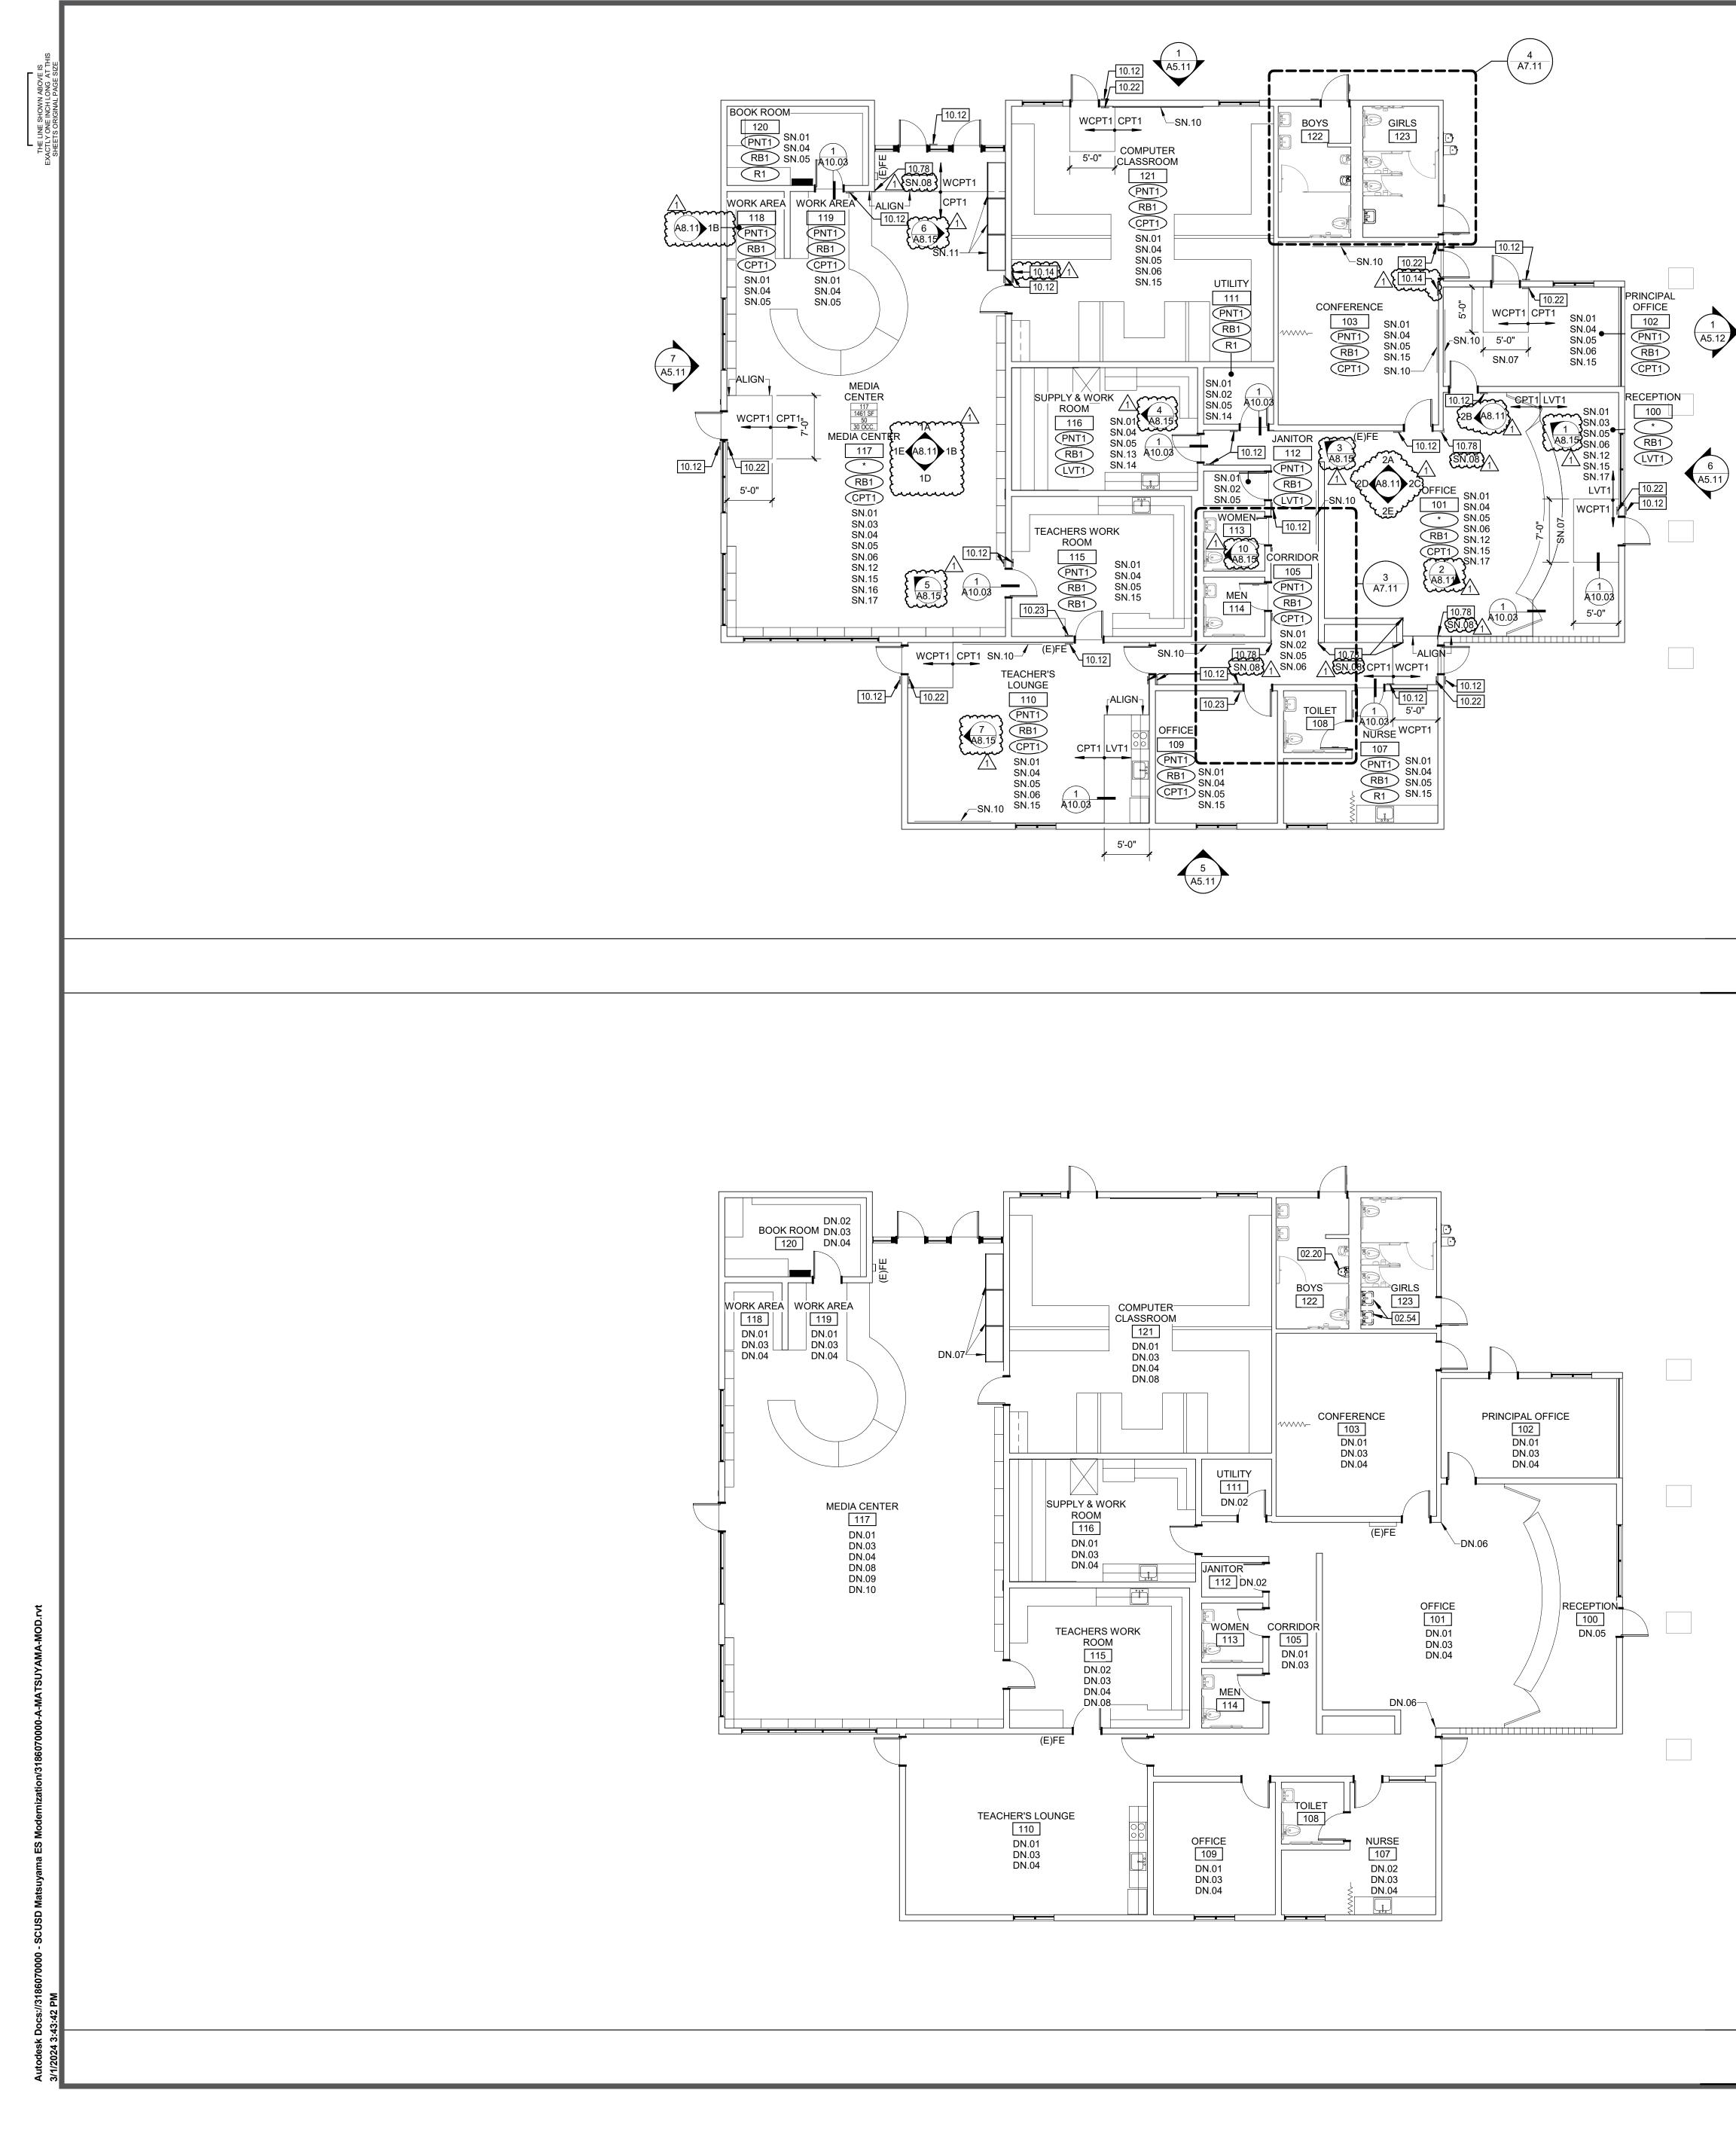	LEGEND EXISTING ELEMENT TO REMAIN EXISTING ELEMENT TO BE DEMOLISHED EXISTING ONE HOUR OCCUPANCY EXISTING EXIS	
	 FLOOR FINISH - SEE FINISH SCHEDULE FLOOR FINISH - SEE FINISH SCHEDULE GENERAL NOTES PATCH AND REPAIR ANY DAMAGED GYPSUM WALLBOARD PRIOR TO PAINTING, AS NEEDED PATCH AND REGLUE ANY LOOSE WALLCOVERING PRIOR TO PAINTING ALL (E) GLUE UP ACOUSTICAL PANELS TO BE PAINTED WITH NON-BRIDGING PAINT REMOVE ALL (E) ABANDONED WIRE MOLD PROTECT ALL (E) TAGS ON DOORS AND WALLS. DO NOT PAINT. PROTECT ALL (E) TAGS ON DOORS AND WALLS. DO NOT PAINT. PAINT ALL INTERIOR AND EXTERIOR (E) NON-WOOD DOORS AND WINDOW FRAMES (PNT2). (E) WOOD DOORS TO REMAIN AS IS. DEMO ALL (E) ROOM ID & RESTROOM SIGNAGE. NEW SIGNAGE TO BE PROVIDED ALL (E) CASEWORK TO REMAIN. PROTECT DURING CONSTRUCTION UNO ALL (E) SIGNAGE TO BE REPLACED IN THE SAME LOCATION, SEE PLAN FOR SIGN TYPE THE ROOM NAMES AND NUMBERS INDICATED ON THE FLOOR PLANS ARE SOLELY FOR REFERENCE IN CONSTRUCTION DOCUMENTS. THE CONTRACTOR TO PROVIDE COMPLETE CHART OF ACTUAL BUILDING ROOM USE SIGNAGE DESIGNATION. THE ARCHITECT TO FORWARD THIS INFORMATION TO THE DISTRICT FOR REVIEW AND APPROVAL. WHERE SIGNS MOUNTED ON GLASS, IF POSSIBLE MOUNT SIGNS BACK TO BACK AND MAKE EQUAL SIZE. WHERE NO SECOND SIGN IS PRESENT, PROVIDE A BLANK SIGN TO COVER ADHESIVE. CONTRACTOR TO PROVIDE BACKING AS REQUIRED FOR ALL INSTALLATIONS, SEE DETAIL 4/A10.03 	<image/> <section-header><section-header></section-header></section-header>
$\mathbf{MPROVEMENT FLOOR PLAN - BLDG 2} 2_{1/3" = 1' \cdot 0"}$		KEYNOTES 1 02.20 REMOVE (E) URINAL 02.20 REMOVE (E) MISC ACCESSORIES, EQUIPMENT & FURNITURE. RETURN TO OWNER FOR SALVAGE/REUSE PER CONTRACTOR/OWNER AGREEMENT 10.12 ROOM ID SIGN 9/A10.04 10.14 ASSISTIVE LISTENING DEVICE SIGN, SEE DETAIL 10.22 TACTILE "EXIT SIGN 8/A10.04 10.23 TACTILE "EXIT ROUTE" SIGN 8/A10.04 10.23 CORNER GUARD - PLASTIC CG1 6/A10.03
		 DEMOLITION NOTES DN.01 (E) CARPET TO BE REMOVED IN ITS ENTIRETY DN.02 (E) VCT TO BE REMOVED IN ITS ENTIRETY DN.03 (E) RUBBER BASE TO BE REMOVED IN ITS ENTIRETY DN.04 (E) LAY-IN CEILING PANELS TO BE REMOVED IN THEIR ENTIRETY. (E) GRID TO REMAIN DN.05 (E) TILE FLOORING TO BE REMOVED IN ITS ENTIRETY DN.06 (E) CORNER GUARDS TO BE REMOVED. PATCH AND REPAIR WALL DN.07 (E) DISPLAY CASES TO BE REMOVED, STORED & REINSTALLED IN THE SAME LOCATION DN.08 (E) CLOCKS AND WALL MOUNTED HAND SANITIZER DISPENSERS TO BE REMOVED IN ITS ENTIRETY DN.09 (E) DRAPERY TO BE REMOVED IN ITS ENTIRETY DN.09 (E) DRAPERY TO BE REMOVED IN ITS ENTIRETY DN.09 (E) DRAPERY TO BE REMOVED IN ITS ENTIRETY DN.10 (E) PROJECTION SCREEN TO BE REMOVED AND STORED
		 SHEET NOTES SN.91 (E) GYPSUM WALLBOARD AND WALLCOVERING TO BE PAINTED SN.92 (E) GYPSUM WALLBOARD CEILING TO BE PAINTED (PNT1) SN.92 (E) GYPSUM WALLBOARD CEILING TO BE PAINTED (PNT1) SN.93 (E) GLUE UP TILES ON WALLS AND CEILINGS TO BE PAINTED (PNT1 U.N.O.) SN.94 PAINT (E) GRID AND DIFFUSERS (PNT1, U.N.O.) AND INSTALL LAY. IN CEILING PANEL (ACP1) SN.95 INSTALL RUBBER BASE SN.96 INSTALL WALK-OFF CARPET AT EXTERIOR DOORS SN.97 CENTER ON DOOR SN.98 MOT USED SN.10 (E) MARKERBOARDS AND TACKBOARDS TO REMAIN. PROTECT DURING CONSTRUCTION SN.11 (E) DISPLAY CASES TO BE REMOVED, STORED & REINSTALLED IN THE SAME LOCATION AND TO MEET ADA CLEARANCE TO RM 121 DOOR SN.12 (E) WOOD TRIM TO BE PAINTED SN.13 (E) DF BOX, PROTECT DURING CONSTRUCTION. SN.14 (E) ELECTRICAL PANELS. PROTECT DURING CONSTRUCTION SN.15 (E) CLOCKS AND WALL MOUNTED HAND SANITIZER DISPENSERS TO BE REINSTALLED IN SAME LOCATION SN.16 (E) PROJECTION SCREEN TO BE REINSTALLED IN SAME LOCATION SN.17 (E) PROJECTION SCREEN TO BE REINSTALLED IN SAME LOCATION SN.17 REFER TO INTERIOR ELEVATIONS FOR ADDITIONAL INFORMATION
		FACILITY: MATSUYAMA ELEMENTARY SCHOOL 7680 WINDBRIDGE DRIVE SACRAMENTO, CA 95831 PROJECT: MATSUYAMA ELEMENTARY SCHOOL MODERNIZATION
$\underbrace{\bigvee}_{PN}^{^{^{{}}}}$		SHEET NAME: DEMOLITION AND IMPROVEMENT FLOOR PLANS - BLDG 2 DSA SUBMITTAL DATE: 01/04/2024 CLIENT PROJ NO: 3186-070-000 SHEET:
DEMOLITION FLOOR PLAN - BLDG 2		A2.12



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CLIENT PROJ NO: 3186-070-000

DEMOLITION AND IMPROVEMEMTN FLOOR PLANS -

MATSUYAMA ELEMENTARY SCHOOL MODERNIZATION

7680 WINDBRIDGE DRIVE

MATSUYAMA ELEMENTARY SCHOOL

DN.01 (E) CARPET TO BE REMOVED IN ITS ENTIRETY DN.02 (E) VCT TO BE REMOVED IN ITS ENTIRETY DN.03 (E) RUBBER BASE TO BE REMOVED IN ITS ENTIRETYDN.04 (E) LAY-IN CEILING PANELS TO BE REMOVED IN THEIR ENTIRETY. (E) GRID TO REMAIN (E) SHEET VINYL TO BE REMOVED IN ITS ENTIRETY (DN.06 (E) CUBBIES AND HOOKS TO BE REMOVED IN THEIR ENTIRETY)

10.12 ROOM ID SIGN | 9/A10.04 10.14 ASSISTIVE LISTENING DEVICE SIGN, SEE DETAIL 18/ATIL 114 10/A10.04 1TACTILE "EXIT" SIGN | 8/A10.04

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03/01/2024