

# **Business Services Contracts Office**

5735 47th Avenue ● Sacramento, CA 95824 (916) 643-2464

Rose Ramos, Chief Business Officer Robert Aldama, Purchasing Manager II

#### **ADDENDUM NO. 3**

Date: August 21, 2023

Issued by: Sacramento City Unified School District

Project: Project #: <u>0510-465</u>

0510-465 CKM/Fern Bacon/Matsuyama/Parkway/Rosa Parks and Sutterville

**Security Improvements: Group 2** 

This addenda shall supersede the original Information, attachments, and specifications regarding **Project No. 0510-465** where it adds to, deletes from, clarifies or otherwise modifies them. All other conditions and any previous addenda shall remain unchanged.

#### Part A - Bidder Questions

**QUESTION #1:** The technology plans scope of work and sheet notes do not identify the hardscape cut and patch that will be required for the new pathways. It doesn't look like this scope was identified in the civil drawings either. Would it be possible to get the cut and patch work incorporated into the civil drawings?

**RESPONSE:** Demolition/trenching/repair for other utilities like LV and data is covered in the trenching and backfilling specifications.

**QUESTION #2:** It appears that the power for the gate operators at McClatchy was not included in the drawings.

**RESPONSE:** See attached **AD3.01 – C.K. McClatchy – Addendum No.1 Drawings** for revisions.

**QUESTION #3:** The civil demolition drawing is missing for McClatchy. Will a civil demolition drawing be provided for this site?

**RESPONSE:** Civil Demolition plan is on sheet C1.1, view B. It was only demolition for a single gate so a separate plan was not provided, it was joined with the construction plan.

# CKM/Fern Bacon/Matsuyama/Parkway/Rosa Parks and Sutterville Security Improvements: Group 2 ADDENDUM NO. 3

**QUESTION #4:** Construction note #8 states to provide new sod where lawn areas are disturbed. The plans only show 2ft of disturbed area outside of the new fence line, but the disturbed area will be more like 10ft due to the equipment that will be used to install the fence. On the site walk a number of the fields were currently dead. Would it be possible to seed drill/ hydroseed the area disturbed during construction or will new SOD be required?

**RESPONSE:** Seed drill/hydroseeding will be accepted. As far as the width, anything damaged outside of the limits of work need to be repaired by the contractor, so it should be covered regardless of the working space they end up using.

**QUESTION #5:** Will a construction trailer be required for this project or will we be able to utilize classrooms at the site(s)?

**RESPONSE:** A trailer is not required. Classrooms will not be available to utilize.

**QUESTION #6:** Per the "notice to bidders" The District will only receive bids submitted electronically through eBuilder. Per the "instructions to bidders": District will receive sealed bids from bidders as stipulated in the Notice to Bidders. Bids may also be submitted electronically in E-Builder.

- a. All bids must be sealed in an envelope, marked with the name and address of the Bidder, name of the Project, the Project Number and/or bid number, and time of bid opening.
- b. Bids must be submitted to the District Office at 5737 47th Avenue, Sacramento, CA by date and time shown in the Notice to Bidders.

Please confirm that bids only need to be submitted through e-Builder.

**RESPONSE:** Confirmed, bids only need to be submitted to eBuilder.

**QUESTION #7:** If submitted through e-Builder, does the original bid bond need to be sent directly to the district as well as uploaded to e-builder? If so, please provide contact information

**RESPONSE:** A copy of the bond needs to be provided and original mailed.

**QUESTION #8:** What is to be entered on the response form "step 3 additional info" in the qualifications text box?

# CKM/Fern Bacon/Matsuyama/Parkway/Rosa Parks and Sutterville Security Improvements: Group 2 ADDENDUM NO. 3

**RESPONSE:** Field can be left blank. Not applicable for this project.

**QUESTION #9:** Please confirm that OCIP Insurance Forms are not required as part of the bid form as stated in Item 7.

- 7. The following documents are attached hereto:
  - Bid Bond on the District's form or other security
  - Designated Subcontractors list
  - Site Visit Verification
  - Non-Collusion Declaration
  - Iran Contracting Act Certification
  - OCIP Insurance Forms

**RESPONSE:** OCIP Insurance Forms are not required.

#### Part B - Drawings & Specifications

#### **CK McClatchy HS**

#### Sheet C0.0

- Sheet index updated for new sheet C1.0.2 added.
- Total sheet count updated.

#### **Sheet C1.0.1**

- Site access plan updated with additional references.
- Gate legend added.
- General access notes added.
- Typical gate clearance details added.

#### Sheet C1.0.2

- New Site fire access plan provided.

#### Sheet C1.1

- Surface repair general note added.
- Note 17 and 18 added and plan adjusted to show conduit and connections for gate opener power supply.

#### Fern Bacon ES

#### Sheet C0.0

- Project description updated.

#### Sheet C1.0.1

- Site access plan updated with additional references.
- Gate legend added.
- General access notes added.
- Typical gate clearance details added.

#### Sheet C1.0.2

# CKM/Fern Bacon/Matsuyama/Parkway/Rosa Parks and Sutterville Security Improvements: Group 2 ADDENDUM NO. 3

- Site fire plan updated with additional references.
- Multi-purpose egress analysis provided.

#### Sheet C2.1

- Surface repair general note added.

#### Sheet C4.1

- Details 5 and 6 updated within additional code required information.

#### Matsuyama ES

#### Sheet C0.0

- Project description updated.

#### Sheet C1.0.1

- Site access plan updated with additional references.
- Gate legend added.
- General access notes added.
- Typical gate clearance details added.

#### Sheet C1.0.2

- Site fire plan updated with additional references.
- Multi-purpose egress analysis provided.

#### Sheet C2.1

- Surface repair general note added.

#### Sheet C4.1

- Details 5 and 6 updated within additional code require information.

#### Sheet C4.3

- Details 2, 3, 4 and 5 removed as they are no longer referenced.

#### Parkway ES

#### Sheet C0.0

Project description updated.

#### Sheet C1.0.1

- Site access plan updated with additional references.
- Gate legend added.
- General access notes added.
- Typical gate clearance details added.

#### Sheet C1.0.2

- Site fire plan updated with additional references.
  - Multi-purpose egress analysis provided.

#### Sheet C2.1

Surface repair general note added.

#### Sheet C4.1

Details 5 and 6 updated within additional code require information.

#### **Rosa Parks ES**

#### Sheet C0.0

Project description updated.

#### Sheet C1.0.1

- Site access plan updated with additional references.
- Gate legend added.
- General access notes added.

# CKM/Fern Bacon/Matsuyama/Parkway/Rosa Parks and Sutterville Security Improvements: Group 2 ADDENDUM NO. 3

- Typical gate clearance details added.

#### Sheet C1.0.2

- Site fire plan updated with additional references.
- Multi-purpose egress analysis provided.

#### Sheet C2.1

- Surface repair general note added.

#### **Sutterville ES**

#### Sheet C0.0

- Project description updated.

#### Sheet C1.0.1

- Site access plan updated with additional references.
- Gate legend added.
- General access notes added.
- Typical gate clearance details added.

#### Sheet C1.0.2

- Site fire plan updated with additional references.
- Multi-purpose egress analysis provided.

#### Sheet C1.1

- Additional demolition shown at main entrance gate in view 1.

#### Sheet C2.1

- Additional flatwork paving shown at main entrance gate in view 1.
- Surface repair general note added.

#### Sheet C2.2

- Code reference added at flush transition near gate.

#### Sheet C4.1

- Details 5 and 6 updated within additional code required information.

#### Sheet C4.3

- Details 5 updated to include single swing gate layout.

#### Sheet T000

- Sheet updated to include additional equipment changes and new sheet added.

#### Sheet T200

- Sheet updated to include additional equipment changes and pathway routing.

#### Sheet T201

- New sheet added for gate controls to be provided at an additional gate.

#### Sheet T900

- Single line diagram updated with new connections per Sheet T200 and T201.

#### **List of Attachments**

**AD3.01** – C.K. McClatchy – Addendum No.1 Drawings (4 Pages)

**AD3.02** – Fern Bacon – Addendum No.1 Drawings (5 Pages)

**AD3.03** – Matsuyama – Addendum No.1 Drawings (7 Pages)

**AD3.04** – Parkway – Addendum No.1 Drawings (5 Pages)

**AD3.05** – Rosa Parks – Addendum No.1 Drawings (5 Pages)

**AD3.06** – Sutterville – Addendum No.1 Drawings (12 Pages)

# Project No: 0510-465 CKM/Fern Bacon/Matsuyama/Parkway/Rosa Parks and Sutterville Security Improvements: Group 2 ADDENDUM NO. 3

#### **END OF ADDENDUM NO. 3**

Acknowledgement of this Addendum will be required at time of bid.

# C.K. McCLATCHY HIGH SCHOOL 2023 FENCING



CO.O COVER SHEET

**ELECTRICAL** 

C1.0.1 SITE ACCESS PLAN
C1.0.2 FIRE ACCESS PLAN


TOPOGRAPHIC SURVEY


TOOO TECHNOLOGY COVER SHEET

T200 TECHNOLOGY FLOOR PLAN

T800 TECHNOLOGY DETAILS



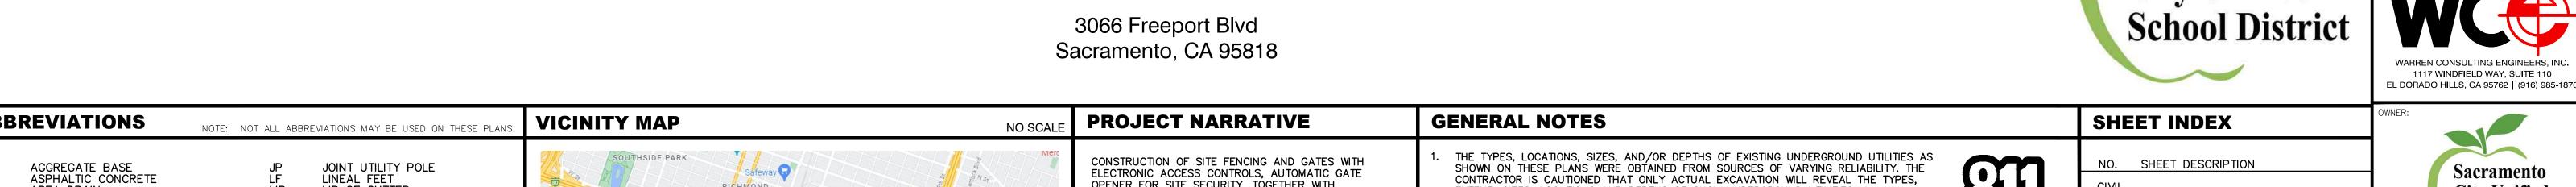

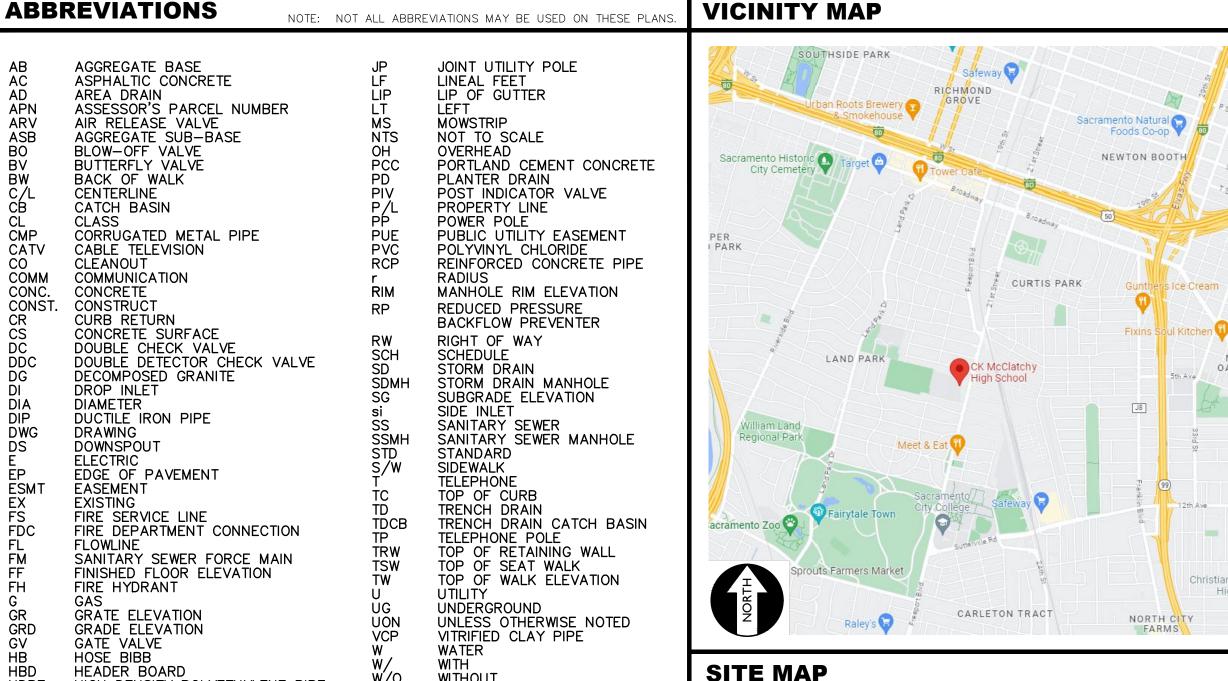

OPENER FOR SITE SECURITY, TOGETHER WITH ASSOCIATED FLATWORK AND PAVING REPAIRS FOR ACCESSIBILITY COMPLIANCE.

THERE ARE NO BUILDINGS OR STRUCTURES TO BE

APPLICABLE REGULATIONS

ALL WORK SHALL CONFORM TO TITLE 24,

CALIFORNIA CODE OF REGULATIONS (CCR)

OR A CONSTRUCTION CHANGE DOCUMENT

4-338, PART 1, TITLE 24 CCR.

4-317, PART 1, TITLE 24, CCR)

LOCAL ORDINANCES.

CODE, SECTION 10-103.

SPECIAL TESTING:

CHANGES TO THE APPROVED DRAWINGS AND

SPECIFICATION SHALL BE MADE BY AN ADDENDA

APPROVED BY DSA AS REQUIRED BY SECTION

SHOULD ANY EXISTING CONDITIONS SUCH AS

DETERIORATION OR NON-COMPLYING CONSTRUCTION

BE DISCOVERED WHICH IS NOT COVERED BY THE

WORK WILL NOT COMPLY WITH TITLE 24, CCR, A

CONSTRUCTION CHANGE DOCUMENT (CCD), OR A SEPARATE SET OF PLANS AND SPECIFICATIONS.

DETAILING AND SPECIFYING THE REQUIRED WORK

BEFORE PROCEEDING WITH THE WORK. (SECTION

A DSA CERTIFIED PROJECT INSPECTOR EMPLOYED

BY THE DISTRICT (OWNER) AND APPROVED BY DSA

SHALL PROVIDE CONTINUOUS INSPECTION OF THE

WORK. THE DUTIES OF THE INSPECTOR ARE

DEFINED IN SECTION 4-342, PART 1, TITLE 24,

THIS PROJECT REQUIRES INSPECTOR CLASS 3

GRADING PLANS, DRAINAGE IMPROVEMENTS, ROAD

AND ACCESS REQUIREMENTS AND ENVIRONMENTAL

HEALTH CONSIDERATIONS SHALL COMPLY WITH ALL

CONTRACTOR SHALL PROVIDE AND COORDINATE

TESTING OF NEW LIGHTING CONTROLES MECHANICAL

SYSTES, ENVELOPES AND PROCESS EQUIPMENT AND

SYSTEMS IN ACCORDANCE WITH CALIFORNIA ENERGY

SHALL BE SUBMITTED TO AND APPROVED BY DSA

CONTRACT DOCUMENTS WHEREIN THE FINISHED

BY THIS SET OF PLANS.

CONSTRUCTED, MODERNIZED OR OTHERWISE ALTERNATED

EXTENT, SIZES, LOCATIONS AND DEPTHS OF SUCH UNDERGROUND UTILITIES. A REASONABLE EFFORT HAS BEEN MADE TO LOCATE AND DELINEATE ALL KNOWN UNDERGROUND UTILITIES. HOWEVER, WARREN CONSULTING ENGINEERS CAN ASSUME NO RESPONSIBILITY FOR THE COMPLETENESS OR ACCURACY OF ITS DELINEATION OF SUCH UNDERGROUND UTILITIES, NOR FOR THE EXISTENCE OF OTHER BURIED OBJECTS OR UTILITIES WHICH MAY BE ENCOUNTERED BUT WHICH ARE NOT SHOWN ON THESE PLANS. THE CONTRACTOR OR ANY SUBCONTRACTOR FOR THIS CONTRACT SHALL NOTIFY MEMBERS OF UNDERGROUND SERVICE ALERT (USA) TWO (2) WORKING DAYS IN ADVANCE OF PERFORMING ANY EXCAVATION WORK BY CALLING TOLL FREE 1-800-227-2600, OR 811

Know what's **below Call** before you dig.

C1.1 FENCING AND CONSTRUCTION PLAN C2.1 DETAILS AND SECTIONS WARREN CONSULTING ENGINEERS, INC. (WCE) ASSUMES NO RESPONSIBILITY FOR ERRORS IN PHYSICAL LOCATION OF IMPROVEMENTS, HORIZONTAL OR VERTICAL, IF STAKED BY OTHERS. IN ADDITION, ANY SUCH ERRORS IN PHYSICAL C2.2 DETAILS AND SECTIONS LOCATION MAY AFFECT THE INTENDED DESIGN OF SUCH IMPROVEMENTS AND WCE CANNOT BE HELD RESPONSIBLE

IF SUBSURFACE CULTURAL RESOURCES, REMAINS, AND/OR ARTIFACTS ARE UNCOVERED DURING PROJECT CONSTRUCTION, ALL WORK IN THE VICINITY SHALL BE STOPPED UNTIL SUCH ITEMS CAN BE ASSESSED BY AN APPROPRIATE MEMBER OF THE COUNTY ENVIRONMENTAL IMPACT SECTION STAFF.

FOR SUCH CONDITIONS WHICH ARE A RESULT OF ERRORS IN SURVEYING, OR IMPROPER CONSTRUCTION.

CONTRACTOR AGREES THAT HE/SHE SHALL ASSUME SOLE AND COMPLETE RESPONSIBILITY FOR JOB SITE CONDITIONS DURING THE COURSE OF CONSTRUCTION OF THIS PROJECT, INCLUDING SAFETY OF ALL PERSONS AND PROPERTY: THAT THIS REQUIREMENT SHALL APPLY CONTINUOUSLY AND SHALL NOT BE LIMITED TO NORMAL WORKING HOURS: AND THAT THE CONTRACTOR SHALL DEFEND, INDEMNIFY AND HOLD THE OWNER AND ENGINEER HARMLESS FROM ANY AND ALL LIABILITY, REAL OR ALLEGED, IN CONNECTION WITH THE PERFORMANCE OF WORK ON THIS PROJECT, EXCEPTING FOR LIABILITY ARISING FROM THE SOLE NEGLIGENCE OF THE OWNER OR ENGINEER

THE CONTRACTOR SHALL OBTAIN AN EXCAVATION PERMIT FROM THE STATE OF CALIFORNIA DEPARTMENT OF INDUSTRIAL SAFETY FOR ALL EXCAVATIONS OF 5 FEET OR MORE IN DEPTH.

IT SHALL BE THE CONTRACTOR'S RESPONSIBILITY TO MAKE ALL NECESSARY PRE-BID AND PRE-CONSTRUCTION SITE INSPECTION, AND/OR OBSERVATIONS ON THE SITE TO PRE-DETERMINE ALL HIS/HER MEANS AND METHODS NECESSARY TO COMPLETE THE IMPROVEMENTS SHOWN ON THESE PLANS AND PER THE PROJECT SPECIFICATIONS IT IS THE CONTRACTORS RESPONSIBILITY TO DETERMINE, AND INCLUDE IN HIS/HER CONTRACT, ALL MEANS AND METHODS NECESSARY TO PERFORM A COMPLETE AND ACCEPTABLE JOB.

WHERE IMPROVEMENTS LIE WITHIN AN EXISTING DEVELOPED AREA, CONTRACTOR SHALL USE CAUTION WHEN ACCESSING THE SITE THROUGH THESE EXISTING IMPROVEMENTS. IT IS THE CONTRACTORS RESPONSIBILITY TO PROTECT ANY SUCH EXISTING IMPROVEMENTS OUTSIDE THE PROJECT BOUNDARY, OR EXISTING IMPROVEMENTS WITHIN THE BOUNDARY WHICH ARE TO REMAIN. PROPER PRECAUTIONS SHALL BE PROVIDED AND MAINTAINED THROUGHOUT CONSTRUCTION. ANY DAMAGE SHALL BE REPAIRED OR REPLACED TO THE SATISFACTION OF THE

IT IS THE RESPONSIBILITY OF THE CONTRACTOR TO KEEP DETAILED RECORDS OF MINOR CHANGES OR ADJUSTMENTS MADE DURING CONSTRUCTION (WHICH WERE NOT FORMALLY ISSUED). UPON PROJECT COMPLETION, THESE RECORDS AND/OR INFORMATION SHALL BE PROVIDED TO THE OWNER AND WARREN CONSULTING ENGINEERS INC. UNLESS AN OFFICIAL "AS-BUILT" SET OF PLANS IS A REQUIREMENT OF THE CONTRACT. IF AS-BUILT PLANS ARE A REQUIREMENT OF THE CONTRACT, REFER TO SPECIFICATIONS FOR AS-BUILT DELIVERABLE REQUIREMENTS.

IN VEHICULAR PATHWAYS, EXISTING ASPHALTIC AND/OR CONCRETE SURFACES SHALL BE CUT TO A NEAT AND STRAIGHT LINE, PARALLEL OR PERPENDICULAR TO THE VEHICULAR TRAVELED PATH. THIS IS TYPICALLY THE ROADWAY CENTERLINE, BUT MAY VARY. THAT SAWCUT EDGE SHALL BE PROTECTED FROM DAMAGE DURING CONSTRUCTION SO A CLEAN EDGE REMAINS FOR PATCH BACK.. IF EDGE IS DAMAGED, A NEW SAW CUT WILL BE REQUIRED. THE EXPOSED EDGE SHALL BE "TACKED" WITH EMULSION PRIOR TO PAVING.

NO BURNING OR BLASTING SHALL BE ALLOWED ONSITE UNLESS SPECIFICALLY ADDRESSED ON PLANS. OR SPECIFICALLY APPROVED AND COORDINATED WITH THE ARCHITECT, ENGINEER, AND LOCAL AGENCY OR OTHER ADMINISTRATIVE AUTHORITY.

SUBGRADE AND RESULTING FINISHED GRADE SHALL BE CONSTRUCTED SMOOTH AND UNIFORM BETWEEN SPOT ELEVATIONS, CONTOURS OR OTHER STRUCTURE ELEVATIONS SHOWN ON GRADING OR OTHER PLANS. NO MOUNDS, RUTS, DEPRESSIONS OR OTHER GRADING DEFICIENCIES WILL BE ALLOWED UNLESS SPECIFICALLY SHOWN ON PLANS.

12. ON NEW WATER SYSTEMS. SERVICE LATERALS SHALL BE MADE USING APPROPRIATE "TEE" AND "WYE" FITTINGS. SADDLE TAPS WILL ONLY BE ALLOWED WHEN MAKING CONNECTIONS TO EXISTING WATER MAINS.

CURING COMPOUND SHALL BE APPLIED IN A CONTINUOUS SOLID WET FLOWING COAT. ANY "SPOTTY" APPLICATIONS SHALL BE RECOATED IMMEDIATELY. APPLICATION SHALL BE INSPECTED BY PROJECT INSPECTOR DURING APPLICATION. EMBEDMENT OF FEATURES IN CONCRETE PAVING, CURBS, OR WALLS, SUCH AS SQUARE OR ROUND TUBING, POSTS

OR COLUMNS, STEEL BOLTED PLATES, OR OTHER STRUCTURES, SHALL REQUIRE ADDITIONAL SCORE OR EXPANSION JOINTS TO PREVENT UNCONTROLLED CRACKING. THOSE ADDITIONAL JOINTS MAY OR MAY NOT BE SPECIFICALLY SHOWN ON PLANS BUT SHALL BE PROVIDED BY THE CONTRACTOR. EMBEDMENT OF FEATURES IN CONCRETE PAVING, CURBS, OR WALLS, SUCH AS SQUARE OR ROUND TUBING, POSTS OR COLUMNS, STEEL BOLTED PLATES, OR OTHER STRUCTURES, SHALL REQUIRE A MINOR ADJUSTMENT OF REBAR

WITHIN CONCRETE TO ALLOW FOR SUCH STRUCTURE. THAT REBAR ADJUSTMENT MAY NOT BE SPECIFICALLY SHOWN NO MORE THAN 1 GALLON OF WATER PER YARD OF CONCRETE CAN BE ADDED TO THE TRUCK AFTER ARRIVAL TO PROJECT SITE. THE ADDITION OF WATER CAN ONLY BE ADDED UNDER THE SUPERVISION OF THE CONCRETE

INSPECTOR OR LABORATORY TECHNICIAN. WHEN PUMPING CONCRETE FOR PLACEMENT, ABSOLUTELY NO WATER IS TO BE ADDED TO PUMP HOPPER. ANY

WATER ADDED TO HOPPER WILL BE REASON FOR CONCRETE REJECTION AT THE CONTRACTORS EXPENSE.

. ALL CONTRACTION/CONSTRUCTION JOINTS "CJ" SHALL BE 1/4 THE SLAB THICKNESS DEEP, BUT NO LESS THAN 1' FOR CONTROLLING OF CRACKING. CONTRACTOR SHALL EXERCISE CAUTION WHEN FINAL TROWELING OF CONCRETE SO AS NOT TO FILL IN THESE JOINTS WITH CONCRETE CREAM. ANY CRACKS OUTSIDE OF JOINTS WHICH WERE CONSTRUCTED LESS THAN 1" DEEP, SHALL BE CAUSE FOR CONCRETE SLAB(S) TO BE REMOVED AND REPLACE AT CONTRACTORS EXPENSE.

19. ANY SCREED BOARDS SET WITHIN CONCRETE SLABS SHALL BE AN "OVERHEAD SCREED" SO THERE IS NO INTERFERENCE WITH THE PLACEMENT AND ALIGNMENT OF SLAB REINFORCING.

20. 3-1/2" FELT JOINTS WILL NOT BE ACCEPTED. PROVIDE A FULL 4" FELT JOINT FOR 4" SLAB CONSTRUCTION, AND A 6" FELT JOINT FOR A 6" SLAB SLAB CONSTRUCTION.

SHOULD ANY SHRINKAGE CRACKS OCCUR OUTSIDE OF EITHER THE EXPANSION JOINTS OR CRACK CONTROL JOINTS, THEN THE CONCRETE SLAB SHALL BE SAWCUT AT THE NEAREST JOINTS ON EACH SIDE OF THE CRACK AND THE CONCRETE SECTION SHALL BE, REMOVED AND REPLACED. NEW CONCRETE SHALL BE DOWELED INTO EXISTING CONCRETE PER DRAWING DETAIL.

SEEDED UNLESS OTHERWISE NOTED. HYDRO SEEDING SHALL CONFORM TO LOCAL CITY/COUNTY STANDARDS. 23. REPAIR OR PATCHING OF GALVANIZED METALS, SUCH AS AFTER WELDING GALVANIZED COMPONENTS, SHALL BE

MADE USING A ZINC COMPOSITION "HOT STICK" APPLICATION PER ASTM A 780-01. GALVANIZING PAINTS WILL NOT

- PROVIDE EQUIVALENT OF MEDIUM BROOM FINISH AT SLOPES UP TO 5.99%, TYPICAL. PROVIDE EQUIVALENT OF HEAVY BROOM FINISH AT SLOPES 6% AND GREATER. REFER TO SPECIFICATIONS.
- ALL NEW PEDESTRIAN WALKWAYS (NON-RAMP) SHALL BE SLOPED NO GREATER THAN 2.0%, AND NO LESS THAN 0.75% IN ANY DIRECTION, UNLESS SPECIFICALLY LABELED OTHERWISE. ALL CONCRETE SHALL MEET THE FOLLOWING SLOPE REQUIREMENTS:
- NO GREATER THAN 2% SLOPE IN ANY DIRECTION IN COURTYARD OR PLAZA AREAS.

**City Unified School District** 

Sacramento City Unified School District 5735 47th Avenue Sacramento, CA 95824-4528

**ANTHONY J TASSANO** 

**CK McClatchy High School** 2023 Fencing

3066 Freeport Boulevard Sacramento, CA 95818

TOTAL SHEET COUNT € 10 1/1

OWNER:

**REVISIONS** OWNER/USER DESCRIPTION ADDENDUM NO.1 SACRAMENTO CITY UNIFIED SCHOOL DISTRICT 5735 47TH AVE. SACRAMENTO, CA 95824-4528

PHONE: (916) 643-9000 **DISTRICT CONTACT:** [CONTACT] FACILITIES SUPPORT SERVICES (916) 264-4075 [EMAIL]

**ADDITIONAL CONTACTS:** TROY MIETZ TROY-MIETZ@SCUSD.EDU DRAWN: SCALE: AS NOTE PROJECT NO. CHECKED: 23-052 DESIGNED: 4/24/2023 ISSUANCE:


# PROJECT TEAM

WARREN CONSULTING ENGINEERS, INC. 1117 WINDFIELD WAY, SUITE 110 EL DORADO HILLS, CA 95762 PHONE: (916) 985-1870 FAX: (916) 985-1877

ELEC/LV: KMM SERVICES, INC. 5433 EL CAMINO AVENUE, SUITE 5 CARMICHAEL, CA 95608 PHONE: (916) 359-4000 WWW.KMMSERVICES.COM


SHEET NO.

**COVER SHEET** 

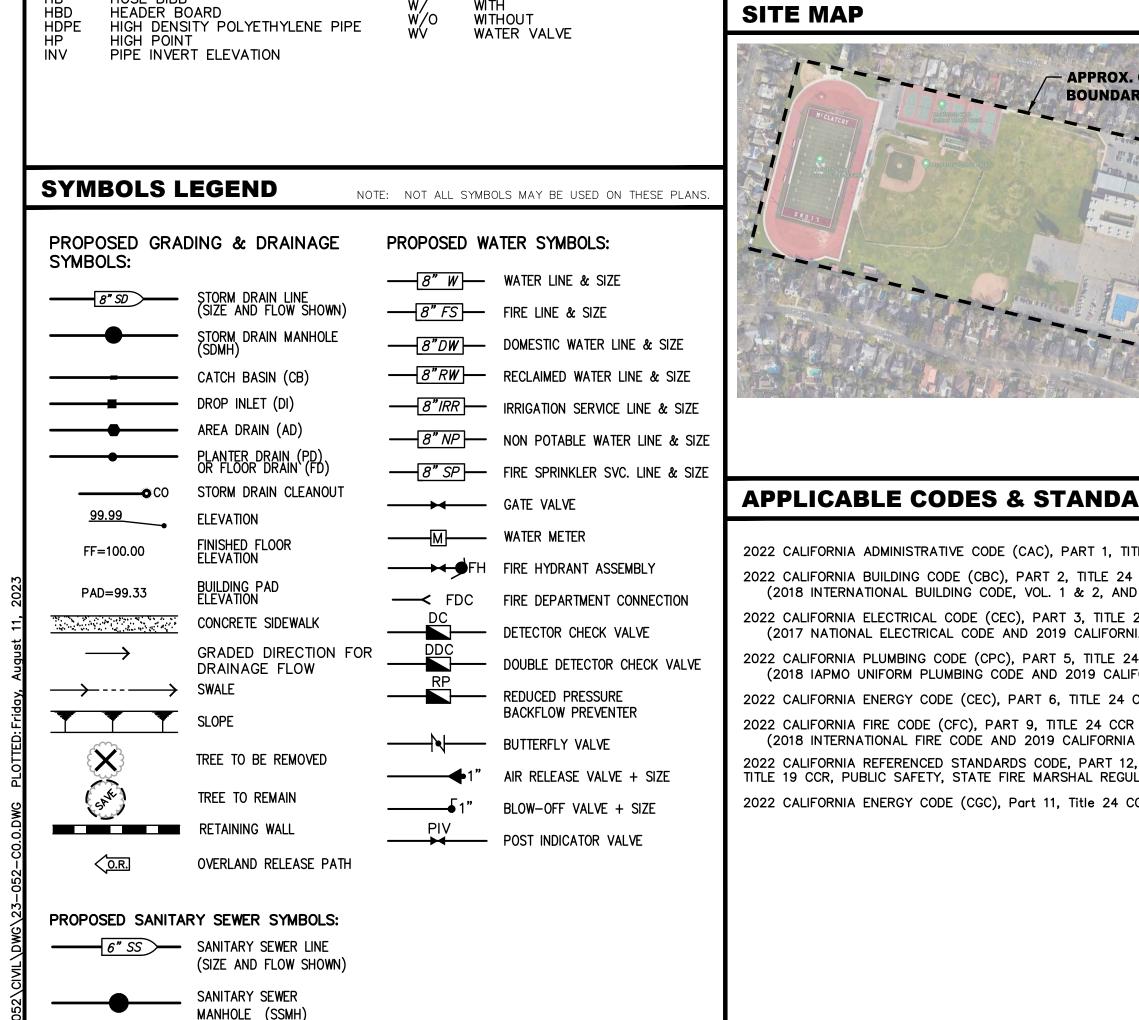

SEWER CLEANOU?

FLUSHER BRANCH

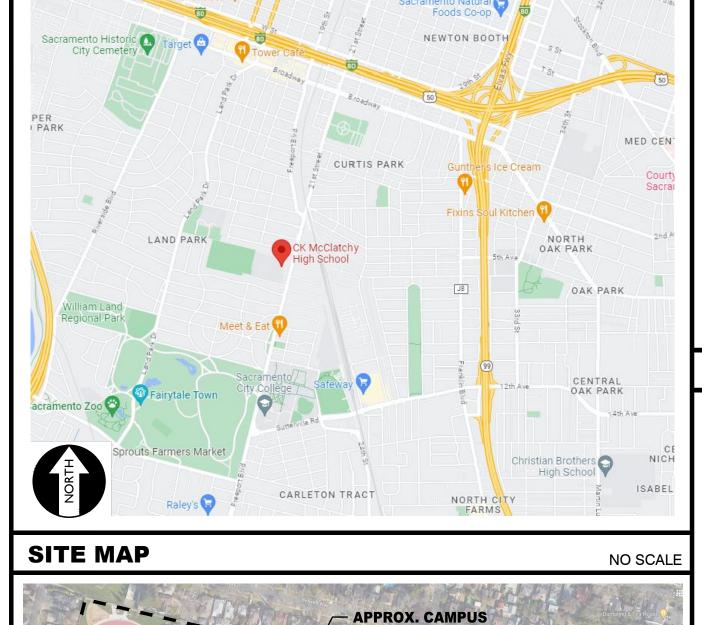



# APPLICABLE CODES & STANDARDS

2022 CALIFORNIA ADMINISTRATIVE CODE (CAC), PART 1, TITLE 24 CCR\* 2022 CALIFORNIA BUILDING CODE (CBC), PART 2, TITLE 24 CCR (2018 INTERNATIONAL BUILDING CODE, VOL. 1 & 2, AND 2019 CALIFORNIA AMENDMENTS) 2022 CALIFORNIA ELECTRICAL CODE (CEC), PART 3, TITLE 24 CCR

(2017 NATIONAL ELECTRICAL CODE AND 2019 CALIFORNIA AMENDMENTS) 2022 CALIFORNIA PLUMBING CODE (CPC), PART 5, TITLE 24 CCR (2018 IAPMO UNIFORM PLUMBING CODE AND 2019 CALIFORNIA AMENDMENTS) 2022 CALIFORNIA ENERGY CODE (CEC), PART 6, TITLE 24 CCR

(2018 INTERNATIONAL FIRE CODE AND 2019 CALIFORNIA AMENDMENTS) 2022 CALIFORNIA REFERENCED STANDARDS CODE, PART 12, TITLE 24 CCR TITLE 19 CCR, PUBLIC SAFETY, STATE FIRE MARSHAL REGULATIONS 2022 CALIFORNIA ENERGY CODE (CGC), Part 11, Title 24 CCR.


# **DEFERRED APPROVALS**

# **STATEMENTS:**

22. ALL AREAS DISTURBED BY GRADING OPERATIONS WHETHER SHOWN ON THE DRAWINGS OR NOT SHALL BE HYDRO

# **GENERAL PAVING SURFACE NOTES:**


- NO GREATER THAN 5% SLOPE IN THE DIRECTION OF TRAVEL. - NO GREATER THAN 2% SLOPE CROSSING THE DIRECTION OF TRAVEL

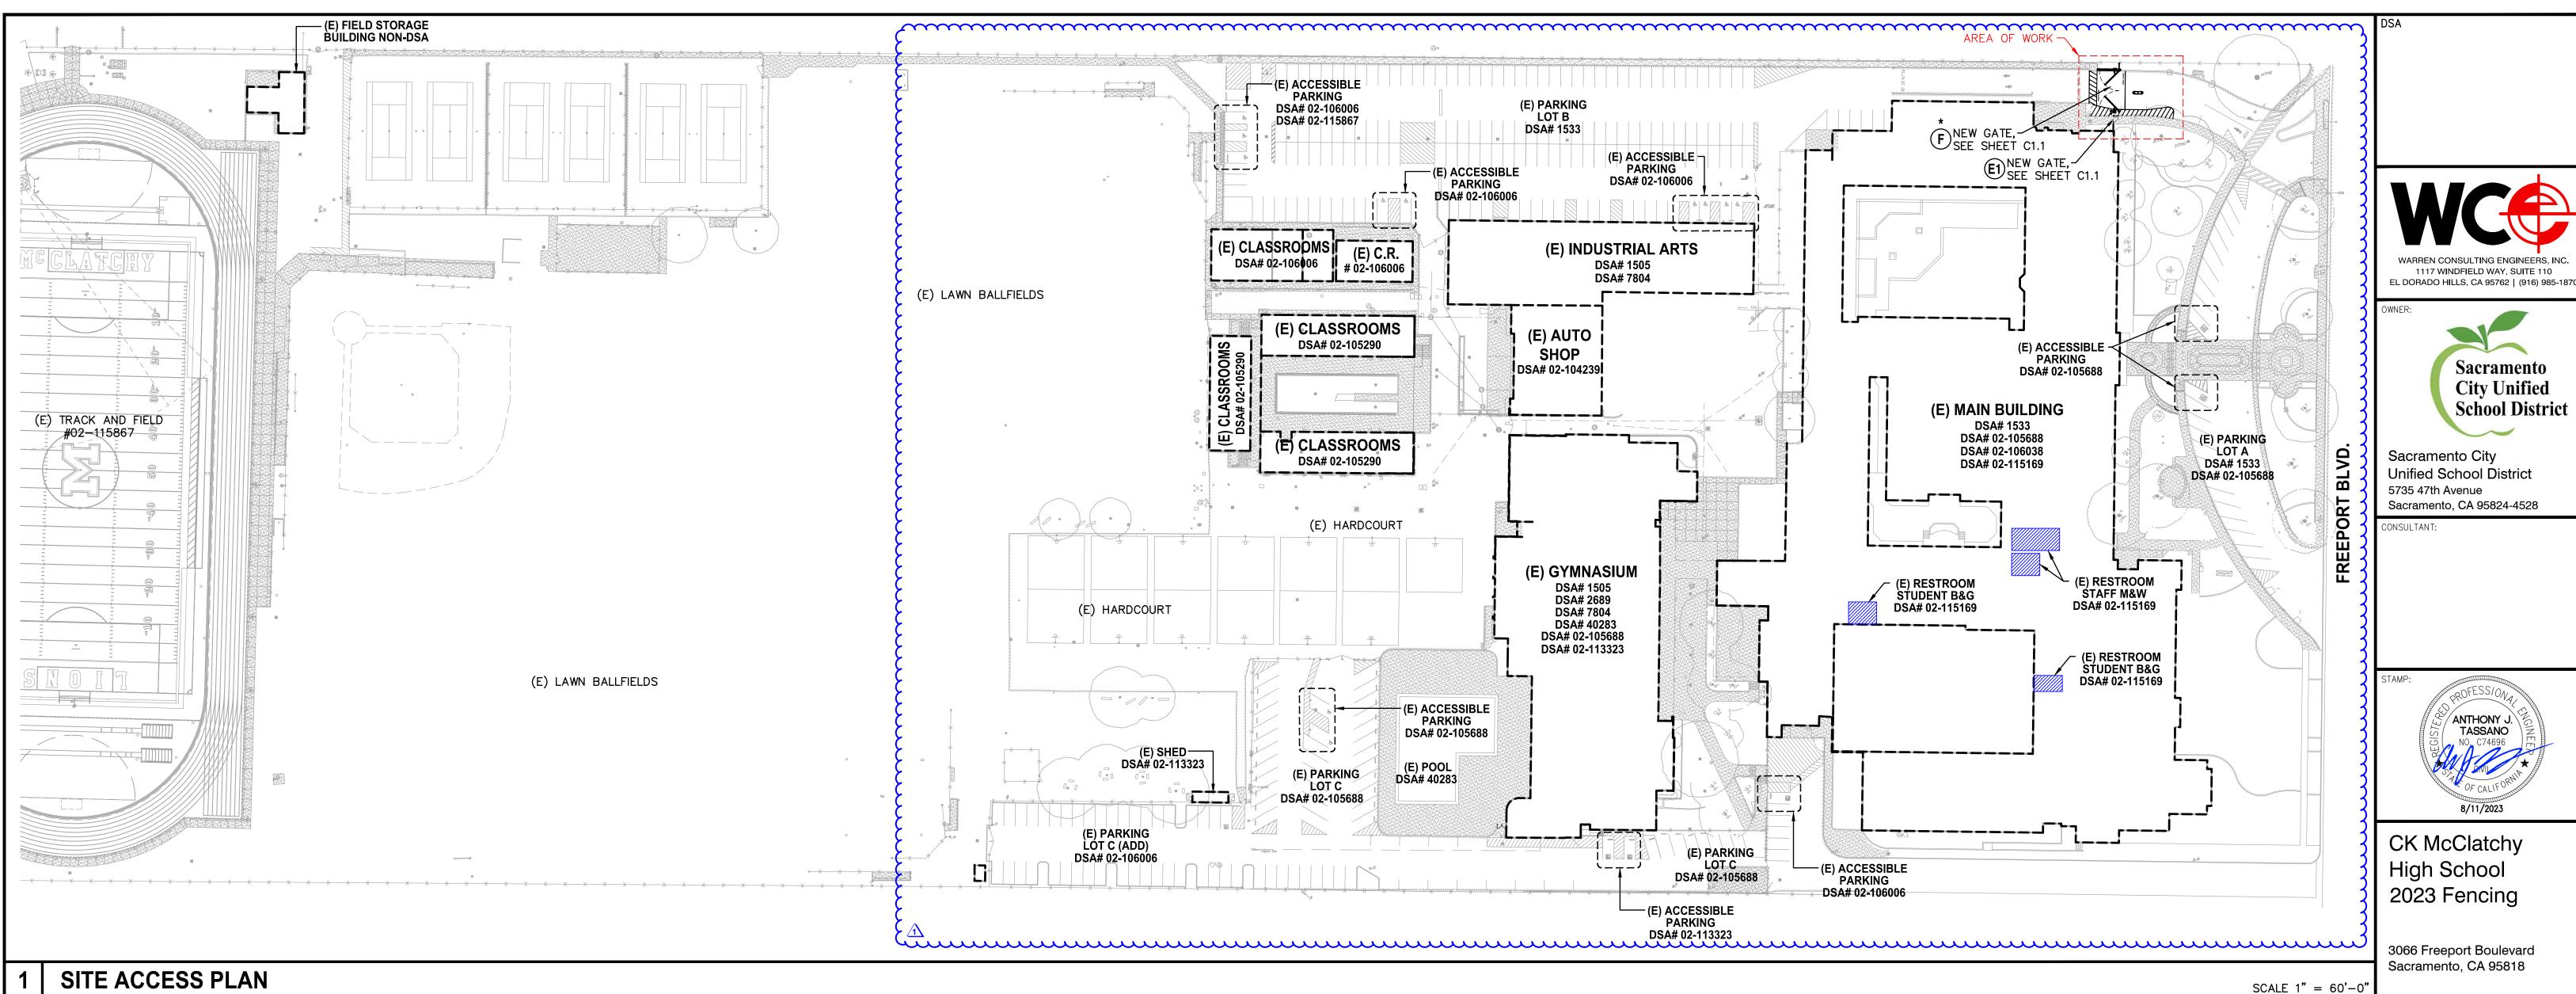

SITE ACCESS PLAN



| GA         | IE LEGEND   |                    |
|------------|---|--------------------|
| $\bigcirc$ | ORNAMENTAL METAL GATES  | DETAIL REF.        |
| E1         | SINGLE ACCESSIBLE PEDESTRIAN GATE WITH ALL ACCESSIBLE HARDWARE & PANIC FOR EGRESS.            | 4<br>C2.2          |
| F          | FIRE LANE VEHICULAR ACCESS GATE, MINIMUM 20'<br>CLEAR WITH KNOX BOX OR KNOX LOCK.             | * 2 8<br>C2.2 C2.1 |
| •          | WHERE "*" SHOWN ON PLAN, VEHICULAR GATE IS PRO'ECTRONIC ACCESS CONTROLS. NOTE: ELECTRONIC CON |                    |
|            | CK OUT INSIDE GATE EGRESS. GATE OPENER SHALL ALS<br>D BE INSTALLED PER ASTM F2200.)           | SO MEET UL 325     |

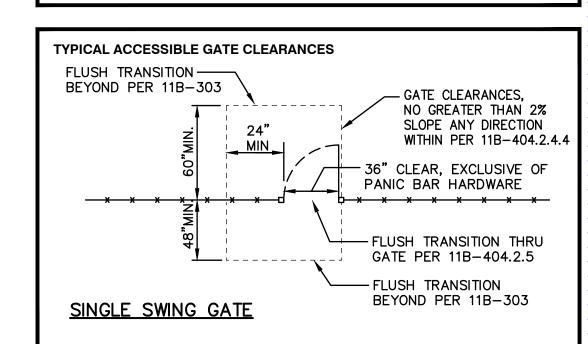

**GENERAL SITE PLAN AND ACCESS NOTES:** 

1. Slope shall not be steeper than 1:48 in any direction in open areas." At least one accessible route within the boundary of the site shall be provided from public way, accessible parking, and accessible restrooms, to area of work.

2. Slopes in direction of P.O.T. greater than 1:20 are considered ramps(11B-405); Please show all.

3. Walks in path of travel shall be free of gratings wherever possible. Grating which occur within the P.O.T. shall have grid openings at ½" maximum in the direction of traffic flow per CBC Section 11B-302.3; Provide manufactures

4. When provided, all new gates and gates on path of travel must comply with 11B-404 requirements. Provide a 24" min. Strike side clearance on pull side and a smooth surface at the bottom 10 inches of push side of gate. Specify accessible / lever hardware.

| ~ |   |          |          |
|---|---|----------|----------|
| 7 | PARKING LOT A PARKING TOTALS                                      | EXISTING | PROPOSED |
| 4 | STANDARD PARKING STALLS ACCESSIBLE PARKING SPACES                 | 159<br>9 | 159<br>9 |
| 3 | OVERALL TOTAL PARKING SPACES                                      | 168      | 168      |
| 2 | (E) ACCESSIBLE SPACE REQUIREMENTS                                 | REQUIRED | PROVIDED |
| 3 | REQUIRED ACCESSIBLE SPACES (CAR)                                  | 4        | 5        |
| 2 | REQUIRED ACCESSIBLE SPACES (VAN)                                  | 1        | 4        |
| 3 | TOTAL REQUIRED ACCESSIBLE SPACES (PER 2022 CBC SECTION 11B-208.2) | 5        | 9        |
|   |   |          |          |

| PARKING LOT B                                     |          |         |
|---|----------|---------|
| PARKING TOTALS                                    | EXISTING | PROPOSE |
| STANDARD PARKING STALLS ACCESSIBLE PARKING SPACES | 26<br>2  | 23<br>2 |
| OVERALL TOTAL PARKING SPACES                      | 28       | 25      |
| (E) ACCESSIBLE SPACE REQUIREMENTS                 | REQUIRED | PROVIDE |
| REQUIRED ACCESSIBLE SPACES (CAR)                  | 1        | 1       |
| REQUIRED ACCESSIBLE SPACES (VAN)                  | <u> </u> | 1       |
| TOTAL REQUIRED ACCESSIBLE SPACES                  | 2        | 2       |

(PER 2022 CBC SECTION 11B-208.2)

| PARKING LOT C PARKING TOTALS                                      | EXISTING | PROPOSED |
|---|----------|----------|
| STANDARD PARKING STALLS<br>ACCESSIBLE PARKING SPACES              | 100<br>6 | 100<br>6 |
| OVERALL TOTAL PARKING SPACES                                      | 106      | 106      |
| (E) ACCESSIBLE SPACE REQUIREMENTS                                 | REQUIRED | PROVIDED |
| REQUIRED ACCESSIBLE SPACES (CAR)                                  | 3        | 3        |
| REQUIRED ACCESSIBLE SPACES (VAN)                                  | 1        | 3        |
| TOTAL REQUIRED ACCESSIBLE SPACES (PER 2022 CBC SECTION 11B-208.2) | 4        | 6        |

# "Design Professional in General Responsible Charge Statement:

The POT identified in these construction documents meets the requirements of the current applicable California Building Code (CBC) accessibility provisions for path of travel requirements for alterations, additions and **structural repairs**. As part of the design of this project, the POT was examined and any elements, components or portions of the POT that were determined to be noncompliant with the CBC have been identified and the corrective work necessary to bring them into compliance has been included within the scope of this project's work through details, drawings and specifications incorporated into these construction documents. Any noncompliant elements, components or portions of the POT that will not be corrected by this project based on valuation threshold limitations or a finding of unreasonable hardship are indicated in these construction documents.

During construction, if POT items within the scope of the project represented as CBC compliant are found to be nonconforming beyond reasonable construction tolerances, the items shall be brought into compliance with the CBC as a part of this project by means of a construction change document."

# **FENCEING ONLY PROJECT ACCESSIBLE PATH OF TRAVEL**

IN ACCORDANCE WITH DSA IR A-22, ITEM NO. 12, KEYNOTE 4, THE ACCESSIBLE PATH OF TRAVEL REVIEW SHALL BE LIMITED TO WHERE NEW FENCES AND GATES AFFECT/CROSS AN ACCESSIBLE PATH OF TRAVEL.

# **ACCESSIBLE PATH OF TRAVEL (P.O.T.)**

TO THE BEST OF THE KNOWLEDGE OF THE ARCHITECT AND/OR ENGINEER. OR THE DISTRICT, THE PATH OF TRAVEL (P.O.T.) AS INDICATED, IS A BARRIER FREE ACCESS ROUTE CONFORMING TO THE FOLLOWING:

1. THERE ARE NO ABRUPT LEVEL CHANGES EXCEEDING 1/2" IF BEVELED

- AT 1V:2H MAX SLOPE, OR VERTICAL LEVEL CHANGES NOT EXCEEDING 1/4" MAX. 2. THE MINIMUM WIDTH OF THE P.O.T. IS 48" AT ANY GIVEN POINT.
- (11B-403.5.1)

IN THE DIRECTION OF TRAVEL (11B-405.2).

- 3. THE SURFACE OF THE P.O.T. STABLE, FIRM, AND SLIP RESISTANT. (11B-403.2)
- UNLESS OTHERWISE INDICATED, WITH THE FOLLOWING EXCEPTIONS: A. THE SLOPED PORTION OF "RAMP" DOES NOT EXCEED 8.33% (1V:12H)

4. THE MAXIMUM SLOPE IN THE DIRECTION OF TRAVEL IS 5.0% (11B-403.3),

- B. THE SLOPED PORTION OF A "CURB RAMP" DOES NOT EXCEED 8.33% (1V:12H) IN THE DIRECTION OF TRAVEL (11B-406.2.1 AND 11B-406.3.1).
- 5. THE CROSS SLOPE OF THE ACCESSIBLE PATH OF TRAVEL DOES NOT EXCEED 2% AT ANY GIVEN POINT (11B-403.3).
- 6. THE ACCESSIBLE PATH OF TRAVEL SHALL BE MAINTAINED FREE OF OVERHANGING OBSTRUCTIONS TO 80" MINIMUM (11B-307).
- 7. THERE ARE NO PROTRUDING OBJECTS GREATER THAN 4" PROJECTION FROM WALL AND ABOVE 27" AND LESS THAN 80" (11B-307).
- 8. PASSING SPACES AT LEAST 60"X60" ARE LOCATED NOT MORE THAT 200' APART. (11B-403.5.3)

10. THERE IS NO DROP-OFF OVER 4" AT THE EDGE OF WALK OR LANDING.

- 9. PARTS OF P.O.T. WITH CONTINUOUS GRADIENTS HAVE 60" LEVEL AREAS NOT MORE THAN 400' APART. (11B-407.3)
- (11B-303.5) 11. ARCHITECT AND CONTRACTOR SHALL VERIFY THAT ALL BARRIERS ON
- 12. THERE ARE NO GRATINGS WITHIN THE PATH OF TRAVEL WITH GRATE OPENINGS EXCEEDING 1/2" IN THE DIRECTION OF TRAVEL. (11B-302.3)

THE INDICATED PATH OF TRAVEL HAVE BEEN REMOVED.



LEGEND

ACCESSIBLE PATH OF TRAVEL (P.O.T.)

NEW CONCRETE WALKWAY (SEE SHEET C2.1)

SCOPE OF PROJECT

ST STORAGE, SHED/CONTAINER

--- PROPERTY LINE

---- ROAD CENTERLINE


EXISTING CONCRETE WALKWAY

(SEE SHEET CO.1-CO.2 & C2.1)

LIMIT/END OF PATH OF TRAVEL THIS PROJECT.

- PATH OF TRAVEL CONTINUATION INTO ACCESSIBLE

ACCESSIBLE RESTROOM (PROJECT COMPLIANCE)

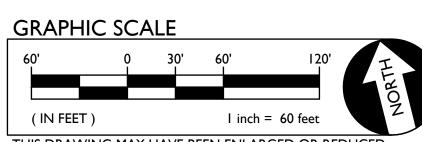

# Call before you dig. THIS DRAWING M.

| ( IN FEET )                                    | I inch = 60 feet |   |     |               |          |
|--|------------------|---|-----|---------------|----------|
| THIS DRAWING MAY HAVE BEEN ENLARGED OR REDUCED |                  |   |     | REVISIONS     | <u>`</u> |
|  |                  |   | NO. | DESCRIPTION   |          |
| D  |                  |   | 1   | ADDENDUM NO.1 |          |
|  |                  |   |     |               |          |
| EXISTING BUILDING NOT MODI                     | ERNIZED BY THIS  | 5 |     |               | _        |
|  | <b>-</b>         |   |     |               |          |
| STORAGE CONTAINER / SHEE                       | J                |   |     |               |          |
|  |                  |   |     |               |          |

| DRAWN:    | SCALE:      |
|-----------|-------------|
| SMN       | AS NOTED    |
| CHECKED:  | PROJECT NO. |
| AT        | 23-052      |
| DESIGNED: | DATE:       |
| SMN/AT    | 4/24/2023   |
| ISSUANCE: |             |

1117 WINDFIELD WAY, SUITE 110

Sacramento

**City Unified** 

**ANTHONY J** 

**TASSANO** 

**School District** 

SHEET TITLE:

SITE ACCESS **PLAN** 

SHEET NO.

C1.0.1



# FIRE & LIFE SAFETY SITE CONDITIONS SUBMITTAL

Division of the State Architect (DSA) documents referenced within this publication are available on the DSA Forms or DSA Publications webpages.

To facilitate the Division of the State Architect's (DSA) fire and life safety plan review of project site conditions, DSA requires the design professional to provide the following information at time of project submittal for projects consisting of construction of a new campus, construction of new building(s), additions to existing buildings, and for site alternate design means for fire department emergency vehicle access, and fire suppression water supply.

Information associated with compliance items 1 through 3 below is to be provided for all project types indicated above. Information associated with items 4 through 7 is to be completed when an alternate means is utilized. Acknowledgement by the school district and signature from the Local Fire Authority (LFA) is only required when an alternate design means is being requested.

The Project Information and Fire & Life Safety Information sections are to be completed for all projects and imaged onto the fire access site plan. When an alternate design/means is proposed, all sections on pages 1 and 2 are to be completed and imaged on the fire access site plan.

For additional information refer to the instructions at the end of this form and DSA Policy PL 09-01: Fire Flow for

# PROJECT INFORMATION School District/Owner: SACRAMENTO CITY UNIFIED SCHOOL DISTRICT Project Name/School: C.K. McCLATCHY HIGH SCHOOL Project Address: 3066 FREEPORT BOULEVARD, SACRAMENTO, CA 95818

| 1. | Has a fire hydrant flow test been performed within the past 12 months?  | Yes 🔲    |        | No X      |  |
|----|---|----------|--------|-----------|--|
|    | (If yes, provide a copy of the test data.)  |          |        |           |  |
| 2. | Was the fire hydrant water flow test performed as part of this LFA review?  | Yes 🗉    |        | No 💢      |  |
| 3. | Is the project located within a designated fire hazard severity zone (FHSZ) as established by Cal-Fire? (If yes, indicate FHSZ classification below.) | Yes 🗆    |        | No X      |  |
|    | Refer to the following website for FHSZ locations:<br>http://eqis.fire.ca.gov/FHSZ/   | Moderate | High 🔲 | Very High |  |
|    | Wildland Interface Area (WIFA) (If any designations are checked, project design must meet the requirements of CBC Chapter 7A.)                        |          |        |           |  |

DGS DSA 810 (revised 12/29/20) DEPARTMENT OF GENERAL SERVICES STATE OF CALIFORNIA DIVISION OF THE STATE ARCHITECT

FIRE & LIFE SAFETY SITE CONDITIONS SUBMITTAL

| CON | IDITION MEANS AND METHODS RESOLUTION   | ALTE | RNATE | ACCEPTI | ED  |
|-----|--|------|-------|---------|-----|
|     |  | Yes  | No    | N/A     | N/R |
| 4.  | Emergency vehicle access roadways do not meet CFC requirements.  |      |       | X       |     |
| 4a. | Acceptable Alternate: Emergency vehicle and personnel access as proposed by the project architect is acceptable for providing fire suppression and protection of life and property.                          |      |       |         |     |
| 5.  | Fire Hydrants: Number and spacing does not meet CFC requirements.  |      |       | X       |     |
| 5a. | Acceptable Alternate: Number of fire hydrants and spacing as proposed by the project architect is acceptable for fire suppression and protection of life and property.                                       |      |       |         |     |
| 6.  | Fire Hydrants: Water flow and pressure are less than CFC minimum.  | ė    |       | X       | y)  |
| 6a. | Acceptable Alternate: The available flow and pressure is acceptable for providing fire suppression and protection of life and property.  |      |       |         |     |
| 7.  | Location of fire department connection(s) serving fire sprinkler systems or standpipe systems does not meet CFC requirements.  |      |       | X       |     |
| 7a. | Acceptable Alternate: The location of fire department connection serving the fire sprinkler system and/or standpipe system is acceptable for providing fire suppression and protection of life and property. |      |       |         |     |

School District Acceptance of Acceptable Design Alternates

DGS DSA 810 (revised 12/29/20)

DIVISION OF THE STATE ARCHITECT

By signing this form, the school district acknowledges and accepts the proposed design as an alternative to California Building Code (CBC) and California Fire Code (CFC) minimum requirements, as indicated by one or more of the conditions

| indicated at it | ems 4a, 5a, 6a or 7a, for providing fire and life safety protec | tion of life a | and property. |  |
|-----------------|---|----------------|---------------|--|
| Accepted by:    | N/A - NO VARIANCE PROPOSED                                      | Title:         |               |  |
| Signature:      |   |                | Date:         |  |

| LFA Agency Name:     | <b>City of Sacramento Fire Departr</b> | nent        |                |
|----------------------|--|-------------|----------------|
| LFA Review Official: | King Tunson                            |             |                |
| Title: Program       | Specialist                             | Work Phone: | (916) 808-1358 |
| Work Email: ktur     | nson@sfd.cityofsacramento.org          |             |                |
|                      | *                                      |             |                |
| FA Reviewer's Signa  | ture:                                  | Date:       |                |

DEPARTMENT OF GENERAL SERVICES

SEE STRIPING PLAN FOR ACTUAL REQUIRED STRIPING.

NOTE:

All new and existing fire lanes are asphalt or concrete paved unless otherwise stated.

TYPICAL FIRE LANE

CLEAR WIDTH 20 FEET CLEAR HEIGHT 13.5 FEET INSIDE RADIUS 35 FEET MIN. OUTSIDE RADIUS 55 FEET MIN.

(E) FIRE LANE **GRAPHIC SCALE** (E) PARKING LOT B R=~45'— R=~25'— DSA# 1533 (E) FIRE LANE (E) FIRE LANE \_\_\_\_\_\_\_\_ THIS DRAWING MAY HAVE BEEN ENLARGED OR REDUCED. (E) INDUSTRIAL ARTS (E) CLASSROOMS ( (E) C.R. DSA# 02-106**0**06 # 02-106006 DSA# 7804 (E) LAWN BALLFIELDS (E) CLASSROOMS (E) AUTO DSA# 02-105290 SHOP DSA# 02-104239 (E) MAIN BUILDING DSA# 1533 DSA# 02-105688 (E) PARKING (E) CLASSROOMS DSA# 02-106038 LOT A DSA# 02-105290 DSA# 02-115169 DSA# 1533 DSA# 02-105688 (E) HARDCOURT (E) GYMNASIUM DSA# 1505 DSA# 2689 (E)FH -DSA# 7804 DSA# 40283 (E) 20' CLEAR GATE DSA# 02-105688 DSA# 02-113323 DSA# 02-113323 DŠÁ# 40283 (E) LAWN BALLFIELDS (E) PARKING (E) PARKING R=55 LOT C R=35 DSA# 02-105688 LOT C DSA# 02-106006 (E) FIRE LANE (E) FIRE LANE ►(E) 20' CLEAR GATE (E) 20' CLEAR GATE

SCALE 1'' = 60' - 0''

**ELECTRIC GATE OPENER REQUIREMENTS** 

ELECTRIC GATE OPENER, WHEN ALONG THE FIRE APPARATUS ACCESS LANE, PER CFC 503.6.1 SHALL BE PER UL 325. THE GATE INSTALLATION IS DESIGNED AND SHALL BE CONSTRUCTED AND INSTALLED TO COMPLY WITH ASTM F2200.

1117 WINDFIELD WAY, SUITE 110 EL DORADO HILLS, CA 95762 | (916) 985-1870

Sacramento **City Unified School District** 

Sacramento City **Unified School District** 5735 47th Avenue Sacramento, CA 95824-4528

CONSULTANT:

ANTHONY J **TASSANO** 

**CK McClatchy** High School 2023 Fencing

3066 Freeport Boulevard Sacramento, CA 95818

**REVISIONS** DESCRIPTION ADDENDUM NO.1

DRAWN: SCALE: AS NOTED CHECKED: PROJECT NO. 23-052 DESIGNED: DATE: SMN/AT 4/24/2023

SHEET TITLE:

ISSUANCE:

SITE FIRE ACCESS

PLAN

SHEET NO.

POUNDS IN ACCORDANCE WITH CFC 2022, APPENDIX D.

FIRE ACCESS PLAN

**PAVEMENT NOTES** 

**KNOX NOTES** 

DESIGNATION.

Page 2 of 4

STATE OF CALIFORNIA

# FIRE LANE DESIGNATION

ALL FIRE LANES ON THIS PLAN SHALL BE DESIGNATED IN ACCORDANCE WITH THE STRIPING PLANS, UTILIZING ONE OF THE FOLLOWING APPROVED MEANS:

ALL GATES WHICH CROSS THE FIRE LANE AS DESIGNATED BY THIS


ALL FIRE CONTROL ROOMS FOR THIS PROJECT SHALL BE OUTFITTED WITH A HIGH LEVEL KNOX BOX AT A LOCATION WHICH IS APPROVED BY THE

FIRE ACCESS ROADWAYS SHALL BE BUILT TO BEAR A MINIMUM OF 75,000

PLAN SHALL BE OUTFITTED WITH A LOW LEVEL KNOX LOCK.


SACRAMENTO METROPOLITAN FIRE DISTRICT INSPECTOR.

- CURBS PAINT CURB TOP AND FACE RED WITH COMMERCIAL GRADE RED TRAFFIC PAINT. ON FACE OF CURB, PAINT 4" TALL WHITE LETTERING STATING "NO PARKING - FIRE LANE" AT 25' O.C. CENTERED ON FACE.
- PAVING PAINT 6" WIDE RED STRIPE ON PAVEMENT WITH COMMERCIAL GRADE RED TRAFFIC PAINT. CENTERED IN STRIPE, PAINT 4" TALL WHITE LETTERING STATING "NO PARKING - FIRE LANE" AT 25' O.C.
- SIGNAGE POSTING OF SIGNS COMPLIANT WITH CFC 2016, APPENDIX D103.6 EVERY 50 FEET.
- STREETS 20' WIDE TO 26' WIDE SHALL BE MARKED ON BOTH SIDES AS STATED ABOVE.
- STREETS GREATER THAN 26' WIDE NEED ONLY MARKING ON ONE SIDE AS STATED ABOVE. EDGES OF FIRE LANES AT PARKING DO NOT REQUIRE

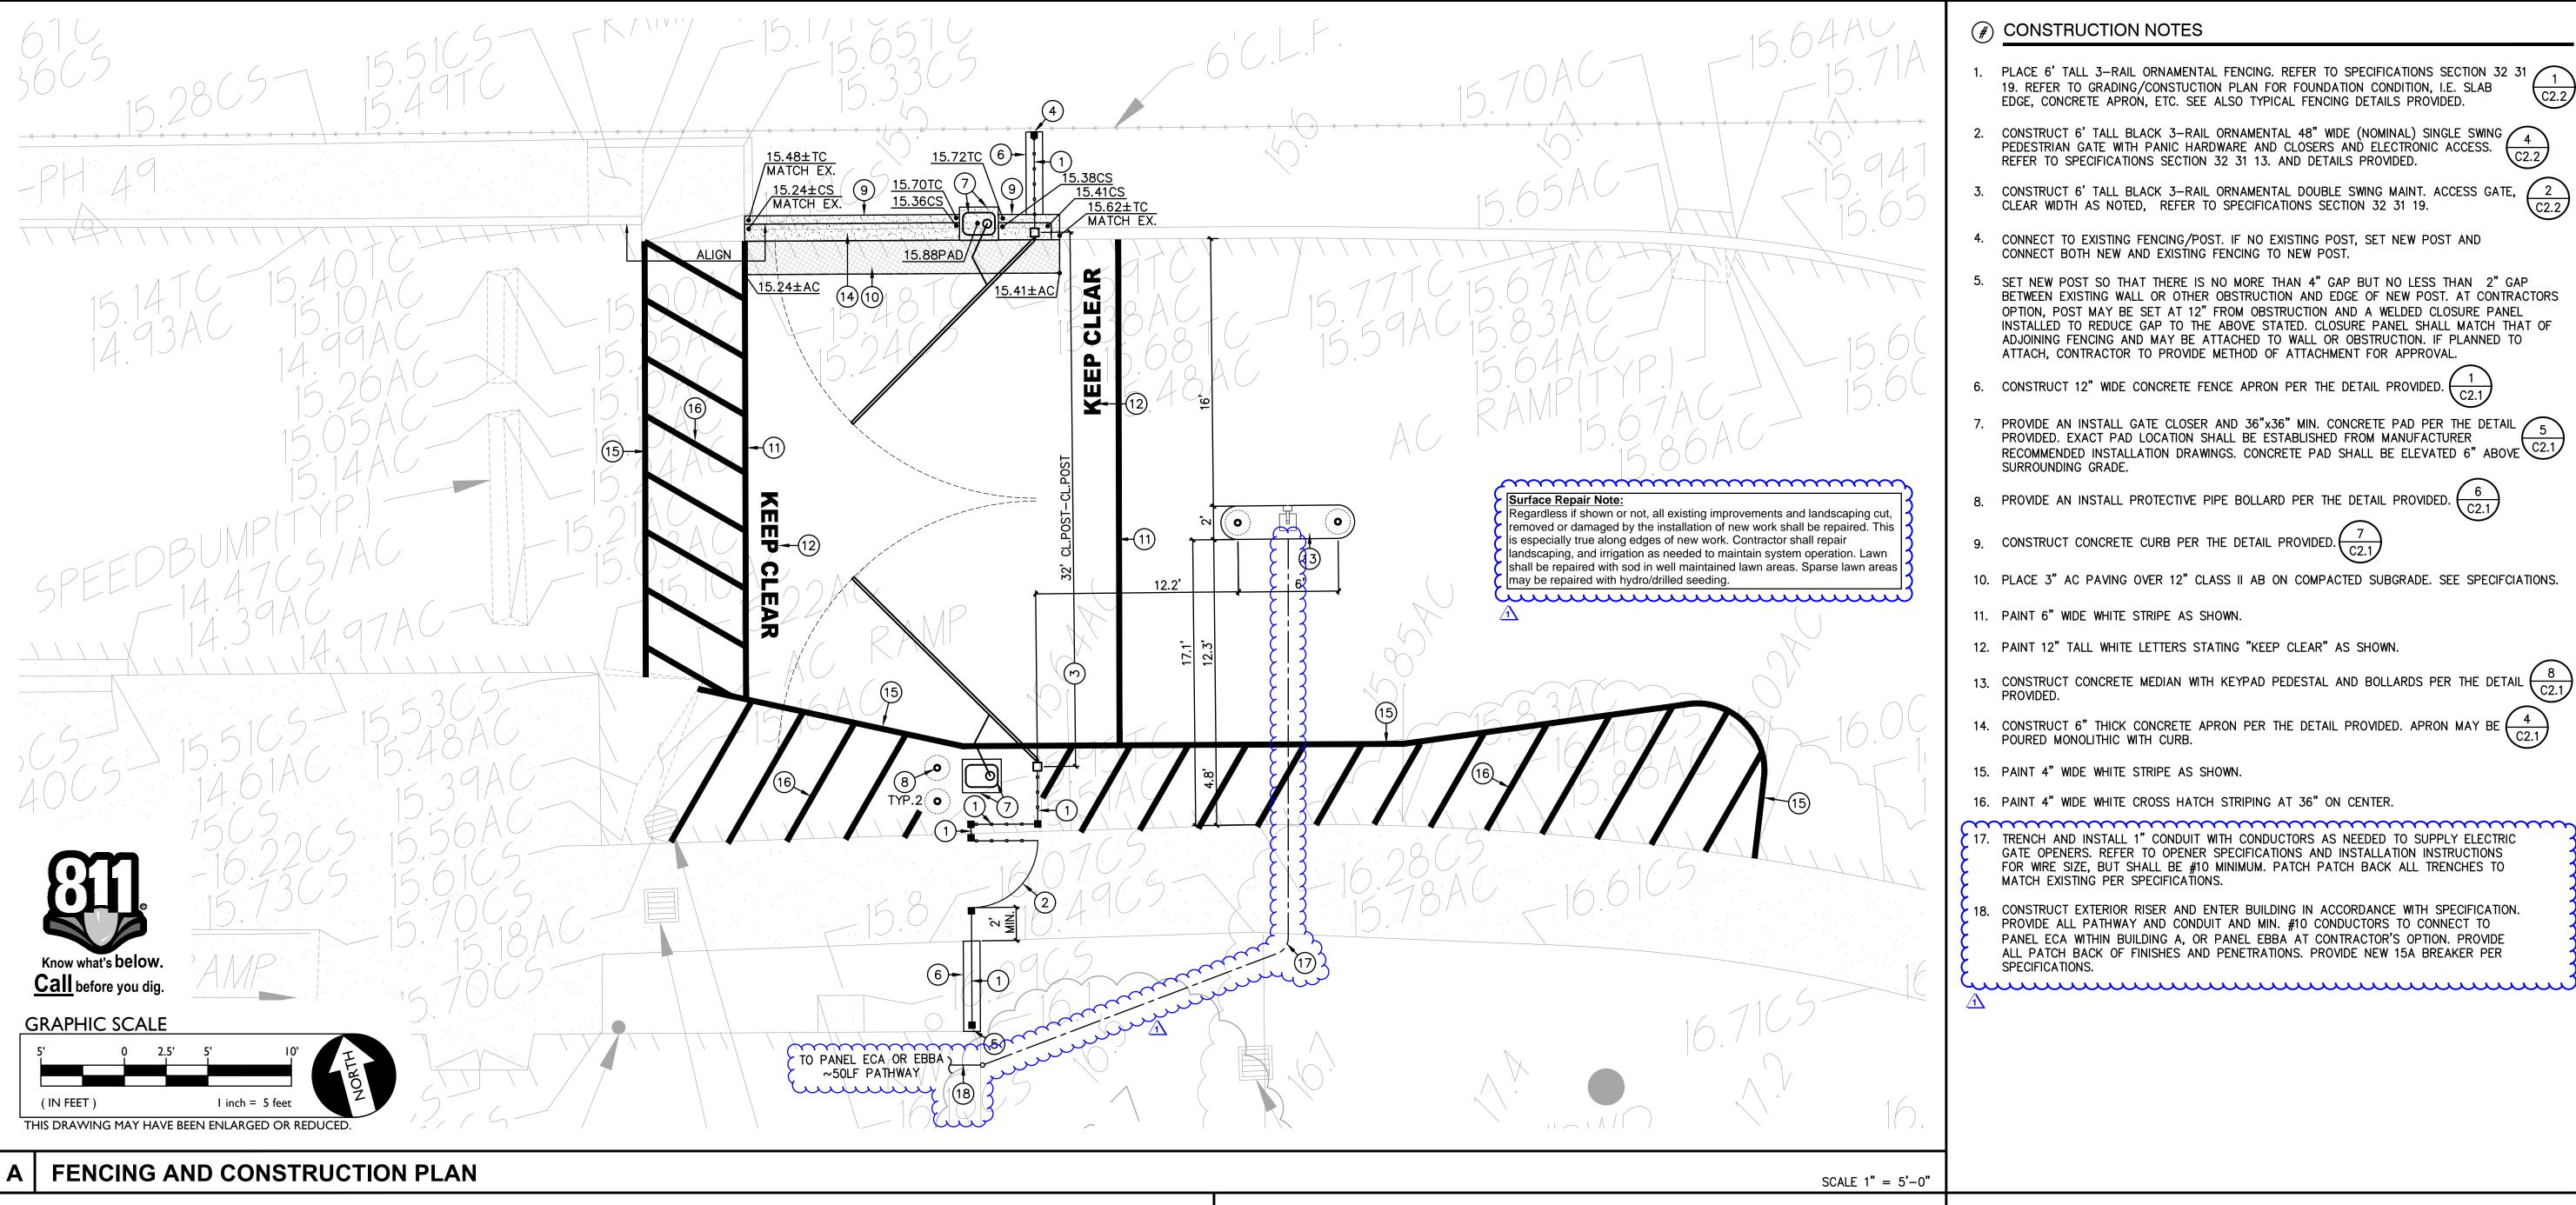

(#) CONSTRUCTION NOTES


PLACE 6' TALL 3-RAIL ORNAMENTAL FENCING. REFER TO SPECIFICATIONS SECTION 32 31 19. REFER TO GRADING/CONSTUCTION PLAN FOR FOUNDATION CONDITION, I.E. SLAB EDGE, CONCRETE APRON, ETC. SEE ALSO TYPICAL FENCING DETAILS PROVIDED.

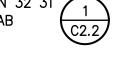

CONSTRUCT 6' TALL BLACK 3-RAIL ORNAMENTAL 48" WIDE (NOMINAL) SINGLE SWING PEDESTRIAN GATE WITH PANIC HARDWARE AND CLOSERS AND ELECTRONIC ACCESS. REFER TO SPECIFICATIONS SECTION 32 31 13. AND DETAILS PROVIDED.



CONSTRUCT 6' TALL BLACK 3-RAIL ORNAMENTAL DOUBLE SWING MAINT. ACCESS GATE, CLEAR WIDTH AS NOTED, REFER TO SPECIFICATIONS SECTION 32 31 19.

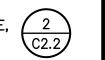

4. CONNECT TO EXISTING FENCING/POST. IF NO EXISTING POST, SET NEW POST AND CONNECT BOTH NEW AND EXISTING FENCING TO NEW POST.

SET NEW POST SO THAT THERE IS NO MORE THAN 4" GAP BUT NO LESS THAN 2" GAP BETWEEN EXISTING WALL OR OTHER OBSTRUCTION AND EDGE OF NEW POST. AT CONTRACTORS OPTION, POST MAY BE SET AT 12" FROM OBSTRUCTION AND A WELDED CLOSURE PANEL INSTALLED TO REDUCE GAP TO THE ABOVE STATED. CLOSURE PANEL SHALL MATCH THAT OF ADJOINING FENCING AND MAY BE ATTACHED TO WALL OR OBSTRUCTION. IF PLANNED TO


6. CONSTRUCT 12" WIDE CONCRETE FENCE APRON PER THE DETAIL PROVIDED

ATTACH, CONTRACTOR TO PROVIDE METHOD OF ATTACHMENT FOR APPROVAL.



PROVIDE AN INSTALL GATE CLOSER AND 36"x36" MIN. CONCRETE PAD PER THE DETAIL 5 PROVIDED. EXACT PAD LOCATION SHALL BE ESTABLISHED FROM MANUFACTURER RECOMMENDED INSTALLATION DRAWINGS. CONCRETE PAD SHALL BE ELEVATED 6" ABOVE C2.1 SURROUNDING GRADE.

PROVIDE AN INSTALL PROTECTIVE PIPE BOLLARD PER THE DETAIL PROVIDED.

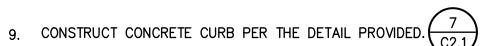

- 10. PLACE 3" AC PAVING OVER 12" CLASS II AB ON COMPACTED SUBGRADE. SEE SPECIFCIATIONS.
- 11. PAINT 6" WIDE WHITE STRIPE AS SHOWN.
- 12. PAINT 12" TALL WHITE LETTERS STATING "KEEP CLEAR" AS SHOWN.
- 13. CONSTRUCT CONCRETE MEDIAN WITH KEYPAD PEDESTAL AND BOLLARDS PER THE DETA
- 14. CONSTRUCT 6" THICK CONCRETE APRON PER THE DETAIL PROVIDED. APRON MAY BE POURED MONOLITHIC WITH CURB.



16. PAINT 4" WIDE WHITE CROSS HATCH STRIPING AT 36" ON CENTER.

- TRENCH AND INSTALL 1" CONDUIT WITH CONDUCTORS AS NEEDED TO SUPPLY ELECTRIC GATE OPENERS. REFER TO OPENER SPECIFICATIONS AND INSTALLATION INSTRUCTIONS FOR WIRE SIZE, BUT SHALL BE #10 MINIMUM. PATCH PATCH BACK ALL TRENCHES TO MATCH EXISTING PER SPECIFICATIONS.
- CONSTRUCT EXTERIOR RISER AND ENTER BUILDING IN ACCORDANCE WITH SPECIFICATION. PROVIDE ALL PATHWAY AND CONDUIT AND MIN. #10 CONDUCTORS TO CONNECT TO PANEL ECA WITHIN BUILDING A. OR PANEL EBBA AT CONTRACTOR'S OPTION. PROVIDE ALL PATCH BACK OF FINISHES AND PENETRATIONS. PROVIDE NEW 15A BREAKER PER

Sacramento **City Unified School District** 

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EL DORADO HILLS, CA 95762 | (916) 985-1870

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ONSULTANT:

**ANTHONY J TASSANO** 

**CK McClatchy** High School 2023 Fencing

3066 Freeport Boulevard Sacramento, CA 95818

# **DEMOLITION GENERAL NOTES**

- 1. IN THE EVENT THAT ANY UNUSUAL CONDITIONS NOT COVERED BY THE GEOTECHNICAL INVESTIGATION REPORT OR ARE ENCOUNTERED DURING GRADING OPERATIONS THE GEOTECHNICAL ENGINEER AND THE ENGINEER SHALL BE IMMEDIATELY NOTIFIED FOR
- DIRECTIONS.
  2. NO BURNING OR BLASTING SHALL BE PERMITTED.
- ADDITIONAL DEMOLITION INFORMATION MAY BE SHOWN ON THE GRADING, DRAINAGE, AND UTILITY PLANS, AND THOSE PLANS PREPARED BY OTHER DISCIPLINES FOR THIS PROJECT.
- 4. ALL DEMOLISHED ITEMS SHALL BE DISPOSED OF OFFSITE AT A SUITABLE, LEGAL, DUMP SITE OR OTHER FACILITY.
- 5. ALL DISPOSED OF MATERIALS SHALL BE RECYCLED IF POSSIBLE.
- 6. THE TYPES, LOCATIONS, SIZES AND/OR DEPTHS OF EXISTING UNDERGROUND UTILITIES AS SHOWN IN THESE PLANS WERE OBTAINED FROM SOURCES OF VARYING RELIABILITY. THE CONTRACTOR IS CAUTIONED THAT ONLY ACTUAL EXCAVATION WILL REVEAL THE TYPES, EXTENT, SIZES, LOCATIONS, AND DEPTHS OF SUCH UNDERGROUND UTILITIES. A REASONABLE EFFORT HAS BEEN MADE TO LOCATE AND DELINEATE ALL KNOWN UNDERGROUND UTILITIES. HOWEVER, WARREN CONSULTING ENGINEERS CAN ASSUME NO RESPONSIBILITY FOR THE COMPLETENESS OR ACCURACY OF ITS DELINEATION OF SUCH UNDERGROUND UTILITIES, NOR FOR THE EXISTENCE OF OTHER BURIED OBJECTS OR UTILITIES WHICH MAY BE ENCOUNTERED BUT WHICH ARE NOT SHOWN ON THESE DRAWINGS. THE CONTRACTOR OR ANY SUBCONTRACTOR FOR THIS CONTRACT SHALL NOTIFY THE DISTRICT TWO (2) WORKING DAYS IN ADVANCE OF PERFORMING ANY EXCAVATION WORK IN ORDER TO VERIFY TO THE GREATEST EXTENT POSSIBLE THE EXISTING UTILITY LINES, CONFLICTS AND PROPOSED UTILITY CONNECTION POINTS.
- THE SCHOOL DISTRICT SHALL HAVE SALVAGE RIGHTS TO ANY DEMOLISHED ITEMS SHOWN HEREON. THE CONTRACTOR SHALL GIVE THE DISTRICT NOTICE 7 DAYS PRIOR TO THE START OF DEMOLITION. THE DISTRICT SHALL MOVE ANY RETAINED ITEMS OUT OF THE CONTRACTORS WORK AREA, UNLESS ANOTHER ARRANGEMENT IS MADE WITH THE CONTRACTOR. ANY REMAINING ITEMS BECOME THE PROPERTY OF THE CONTRACTOR AND SHALL BE REMOVED FROM THE SITE. ANY ITEMS NOT SHOWN FOR REMOVAL SHALL REMAIN AND SHALL BE PROTECTED FROM DAMAGE DURING CONSTRUCTION TO A REASONABLE EXTEND.
- 8. EXISTING UTILITY STRUCTURES IN AREAS OF NEW PAVING SHALL BE REMOVED AND REINSTALLED AT NEW GRADE UNLESS SPECIFICALLY NOTED OTHERWISE.
- ITEMS OUTSIDE THE LIMITS OF DEMOLITION SHALL REMAIN AND BE PROTECTED FROM DAMAGE DURING CONSTRUCTION..
- 10. CONTRACTOR SHALL COMPLY WITH CHAPTER 33 OF THE 2019 CFC, "FIRE SAFETY DURING CONSTRUCTION AND DEMOLITION" AT ALL TIMES DURING CONSTRUCTION.


- 11. CONTRACTOR SHALL HIRE A UTILITY LOCATING COMPANY AND SHALL SCAN THE ENTIRE AREA WITHIN THE LIMITS OF NEW WORK. ALL UTILITIES LOCATED SHALL BE MARKED AND PROTECTED DURING THE LIMING OPERATIONS AS WELL AS ANY EXCAVATING TASKS. ANY LOCATED UTILITY DAMAGED WITHIN THE LIMITS OF WORK WILL BE THE RESPONSIBILITY OF THE CONTRACTOR TO REPAIR.
- 12. ALL DEMOLITION SHALL BE APPROPRIATELY SUPPORTED AND REINFORCED DURING REMOVAL TO PREVENT INJURY FROM FALLING, PROJECTILE, OR OTHERWISE MOVING DEBRIS OR OTHER DELETERIOUS MATERIAL. ONSITE SAFETY WITHIN THE LIMITS OF WORK IS THE CONTRACTORS SOLE RESPONSIBILITY.

# **Concrete Sawcut Note:**

SAWCUTS AND SUBSEQUENT PATCH BACK OF CONCRETE WALKS, SHALL BE TO THE EXISTING CONCRETE JOINT BEYOND NEAREST THE LOCATION OF DEMOLITION AS SHOWN. A REASONABLE EFFORT HAS BEEN MADE TO LOCATE, SHOW AND COORDINATE WITH EXISTING JOINTS, HOWEVER IF FIELD CONDITIONS ARE OTHERWISE, IT IS UNDERSTOOD TO REMOVE AND PATCH BACK TO THE NEAREST JOINTS BEYOND DEMOLITION.

# **Dust Control:**

CONTRACTOR SHALL PROVIDE DUST CONTROL MEASURES AT ALL TIMES WHEN A SITE CONSTRUCTION ACTIVITY MAY GENERATE AIRBORNE DUST, INCLUDING BUT NOT LIMITED TO, APPLICATION OF WATER, HAUL TRUCK COVERS, STOCKPILE COVERS, STRAW/MULCH, APPROVED SOIL STABILIZATION CHEMICALS/TACKIFIERS, RETAINED VEGITATION, HYDROSEED, ETC. REFER TO CONTRACTORS SWPPP, PROJECT SPECIFICATION SECTION 31 10 00, 1.06.

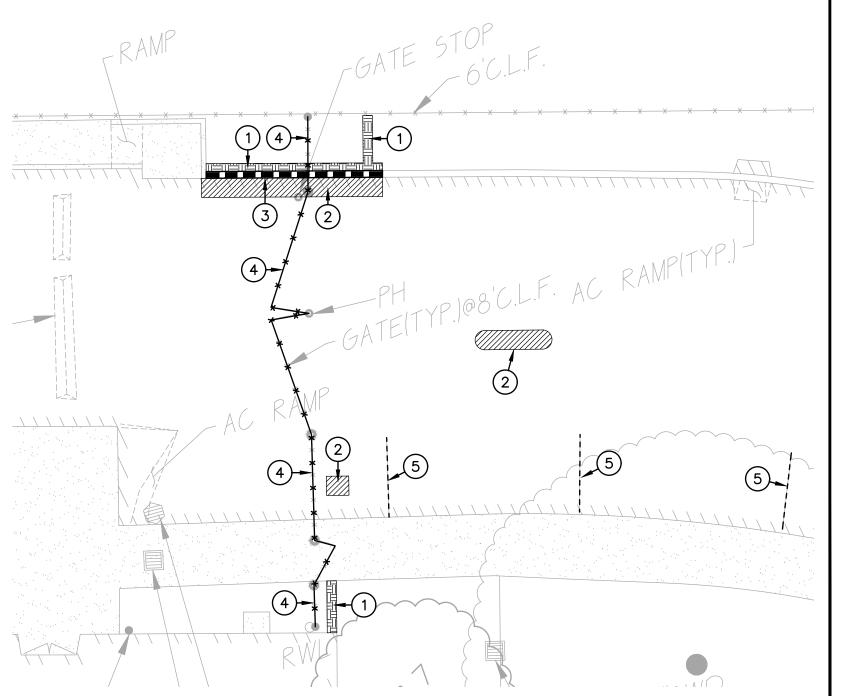

# **DEMOLITION NOTES**

NOTE: NOT ALL NOTES MAY BE USED ON THIS SHEET


AND/OR LEGEND (#) DEMOLITION NOTES

REMOVE ALL PLANTS, SHRUBS, EXISTING VEGETATION, AND IRRIGATION SYSTEMS. REFER TO EARTHWORK SPECIFICATIONS FOR ADDITIONAL SITE


CLEARING REQUIREMENTS. SEE GENERAL IRRIGATION NOTE, THIS SHEET.



REMOVE EXISTING ASPHALT PAVING AND BASE TO ALLOW FOR NEW WORK. AC MAY BE GRINDED AND BLENDED WITH EXISTING BASE, EXCAVATED AND USED AS FILL, REFER TO EARTHWORK SPECIFICATIONS.

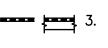

3. REMOVE EXISTING CONCRETE CURB, MOWBAND, APRON OR GUTTER AS REMOVE EXISTING CHAIN LINK FENCING AND GATES AS SHOWN. REMOVE

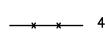

POST TO INCLUDE CONCRETE FOOTINGS. REPAIR FINISHED SURFACES.

5. PAINT EXISTING STRIPING BLACK WTH MIN. 2 COATS COMMERCIAL GRADE BLACK TRAFFIC STRIPING PAINT.

**REVISIONS** DESCRIPTION ADDENDUM NO.1

DRAWN: SCALE: AS NOTED CHECKED: PROJECT NO. 23-052 DESIGNED: DATE: SMN/AT

4/24/2023

ISSUANCE:

SHEET TITLE: **FENCING** CONSTRUCTION

**PLAN** 

SHEET NO.

**DEMO PLAN** 


SCALE 1" = 10'-0"

# FERN BACON MIDDLE SCHOOL 2023 FENCING

4140 Cuny Avenue Sacramento, CA 95823






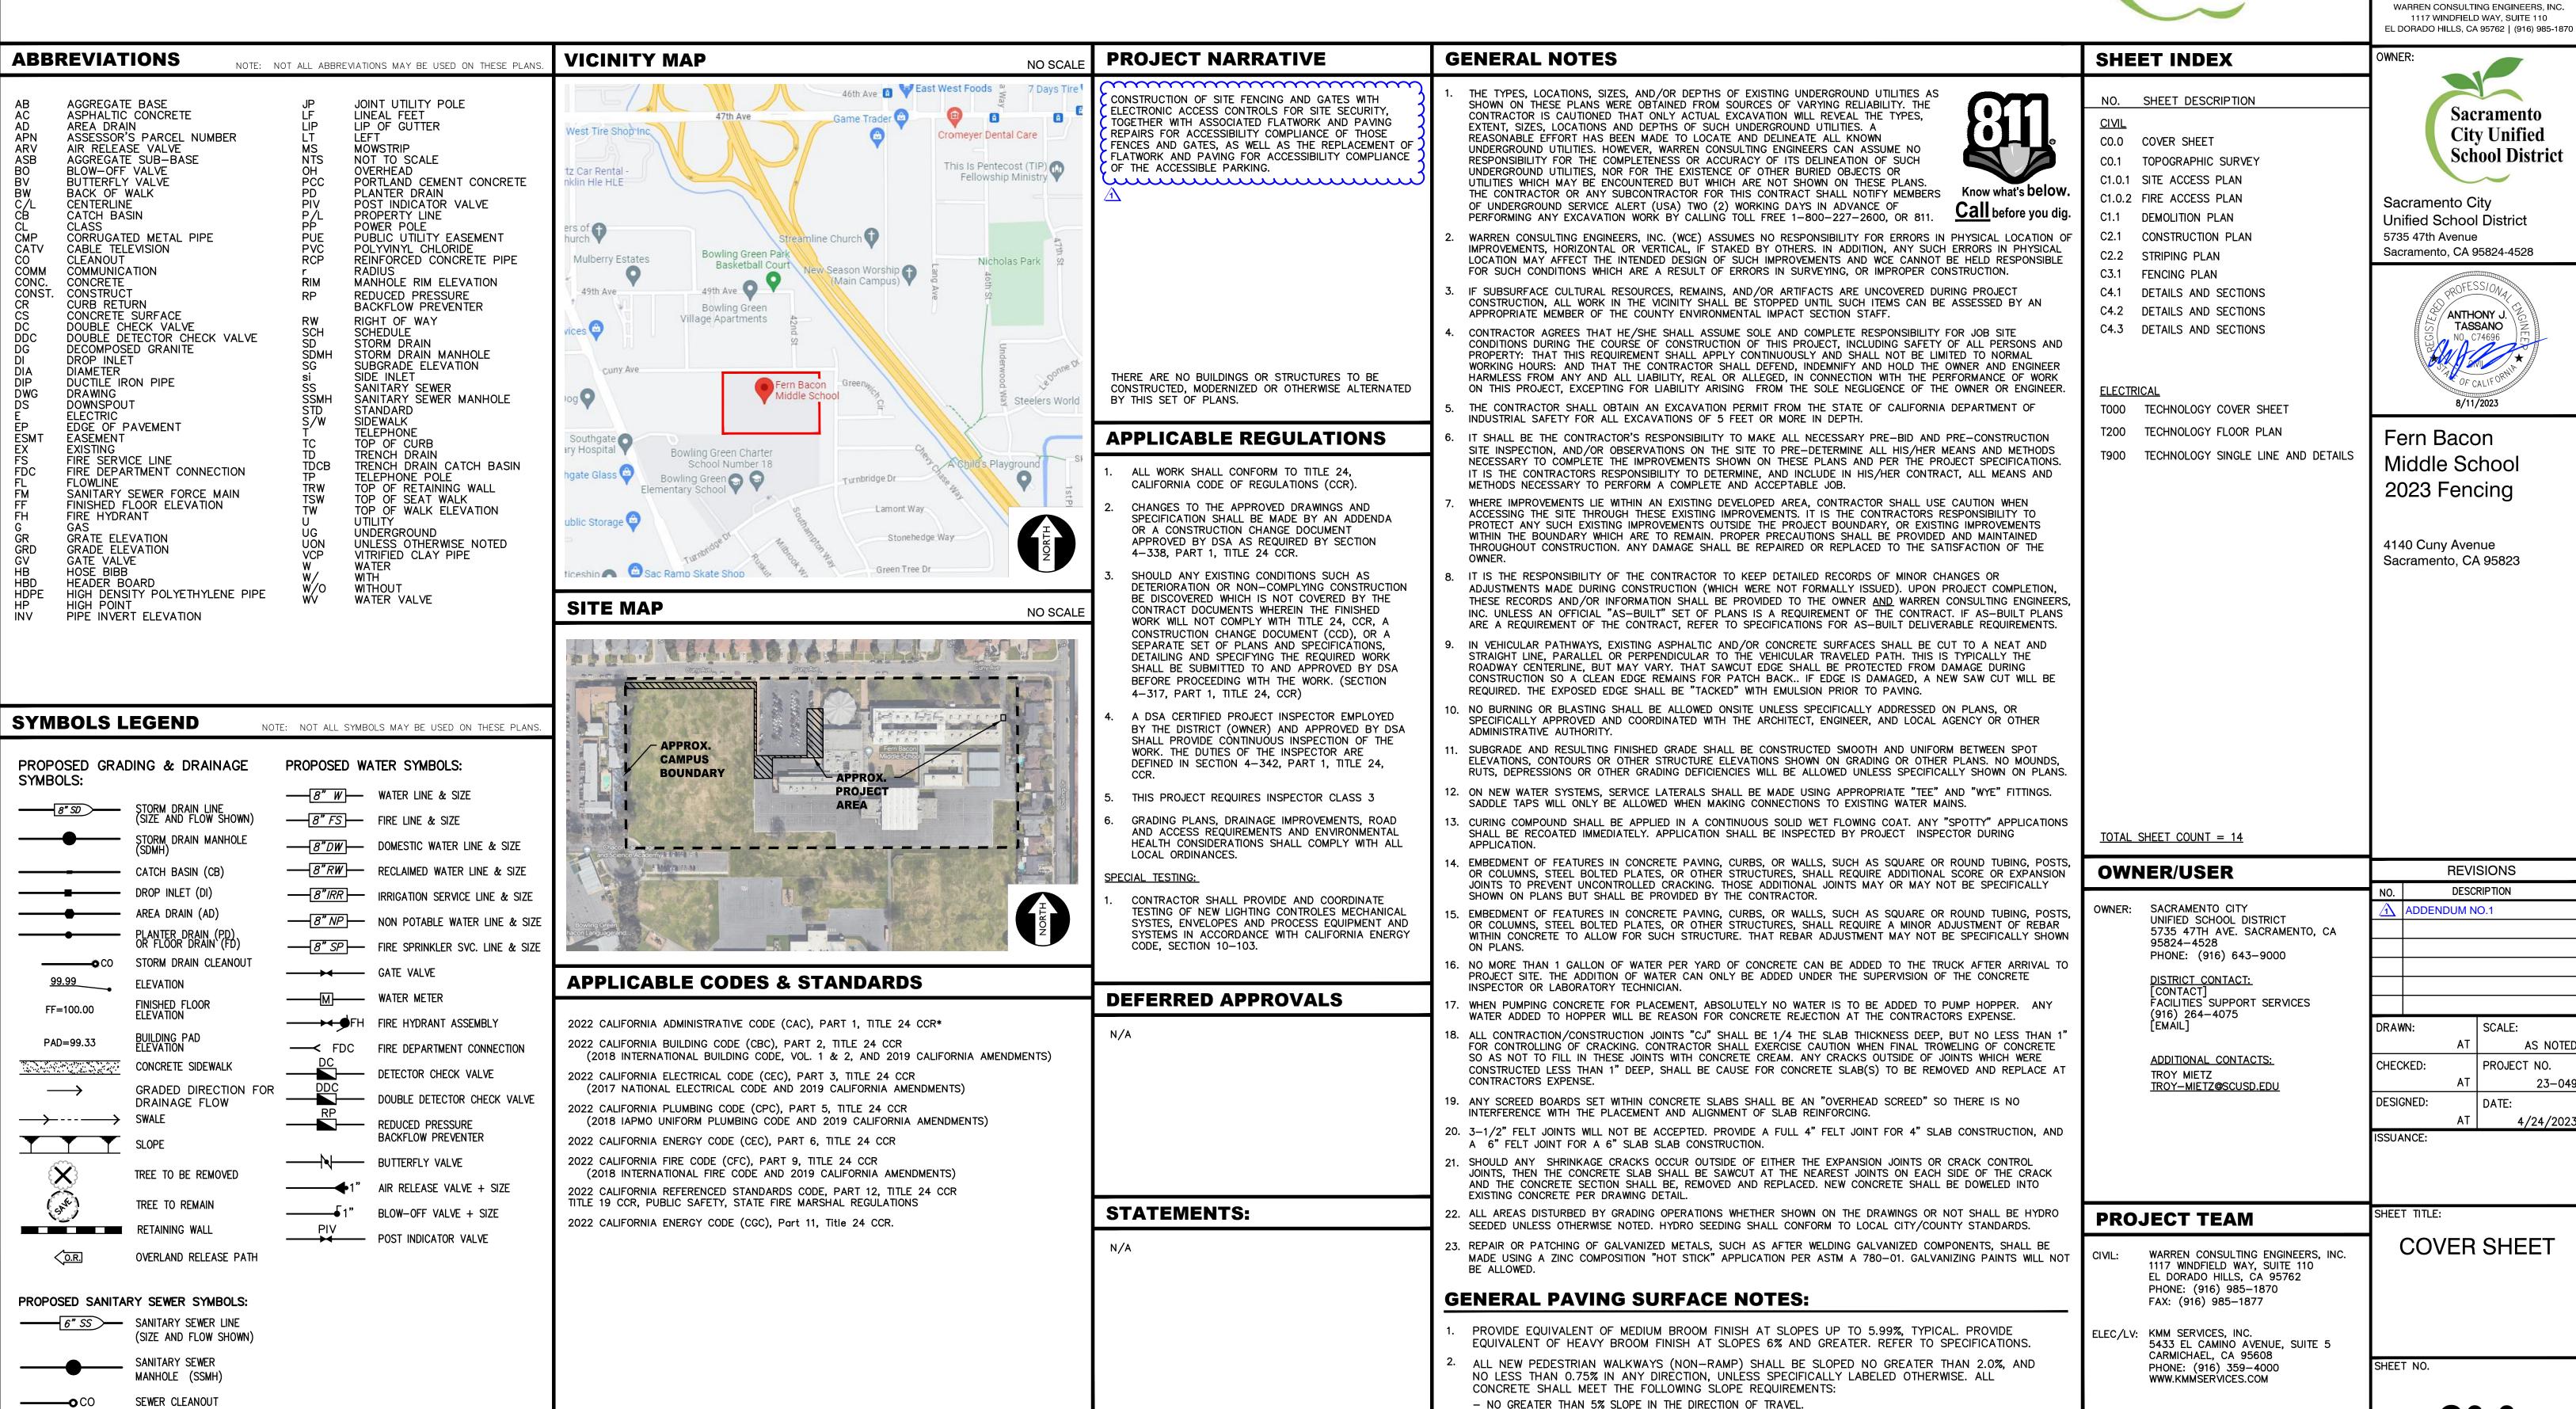

NO GREATER THAN 2% SLOPE CROSSING THE DIRECTION OF TRAVEL

NO GREATER THAN 2% SLOPE IN ANY DIRECTION IN COURTYARD OR PLAZA AREAS.

FLUSHER BRANCH

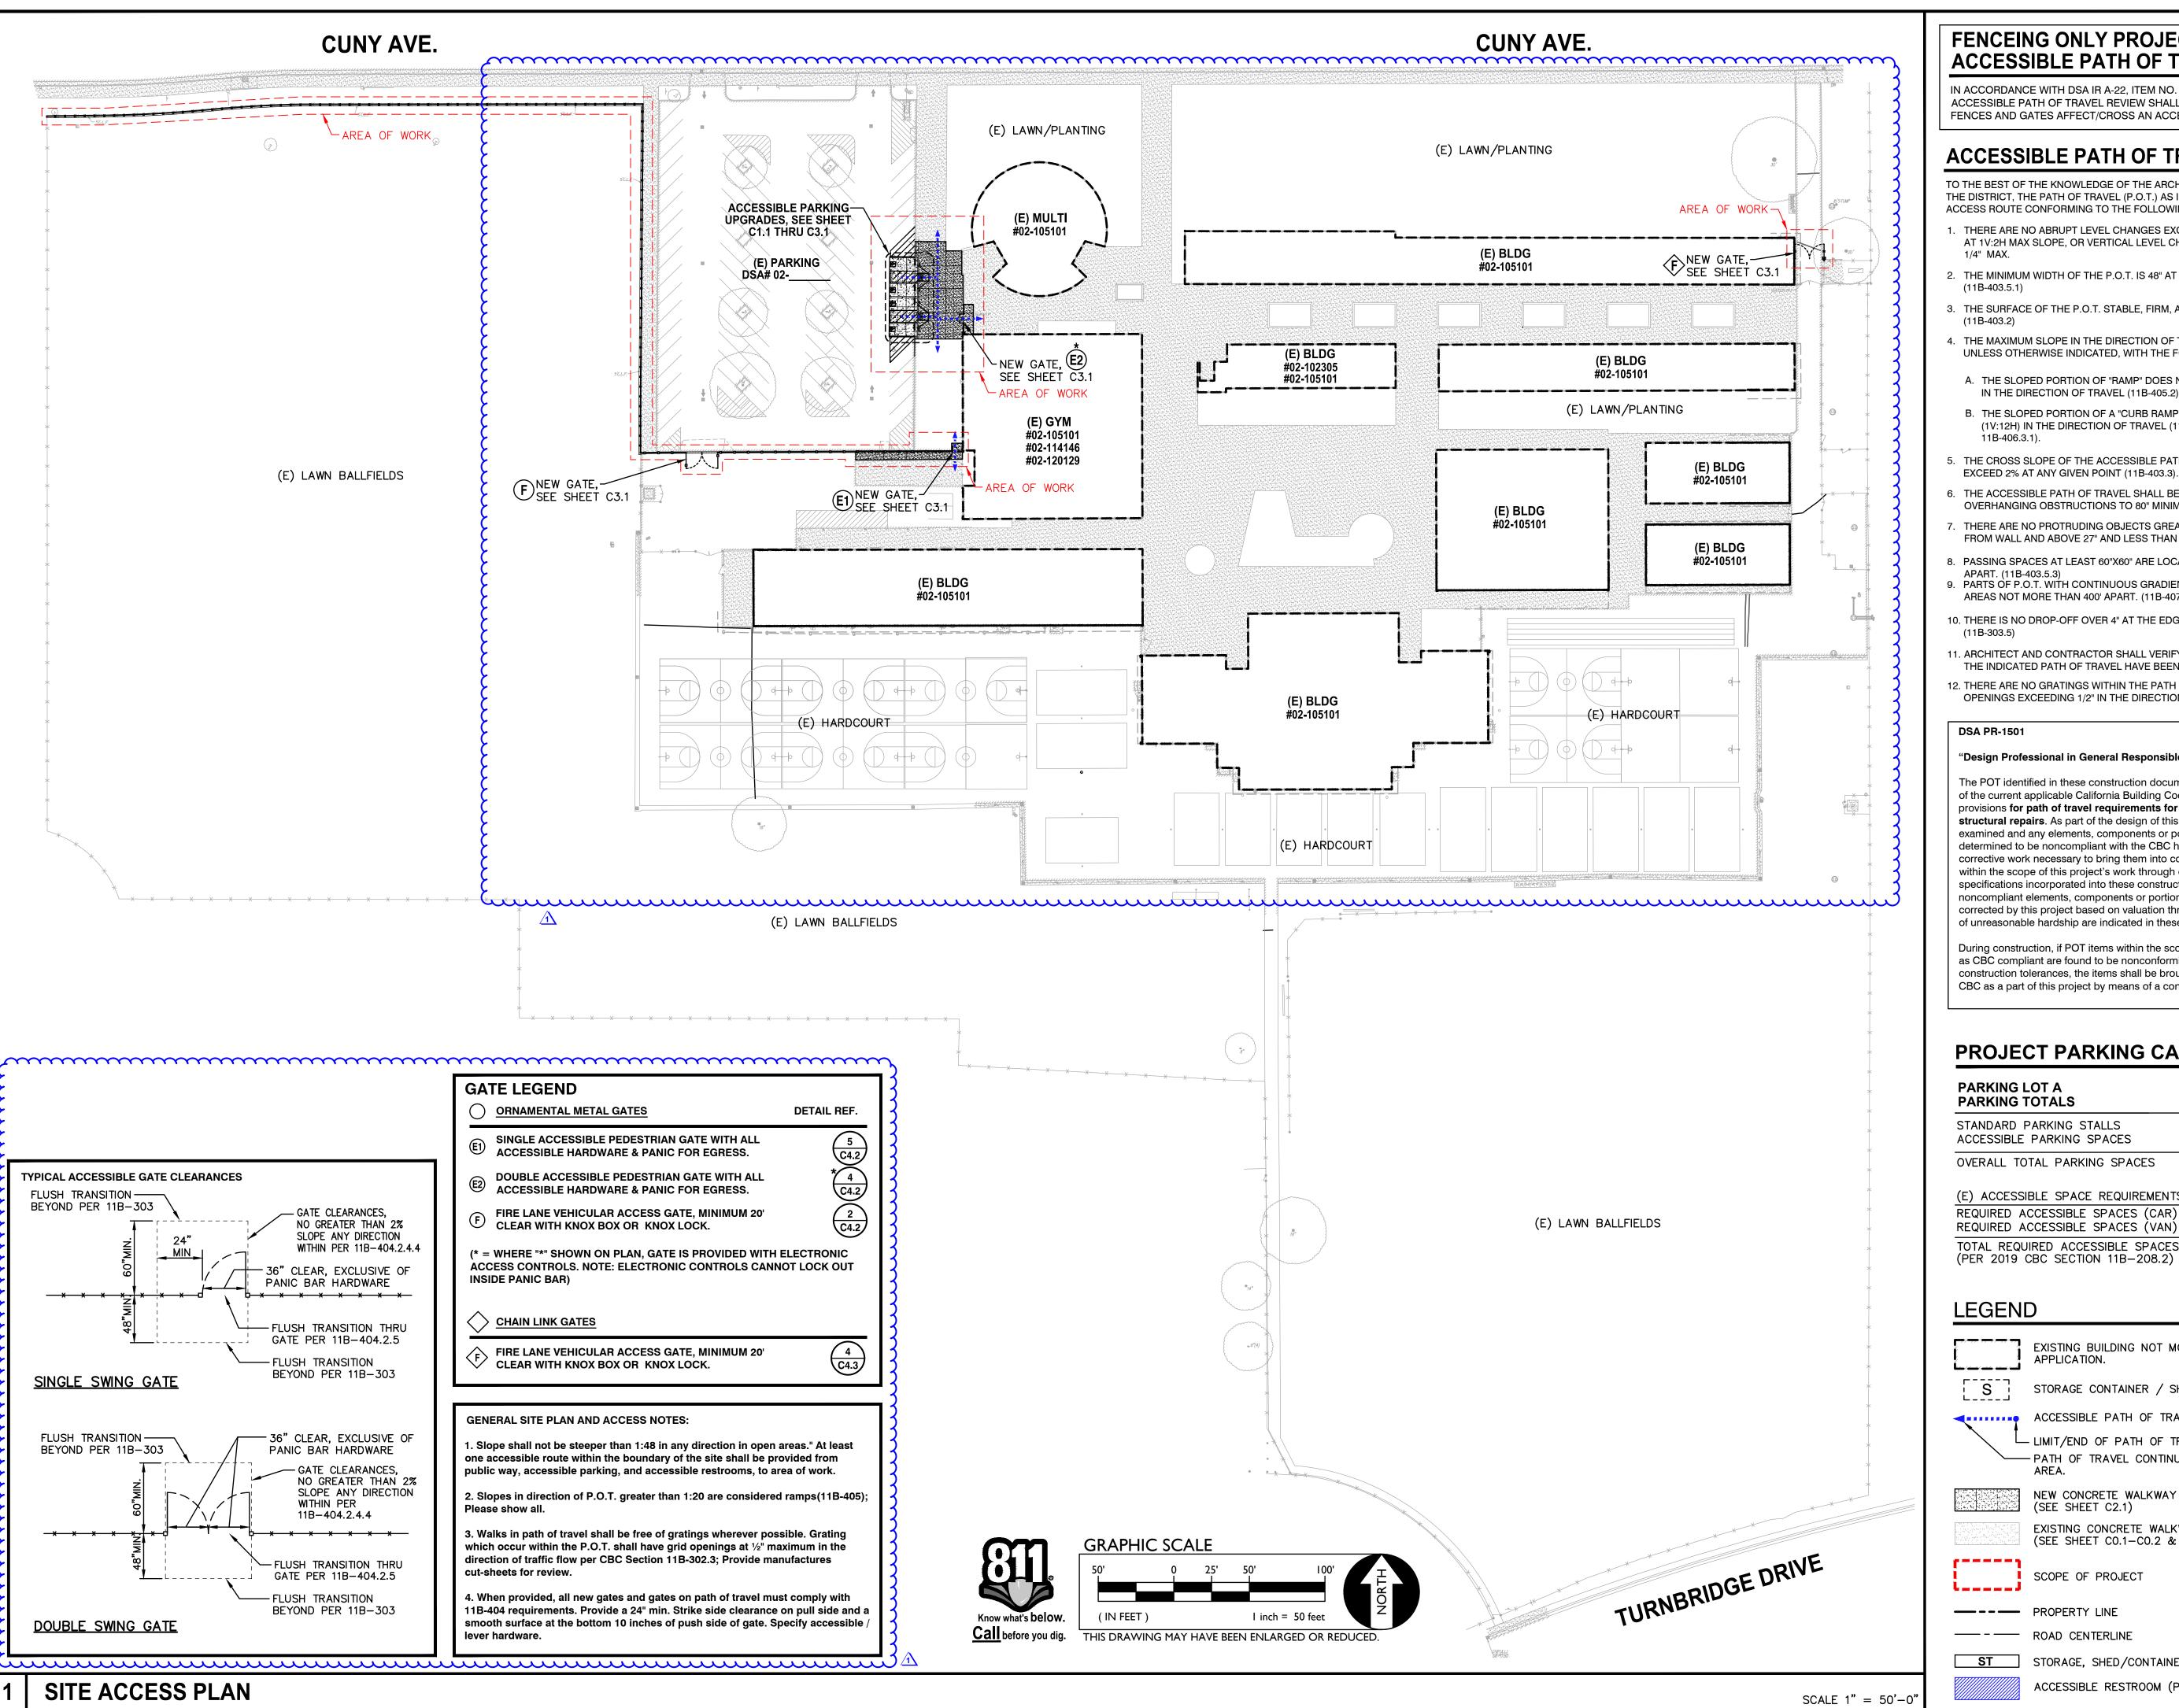

# **FENCEING ONLY PROJECT ACCESSIBLE PATH OF TRAVEL**

IN ACCORDANCE WITH DSA IR A-22, ITEM NO. 12, KEYNOTE 4, THE ACCESSIBLE PATH OF TRAVEL REVIEW SHALL BE LIMITED TO WHERE NEW FENCES AND GATES AFFECT/CROSS AN ACCESSIBLE PATH OF TRAVEL.

# **ACCESSIBLE PATH OF TRAVEL (P.O.T.)**

TO THE BEST OF THE KNOWLEDGE OF THE ARCHITECT AND/OR ENGINEER, OR THE DISTRICT, THE PATH OF TRAVEL (P.O.T.) AS INDICATED, IS A BARRIER FREE ACCESS ROUTE CONFORMING TO THE FOLLOWING:

- THERE ARE NO ABRUPT LEVEL CHANGES EXCEEDING 1/2" IF BEVELED AT 1V:2H MAX SLOPE, OR VERTICAL LEVEL CHANGES NOT EXCEEDING
- THE MINIMUM WIDTH OF THE P.O.T. IS 48" AT ANY GIVEN POINT. (11B-403.5.1)
- . THE SURFACE OF THE P.O.T. STABLE, FIRM, AND SLIP RESISTANT.
- THE MAXIMUM SLOPE IN THE DIRECTION OF TRAVEL IS 5.0% (11B-403.3), UNLESS OTHERWISE INDICATED, WITH THE FOLLOWING EXCEPTIONS:
- A. THE SLOPED PORTION OF "RAMP" DOES NOT EXCEED 8.33% (1V:12H) IN THE DIRECTION OF TRAVEL (11B-405.2).
- B. THE SLOPED PORTION OF A "CURB RAMP" DOES NOT EXCEED 8.33% (1V:12H) IN THE DIRECTION OF TRAVEL (11B-406.2.1 AND 11B-406.3.1).
- THE CROSS SLOPE OF THE ACCESSIBLE PATH OF TRAVEL DOES NOT EXCEED 2% AT ANY GIVEN POINT (11B-403.3).
- THE ACCESSIBLE PATH OF TRAVEL SHALL BE MAINTAINED FREE OF OVERHANGING OBSTRUCTIONS TO 80" MINIMUM (11B-307).
- THERE ARE NO PROTRUDING OBJECTS GREATER THAN 4" PROJECTION FROM WALL AND ABOVE 27" AND LESS THAN 80" (11B-307).
- . PASSING SPACES AT LEAST 60"X60" ARE LOCATED NOT MORE THAT 200' APART. (11B-403.5.3)
- PARTS OF P.O.T. WITH CONTINUOUS GRADIENTS HAVE 60" LEVEL AREAS NOT MORE THAN 400' APART. (11B-407.3)
- 10. THERE IS NO DROP-OFF OVER 4" AT THE EDGE OF WALK OR LANDING. (11B-303.5)
- 11. ARCHITECT AND CONTRACTOR SHALL VERIFY THAT ALL BARRIERS ON THE INDICATED PATH OF TRAVEL HAVE BEEN REMOVED.
- 12. THERE ARE NO GRATINGS WITHIN THE PATH OF TRAVEL WITH GRATE OPENINGS EXCEEDING 1/2" IN THE DIRECTION OF TRAVEL. (11B-302.3)

#### **DSA PR-1501**

#### "Design Professional in General Responsible Charge Statement:


The POT identified in these construction documents meets the requirements of the current applicable California Building Code (CBC) accessibility provisions for path of travel requirements for alterations, additions and **structural repairs**. As part of the design of this project, the POT was examined and any elements, components or portions of the POT that were determined to be noncompliant with the CBC have been identified and the corrective work necessary to bring them into compliance has been included within the scope of this project's work through details, drawings and specifications incorporated into these construction documents. Any noncompliant elements, components or portions of the POT that will not be corrected by this project based on valuation threshold limitations or a finding of unreasonable hardship are indicated in these construction documents.

During construction, if POT items within the scope of the project represented as CBC compliant are found to be nonconforming beyond reasonable construction tolerances, the items shall be brought into compliance with the CBC as a part of this project by means of a construction change document."

# PROJECT PARKING CALCULATION

| PARKING LOT A  |          |          |
|--|----------|----------|
| PARKING TOTALS                                       | EXISTING | PROPOSED |
| STANDARD PARKING STALLS<br>ACCESSIBLE PARKING SPACES | 83<br>4  | 83<br>4  |
| OVERALL TOTAL PARKING SPACES                         | 87       | 87       |
| (E) ACCESSIBLE SPACE REQUIREMENTS                    | REQUIRED | PROVIDED |
| REQUIRED ACCESSIBLE SPACES (CAR)                     | 3        | 3        |
| REQUIRED ACCESSIBLE SPACES (VAN)                     | 1        | 1        |
| TOTAL REQUIRED ACCESSIBLE SPACES                     | 4        | 4        |

# **LEGEND**

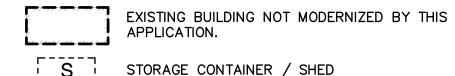

STORAGE CONTAINER / SHED

ACCESSIBLE PATH OF TRAVEL (P.O.T.) — LIMIT/END OF PATH OF TRAVEL THIS PROJECT. PATH OF TRAVEL CONTINUATION INTO ACCESSIBLE

ACCESSIBLE RESTROOM (PROJECT COMPLIANCE)

NEW CONCRETE WALKWAY (SEE SHEET C2.1)

EXISTING CONCRETE WALKWAY (SEE SHEET CO.1-CO.2 & C2.1)

SCOPE OF PROJECT

— PROPERTY LINE

ST STORAGE, SHED/CONTAINER


C1.0.1







Sacramento City **Unified School District** 5735 47th Avenue Sacramento, CA 95824-4528

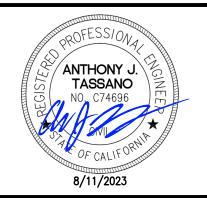

Fern Bacon Middle School 2023 Fencing


4140 Cuny Avenue Sacramento, CA 95823

| REVISIONS |               |  |  |  |
|-----------|---------------|--|--|--|
| NO.       | DESCRIPTION   |  |  |  |
| 1         | ADDENDUM NO.1 |  |  |  |
|           |               |  |  |  |
|           |               |  |  |  |

| RAWN:    |    | SCALE:      |
|----------|----|-------------|
|          | ΑT | AS NOTED    |
| HECKED:  |    | PROJECT NO. |
|          | ΑT | 23-049      |
| ESIGNED: |    | DATE:       |
|          | ΑT | 4/24/2023   |
| SHANCE   |    |             |

SHEET TITLE:

SITE ACCESS **PLAN** 

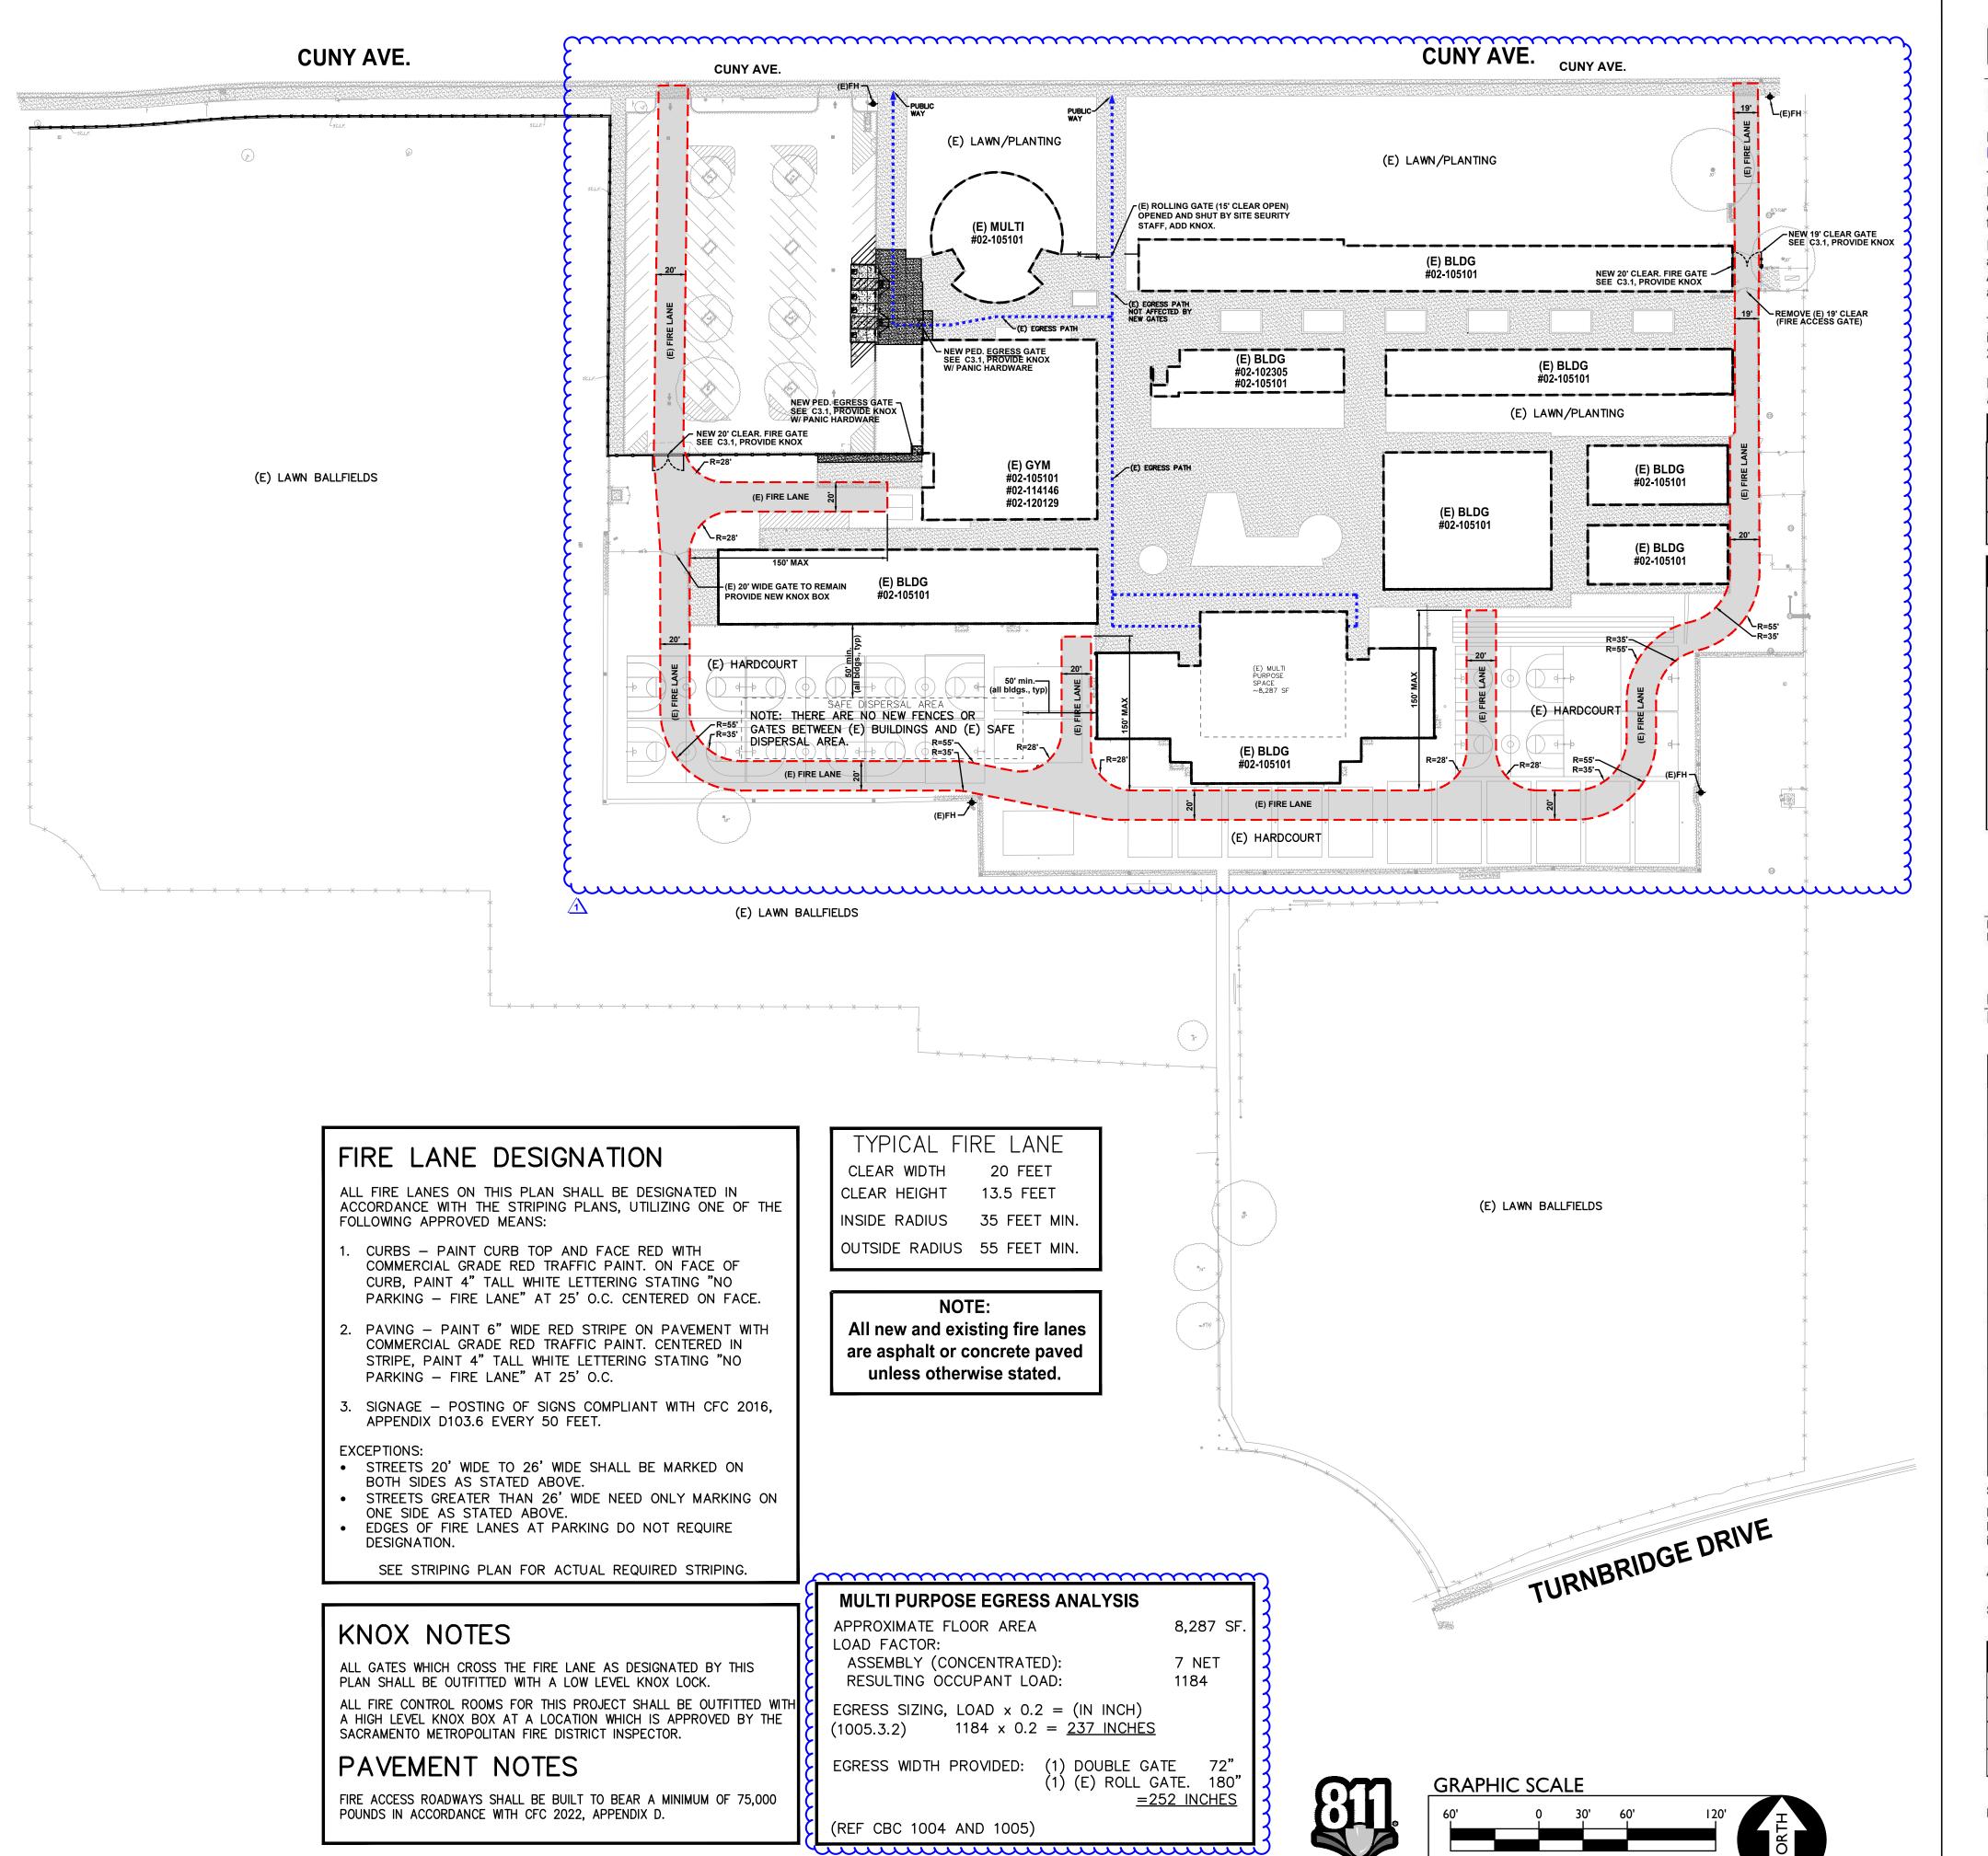

**ADSA** 

PROJECT INFORMATION

81

TIONIC CLIDANITTAL

# FIRE & LIFE SAFETY SITE CONDITIONS SUBMITTAL


Division of the State Architect (DSA) documents referenced within this publication are available on the DSA Forms or DSA Publications webpages.

To facilitate the Division of the State Architect's (DSA) fire and life safety plan review of project site conditions, DSA requires the design professional to provide the following information at time of project submittal for projects consisting of construction of a new campus, construction of new building(s), additions to existing buildings, and

for site alternate design means for fire department emergency vehicle access, and fire suppression water supply. Information associated with compliance items 1 through 3 below is to be provided for all project types indicated above. Information associated with items 4 through 7 is to be completed when an alternate means is utilized. Acknowledgement by the school district and signature from the Local Fire Authority (LFA) is only required when an alternate design means is being requested.

The Project Information and Fire & Life Safety Information sections are to be completed for all projects and imaged onto the fire access site plan. When an alternate design/means is proposed, all sections on pages 1 and 2 are to be completed and imaged on the fire access site plan.

For additional information refer to the instructions at the end of this form and DSA Policy *PL 09-01: Fire Flow for Buildings*.

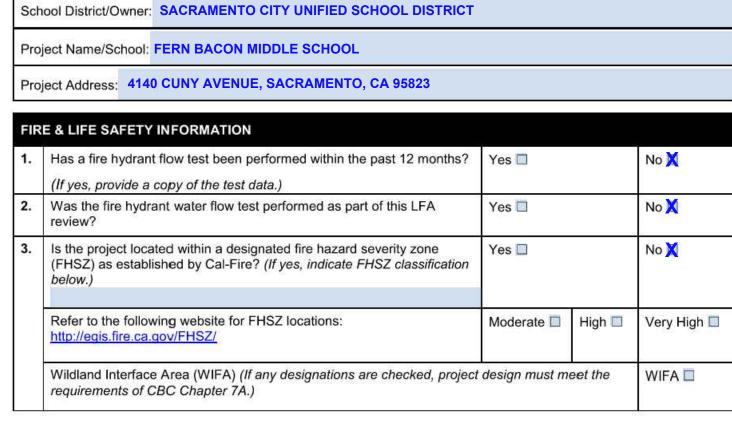

DGS DSA 810 (revised 12/29/20)
DIVISION OF THE STATE ARCHITECT DEPARTMENT OF GENERAL SERVICES STATE OF CALIFORNIA

# DSA 810

FIRE & LIFE SAFETY SITE CONDITIONS SUBMITTAL

| COI | IDITION MEANS AND METHODS RESOLUTION   | ALTE | RNATE | ACCEPT | =  |
|-----|--|------|-------|--------|----|
|     |  | Yes  | No    | N/A    | Ī  |
| 4.  | Emergency vehicle access roadways do not meet CFC requirements.  |      |       | X      |    |
| 4a. | Acceptable Alternate: Emergency vehicle and personnel access as proposed by the project architect is acceptable for providing fire suppression and protection of life and property.                          |      |       |        |    |
| 5.  | Fire Hydrants: Number and spacing does not meet CFC requirements.  |      |       | X      | 2  |
| 5a. | Acceptable Alternate: Number of fire hydrants and spacing as proposed by the project architect is acceptable for fire suppression and protection of life and property.                                       |      |       |        |    |
| 6.  | Fire Hydrants: Water flow and pressure are less than CFC minimum.  | 8    |       | X      |    |
| 6a. | Acceptable Alternate: The available flow and pressure is acceptable for providing fire suppression and protection of life and property.  |      |       |        |    |
| 7.  | Location of fire department connection(s) serving fire sprinkler systems or standpipe systems does not meet CFC requirements.  |      |       | X      |    |
| 7a. | Acceptable Alternate: The location of fire department connection serving the fire sprinkler system and/or standpipe system is acceptable for providing fire suppression and protection of life and property. |      |       |        | A. |

# School District Acceptance of Acceptable Design Alternates

By signing this form, the school district acknowledges and accepts the proposed design as an alternative to California Building Code (CBC) and California Fire Code (CFC) minimum requirements, as indicated by one or more of the conditions indicated at items 4a, 5a, 6a or 7a, for providing fire and life safety protection of life and property.

Accepted by: N/A - NO VARIANCE PROPOSED

Title:

Date:

| ing Tunson                  |             |                |
|-----------------------------|-------------|----------------|
| ing runson                  |             |                |
| pecialist                   | Work Phone: | (916) 808-1358 |
| on@sfd.cityofsacramento.org |             |                |
|                             |             |                |

DGS DSA 810 (revised 12/29/20)

DIVISION OF THE STATE ARCHITECT

DEPARTMENT OF GENERAL SERVICES


STATE OF CALIFORNIA

WARREN CONSULTING ENGINEERS, INC.
1117 WINDFIELD WAY, SUITE 110
EL DORADO HILLS, CA 95762 | (916) 985-1870

OWNER:



Sacramento City Unified School District 5735 47th Avenue Sacramento, CA 95824-4528

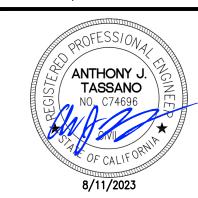

Fern Bacon Middle School 2023 Fencing

4140 Cuny Avenue Sacramento, CA 95823

REVISIONS

NO. DESCRIPTION

ADDENDUM NO.1

DRAWN:
AT
AS NOTED

CHECKED:
PROJECT NO.
AT
23-049

DESIGNED:
DATE:
AT
4/24/2023

ISSUANCE:

SHEET TITLE:


FIRE ACCESS PLAN

SHEET NO.

C1.0.2

Know what's below.


Call before you dig. THIS DRAWING MAY HAVE BEEN ENLARGED OR REDUCED.

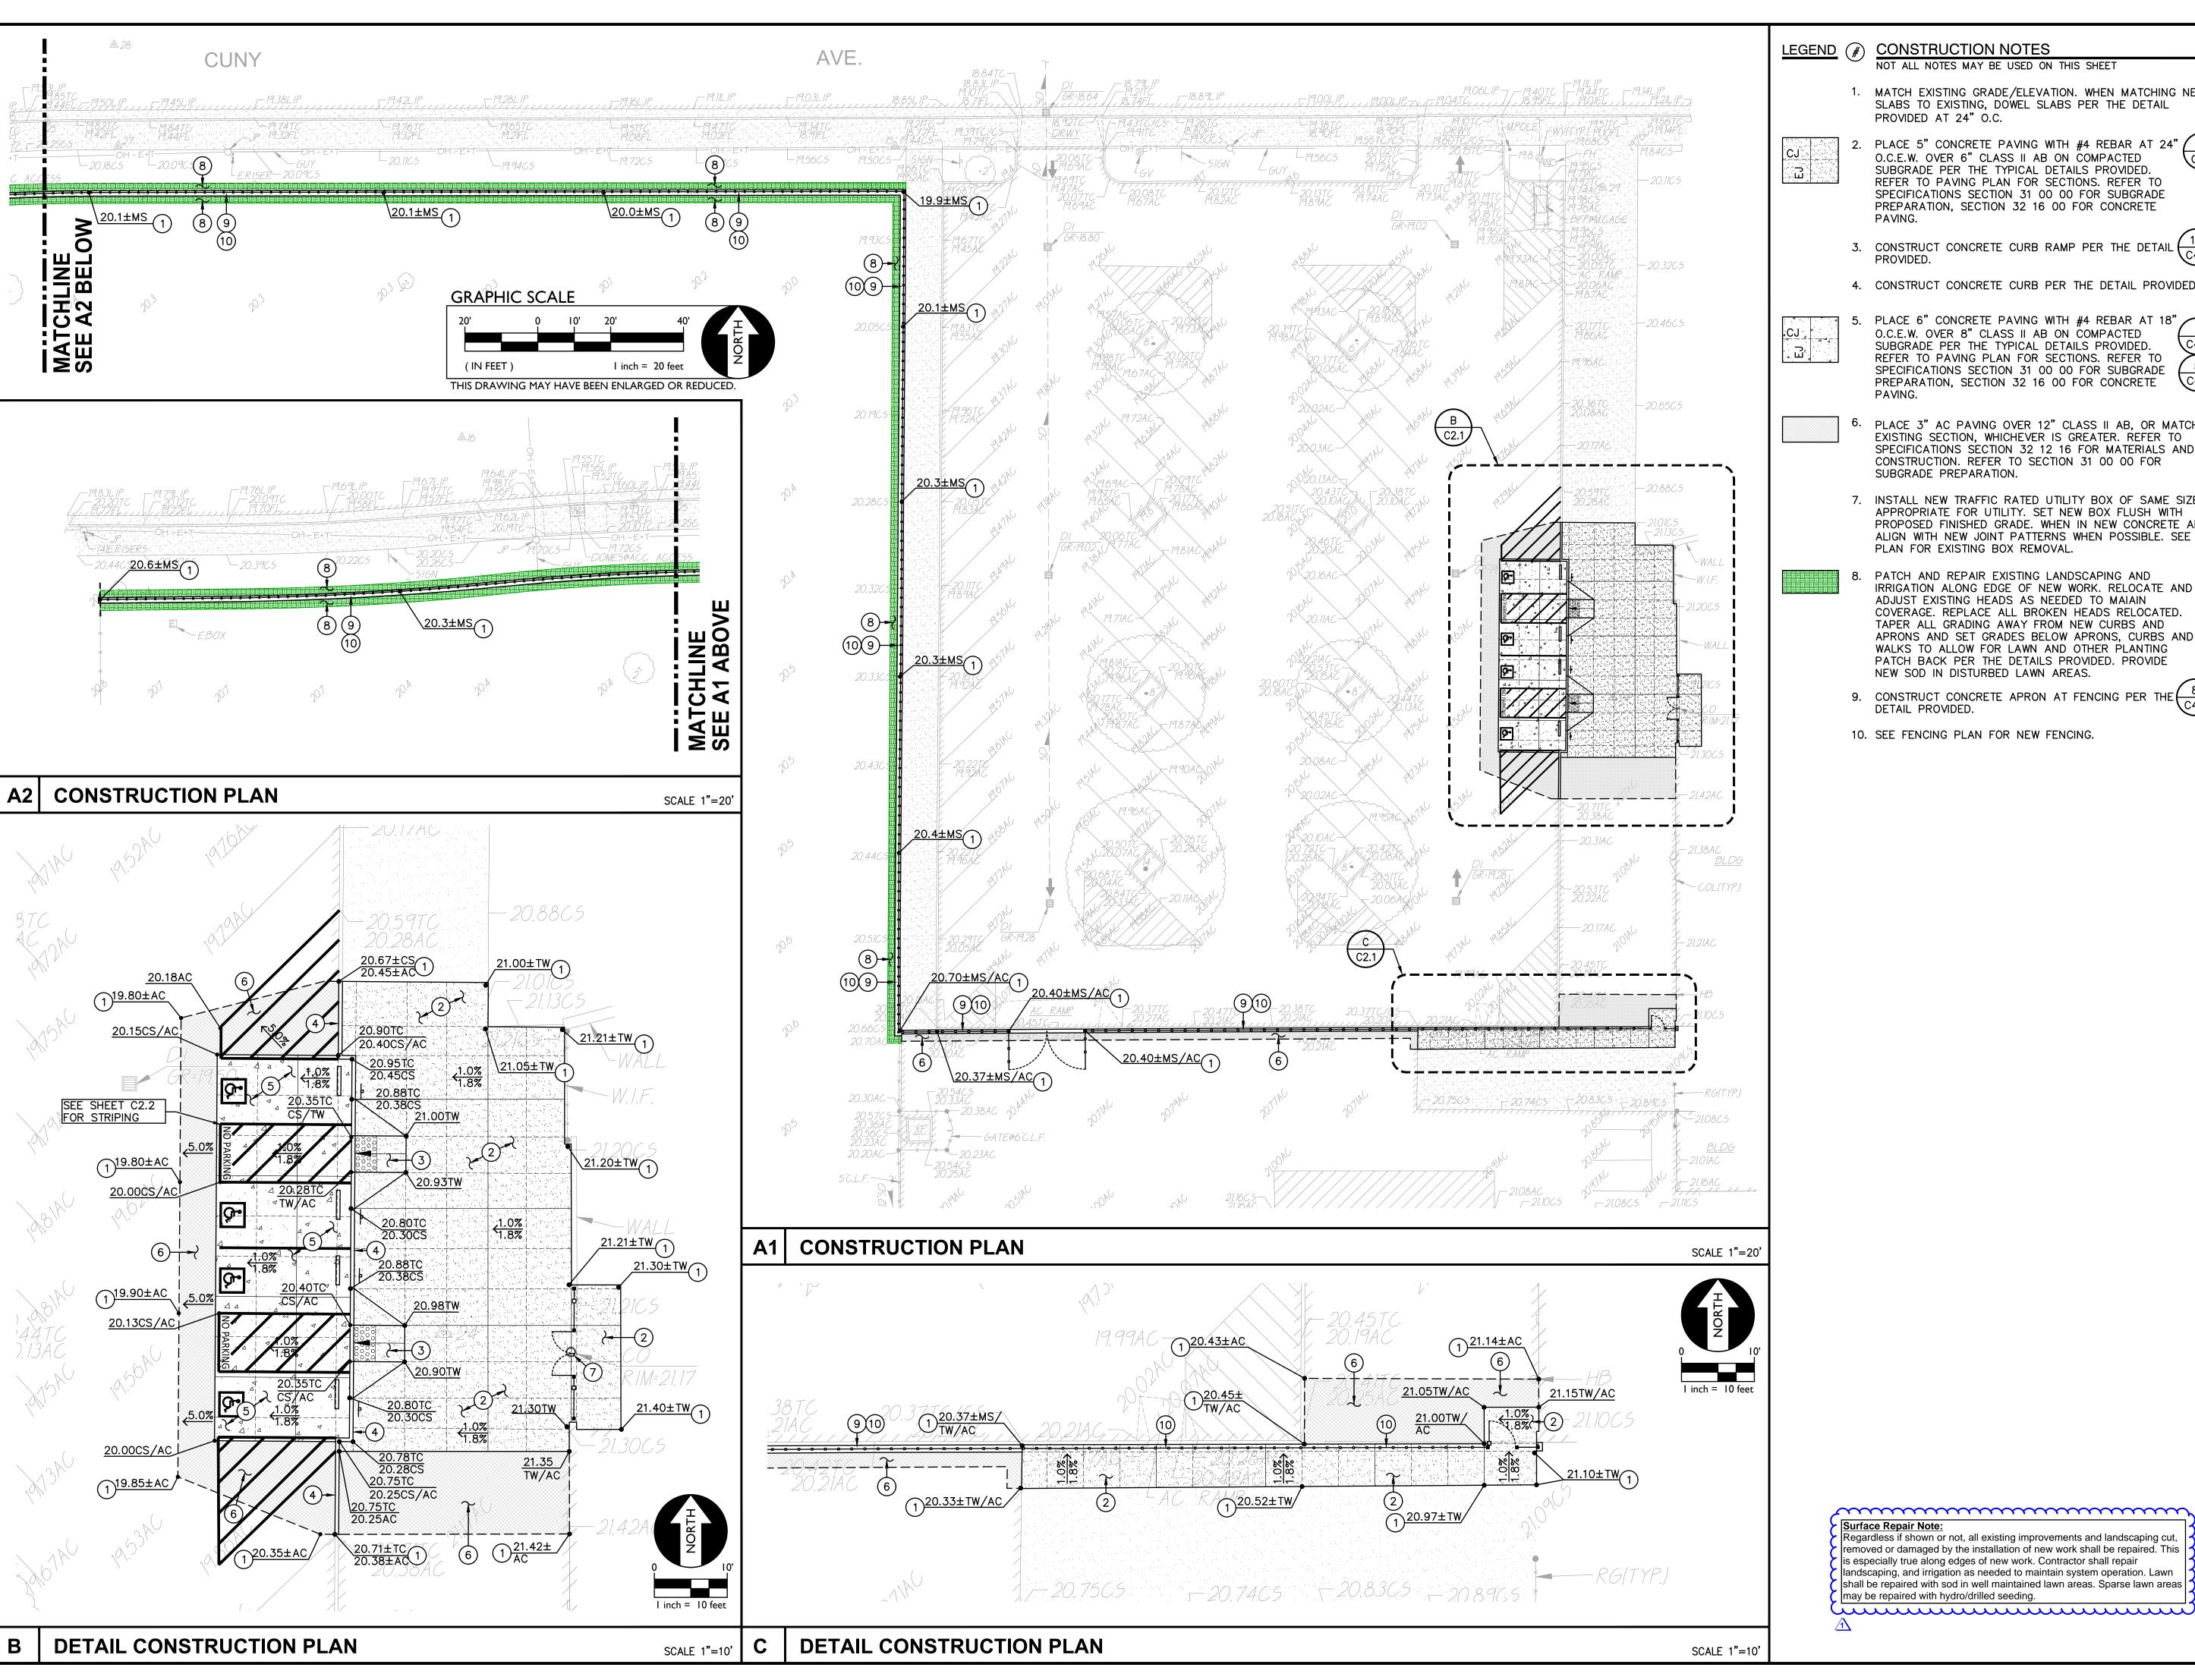


CONSTRUCTION NOTES

NOT ALL NOTES MAY BE USED ON THIS SHEET

MATCH EXISTING GRADE/ELEVATION. WHEN MATCHING NEW  $\begin{pmatrix} 1 \\ C4.1 \end{pmatrix}$ PROVIDED AT 24" O.C.

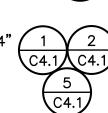


PLACE 5" CONCRETE PAVING WITH #4 REBAR AT 24" / 1 O.C.E.W. OVER 6" CLASS II AB ON COMPACTED SUBGRADE PER THE TYPICAL DETAILS PROVIDED.
REFER TO PAVING PLAN FOR SECTIONS. REFER TO SPECIFICATIONS SECTION 31 00 00 FOR SUBGRADE PREPARATION, SECTION 32 16 00 FOR CONCRETE PAVING.

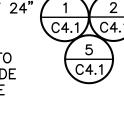



3. CONSTRUCT CONCRETE CURB RAMP PER THE DETAIL  $\left(\frac{10}{C4.1}\right)$ 



4. CONSTRUCT CONCRETE CURB PER THE DETAIL PROVIDED. (12)

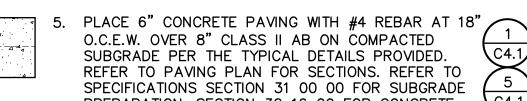

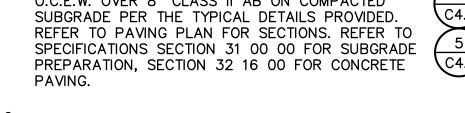

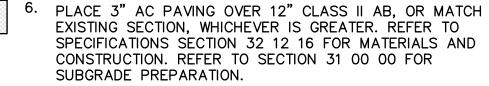

7. INSTALL NEW TRAFFIC RATED UTILITY BOX OF SAME SIZE AND APPROPRIATE FOR UTILITY. SET NEW BOX FLUSH WITH PROPOSED FINISHED GRADE. WHEN IN NEW CONCRETE AREAS, ALIGN WITH NEW JOINT PATTERNS WHEN POSSIBLE. SEE DEMO PLAN FOR EXISTING BOX REMOVAL.

PATCH AND REPAIR EXISTING LANDSCAPING AND ADJUST EXISTING HEADS AS NEEDED TO MAIAIN COVERAGE. REPLACE ALL BROKEN HEADS RELOCATED. TAPER ALL GRADING AWAY FROM NEW CURBS AND APRONS AND SET GRADES BELOW APRONS, CURBS AND WALKS TO ALLOW FOR LAWN AND OTHER PLANTING PATCH BACK PER THE DETAILS PROVIDED. PROVIDE NEW SOD IN DISTURBED LAWN AREAS.




10. SEE FENCING PLAN FOR NEW FENCING.



OWNER:



Sacramento City **Unified School District** 5735 47th Avenue Sacramento, CA 95824-4528

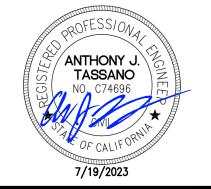

Fern Bacon Middle School 2023 Fencing

4140 Cuny Avenue Sacramento, CA 95823

**REVISIONS** DESCRIPTION ADDENDUM NO.1

DRAWN: SCALE: AS NOTE PROJECT NO. CHECKED: 23-049 DESIGNED: DATE: 4/24/2023


ISSUANCE:


SHEET TITLE:

CONSTRUCTION PLAN

SHEET NO.

**C2.1** 

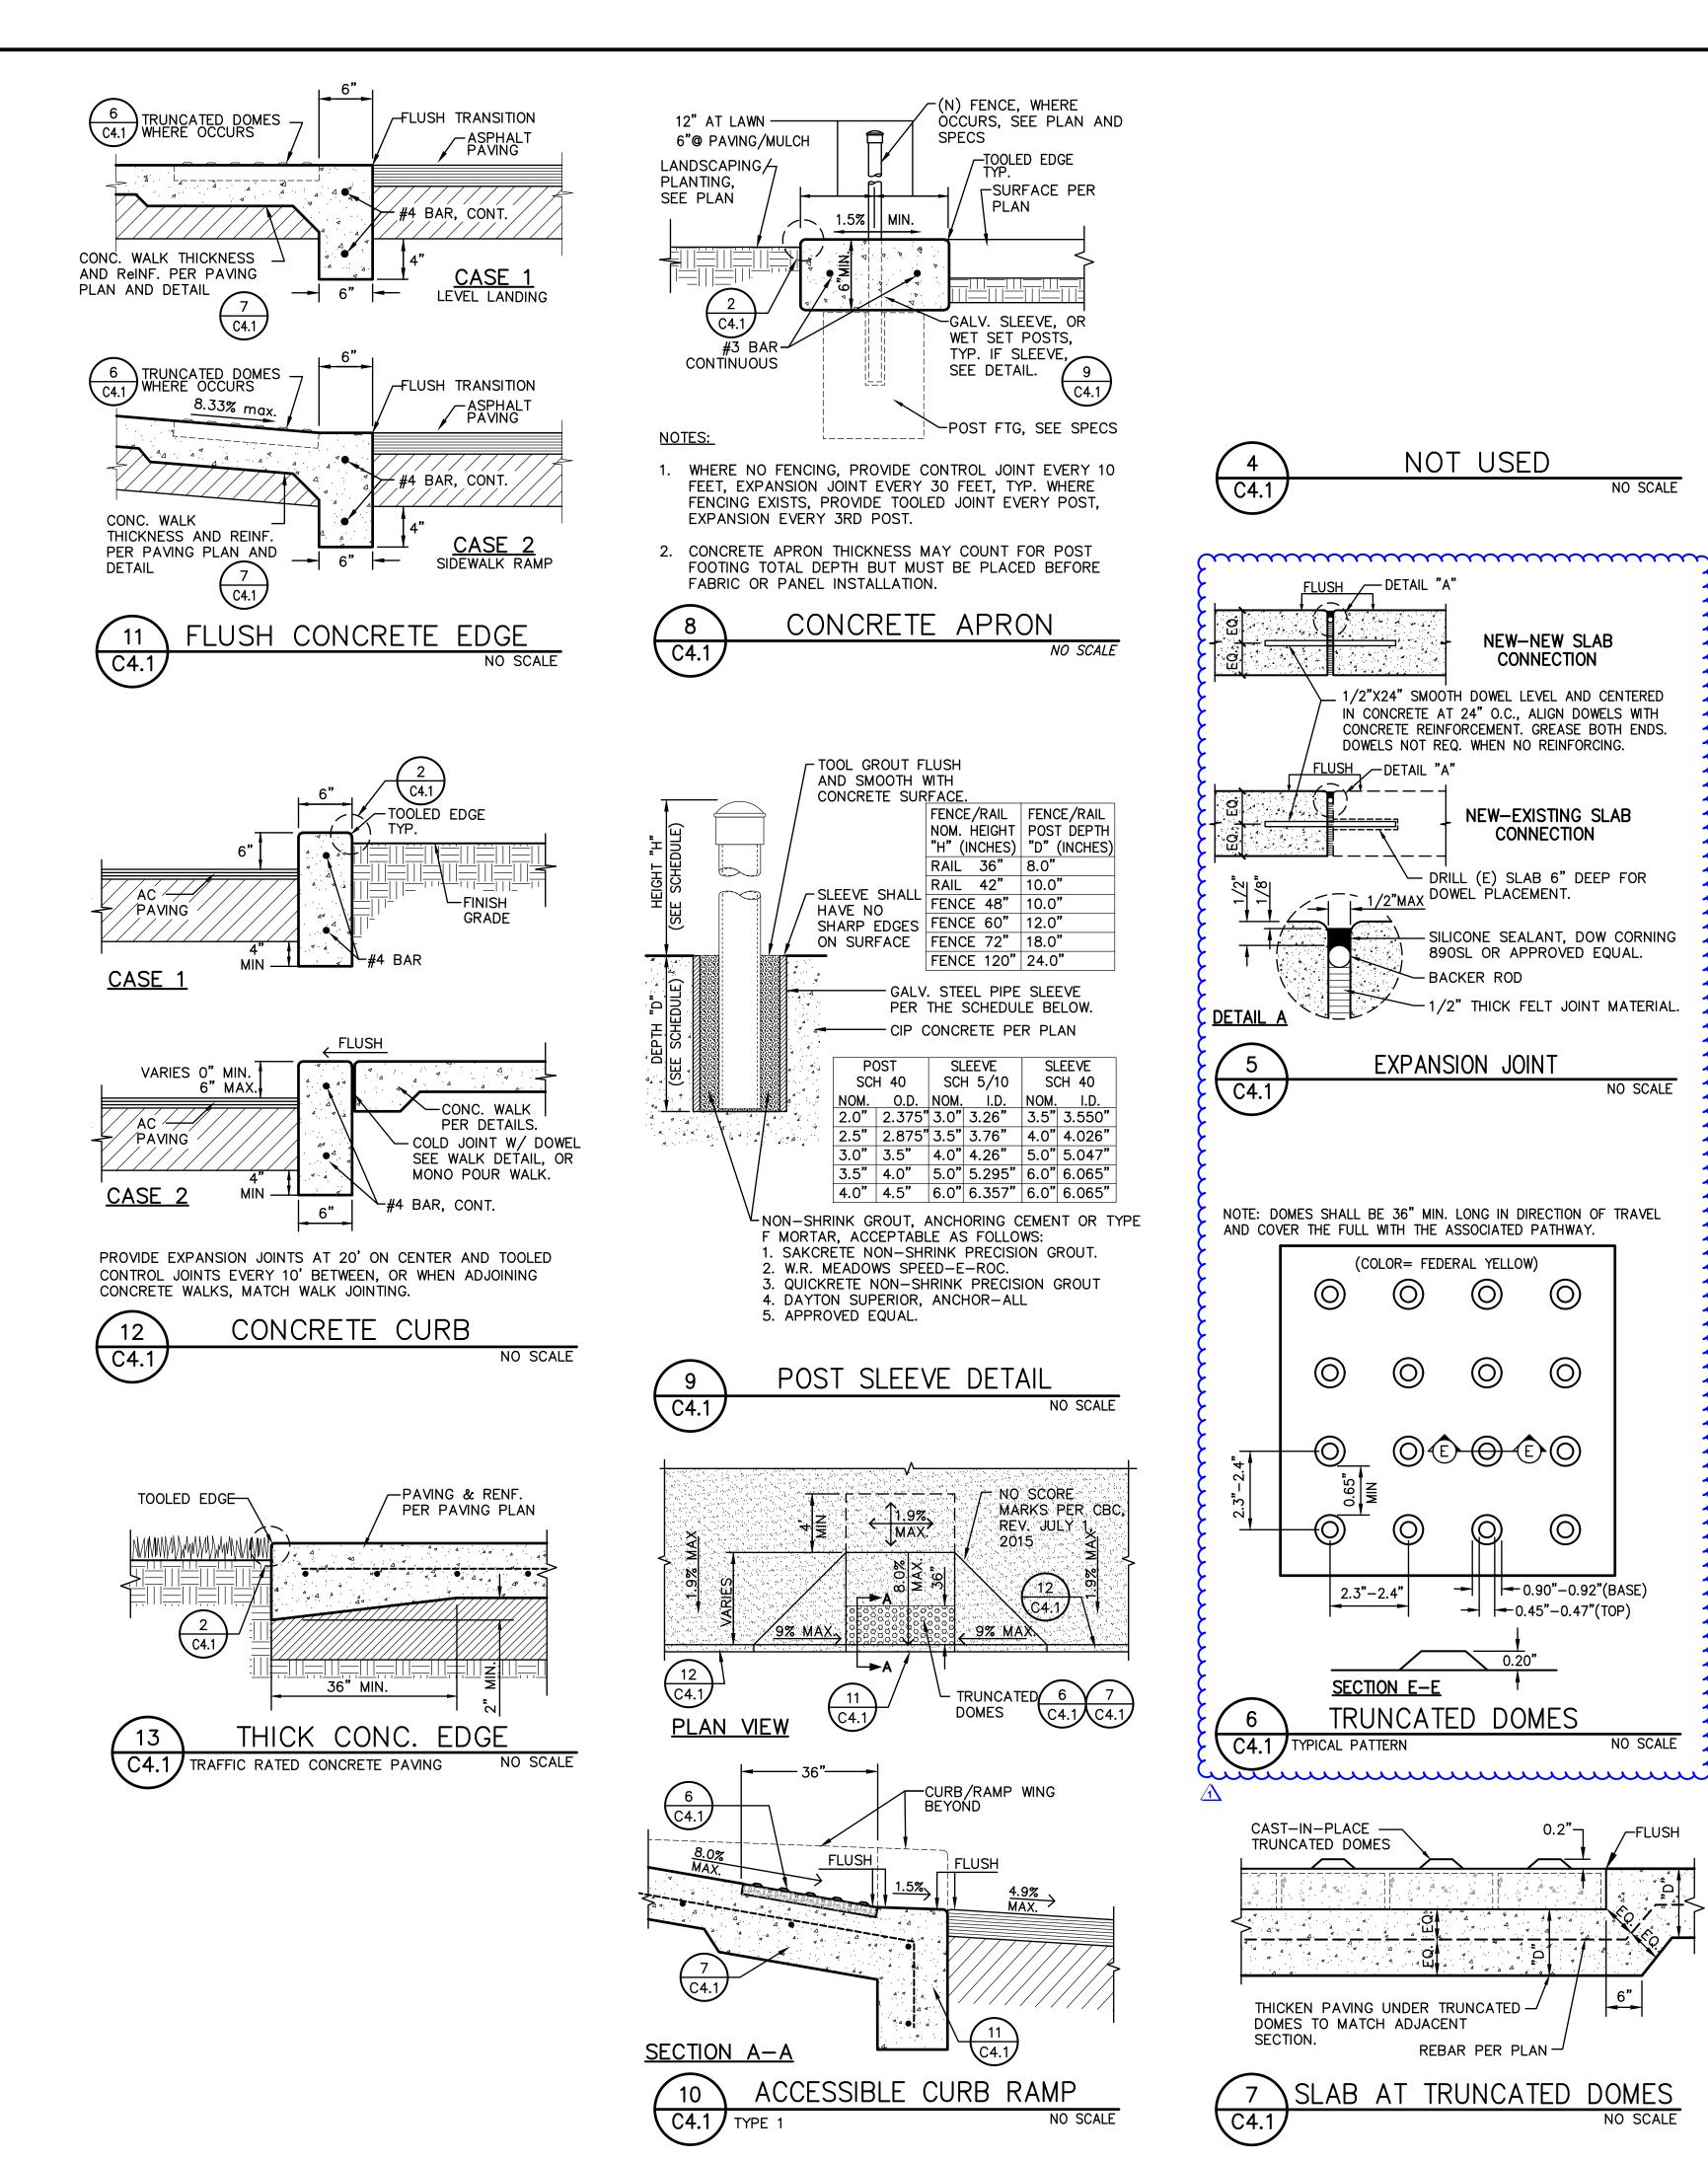

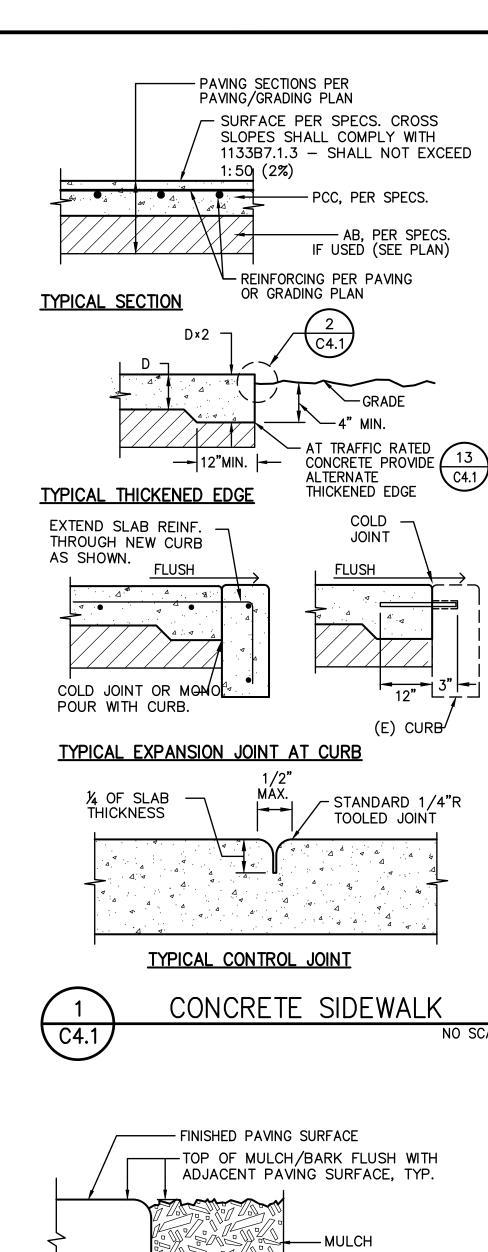

NOT USED

NEW-NEW SLAB

CONNECTION

NEW-EXISTING SLAB

CONNECTION

- SILICONE SEALANT, DOW CORNING

-1/2" THICK FELT JOINT MATERIAL.

0.90"-0.92"(BASE)

NO SCALE

/-FLUSH

C4.1


-- 0.45"-0.47"(TOP)

NO SCALE


- DRILL (E) SLAB 6" DEEP FOR

890SL OR APPROVED EQUAL.

NO SCALE

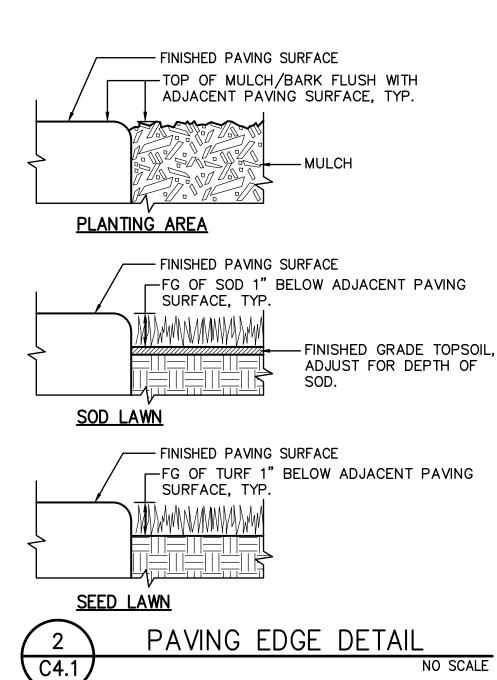

NOT USED

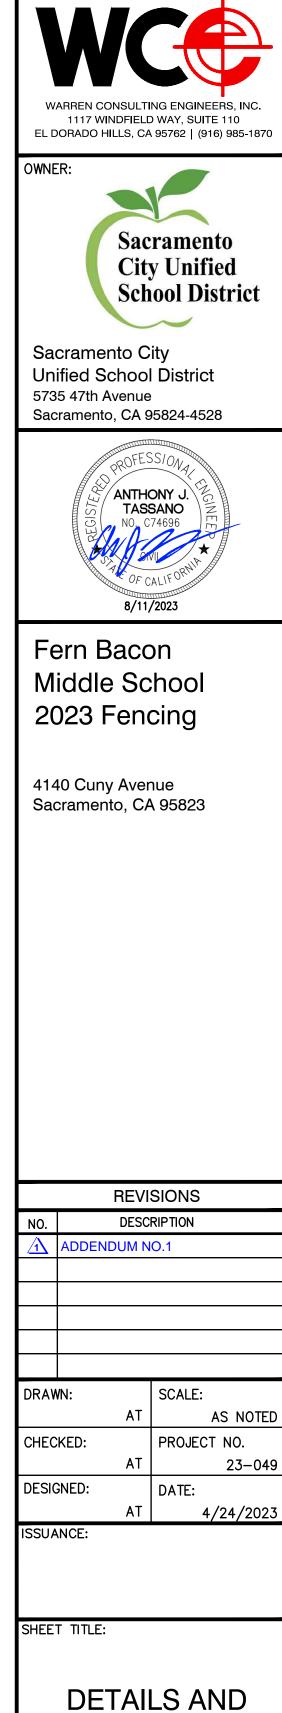

SECTIONS

C4.1

SHEET NO.

NO SCALE

# MATSUYAMA ELEMENTARY SCHOOL 2023 FENCING

7680 Windbridge Drive Sacramento, CA 95831

CONSTRUCTION OF SITE FENCING AND GATES WITH ELECTRONIC ACCESS CONTROLS FOR SITE SECURITY, TOGETHER WITH ASSOCIATED FLATWORK AND PAVING PERAIRS FOR ACCESSIBILITY COMPLIANCE.

EXISTING CONCRETE PER DRAWING DETAIL.

**GENERAL PAVING SURFACE NOTES:** 

CONCRETE SHALL MEET THE FOLLOWING SLOPE REQUIREMENTS:

NO GREATER THAN 2% SLOPE CROSSING THE DIRECTION OF TRAVEL.

NO GREATER THAN 2% SLOPE IN ANY DIRECTION IN COURTYARD OR PLAZA AREAS.

- NO GREATER THAN 5% SLOPE IN THE DIRECTION OF TRAVEL.

BE ALLOWED.

22. ALL AREAS DISTURBED BY GRADING OPERATIONS WHETHER SHOWN ON THE DRAWINGS OR NOT SHALL BE HYDRO

SEEDED UNLESS OTHERWISE NOTED. HYDRO SEEDING SHALL CONFORM TO LOCAL CITY/COUNTY STANDARDS.

23. REPAIR OR PATCHING OF GALVANIZED METALS, SUCH AS AFTER WELDING GALVANIZED COMPONENTS, SHALL BE

PROVIDE EQUIVALENT OF MEDIUM BROOM FINISH AT SLOPES UP TO 5.99%, TYPICAL. PROVIDE

NO LESS THAN 0.75% IN ANY DIRECTION, UNLESS SPECIFICALLY LABELED OTHERWISE. ALL

EQUIVALENT OF HEAVY BROOM FINISH AT SLOPES 6% AND GREATER. REFER TO SPECIFICATIONS.

ALL NEW PEDESTRIAN WALKWAYS (NON-RAMP) SHALL BE SLOPED NO GREATER THAN 2.0%, AND

MADE USING A ZINC COMPOSITION "HOT STICK" APPLICATION PER ASTM A 780-01. GALVANIZING PAINTS WILL NOT



PROJECT TEAM

CIVIL:

WARREN CONSULTING ENGINEERS. INC.

1117 WINDFIELD WAY, SUITE 110

EL DORADO HILLS, CA 95762 PHONE: (916) 985-1870

FAX: (916) 985-1877

KMM SERVICES, INC.

5433 EL CAMINO AVE #5 CARMICHAEL. CA 95608

PHONE: (916) 359-4000



**COVER SHEET** 

SHEET NO.

#### REPAIRS FOR ACCESSIBILITY COMPLIANCE. L DORADO HILLS, CA 95762 | (916) 985-187 **PROJECT NARRATIVE VICINITY MAP GENERAL NOTES SHEET INDEX ABBREVIATIONS** NOTE: NOT ALL ABBREVIATIONS MAY BE USED ON THESE PLAN THE TYPES, LOCATIONS, SIZES, AND/OR DEPTHS OF EXISTING UNDERGROUND UTILITIES AS CONSTRUCTION OF SITE FENCING AND GATES ALONG NO. SHEET DESCRIPTION AGGREGATE BASE JOINT UTILITY POLE SHOWN ON THESE PLANS WERE OBTAINED FROM SOURCES OF VARYING RELIABILITY. THE Sacrament SCHOOL FRONTAGE, TWO ACCESSIBLE EGRESS GATE LINEAL FEET ASPHALTIC CONCRETE CONTRACTOR IS CAUTIONED THAT ONLY ACTUAL EXCAVATION WILL REVEAL THE TYPES, OF WHICH TO BE PROVIDED WITH ELECTRONIC ACCESS LIP OF GUTTER **City Unified** EXTENT, SIZES, LOCATIONS AND DEPTHS OF SUCH UNDERGROUND UTILITIES. A CONTROLS. ADDITIONAL ACCESSIBLE PEDESTRIAN ASSESSOR'S PARCEL NUMBER REASONABLE EFFORT HAS BEEN MADE TO LOCATE AND DELINEATE ALL KNOWN C0.0 COVER SHEET **School District** EGRESS AND MAINTENANCE GATES HAVE ALSO BEEN AIR RELEASE VALVE **MOWSTRIP** UNDERGROUND UTILITIES. HOWEVER, WARREN CONSULTING ENGINEERS CAN ASSUME NO NOT TO SCALE C0.1 AGGREGATE SUB-BASE ADDED. ALL PEDESTRIAN GATES IN A KNOWN OR TOPOGRAPHIC SURVEY RESPONSIBILITY FOR THE COMPLETENESS OR ACCURACY OF ITS DELINEATION OF SUCH BLOW-OFF VALVE OVERHEAD UNDERGROUND UTILITIES, NOR FOR THE EXISTENCE OF OTHER BURIED OBJECTS OR POTENTIAL MEANS OF EGRESS HAVE BEEN PROVIDED TOPOGRAPHIC SURVEY BUTTERFLY VALVE PORTLAND CEMENT CONCRETE UTILITIES WHICH MAY BE ENCOUNTERED BUT WHICH ARE NOT SHOWN ON THESE PLANS. WITH PANIC HARDWARE. CONCRETE FLATWORK BACK OF WALK PLANTER DRAIN THE CONTRACTOR OR ANY SUBCONTRACTOR FOR THIS CONTRACT SHALL NOTIFY MEMBERS C1.0.1 SITE ACCESS PLAN UPGRADES TO PROVIDE LEVEL LANDINGS AND Sacramento City POST INDICATOR VALVE CENTERLINE OF UNDERGROUND SERVICE ALERT (USA) TWO (2) WORKING DAYS IN ADVANCE OF CORRECT SLOPES OF CONNECTING WALKWAYS IS ALSO **Call** before you dig. C1.0.2 FIRE ACCESS PLAN Unified School District CATCH BASIN PROPERTY LINE PERFORMING ANY EXCAVATION WORK BY CALLING TOLL FREE 1-800-227-2600, OR 811 PROPOSED AT EACH PEDESTRIAN GATE, BUT ALL POWER POLE FLATWORK PROPOSED IS ONLY FOR COMPLIANCE 5735 47th Avenue C1.1 DEMOLITION PLAN PUBLIC UTILITY EASEMENT CORRUGATED METAL PIPE WARREN CONSULTING ENGINEERS, INC. (WCE) ASSUMES NO RESPONSIBILITY FOR ERRORS IN PHYSICAL LOCATION C UPGRADES NECESSARY FOR THE FENCING AND GATE Sacramento, CA 95824-4528 POLYVINYL CHLORIDE REINFORCED CONCRETE PIPE IMPROVEMENTS, HORIZONTAL OR VERTICAL, IF STAKED BY OTHERS. IN ADDITION, ANY SUCH ERRORS IN PHYSICAL CABLE TELEVISION C1.2 DEMOLITION PLAN INSTALLATIONS, NO OTHER ELECTIVE FLATWORK IS CLEANOUT LOCATION MAY AFFECT THE INTENDED DESIGN OF SUCH IMPROVEMENTS AND WCE CANNOT BE HELD RESPONSIBLE PROPOSED, ONLY WORK FOR COMPLIANCE. GRADING AND CONSTRUCTION PLAN COMMUNICATION FOR SUCH CONDITIONS WHICH ARE A RESULT OF ERRORS IN SURVEYING, OR IMPROPER CONSTRUCTION. CONCRETE MANHOLE RIM ELEVATION C3.1 FENCING PLAN IF SUBSURFACE CULTURAL RESOURCES, REMAINS, AND/OR ARTIFACTS ARE UNCOVERED DURING PROJECT CONSTRUCT REDUCED PRESSURE C4.1 DETAILS AND SECTIONS CONSTRUCTION, ALL WORK IN THE VICINITY SHALL BE STOPPED UNTIL SUCH ITEMS CAN BE ASSESSED BY AN CURB RETURN BACKFLOW PREVENTER APPROPRIATE MEMBER OF THE COUNTY ENVIRONMENTAL IMPACT SECTION STAFF. CONCRETE SURFACE C4.2 DETAILS AND SECTIONS RIGHT OF WAY DOUBLE CHECK VALVE SCHEDULE CONTRACTOR AGREES THAT HE/SHE SHALL ASSUME SOLE AND COMPLETE RESPONSIBILITY FOR JOB SITE CONDITIONS DURING THE COURSE OF CONSTRUCTION OF THIS PROJECT, INCLUDING SAFETY OF ALL PERSONS AND DOUBLE DETECTOR CHECK VALVE C4.3 DETAILS AND SECTIONS STORM DRAIN DECOMPOSED GRANITE STORM DRAIN MANHOLE PROPERTY: THAT THIS REQUIREMENT SHALL APPLY CONTINUOUSLY AND SHALL NOT BE LIMITED TO NORMAL C4.4 DETAILS AND SECTIONS DROP INLET WORKING HOURS: AND THAT THE CONTRACTOR SHALL DEFEND, INDEMNIFY AND HOLD THE OWNER AND ENGINEER SUBGRADE ELEVATION DIAMFTER SIDE INLET THERE ARE NO BUILDINGS OR STRUCTURES TO BE HARMLESS FROM ANY AND ALL LIABILITY, REAL OR ALLEGED, IN CONNECTION WITH THE PERFORMANCE OF WORK DUCTILE IRON PIPE SANITARY SEWER CONSTRUCTED, MODERNIZED OR OTHERWISE ALTERNATED ON THIS PROJECT, EXCEPTING FOR LIABILITY ARISING FROM THE SOLE NEGLIGENCE OF THE OWNER OR ENGINEER. **DRAWING** SANITARY SEWER MANHOLE BY THIS SET OF PLANS. **ELECTRICAL** DOWNSPOUT THE CONTRACTOR SHALL OBTAIN AN EXCAVATION PERMIT FROM THE STATE OF CALIFORNIA DEPARTMENT OF STANDARD TOOO TECHNOLOGY COVER SHEET INDUSTRIAL SAFETY FOR ALL EXCAVATIONS OF 5 FEET OR MORE IN DEPTH. SIDEWALK **TELEPHONE** APPLICABLE REGULATIONS :ASEMENT IT SHALL BE THE CONTRACTOR'S RESPONSIBILITY TO MAKE ALL NECESSARY PRE-BID AND PRE-CONSTRUCTION T200 TECHNOLOGY FLOOR PLAN TOP OF CURB SITE INSPECTION, AND/OR OBSERVATIONS ON THE SITE TO PRE-DETERMINE ALL HIS/HER MEANS AND METHODS TRENCH DRAIN ANTHONY J NECESSARY TO COMPLETE THE IMPROVEMENTS SHOWN ON THESE PLANS AND PER THE PROJECT SPECIFICATIONS. T900 TECHNOLOGY DETAILS TRENCH DRAIN CATCH BASIN FIRE DEPARTMENT CONNECTION ALL WORK SHALL CONFORM TO TITLE 24, TASSANO IT IS THE CONTRACTORS RESPONSIBILITY TO DETERMINE, AND INCLUDE IN HIS/HER CONTRACT, ALL MEANS AND TELEPHONE POLE **FLOWLINE** CALIFORNIA CODE OF REGULATIONS (CCR) METHODS NECESSARY TO PERFORM A COMPLETE AND ACCEPTABLE JOB. TOP OF RETAINING WALL SANITARY SEWER FORCE MAIN TOP OF SEAT WALK WHERE IMPROVEMENTS LIE WITHIN AN EXISTING DEVELOPED AREA, CONTRACTOR SHALL USE CAUTION WHEN FINISHED FLOOR ELEVATION CHANGES TO THE APPROVED DRAWINGS AND TOP OF WALK ELEVATION SITE MAP ACCESSING THE SITE THROUGH THESE EXISTING IMPROVEMENTS. IT IS THE CONTRACTORS RESPONSIBILITY TO FIRE HYDRANT NO SCALE SPECIFICATION SHALL BE MADE BY AN ADDENDA PROTECT ANY SUCH EXISTING IMPROVEMENTS OUTSIDE THE PROJECT BOUNDARY, OR EXISTING IMPROVEMENTS OR A CONSTRUCTION CHANGE DOCUMENT UNDERGROUND WITHIN THE BOUNDARY WHICH ARE TO REMAIN. PROPER PRECAUTIONS SHALL BE PROVIDED AND MAINTAINED APPROVED BY DSA AS REQUIRED BY SECTION UNLESS OTHERWISE NOTED THROUGHOUT CONSTRUCTION. ANY DAMAGE SHALL BE REPAIRED OR REPLACED TO THE SATISFACTION OF THE GRADE ELEVATION 4-338, PART 1, TITLE 24 CCR. VITRIFIED CLAY PIPE GATE VALVE WATER HOSE BIBB IT IS THE RESPONSIBILITY OF THE CONTRACTOR TO KEEP DETAILED RECORDS OF MINOR CHANGES OR SHOULD ANY EXISTING CONDITIONS SUCH AS WITH Matsuyama HEADER BOARD DETERIORATION OR NON-COMPLYING CONSTRUCTION WITHOUT ADJUSTMENTS MADE DURING CONSTRUCTION (WHICH WERE NOT FORMALLY ISSUED). UPON PROJECT COMPLETION, HIGH DENSITY POLYETHYLENE PIPE BE DISCOVERED WHICH IS NOT COVERED BY THE WATER VALVE THESE RECORDS AND/OR INFORMATION SHALL BE PROVIDED TO THE OWNER AND WARREN CONSULTING ENGINEERS HIGH POINT Elementary CONTRACT DOCUMENTS WHEREIN THE FINISHED INC. UNLESS AN OFFICIAL "AS-BUILT" SET OF PLANS IS A REQUIREMENT OF THE CONTRACT. IF AS-BUILT PLANS PIPE INVERT ELEVATION WORK WILL NOT COMPLY WITH TITLE 24, CCR, A ARE A REQUIREMENT OF THE CONTRACT, REFER TO SPECIFICATIONS FOR AS-BUILT DELIVERABLE REQUIREMENTS. 2023 Fencing CONSTRUCTION CHANGE DOCUMENT (CCD), OR A SEPARATE SET OF PLANS AND SPECIFICATIONS. IN VEHICULAR PATHWAYS, EXISTING ASPHALTIC AND/OR CONCRETE SURFACES SHALL BE CUT TO A NEAT AND STRAIGHT LINE, PARALLEL OR PERPENDICULAR TO THE VEHICULAR TRAVELED PATH. THIS IS TYPICALLY THE DETAILING AND SPECIFYING THE REQUIRED WORK SHALL BE SUBMITTED TO AND APPROVED BY DSA ROADWAY CENTERLINE, BUT MAY VARY. THAT SAWCUT EDGE SHALL BE PROTECTED FROM DAMAGE DURING CONSTRUCTION SO A CLEAN EDGE REMAINS FOR PATCH BACK.. IF EDGE IS DAMAGED, A NEW SAW CUT WILL BE **PROJECT** BEFORE PROCEEDING WITH THE WORK. (SECTION REQUIRED. THE EXPOSED EDGE SHALL BE "TACKED" WITH EMULSION PRIOR TO PAVING. 7680 Windbridge Drive 4-317, PART 1, TITLE 24, CCR) Sacramento, CA 95831 NO BURNING OR BLASTING SHALL BE ALLOWED ONSITE UNLESS SPECIFICALLY ADDRESSED ON PLANS, OR A DSA CERTIFIED PROJECT INSPECTOR EMPLOYED SPECIFICALLY APPROVED AND COORDINATED WITH THE ARCHITECT, ENGINEER, AND LOCAL AGENCY OR OTHER SYMBOLS LEGEND NOTE: NOT ALL SYMBOLS MAY BE USED ON THESE PLANS BY THE DISTRICT (OWNER) AND APPROVED BY DSA ADMINISTRATIVE AUTHORITY. SHALL PROVIDE CONTINUOUS INSPECTION OF THE SUBGRADE AND RESULTING FINISHED GRADE SHALL BE CONSTRUCTED SMOOTH AND UNIFORM BETWEEN SPOT WORK. THE DUTIES OF THE INSPECTOR ARE ELEVATIONS, CONTOURS OR OTHER STRUCTURE ELEVATIONS SHOWN ON GRADING OR OTHER PLANS. NO MOUNDS, DEFINED IN SECTION 4-342, PART 1, TITLE 24, PROPOSED GRADING & DRAINAGE PROPOSED WATER SYMBOLS: RUTS, DEPRESSIONS OR OTHER GRADING DEFICIENCIES WILL BE ALLOWED UNLESS SPECIFICALLY SHOWN ON PLANS. SYMBOLS: 12. ON NEW WATER SYSTEMS. SERVICE LATERALS SHALL BE MADE USING APPROPRIATE "TEE" AND "WYE" FITTINGS. THIS PROJECT REQUIRES INSPECTOR CLASS 3 SADDLE TAPS WILL ONLY BE ALLOWED WHEN MAKING CONNECTIONS TO EXISTING WATER MAINS. GRADING PLANS, DRAINAGE IMPROVEMENTS, ROAD 8" FS FIRE LINE & SIZE CURING COMPOUND SHALL BE APPLIED IN A CONTINUOUS SOLID WET FLOWING COAT. ANY "SPOTTY" APPLICATIONS AND ACCESS REQUIREMENTS AND ENVIRONMENTAL SHALL BE RECOATED IMMEDIATELY. APPLICATION SHALL BE INSPECTED BY PROJECT INSPECTOR DURING TOTAL SHEET COUNT = 16 HEALTH CONSIDERATIONS SHALL COMPLY WITH ALL APPLICATION. —— 8"DW — DOMESTIC WATER LINE & SIZE LOCAL ORDINANCES. EMBEDMENT OF FEATURES IN CONCRETE PAVING, CURBS, OR WALLS, SUCH AS SQUARE OR ROUND TUBING, POSTS, REVISIONS OWNER/USER RECLAIMED WATER LINE & SIZE CATCH BASIN (CB) OR COLUMNS. STEEL BOLTED PLATES. OR OTHER STRUCTURES. SHALL REQUIRE ADDITIONAL SCORE OR EXPANSION SPECIAL TESTING: JOINTS TO PREVENT UNCONTROLLED CRACKING. THOSE ADDITIONAL JOINTS MAY OR MAY NOT BE SPECIFICALLY DESCRIPTION DROP INLET (DI) SHOWN ON PLANS BUT SHALL BE PROVIDED BY THE CONTRACTOR. **APPLICABLE CODES & STANDARDS** CONTRACTOR SHALL PROVIDE AND COORDINATE ADDENDUM NO.1 SACRAMENTO CITY OWNER: TESTING OF NEW LIGHTING CONTROLES MECHANICAL AREA DRAIN (AD) EMBEDMENT OF FEATURES IN CONCRETE PAVING, CURBS, OR WALLS, SUCH AS SQUARE OR ROUND TUBING, POSTS UNIFIED SCHOOL DISTRICT SYSTES, ENVELOPES AND PROCESS EQUIPMENT AND OR COLUMNS, STEEL BOLTED PLATES, OR OTHER STRUCTURES, SHALL REQUIRE A MINOR ADJUSTMENT OF REBAR 5735 47TH AVE. SACRAMENTO, CA SYSTEMS IN ACCORDANCE WITH CALIFORNIA ENERGY WITHIN CONCRETE TO ALLOW FOR SUCH STRUCTURE. THAT REBAR ADJUSTMENT MAY NOT BE SPECIFICALLY SHOWN 2022 CALIFORNIA ADMINISTRATIVE CODE (CAC), PART 1, TITLE 24 CCR\* 95824-4528 ## FIRE SPRINKLER SVC. LINE & SIZE CODE, SECTION 10-103. PHONE: (916) 643-9000 2022 CALIFORNIA BUILDING CODE (CBC), PART 2, TITLE 24 CCR STORM DRAIN CLEANOUT NO MORE THAN 1 GALLON OF WATER PER YARD OF CONCRETE CAN BE ADDED TO THE TRUCK AFTER ARRIVAL TO → GATE VALVE (2018 INTERNATIONAL BUILDING CODE, VOL. 1 & 2, AND 2019 CALIFORNIA AMENDMENTS) PROJECT SITE. THE ADDITION OF WATER CAN ONLY BE ADDED UNDER THE SUPERVISION OF THE CONCRETE **DISTRICT CONTACT:** ELEVATION INSPECTOR OR LABORATORY TECHNICIAN. [CONTACT] 2022 CALIFORNIA ELECTRICAL CODE (CEC), PART 3, TITLE 24 CCR ——M—— WATER METER **DEFERRED APPROVALS** FACILITIES SUPPORT SERVICES WHEN PUMPING CONCRETE FOR PLACEMENT, ABSOLUTELY NO WATER IS TO BE ADDED TO PUMP HOPPER. ANY (2017 NATIONAL ELECTRICAL CODE AND 2019 CALIFORNIA AMENDMENTS) FF=100.00 (916) 264-4075 ELEVATION WATER ADDED TO HOPPER WILL BE REASON FOR CONCRETE REJECTION AT THE CONTRACTORS EXPENSE. DRAWN: SCALE: → → FH FIRE HYDRANT ASSEMBLY [EMAIL] 2022 CALIFORNIA PLUMBING CODE (CPC), PART 5, TITLE 24 CCR 18. ALL CONTRACTION/CONSTRUCTION JOINTS "CJ" SHALL BE 1/4 THE SLAB THICKNESS DEEP, BUT NO LESS THAN 1' (2018 IAPMO UNIFORM PLUMBING CODE AND 2019 CALIFORNIA AMENDMENTS) AS NOTE PAD=99.33 FOR CONTROLLING OF CRACKING. CONTRACTOR SHALL EXERCISE CAUTION WHEN FINAL TROWELING OF CONCRETE FDC FIRE DEPARTMENT CONNECTION SO AS NOT TO FILL IN THESE JOINTS WITH CONCRETE CREAM. ANY CRACKS OUTSIDE OF JOINTS WHICH WERE 2022 CALIFORNIA ENERGY CODE (CEC), PART 6, TITLE 24 CCR PROJECT NO. CHECKED: **ADDITIONAL CONTACTS:** CONCRETE SIDEWALK CONSTRUCTED LESS THAN 1" DEEP, SHALL BE CAUSE FOR CONCRETE SLAB(S) TO BE REMOVED AND REPLACE AT DETECTOR CHECK VALVE TROY MIETZ 23-055 2022 CALIFORNIA FIRE CODE (CFC), PART 9, TITLE 24 CCR CONTRACTORS EXPENSE. TROY-MIETZ@SCUSD.EDU GRADED DIRECTION FOR $\longrightarrow$ (2018 INTERNATIONAL FIRE CODE AND 2019 CALIFORNIA AMENDMENTS) DESIGNED: DOUBLE DETECTOR CHECK VALVE DRAINAGE FLOW 19. ANY SCREED BOARDS SET WITHIN CONCRETE SLABS SHALL BE AN "OVERHEAD SCREED" SO THERE IS NO 2022 CALIFORNIA REFERENCED STANDARDS CODE. PART 12. TITLE 24 CCR INTERFERENCE WITH THE PLACEMENT AND ALIGNMENT OF SLAB REINFORCING. 4/24/2023 $\longrightarrow$ --- $\longrightarrow$ SWALE TITLE 19 CCR, PUBLIC SAFETY, STATE FIRE MARSHAL REGULATIONS REDUCED PRESSURE 20. 3-1/2" FELT JOINTS WILL NOT BE ACCEPTED. PROVIDE A FULL 4" FELT JOINT FOR 4" SLAB CONSTRUCTION, AND ISSUANCE: BACKFLOW PREVENTER 2022 CALIFORNIA ENERGY CODE (CGC), Part 11, Title 24 CCR. A 6" FELT JOINT FOR A 6" SLAB SLAB CONSTRUCTION. 21. SHOULD ANY SHRINKAGE CRACKS OCCUR OUTSIDE OF EITHER THE EXPANSION JOINTS OR CRACK CONTROL BUTTERFLY VALVE JOINTS, THEN THE CONCRETE SLAB SHALL BE SAWCUT AT THE NEAREST JOINTS ON EACH SIDE OF THE CRACK TREE TO BE REMOVED AND THE CONCRETE SECTION SHALL BE, REMOVED AND REPLACED. NEW CONCRETE SHALL BE DOWELED INTO AIR RELEASE VALVE + SIZE

**STATEMENTS:** 

TREE TO REMAIN

OVERLAND RELEASE PATH

(SIZE AND FLOW SHOWN)

SANITARY SEWER

MANHOLE (SSMH)

SEWER CLEANOU?

FLUSHER BRANCH


RETAINING WALL

PROPOSED SANITARY SEWER SYMBOLS:

6" SS SANITARY SEWER LINE

BLOW-OFF VALVE + SIZE

POST INDICATOR VALVE

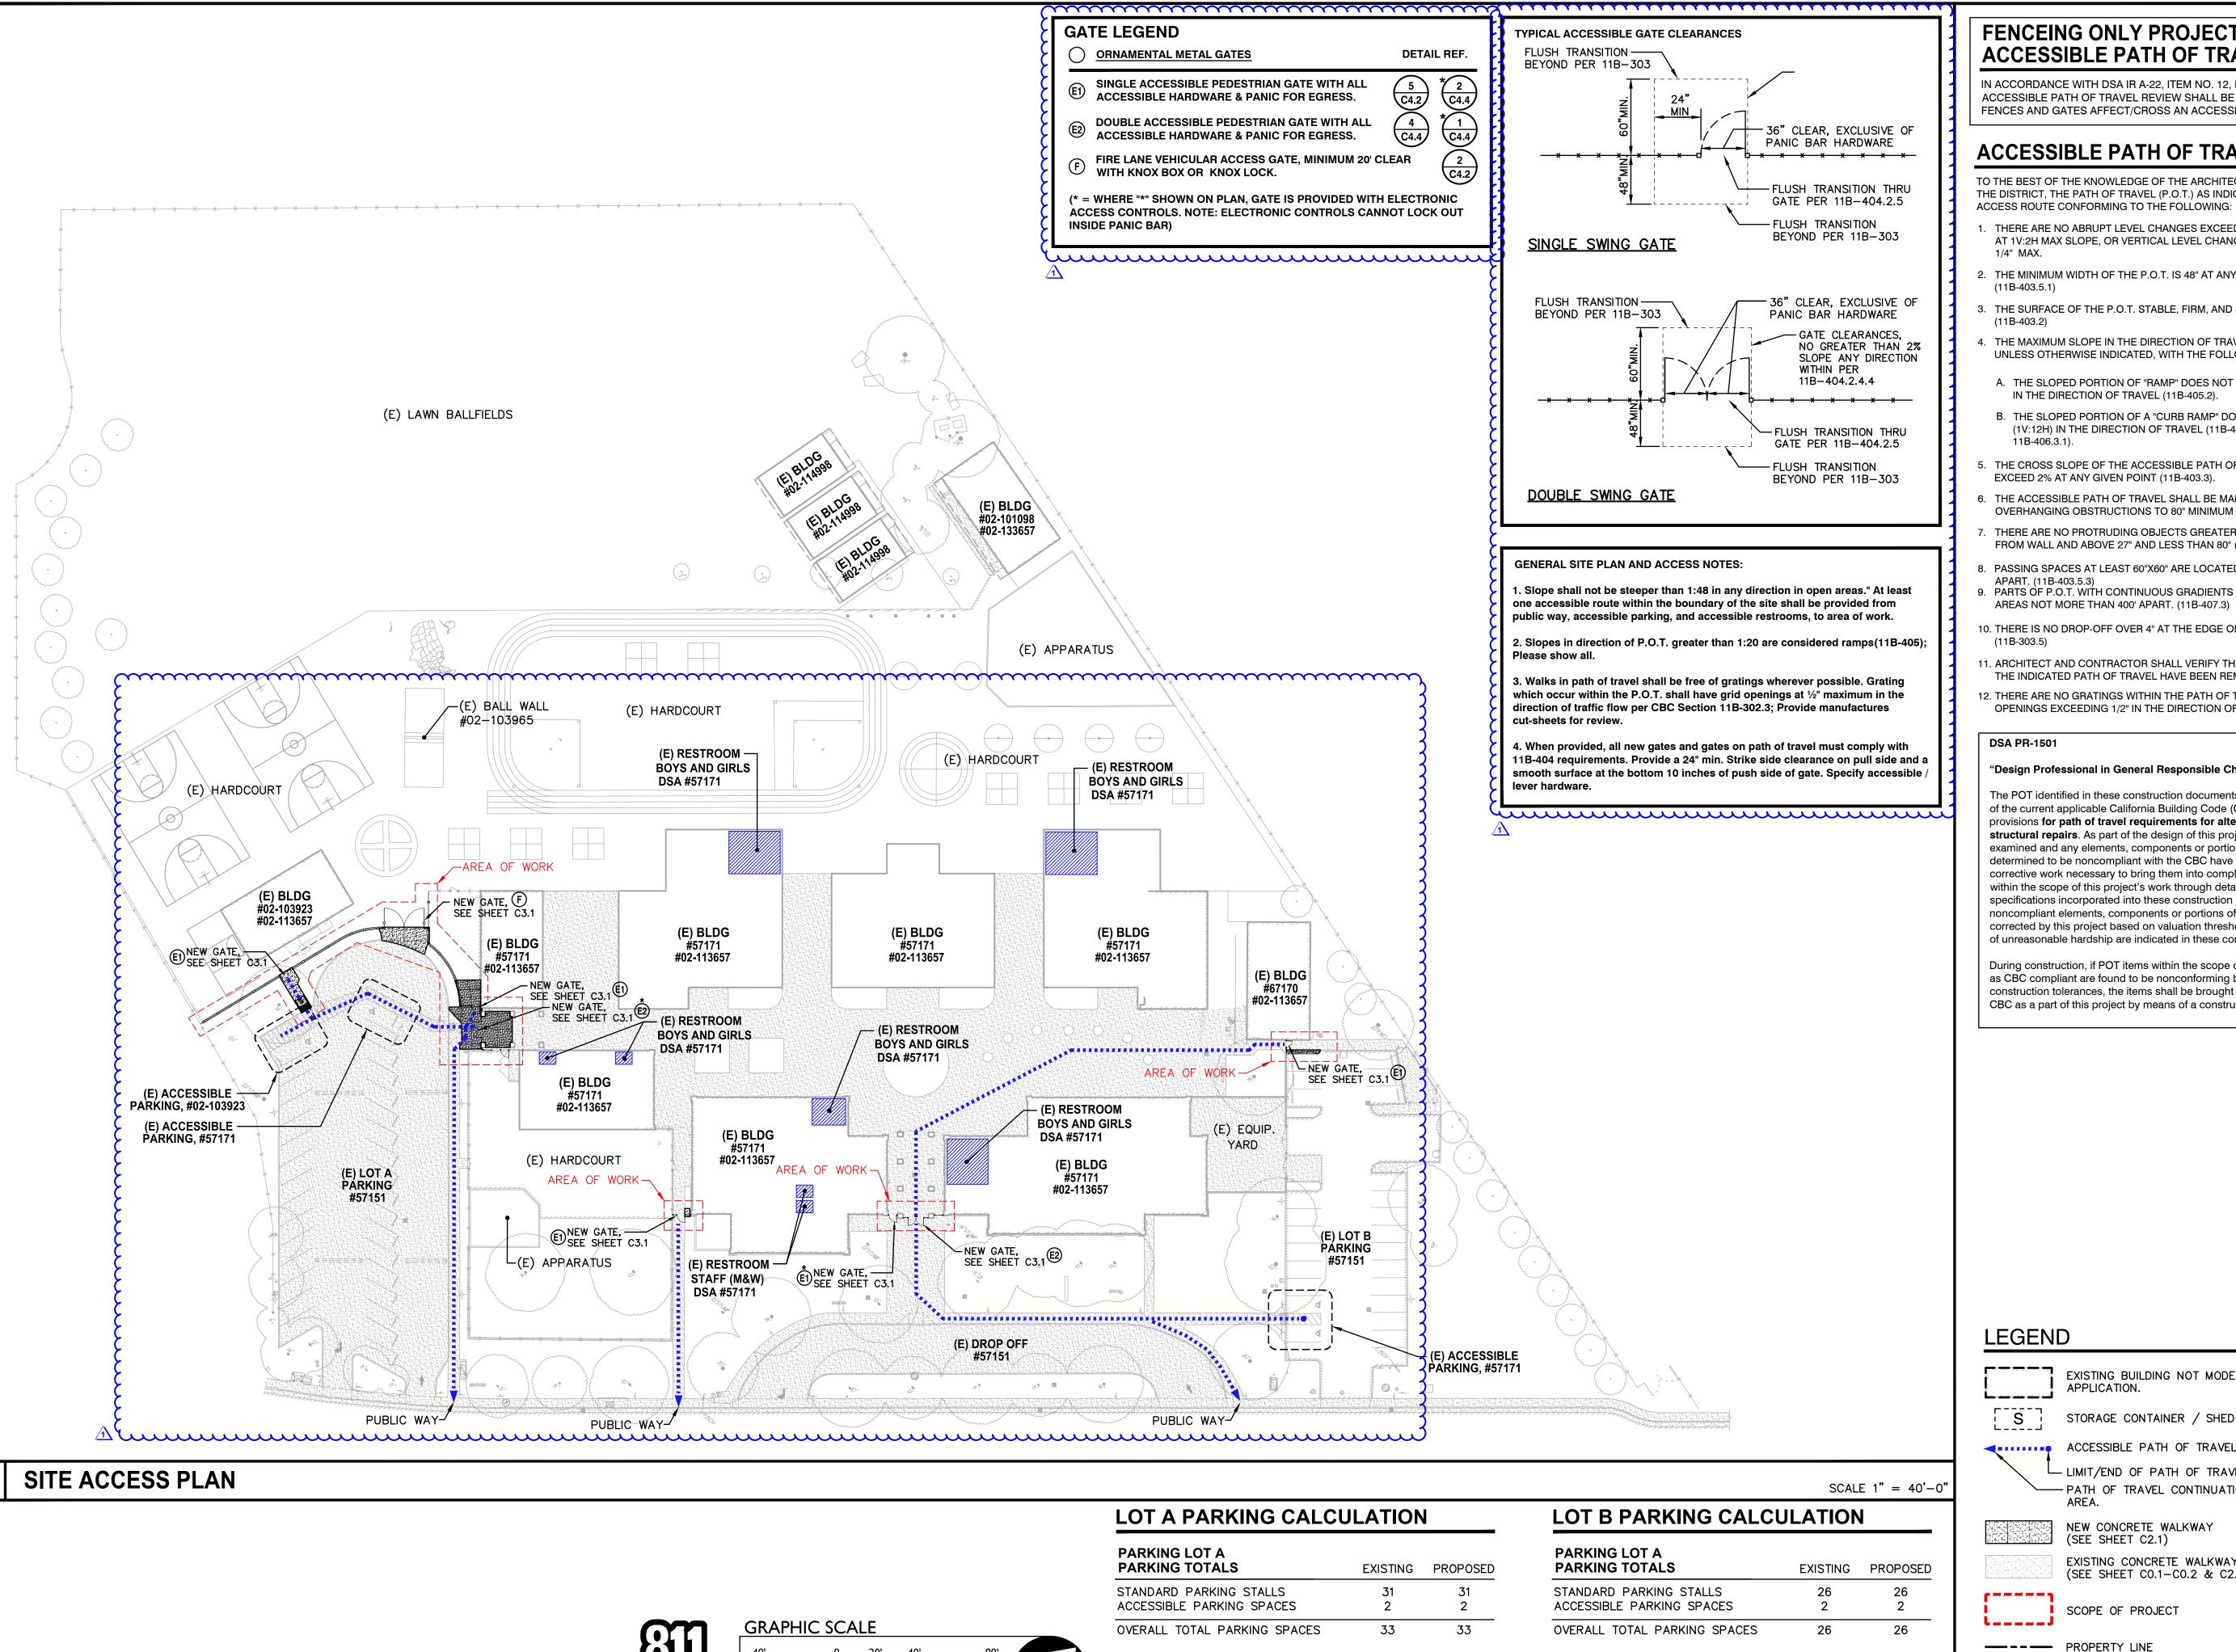

Know what's below.

THIS DRAWING MAY HAVE BEEN ENLARGED OR REDUCED.

# **FENCEING ONLY PROJECT ACCESSIBLE PATH OF TRAVEL**

N ACCORDANCE WITH DSA IR A-22, ITEM NO. 12, KEYNOTE 4, THE ACCESSIBLE PATH OF TRAVEL REVIEW SHALL BE LIMITED TO WHERE NEW FENCES AND GATES AFFECT/CROSS AN ACCESSIBLE PATH OF TRAVEL.

# **ACCESSIBLE PATH OF TRAVEL (P.O.T.)**

TO THE BEST OF THE KNOWLEDGE OF THE ARCHITECT AND/OR ENGINEER. OR THE DISTRICT, THE PATH OF TRAVEL (P.O.T.) AS INDICATED, IS A BARRIER FREE ACCESS ROUTE CONFORMING TO THE FOLLOWING:

- THERE ARE NO ABRUPT LEVEL CHANGES EXCEEDING 1/2" IF BEVELED AT 1V:2H MAX SLOPE, OR VERTICAL LEVEL CHANGES NOT EXCEEDING
- 2. THE MINIMUM WIDTH OF THE P.O.T. IS 48" AT ANY GIVEN POINT.
- . THE SURFACE OF THE P.O.T. STABLE, FIRM, AND SLIP RESISTANT.
- THE MAXIMUM SLOPE IN THE DIRECTION OF TRAVEL IS 5.0% (11B-403.3), UNLESS OTHERWISE INDICATED, WITH THE FOLLOWING EXCEPTIONS:
- A. THE SLOPED PORTION OF "RAMP" DOES NOT EXCEED 8.33% (1V:12H) IN THE DIRECTION OF TRAVEL (11B-405.2).
- B. THE SLOPED PORTION OF A "CURB RAMP" DOES NOT EXCEED 8.33% (1V:12H) IN THE DIRECTION OF TRAVEL (11B-406.2.1 AND 11B-406.3.1).
- THE CROSS SLOPE OF THE ACCESSIBLE PATH OF TRAVEL DOES NOT EXCEED 2% AT ANY GIVEN POINT (11B-403.3).
- 6. THE ACCESSIBLE PATH OF TRAVEL SHALL BE MAINTAINED FREE OF OVERHANGING OBSTRUCTIONS TO 80" MINIMUM (11B-307).
- THERE ARE NO PROTRUDING OBJECTS GREATER THAN 4" PROJECTION FROM WALL AND ABOVE 27" AND LESS THAN 80" (11B-307).
- PASSING SPACES AT LEAST 60"X60" ARE LOCATED NOT MORE THAT 200' APART. (11B-403.5.3) PARTS OF P.O.T. WITH CONTINUOUS GRADIENTS HAVE 60" LEVEL
- 10. THERE IS NO DROP-OFF OVER 4" AT THE EDGE OF WALK OR LANDING. (11B-303.5)
- 11. ARCHITECT AND CONTRACTOR SHALL VERIFY THAT ALL BARRIERS ON THE INDICATED PATH OF TRAVEL HAVE BEEN REMOVED.
- 2. THERE ARE NO GRATINGS WITHIN THE PATH OF TRAVEL WITH GRATE OPENINGS EXCEEDING 1/2" IN THE DIRECTION OF TRAVEL. (11B-302.3)

#### **DSA PR-1501**

#### "Design Professional in General Responsible Charge Statement:

The POT identified in these construction documents meets the requirements of the current applicable California Building Code (CBC) accessibility provisions for path of travel requirements for alterations, additions and **structural repairs**. As part of the design of this project, the POT was examined and any elements, components or portions of the POT that were determined to be noncompliant with the CBC have been identified and the corrective work necessary to bring them into compliance has been included within the scope of this project's work through details, drawings and specifications incorporated into these construction documents. Any noncompliant elements, components or portions of the POT that will not be corrected by this project based on valuation threshold limitations or a finding of unreasonable hardship are indicated in these construction documents.

During construction, if POT items within the scope of the project represented as CBC compliant are found to be nonconforming beyond reasonable construction tolerances, the items shall be brought into compliance with the CBC as a part of this project by means of a construction change document."

EXISTING BUILDING NOT MODERNIZED BY THIS

LIMIT/END OF PATH OF TRAVEL THIS PROJECT.

- PATH OF TRAVEL CONTINUATION INTO ACCESSIBLE

ACCESSIBLE RESTROOM (PROJECT COMPLIANCE)

ACCESSIBLE PATH OF TRAVEL (P.O.T.)

APPLICATION.

STORAGE CONTAINER / SHED

NEW CONCRETE WALKWAY

EXISTING CONCRETE WALKWAY

(SEE SHEET CO.1-CO.2 & C2.1)

(SEE SHEET C2.1)

SCOPE OF PROJECT

**ST** STORAGE, SHED/CONTAINER

---- ROAD CENTERLINE

1117 WINDFIELD WAY, SUITE 110 EL DORADO HILLS, CA 95762 | (916) 985-1870



Sacramento City **Unified School District** 5735 47th Avenue Sacramento, CA 95824-4528

ONSULTANT:

ANTHONY J. TASSANO

# Matsuyama Elementary 2023 Fencing

7680 Windbridge Drive Sacramento, CA 95831

|          | REVISIONS     |
|----------|---------------|
| NO.      | DESCRIPTION   |
| <u>1</u> | ADDENDUM NO.1 |
|          |               |
|          |               |
|          |               |
|          |               |
|          |               |

| RAWN:    | SCALE:      |
|----------|-------------|
| SMN      | AS NOTED    |
| HECKED:  | PROJECT NO. |
| AT       | 23-055      |
| ESIGNED: | DATE:       |
| SMN/AT   | 4/24/2023   |
| SHANCE:  |             |

SHEET TITLE:


SITE ACCESS **PLAN** 

SHEET NO.

C1.0.1

(E) ACCESSIBLE SPACE REQUIREMENTS REQUIRED PROVIDED REQUIRED ACCESSIBLE SPACES (CAR) REQUIRED ACCESSIBLE SPACES (VAN) TOTAL REQUIRED ACCESSIBLE SPACES (PER 2019 CBC SECTION 11B-208.2)

(E) ACCESSIBLE SPACE REQUIREMENTS REQUIRED PROVIDED REQUIRED ACCESSIBLE SPACES (CAR) REQUIRED ACCESSIBLE SPACES (VAN) TOTAL REQUIRED ACCESSIBLE SPACES (PER 2019 CBC SECTION 11B-208.2)

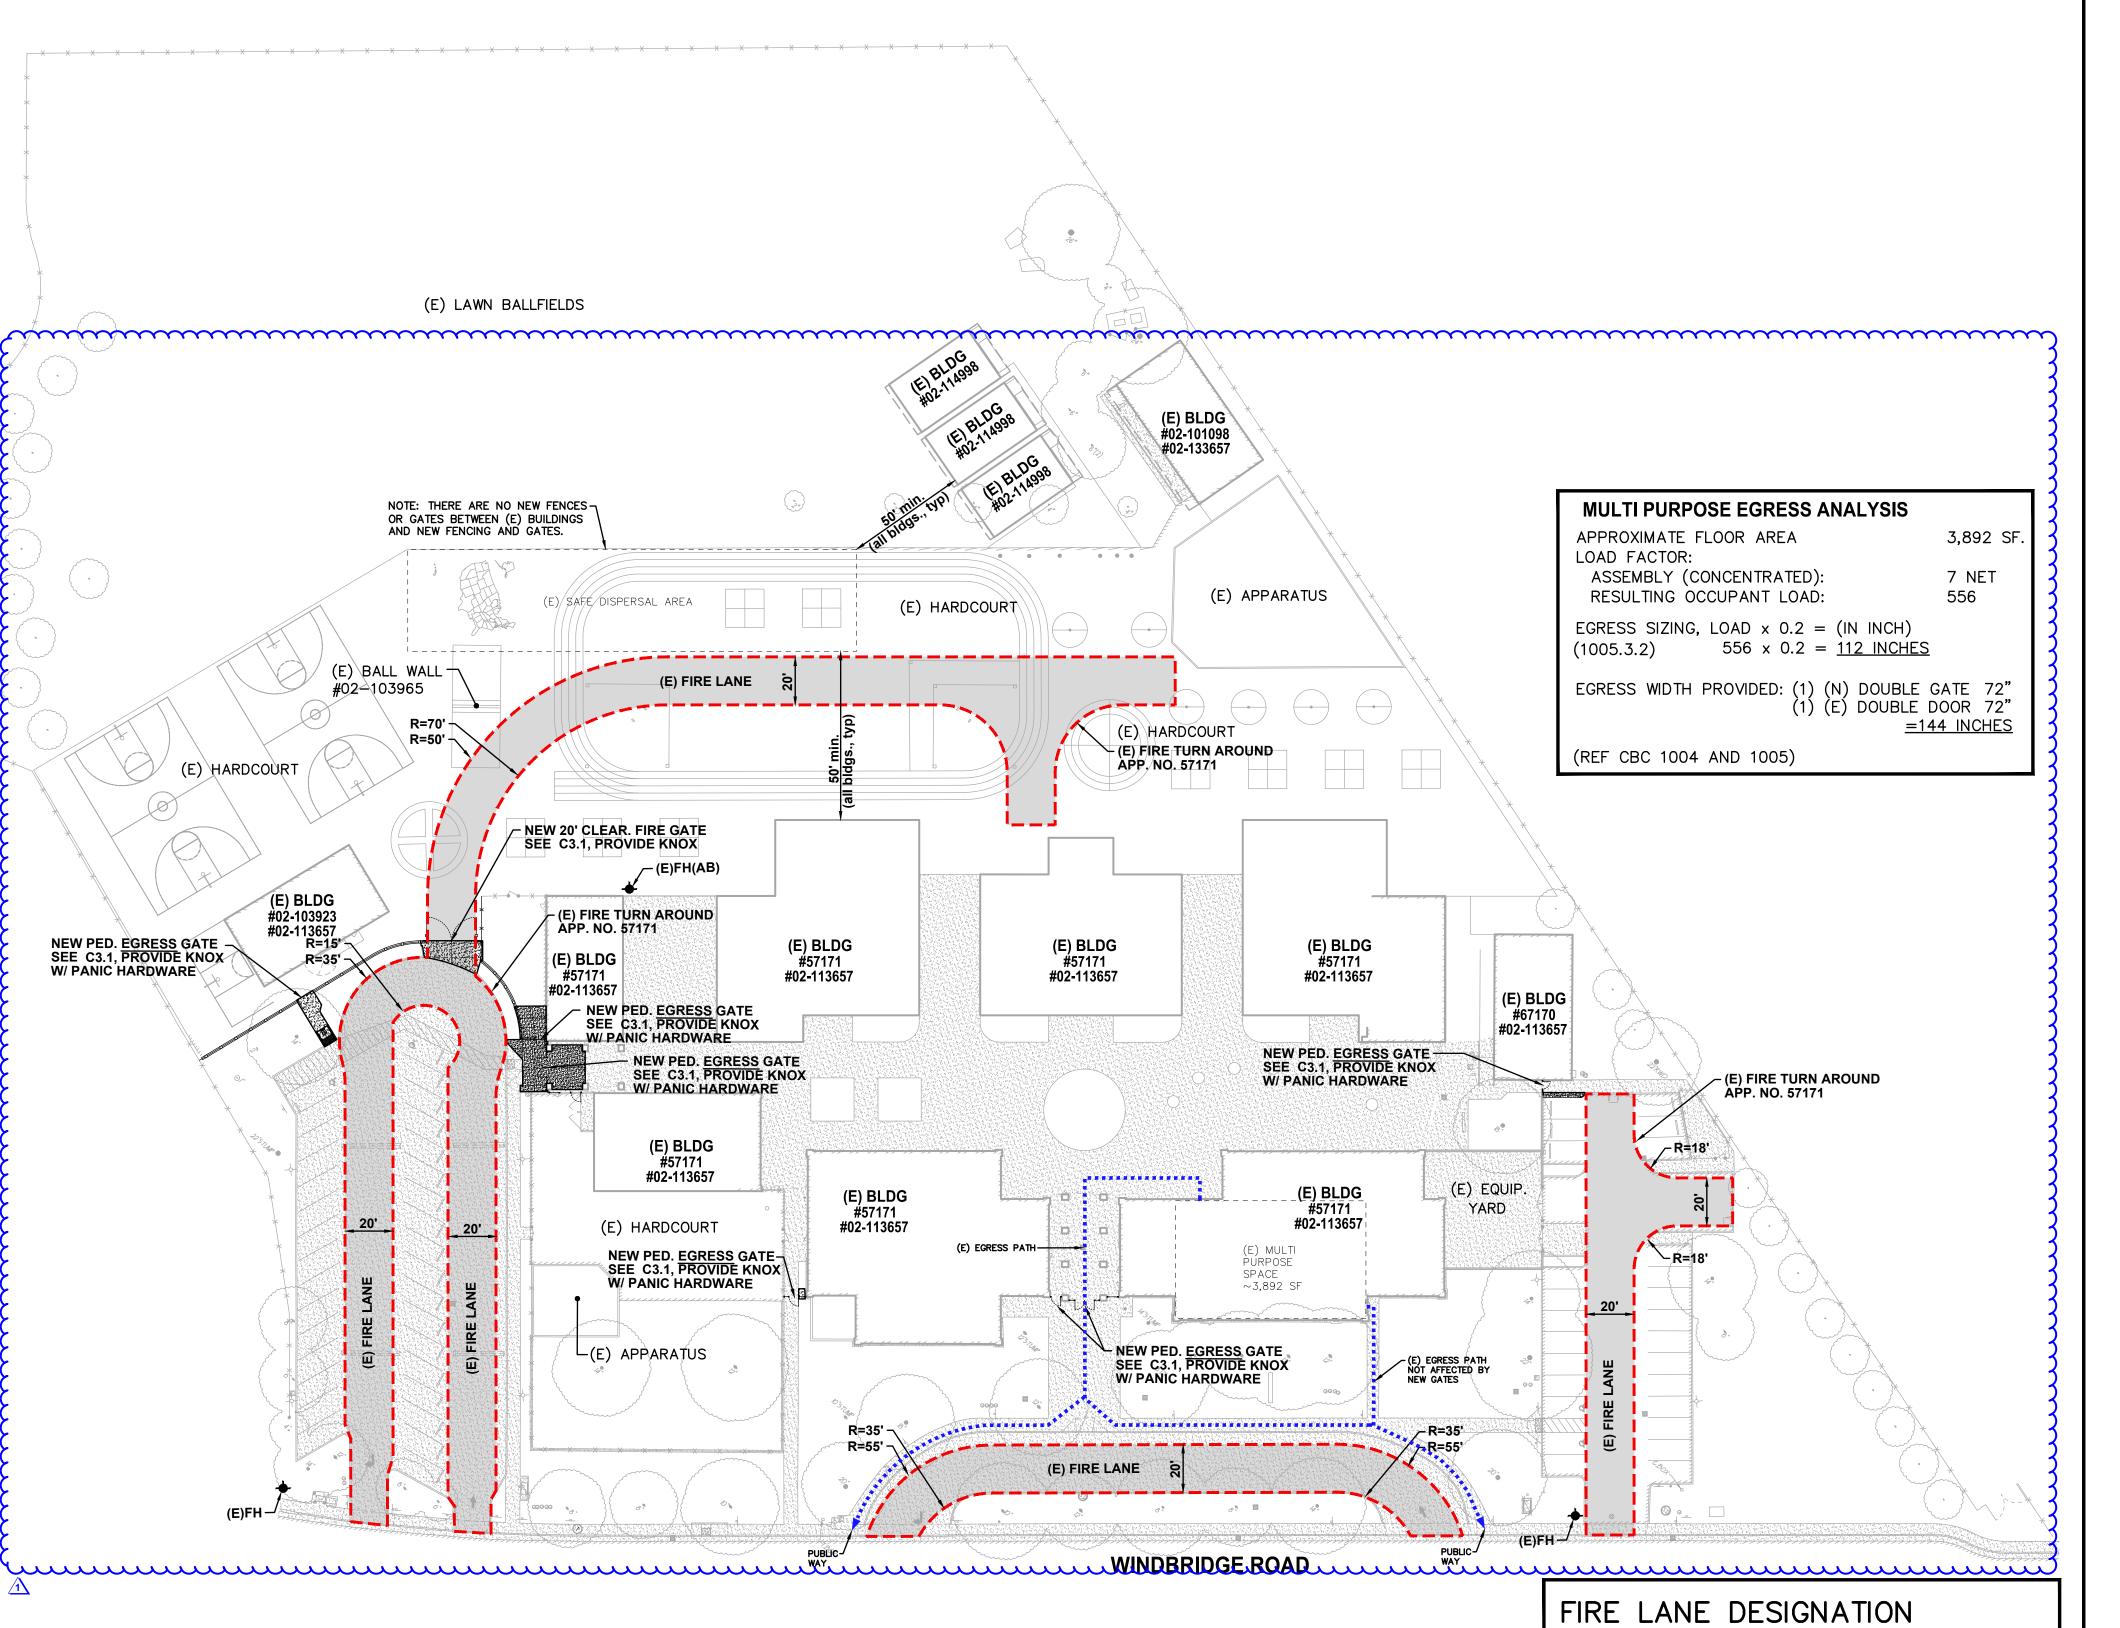

TYPICAL FIRE LANE CLEAR WIDTH 20 FEET CLEAR HEIGHT 13.5 FEET INSIDE RADIUS 35 FEET MIN.

OUTSIDE RADIUS 55 FEET MIN.

KNOX NOTES

NOTE:

All new and existing fire lanes

are asphalt or concrete paved

unless otherwise stated.

ALL GATES WHICH CROSS THE FIRE LANE AS DESIGNATED BY THIS PLAN SHALL BE OUTFITTED WITH A LOW LEVEL KNOX LOCK. ALL FIRE CONTROL ROOMS FOR THIS PROJECT SHALL BE OUTFITTED WITH A HIGH LEVEL KNOX BOX AT A LOCATION WHICH IS APPROVED BY THE SACRAMENTO METROPOLITAN FIRE DISTRICT INSPECTOR.

# PAVEMENT NOTES

FIRE ACCESS ROADWAYS SHALL BE BUILT TO BEAR A MINIMUM OF 75,000 POUNDS IN ACCORDANCE WITH CFC 2022, APPENDIX D.

ALL FIRE LANES ON THIS PLAN SHALL BE DESIGNATED IN ACCORDANCE WITH THE STRIPING PLANS, UTILIZING ONE OF THE FOLLOWING APPROVED MEANS:

- CURBS PAINT CURB TOP AND FACE RED WITH COMMERCIAL GRADE RED TRAFFIC PAINT. ON FACE OF CURB, PAINT 4" TALL WHITE LETTERING STATING "NO PARKING - FIRE LANE" AT 25' O.C. CENTERED ON FACE.
- . PAVING PAINT, 6" WIRE, REP, STRIPE ON PAVEMENT WITH COMMERCIAL GRADE RED TRAFFIC PAINT. CENTERED IN STRIPE, PAINT 4" TALL WHITE LETTERING STATING "NO PARKING - FIRE LANE" AT 25' O.C.
- SIGNAGE POSTING OF SIGNS COMPLIANT WITH CFC 2016, APPENDIX D103.6 EVERY 50 FEET.

# **EXCEPTIONS:**

- STREETS 20' WIDE TO 26' WIDE SHALL BE MARKED ON BOTH SIDES AS STATED ABOVE.
- STREETS GREATER THAN 26' WIDE NEED ONLY MARKING ON ONE SIDE AS STATED ABOVE.
- EDGES OF FIRE LANES AT PARKING DO NOT REQUIRE

SEE STRIPING PLAN FOR ACTUAL REQUIRED STRIPING.

**ADSA** 

# FIRE & LIFE SAFETY SITE CONDITIONS SUBMITTAL


Division of the State Architect (DSA) documents referenced within this publication are available on the DSA Forms or DSA Publications webpages.

To facilitate the Division of the State Architect's (DSA) fire and life safety plan review of project site conditions, DSA requires the design professional to provide the following information at time of project submittal for projects consisting of construction of a new campus, construction of new building(s), additions to existing buildings, and for site alternate design means for fire department emergency vehicle access, and fire suppression water supply.

Information associated with compliance items 1 through 3 below is to be provided for all project types indicated above. Information associated with items 4 through 7 is to be completed when an alternate means is utilized. Acknowledgement by the school district and signature from the Local Fire Authority (LFA) is only required when an alternate design means is being requested.

The Project Information and Fire & Life Safety Information sections are to be completed for all projects and imaged onto the fire access site plan. When an alternate design/means is proposed, all sections on pages 1 and 2 are to be completed and imaged on the fire access site plan.

For additional information refer to the instructions at the end of this form and DSA Policy PL 09-01: Fire Flow for Buildings.

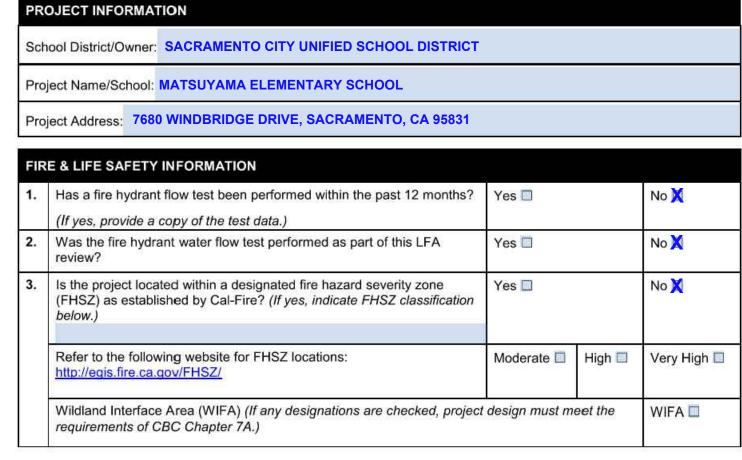

Page 1 of 4 DGS DSA 810 (revised 12/29/20) STATE OF CALIFORNIA DEPARTMENT OF GENERAL SERVICES DIVISION OF THE STATE ARCHITECT

# FIRE & LIFE SAFETY SITE CONDITIONS SUBMITTAL

| CON | IDITION MEANS AND METHODS RESOLUTION   | ALTE | RNATE / | ACCEPT | =1  |
|-----|--|------|---------|--------|-----|
|     |  | Yes  | No      | N/A    | I   |
| 4.  | Emergency vehicle access roadways do not meet CFC requirements.  |      |         | X      |     |
| 4a. | Acceptable Alternate: Emergency vehicle and personnel access as proposed by the project architect is acceptable for providing fire suppression and protection of life and property.                          |      |         |        |     |
| 5.  | Fire Hydrants: Number and spacing does not meet CFC requirements.  |      |         | X      | 100 |
| 5a. | Acceptable Alternate: Number of fire hydrants and spacing as proposed by the project architect is acceptable for fire suppression and protection of life and property.                                       |      |         |        |     |
| 6.  | Fire Hydrants: Water flow and pressure are less than CFC minimum.  |      |         | X      |     |
| 6a. | Acceptable Alternate: The available flow and pressure is acceptable for providing fire suppression and protection of life and property.  |      |         |        | 7   |
| 7.  | Location of fire department connection(s) serving fire sprinkler systems or standpipe systems does not meet CFC requirements.  |      |         | X      |     |
| 7a. | Acceptable Alternate: The location of fire department connection serving the fire sprinkler system and/or standpipe system is acceptable for providing fire suppression and protection of life and property. |      |         |        |     |

# School District Acceptance of Acceptable Design Alternates

By signing this form, the school district acknowledges and accepts the proposed design as an alternative to California Building Code (CBC) and California Fire Code (CFC) minimum requirements, as indicated by one or more of the conditions indicated at items 4a, 5a, 6a or 7a, for providing fire and life safety protection of life and property.

N/A - NO VARIANCE PROPOSED

| LOCAL FIRE AUTH      | ORITY (LFA) INFORMATION                              |      |  |  |  |  |
|----------------------|--|------|--|--|--|--|
| LFA Agency Name:     | LFA Agency Name: City of Sacramento Fire Department  |      |  |  |  |  |
| LFA Review Official: | LFA Review Official: King Tunson                     |      |  |  |  |  |
| Title: Program       | Title: Program Specialist Work Phone: (916) 808-1358 |      |  |  |  |  |
| Work Email: ktu      | Work Email: ktunson@sfd.cityofsacramento.org         |      |  |  |  |  |
| LFA Reviewer's Signa | ature:   | Date |  |  |  |  |

DGS DSA 810 (revised 12/29/20) Page 2 of 4 DIVISION OF THE STATE ARCHITECT DEPARTMENT OF GENERAL SERVICES STATE OF CALIFORNIA

1117 WINDFIELD WAY, SUITE 110 EL DORADO HILLS, CA 95762 | (916) 985-1870

Sacramento **City Unified School District** 

Sacramento City **Unified School District** 5735 47th Avenue Sacramento, CA 95824-4528

ONSULTANT:

ANTHONY J

Matsuyama Elementary 2023 Fencing

7680 Windbridge Drive Sacramento, CA 95831

**REVISIONS** DESCRIPTION 1 ADDENDUM NO.1

DRAWN: SCALE: AS NOTE CHECKED: PROJECT NO. 23-055 DESIGNED: 4/24/2023

ISSUANCE:

SHEET TITLE:


FIRE ACCESS **PLAN** 

SHEET NO.

C1.0.2

Know what's below.

THIS DRAWING MAY HAVE BEEN ENLARGED OR REDUCED.

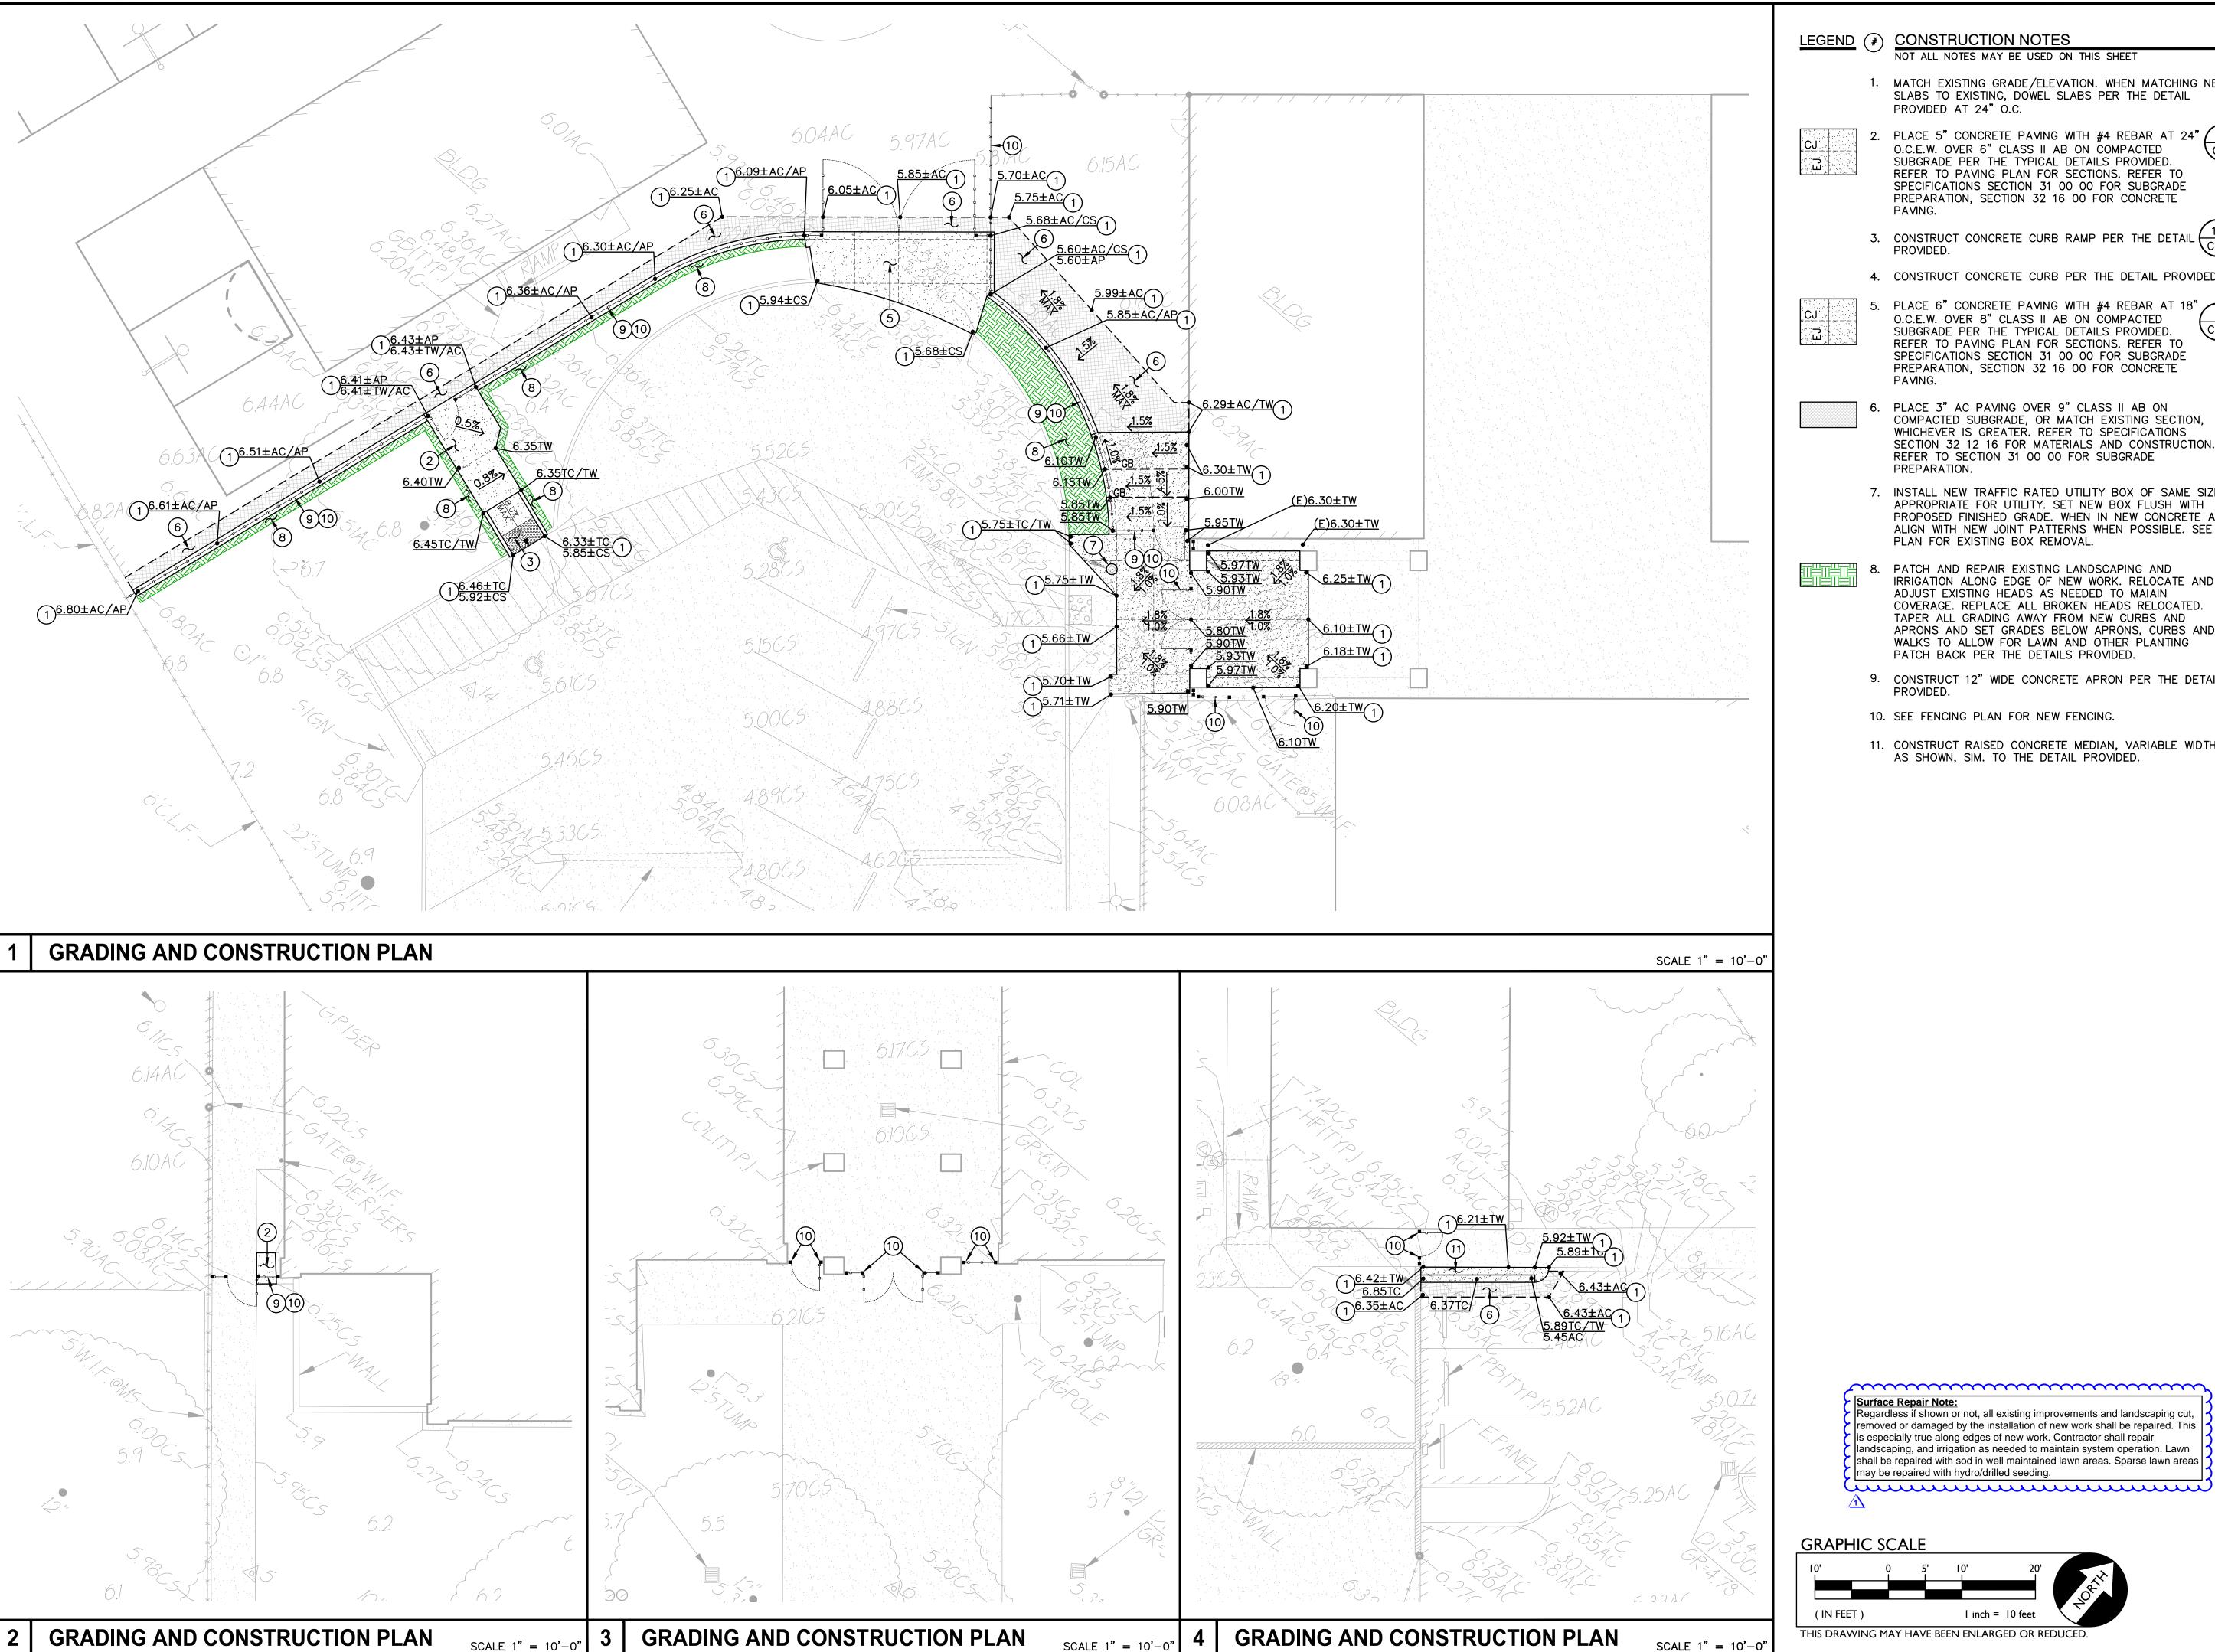

LEGEND (\*) CONSTRUCTION NOTES


MATCH EXISTING GRADE/ELEVATION. WHEN MATCHING NEW SLABS TO EXISTING, DOWEL SLABS PER THE DETAIL PROVIDED AT 24" O.C.

PLACE 5" CONCRETE PAVING WITH #4 REBAR AT 24" O.C.E.W. OVER 6" CLASS II AB ON COMPACTED SUBGRADE PER THE TYPICAL DETAILS PROVIDED. REFER TO PAVING PLAN FOR SECTIONS. REFER TO SPECIFICATIONS SECTION 31 00 00 FOR SUBGRADE PREPARATION, SECTION 32 16 00 FOR CONCRETE



4. CONSTRUCT CONCRETE CURB PER THE DETAIL PROVIDED. C4.1

PLACE 6" CONCRETE PAVING WITH #4 REBAR AT 18" O.C.E.W. OVER 8" CLASS II AB ON COMPACTED SUBGRADE PER THE TYPICAL DETAILS PROVIDED. REFER TO PAVING PLAN FOR SECTIONS. REFER TO SPECIFICATIONS SECTION 31 00 00 FOR SUBGRADE PREPARATION, SECTION 32 16 00 FOR CONCRETE

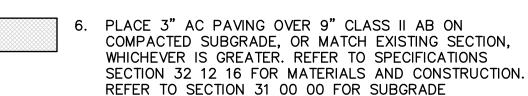

PREPARATION.

7. INSTALL NEW TRAFFIC RATED UTILITY BOX OF SAME SIZE AND APPROPRIATE FOR UTILITY. SET NEW BOX FLUSH WITH PROPOSED FINISHED GRADE. WHEN IN NEW CONCRETE AREAS, ALIGN WITH NEW JOINT PATTERNS WHEN POSSIBLE. SEE DEMO PLAN FOR EXISTING BOX REMOVAL.

PATCH AND REPAIR EXISTING LANDSCAPING AND IRRIGATION ALONG EDGE OF NEW WORK. RELOCATE AND  $\frac{2}{}$ ADJUST EXISTING HEADS AS NEEDED TO MAIAIN COVERAGE. REPLACE ALL BROKEN HEADS RELOCATED. TAPER ALL GRADING AWAY FROM NEW CURBS AND APRONS AND SET GRADES BELOW APRONS, CURBS AND WALKS TO ALLOW FOR LAWN AND OTHER PLANTING PATCH BACK PER THE DETAILS PROVIDED.

- 9. CONSTRUCT 12" WIDE CONCRETE APRON PER THE DETAIL PROVIDED.
- 10. SEE FENCING PLAN FOR NEW FENCING.
- 11. CONSTRUCT RAISED CONCRETE MEDIAN, VARIABLE WIDTH AS SHOWN, SIM. TO THE DETAIL PROVIDED.

C4.1





EL DORADO HILLS, CA 95762 | (916) 985-1870

Sacramento City Unified School District 5735 47th Avenue Sacramento, CA 95824-4528

CONSULTANT:

ANTHONY J.

Matsuyama Elementary 2023 Fencing

7680 Windbridge Drive Sacramento, CA 95831


|     | REVISIONS     |
|-----|---------------|
| NO. | DESCRIPTION   |
| 1   | ADDENDUM NO.1 |
|     |               |
|     |               |
|     |               |
|     |               |
|     |               |

SCALE: AS NOTE PROJECT NO. CHECKED: DESIGNED: SMN/AT 4/24/2023 ISSUANCE:

GRADING AND CONSTRUCTION PLAN

SHEET NO.

**C2.1** 

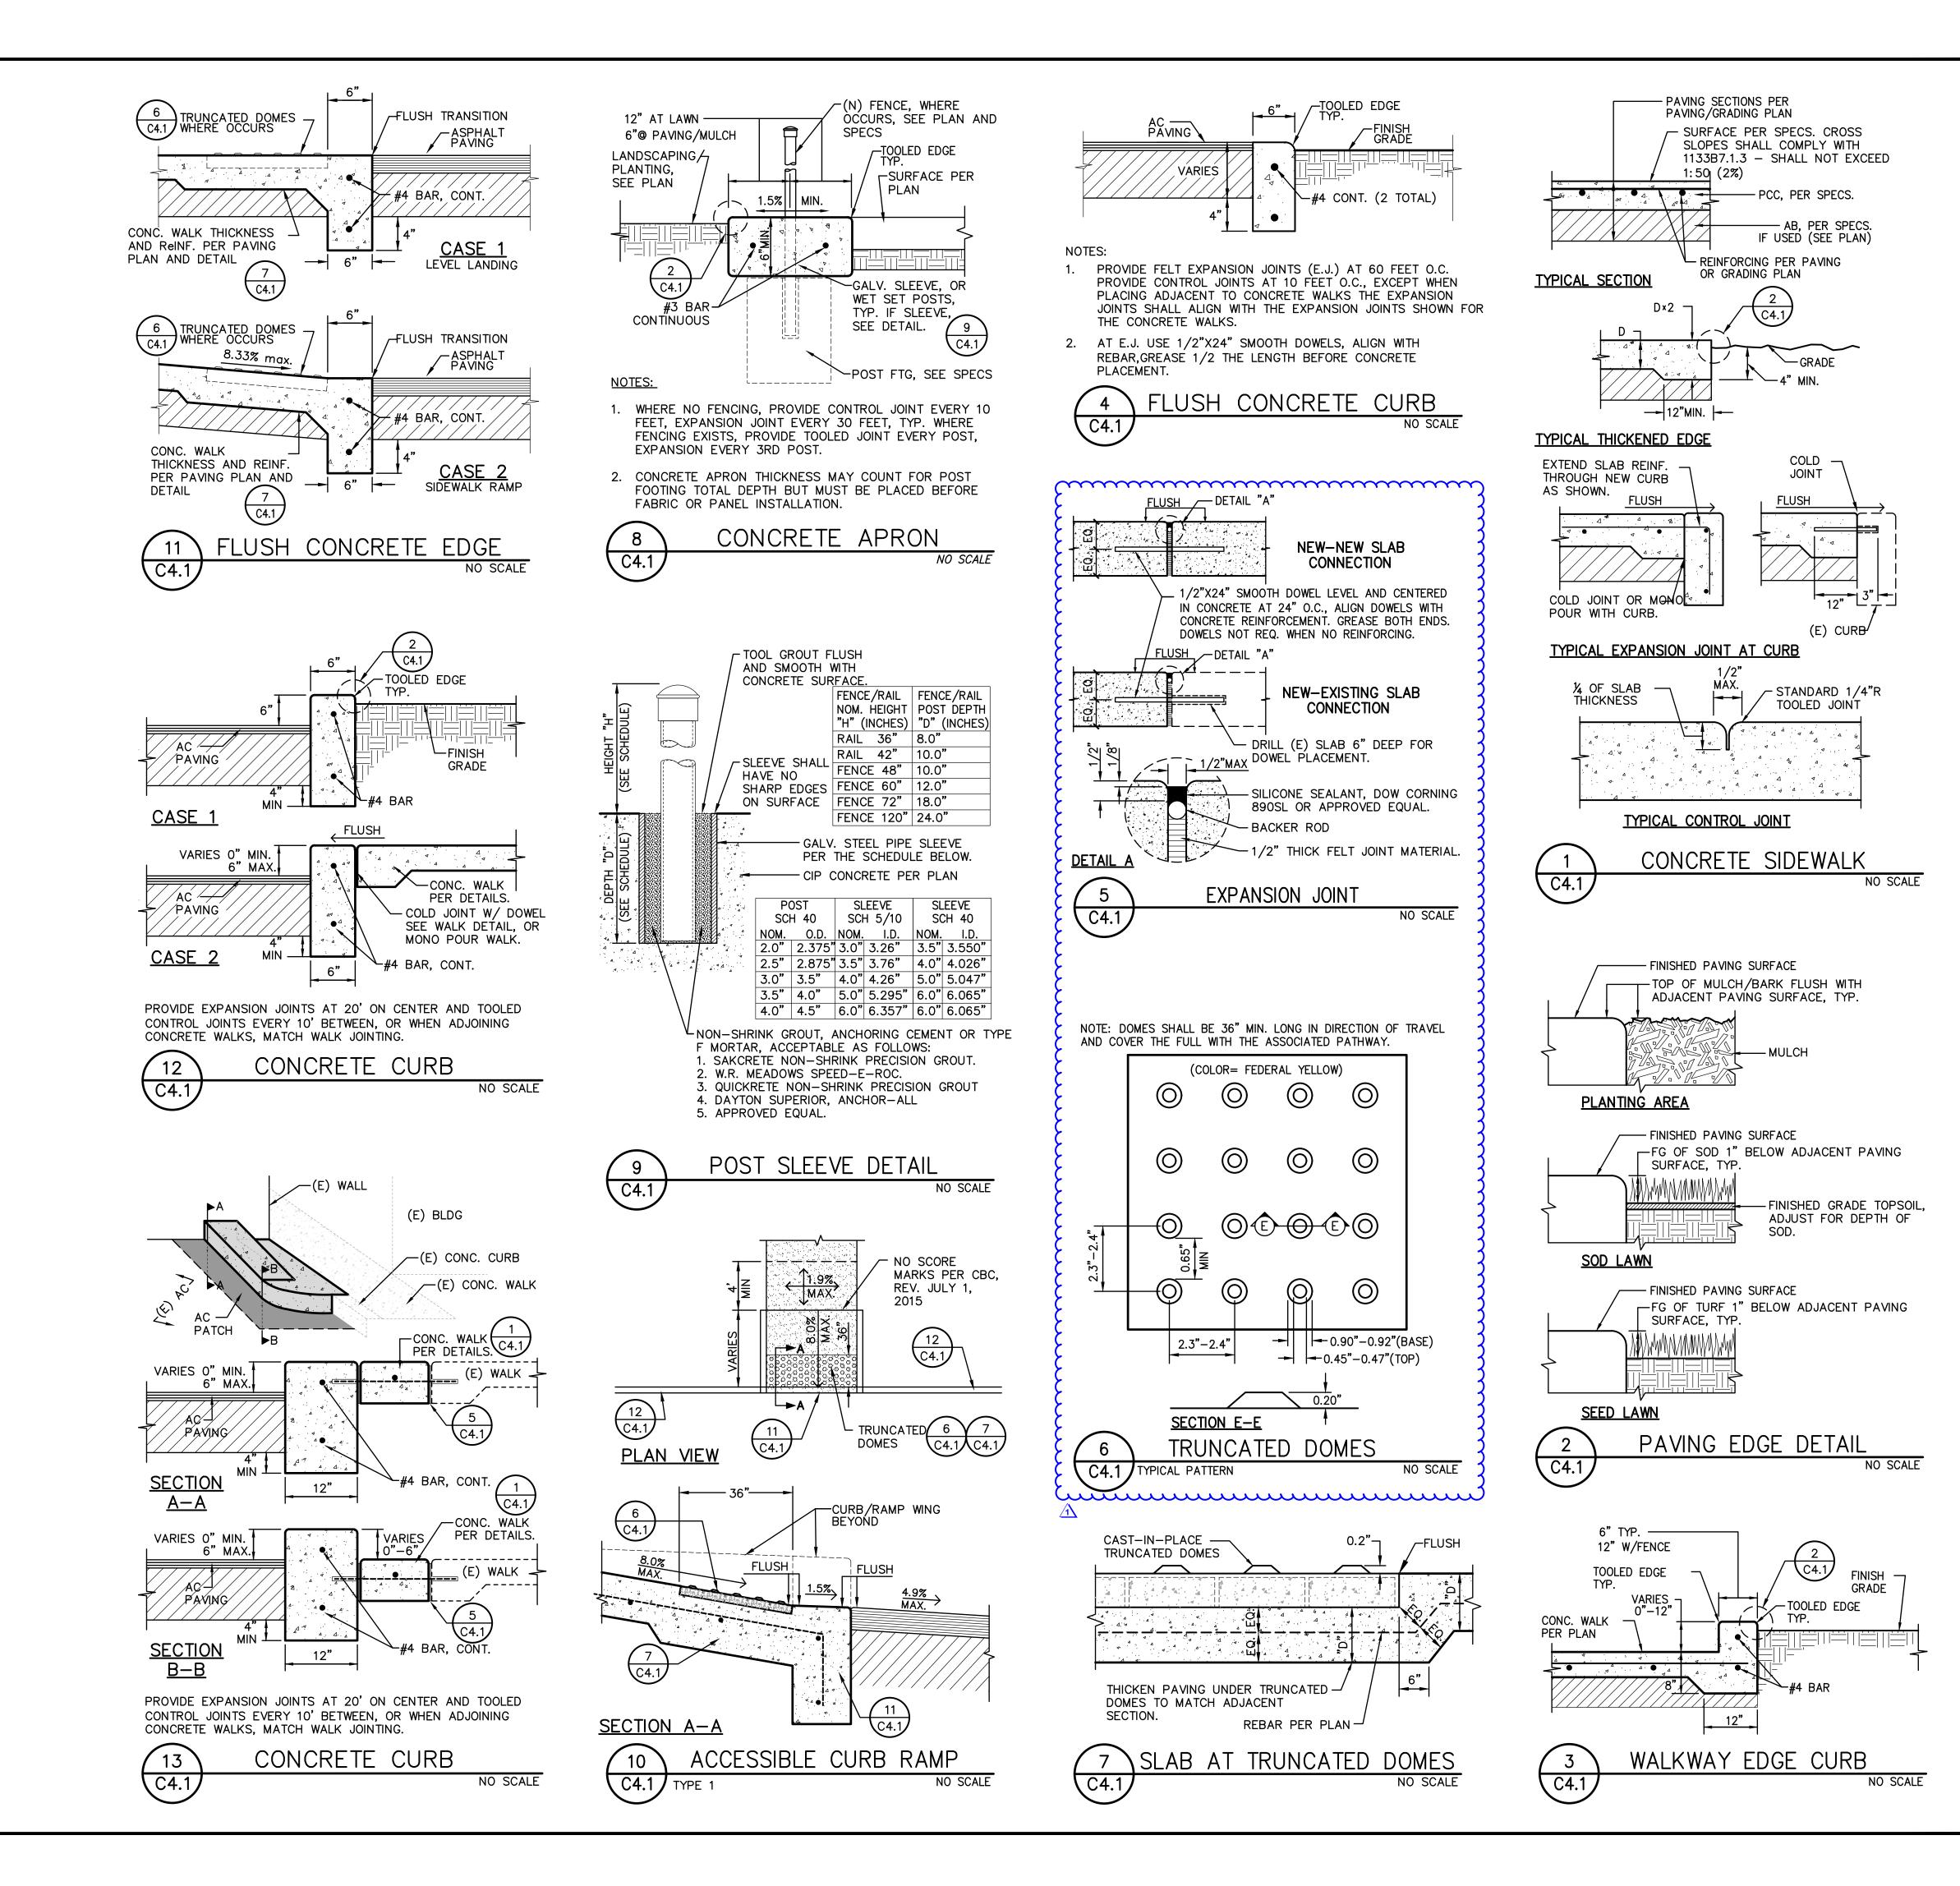

A

WARREN CONSULTING ENGINEERS, INC.
1117 WINDFIELD WAY, SUITE 110
EL DORADO HILLS, CA 95762 | (916) 985-1870

Sacramento City Unified School District

Sacramento City Unified School District 5735 47th Avenue Sacramento, CA 95824-4528

CONSULTANT:

STAMP:

ROFESSION

ANTHONY J.

TASSANO

NO. C74696

\*\*

OF CALIFORM

8/11/2023

Matsuyama Elementary 2023 Fencing

7680 Windbridge Drive Sacramento, CA 95831

REVISIONS

10. DESCRIPTION

ADDENDUM NO.1

DRAWN: SCALE:
SMN AS NOTED
CHECKED: PROJECT NO.
AT 23-055
DESIGNED: DATE:

4/24/2023

ISSUANCE:

SHEET TITLE:


DETAILS AND

SMN/AT

SECTIONS

SHEET NO.

C4.1

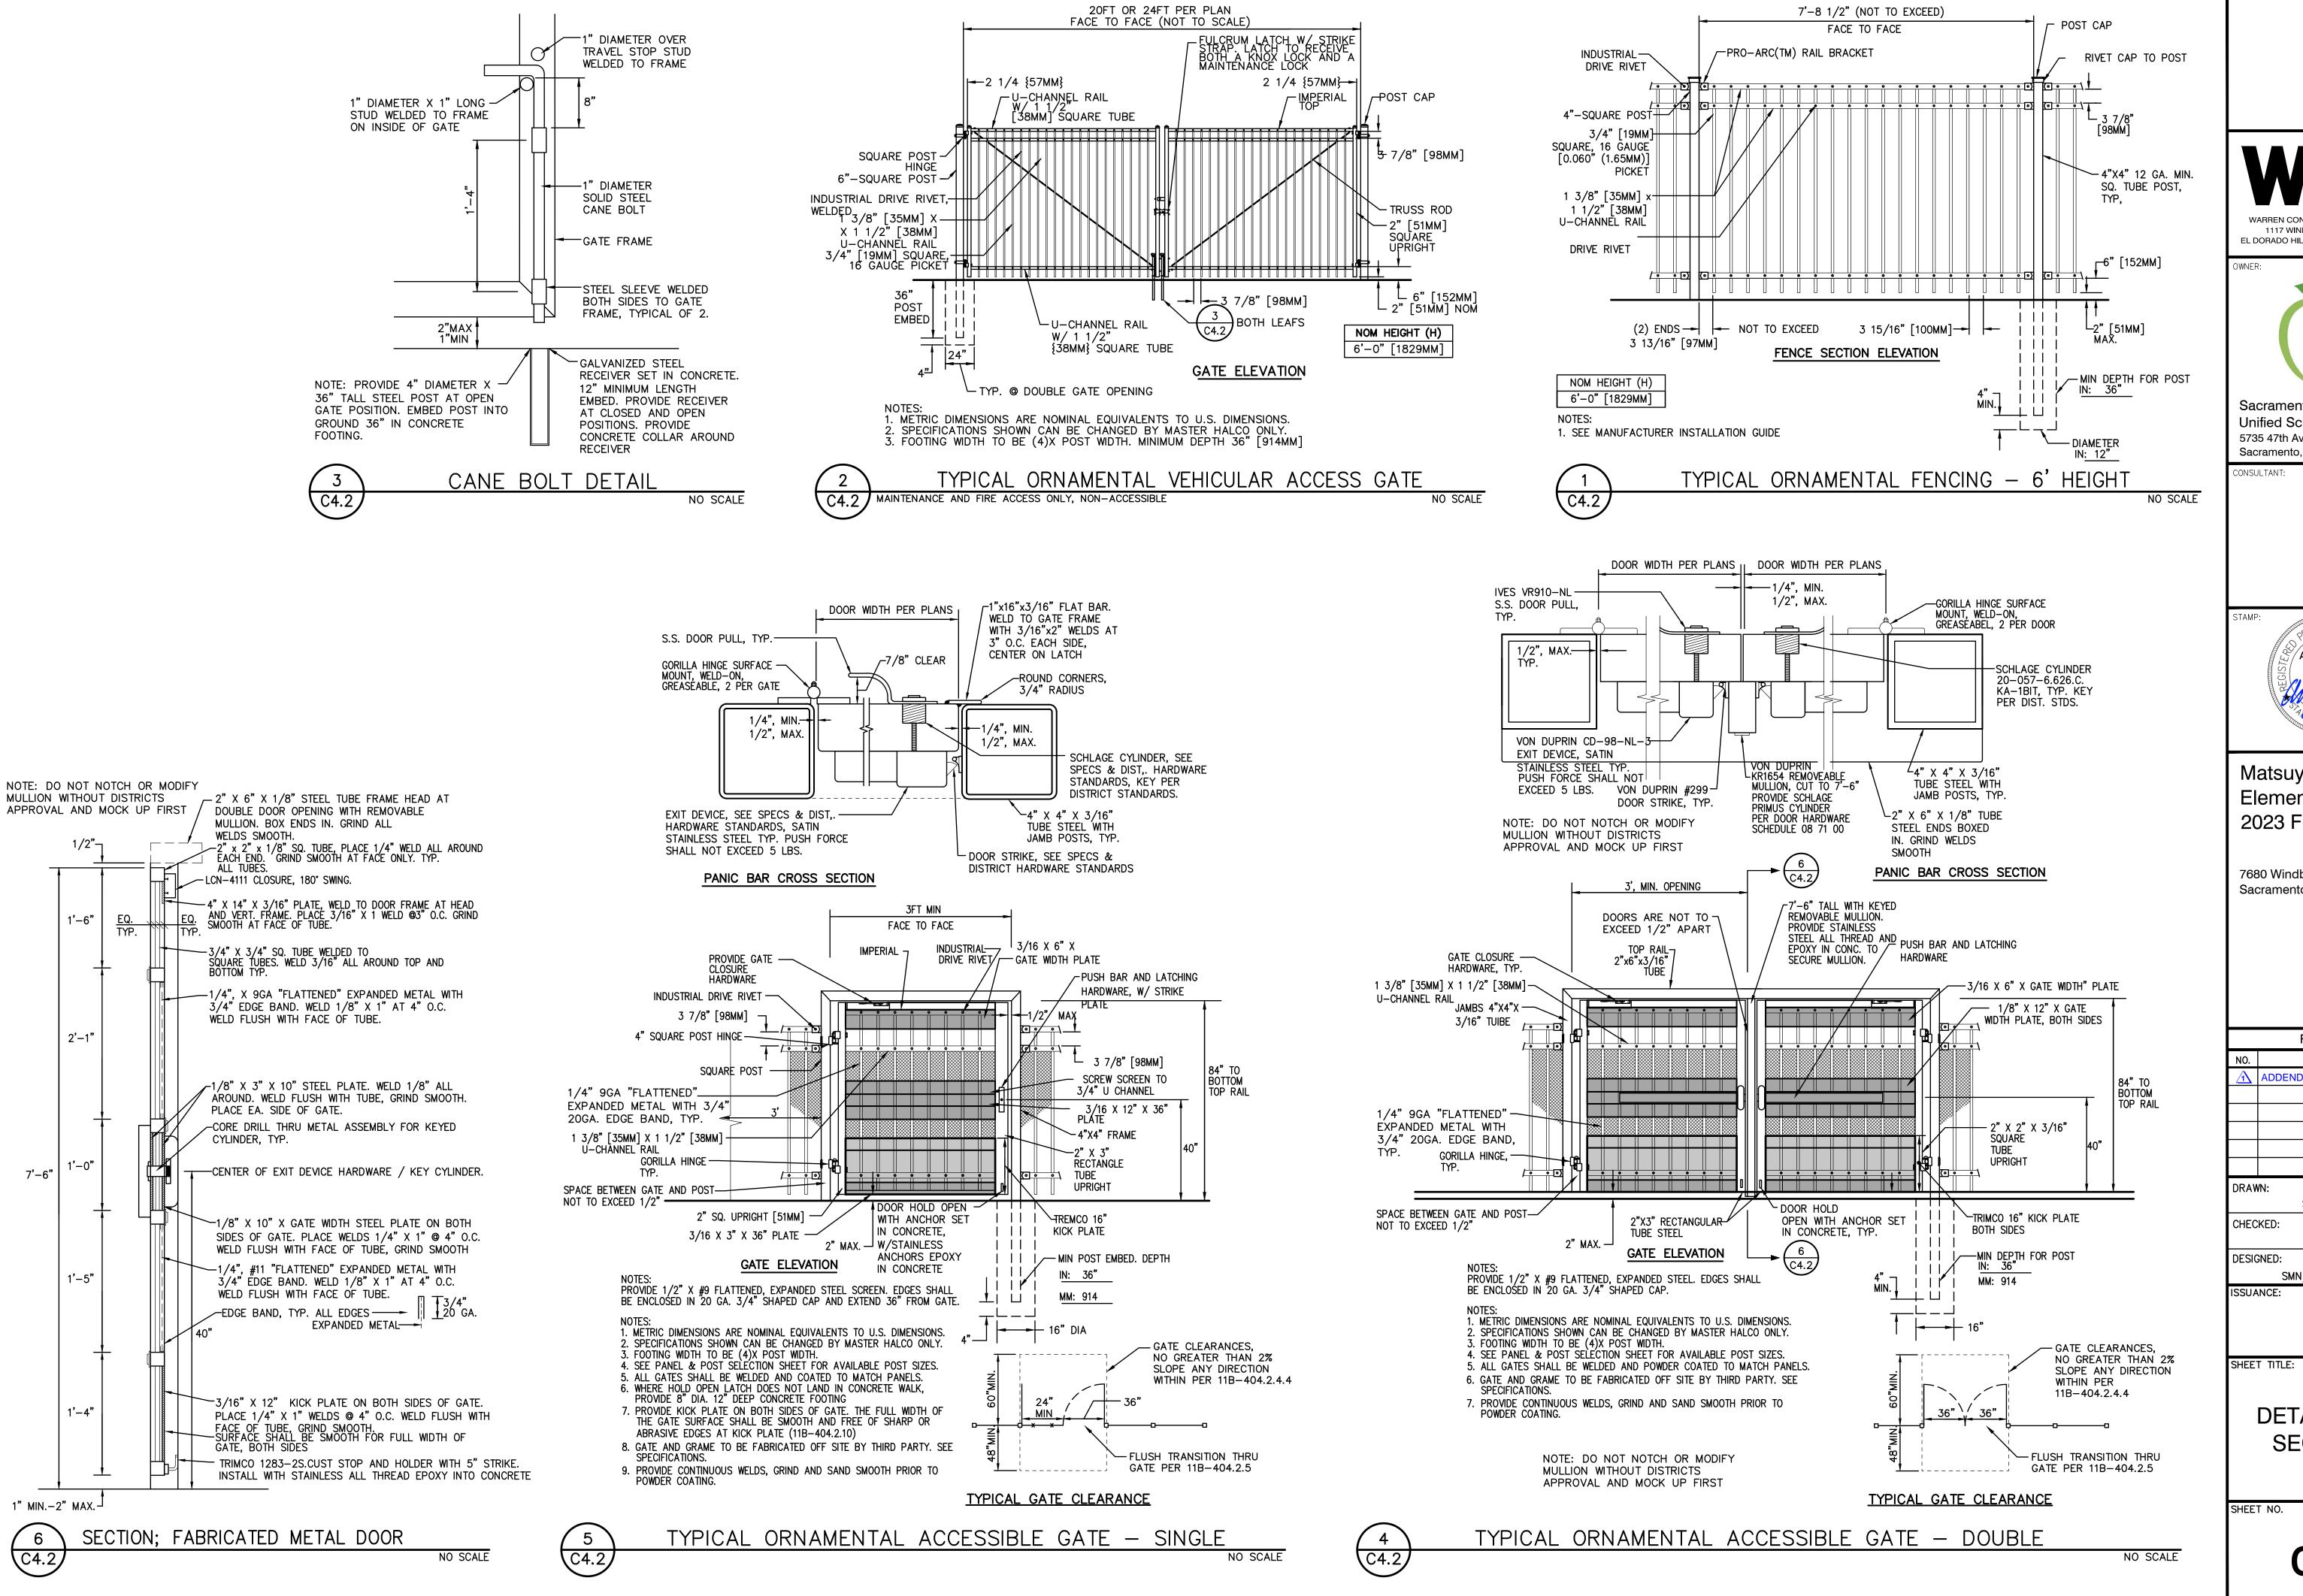

1117 WINDFIELD WAY, SUITE 110

EL DORADO HILLS, CA 95762 | (916) 985-1870

Sacramento **City Unified School District** 

Sacramento City **Unified School District** 5735 47th Avenue Sacramento, CA 95824-4528

ONSULTANT:

ANTHONY J. **TASSANO** 

# Matsuyama Elementary 2023 Fencing

7680 Windbridge Drive Sacramento, CA 95831

**REVISIONS** DESCRIPTION ADDENDUM NO.1

SCALE: DRAWN: AS NOTED CHECKED: PROJECT NO. 23-055


DATE:

SMN/AT 4/24/2023 ISSUANCE:

**DETAILS AND SECTIONS** 

SHEET NO.

**C4.2** 

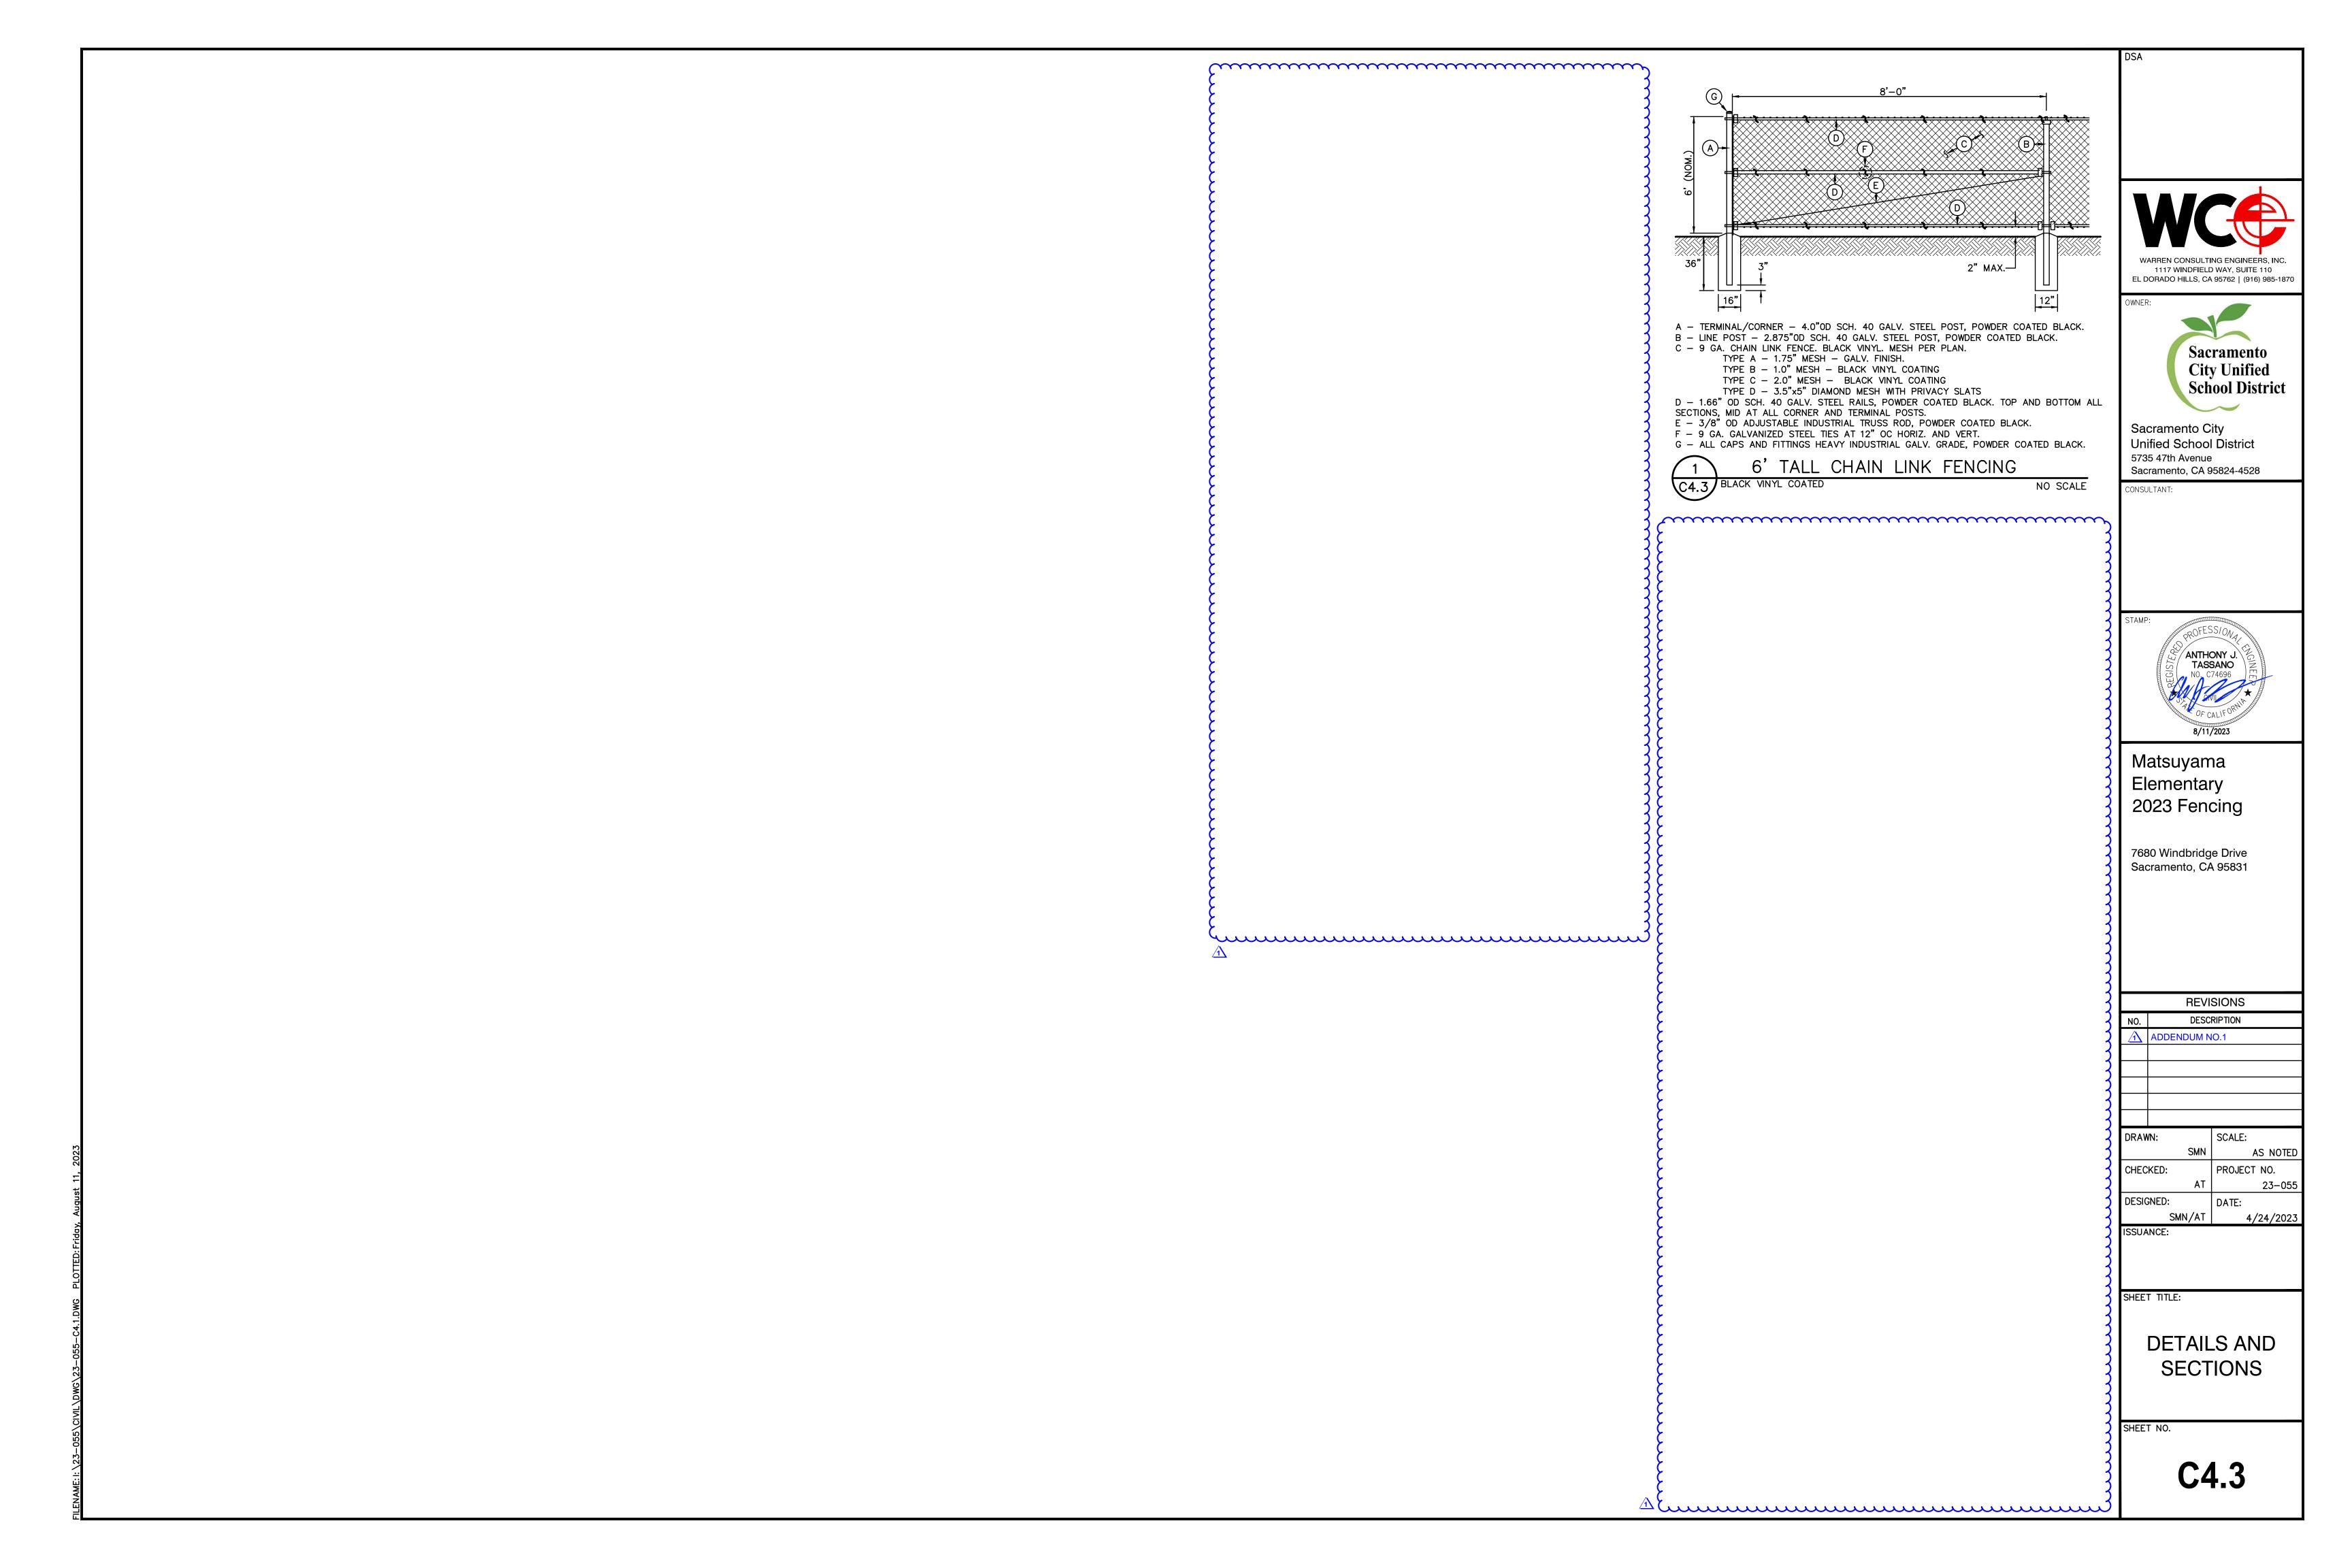


# PARKWAY ELEMENTARY SCHOOL 2023 FENCING

4720 Forest Parkway Sacramento, CA 95823






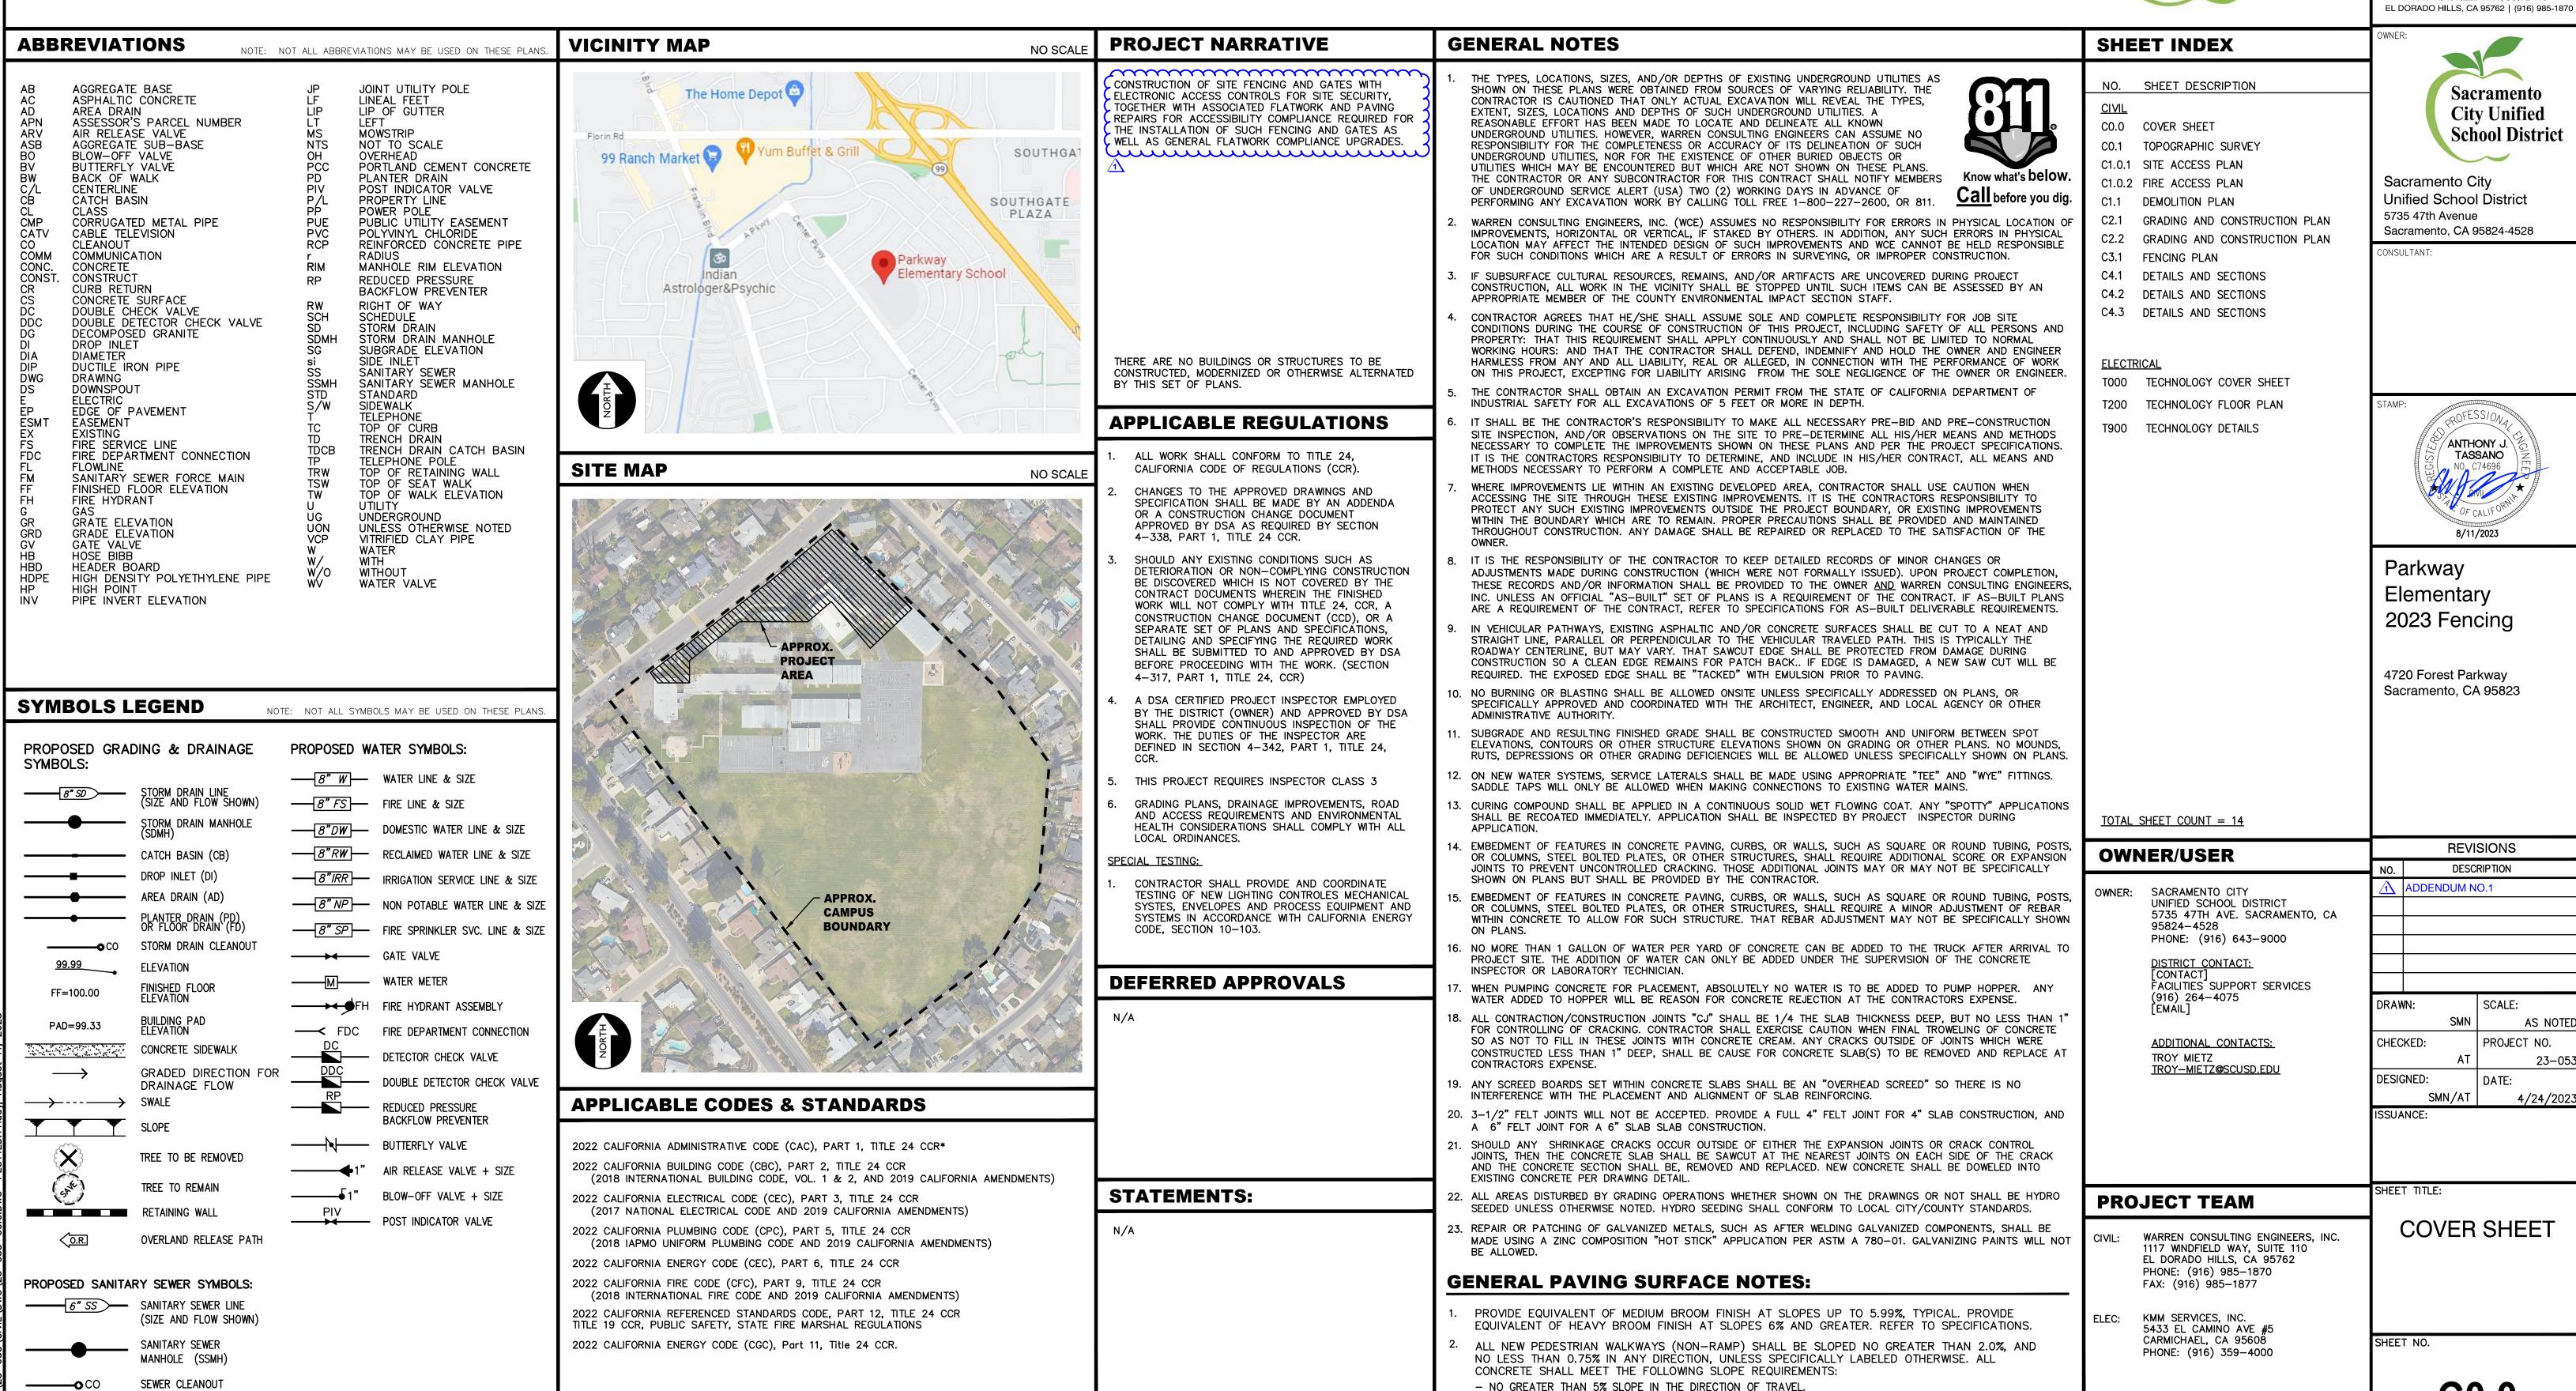


NO GREATER THAN 2% SLOPE CROSSING THE DIRECTION OF TRAVEL.

NO GREATER THAN 2% SLOPE IN ANY DIRECTION IN COURTYARD OR PLAZA AREAS.

FLUSHER BRANCH

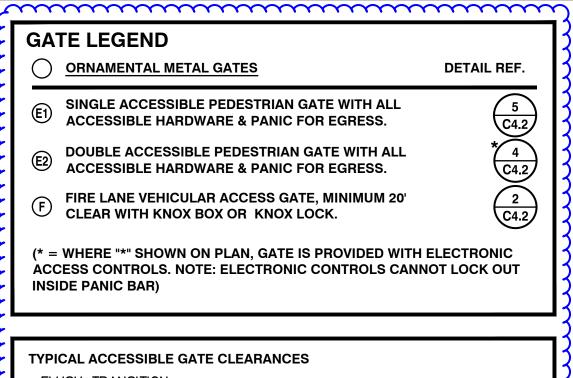

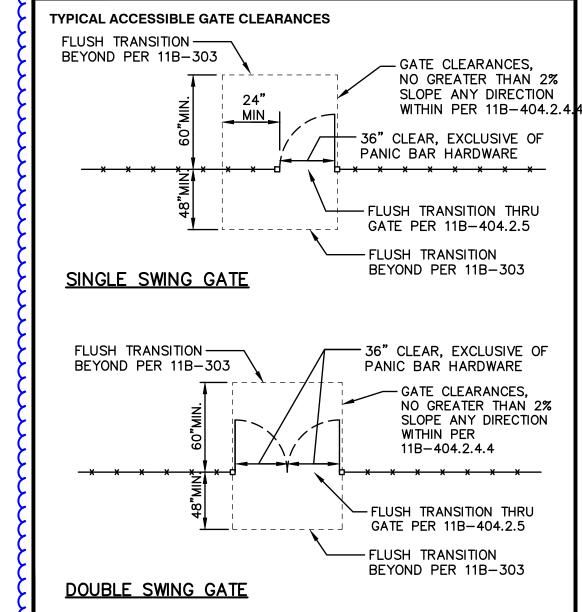

#### **GENERAL SITE PLAN AND ACCESS NOTES:**


I. Slope shall not be steeper than 1:48 in any direction in open areas." At least one accessible route within the boundary of the site shall be provided from public way, accessible parking, and accessible restrooms, to area of work.

2. Slopes in direction of P.O.T. greater than 1:20 are considered ramps(11B-405);

3. Walks in path of travel shall be free of gratings wherever possible. Grating which occur within the P.O.T. shall have grid openings at ½" maximum in the direction of traffic flow per CBC Section 11B-302.3; Provide manufactures cut-sheets for review.

4. When provided, all new gates and gates on path of travel must comply with 11B-404 requirements. Provide a 24" min. Strike side clearance on pull side and a smooth surface at the bottom 10 inches of push side of gate. Specify accessible / lever hardware.

SITE ACCESS PLAN

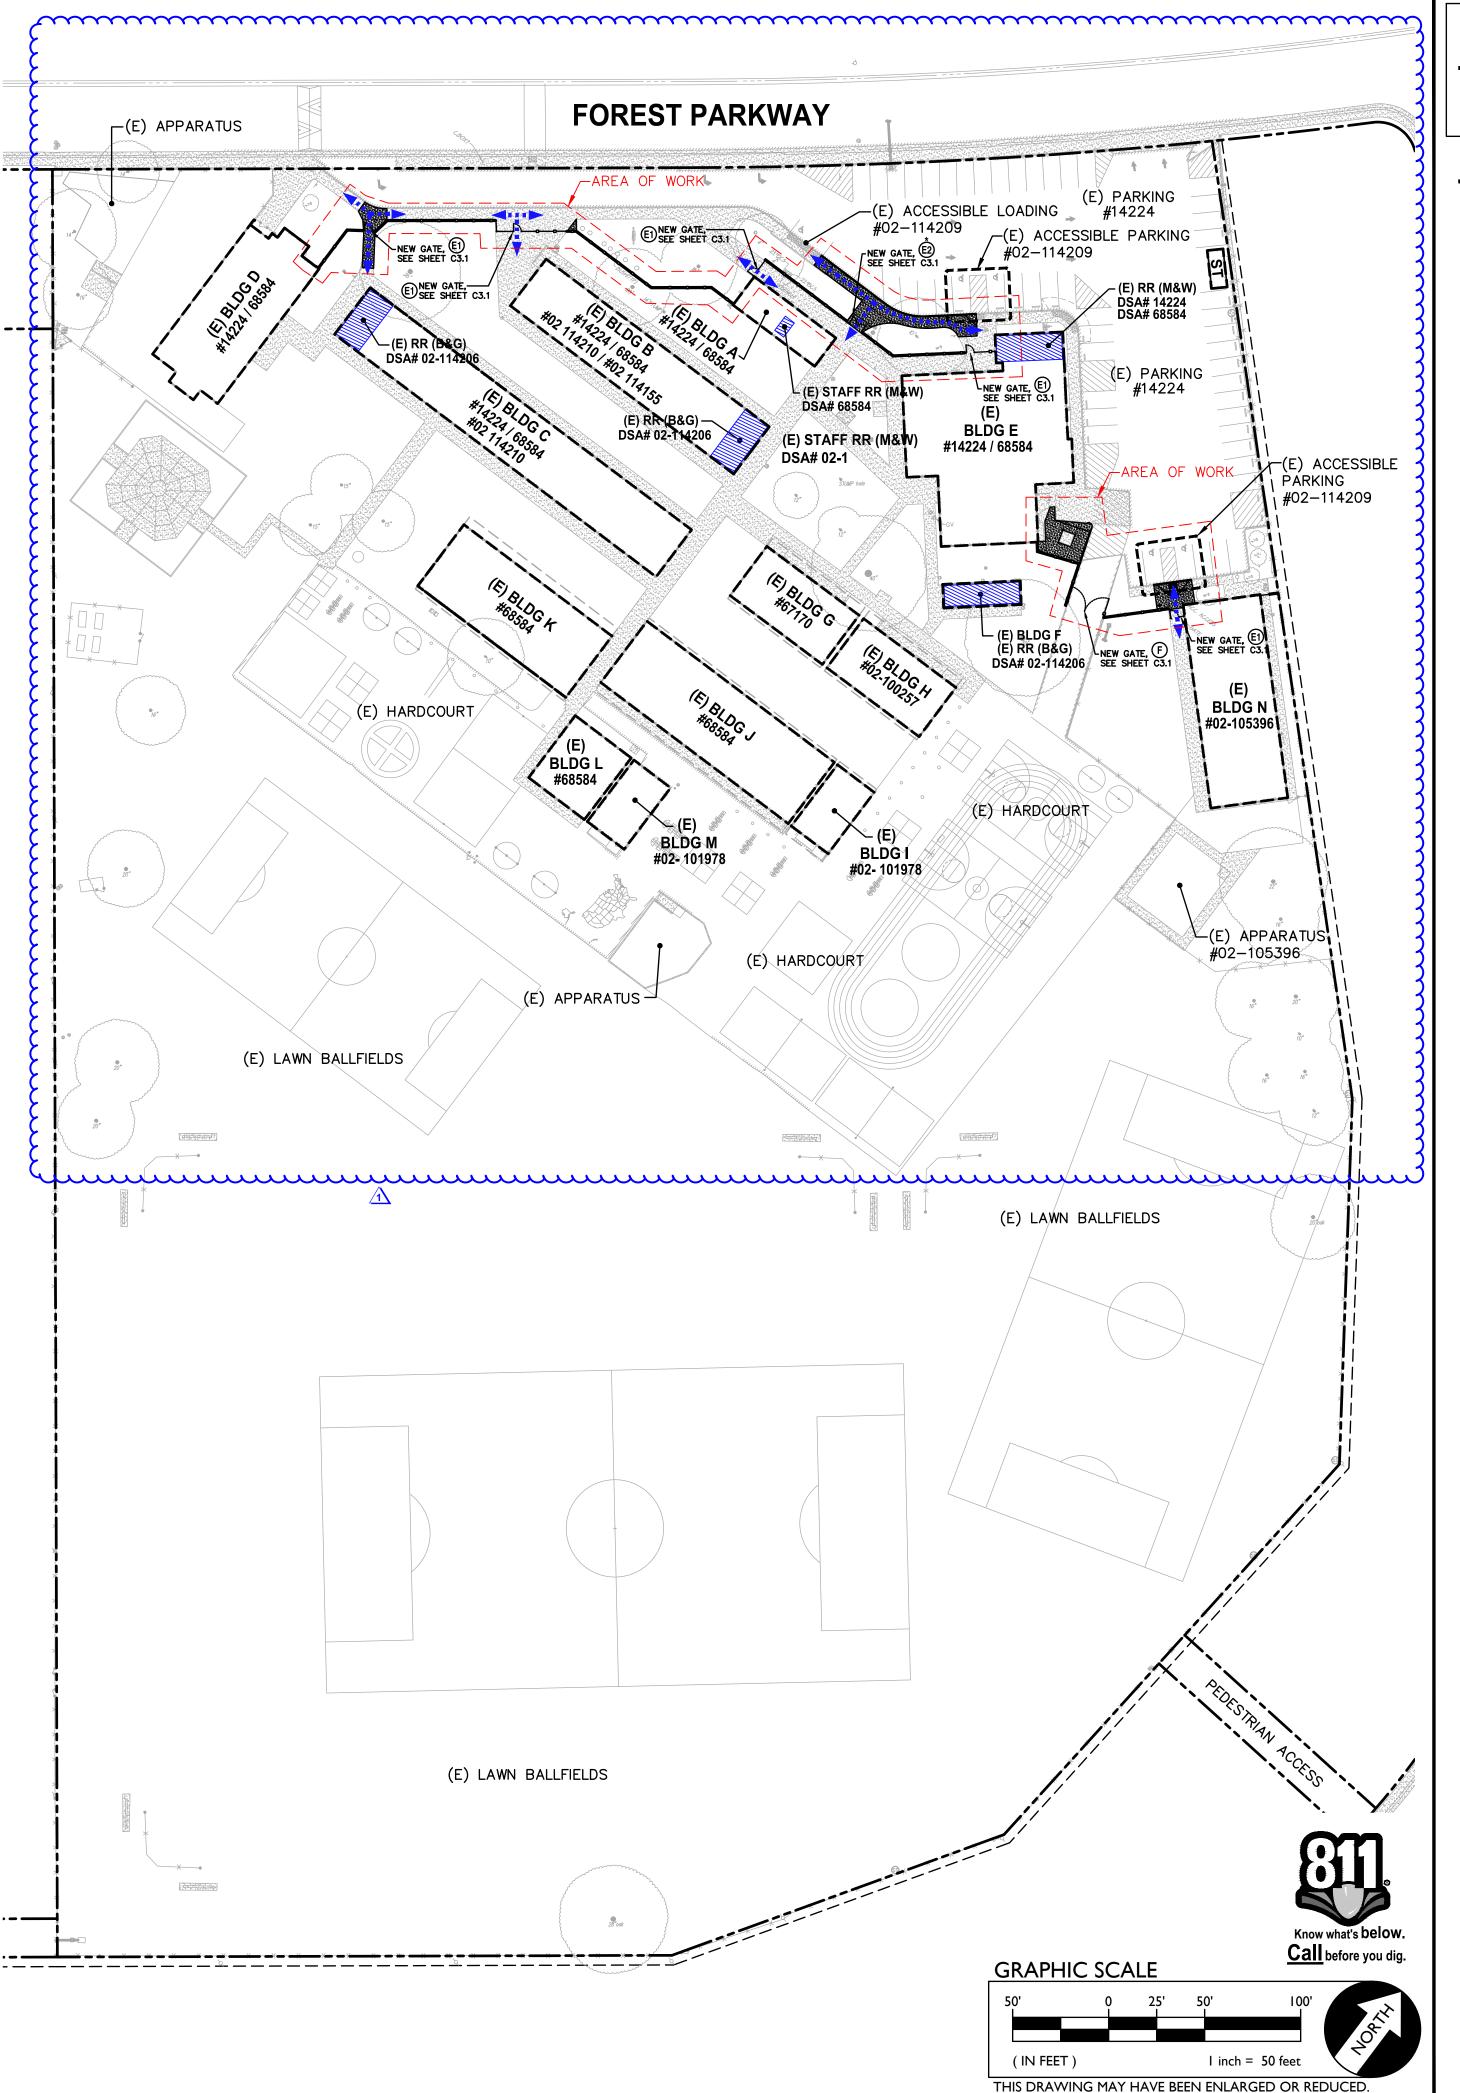

# **FENCEING ONLY PROJECT ACCESSIBLE PATH OF TRAVEL**

IN ACCORDANCE WITH DSA IR A-22, ITEM NO. 12, KEYNOTE 4, THE ACCESSIBLE PATH OF TRAVEL REVIEW SHALL BE LIMITED TO WHERE NEW FENCES AND GATES AFFECT/CROSS AN ACCESSIBLE PATH OF TRAVEL.

# **ACCESSIBLE PATH OF TRAVEL (P.O.T.)**

TO THE BEST OF THE KNOWLEDGE OF THE ARCHITECT AND/OR ENGINEER, OR THE DISTRICT, THE PATH OF TRAVEL (P.O.T.) AS INDICATED, IS A BARRIER FREE ACCESS ROUTE CONFORMING TO THE FOLLOWING:

THERE ARE NO ABRUPT LEVEL CHANGES EXCEEDING 1/2" IF BEVELED AT 1V:2H MAX SLOPE, OR VERTICAL LEVEL CHANGES NOT EXCEEDING

- THE MINIMUM WIDTH OF THE P.O.T. IS 48" AT ANY GIVEN POINT.
- . THE SURFACE OF THE P.O.T. STABLE, FIRM, AND SLIP RESISTANT. (11B-403.2)
- THE MAXIMUM SLOPE IN THE DIRECTION OF TRAVEL IS 5.0% (11B-403.3), UNLESS OTHERWISE INDICATED, WITH THE FOLLOWING EXCEPTIONS:
- A. THE SLOPED PORTION OF "RAMP" DOES NOT EXCEED 8.33% (1V:12H) IN THE DIRECTION OF TRAVEL (11B-405.2).
- B. THE SLOPED PORTION OF A "CURB RAMP" DOES NOT EXCEED 8.33% (1V:12H) IN THE DIRECTION OF TRAVEL (11B-406.2.1 AND
- THE CROSS SLOPE OF THE ACCESSIBLE PATH OF TRAVEL DOES NOT EXCEED 2% AT ANY GIVEN POINT (11B-403.3).
- 6. THE ACCESSIBLE PATH OF TRAVEL SHALL BE MAINTAINED FREE OF OVERHANGING OBSTRUCTIONS TO 80" MINIMUM (11B-307).
- THERE ARE NO PROTRUDING OBJECTS GREATER THAN 4" PROJECTION FROM WALL AND ABOVE 27" AND LESS THAN 80" (11B-307).
- 8. PASSING SPACES AT LEAST 60"X60" ARE LOCATED NOT MORE THAT 200' APART. (11B-403.5.3)
- . PARTS OF P.O.T. WITH CONTINUOUS GRADIENTS HAVE 60" LEVEL AREAS NOT MORE THAN 400' APART. (11B-407.3)
- 10. THERE IS NO DROP-OFF OVER 4" AT THE EDGE OF WALK OR LANDING. (11B-303.5)
- 11. ARCHITECT AND CONTRACTOR SHALL VERIFY THAT ALL BARRIERS ON
- 12. THERE ARE NO GRATINGS WITHIN THE PATH OF TRAVEL WITH GRATE
- OPENINGS EXCEEDING 1/2" IN THE DIRECTION OF TRAVEL. (11B-302.3)

#### **DSA PR-1501**

#### "Design Professional in General Responsible Charge Statement:


THE INDICATED PATH OF TRAVEL HAVE BEEN REMOVED.

The POT identified in these construction documents meets the requirements of the current applicable California Building Code (CBC) accessibility provisions for path of travel requirements for alterations, additions and structural repairs. As part of the design of this project, the POT was examined and any elements, components or portions of the POT that were determined to be noncompliant with the CBC have been identified and the corrective work necessary to bring them into compliance has been included within the scope of this project's work through details, drawings and specifications incorporated into these construction documents. Any noncompliant elements, components or portions of the POT that will not be corrected by this project based on valuation threshold limitations or a finding of unreasonable hardship are indicated in these construction documents.

During construction, if POT items within the scope of the project represented as CBC compliant are found to be nonconforming beyond reasonable construction tolerances, the items shall be brought into compliance with the CBC as a part of this project by means of a construction change document."

# PROJECT PARKING CALCULATION

| PARKING LOT A PARKING TOTALS                                      | EXISTING | PROPOSED |
|---|----------|----------|
| STANDARD PARKING STALLS ACCESSIBLE PARKING SPACES                 | 48<br>4  | 48<br>4  |
| OVERALL TOTAL PARKING SPACES                                      | 52       | 52       |
| (E) ACCESSIBLE SPACE REQUIREMENTS                                 | REQUIRED | PROVIDED |
| REQUIRED ACCESSIBLE SPACES (CAR) REQUIRED ACCESSIBLE SPACES (VAN) | 2<br>1   | 2<br>2   |
| TOTAL REQUIRED ACCESSIBLE SPACES                                  | 3        | 4        |

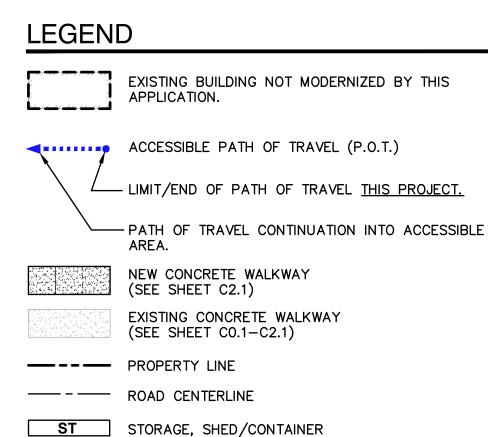

---- AREA OF WORK

SCALE 1" = 50' - 0"

(PER 2019 CBC SECTION 11B-208.2)

ACCESSIBLE RESTROOM (PROJECT COMPLIANCE)

C1.0.1

1117 WINDFIELD WAY, SUITE 110 EL DORADO HILLS, CA 95762 | (916) 985-1870



Sacramento City **Unified School District** 5735 47th Avenue Sacramento, CA 95824-4528

ONSULTANT:



Parkway Elementary 2023 Fencing

4720 Forest Parkway Sacramento, CA 95823

**REVISIONS** DESCRIPTION ADDENDUM NO.1

| AWN:    | SCALE:      |
|---------|-------------|
| SMN     | AS NOTE     |
| ECKED:  | PROJECT NO. |
| AT      | 23-05       |
| SIGNED: | DATE:       |
| SMN/AT  | 4/24/202    |
| UANCE:  |             |

SHEET TITLE:

SITE ACCESS

**PLAN** 

SHEET NO.

# FIRE LANE DESIGNATION

ALL FIRE LANES ON THIS PLAN SHALL BE DESIGNATED IN ACCORDANCE WITH THE STRIPING PLANS, UTILIZING ONE OF THE FOLLOWING APPROVED MEANS:

- . CURBS PAINT CURB TOP AND FACE RED WITH COMMERCIAL GRADE RED TRAFFIC PAINT. ON FACE OF CURB, PAINT 4" TALL WHITE LETTERING STATING "NO PARKING - FIRE LANE" AT 25' O.C. CENTERED ON FACE.
- 2. PAVING PAINT 6" WIDE RED STRIPE ON PAVEMENT WITH COMMERCIAL GRADE RED TRAFFIC PAINT. CENTERED IN STRIPE, PAINT 4" TALL WHITE LETTERING STATING "NO PARKING - FIRE LANE" AT 25' O.C.
- 3. SIGNAGE POSTING OF SIGNS COMPLIANT WITH CFC 2016, APPENDIX D103.6 EVERY 50 FEET.

#### **EXCEPTIONS:**

- STREETS 20' WIDE TO 26' WIDE SHALL BE MARKED ON BOTH SIDES AS STATED ABOVE.
- STREETS GREATER THAN 26' WIDE NEED ONLY MARKING ON
- ONE SIDE AS STATED ABOVE. EDGES OF FIRE LANES AT PARKING DO NOT REQUIRE DESIGNATION.

SEE STRIPING PLAN FOR ACTUAL REQUIRED STRIPING.

# KNOX NOTES

ALL GATES WHICH CROSS THE FIRE LANE AS DESIGNATED BY THIS PLAN SHALL BE OUTFITTED WITH A LOW LEVEL KNOX LOCK.

ALL FIRE CONTROL ROOMS FOR THIS PROJECT SHALL BE OUTFITTED WITH A HIGH LEVEL KNOX BOX AT A LOCATION WHICH IS APPROVED BY THE SACRAMENTO METROPOLITAN FIRE DISTRICT INSPECTOR.

# PAVEMENT NOTES

FIRE ACCESS ROADWAYS SHALL BE BUILT TO BEAR A MINIMUM OF 75,000 POUNDS IN ACCORDANCE WITH CFC 2022, APPENDIX D.

> CLEAR WIDTH 20 FEET CLEAR HEIGHT 13.5 FEET INSIDE RADIUS 35 FEET MIN. OUTSIDE RADIUS 55 FEET MIN.

# NOTE:

All new and existing fire lanes are asphalt or concrete paved unless otherwise stated.

# MULTI PURPOSE EGRESS ANALYSIS

APPROXIMATE FLOOR AREA 2,678 SF. LOAD FACTOR: ASSEMBLY (CONCENTRATED): 7 NET RESULTING OCCUPANT LOAD: 383 EGRESS SIZING, LOAD  $\times$  0.2 = (IN INCH)


 $383 \times 0.2 = 77 \text{ INCHES}$ 

EGRESS WIDTH PROVIDED:

(1) DOUBLE GATE(1) SINGLE GATE =108 INCHES

(REF CBC 1004 AND 1005)

(1005.3.2)

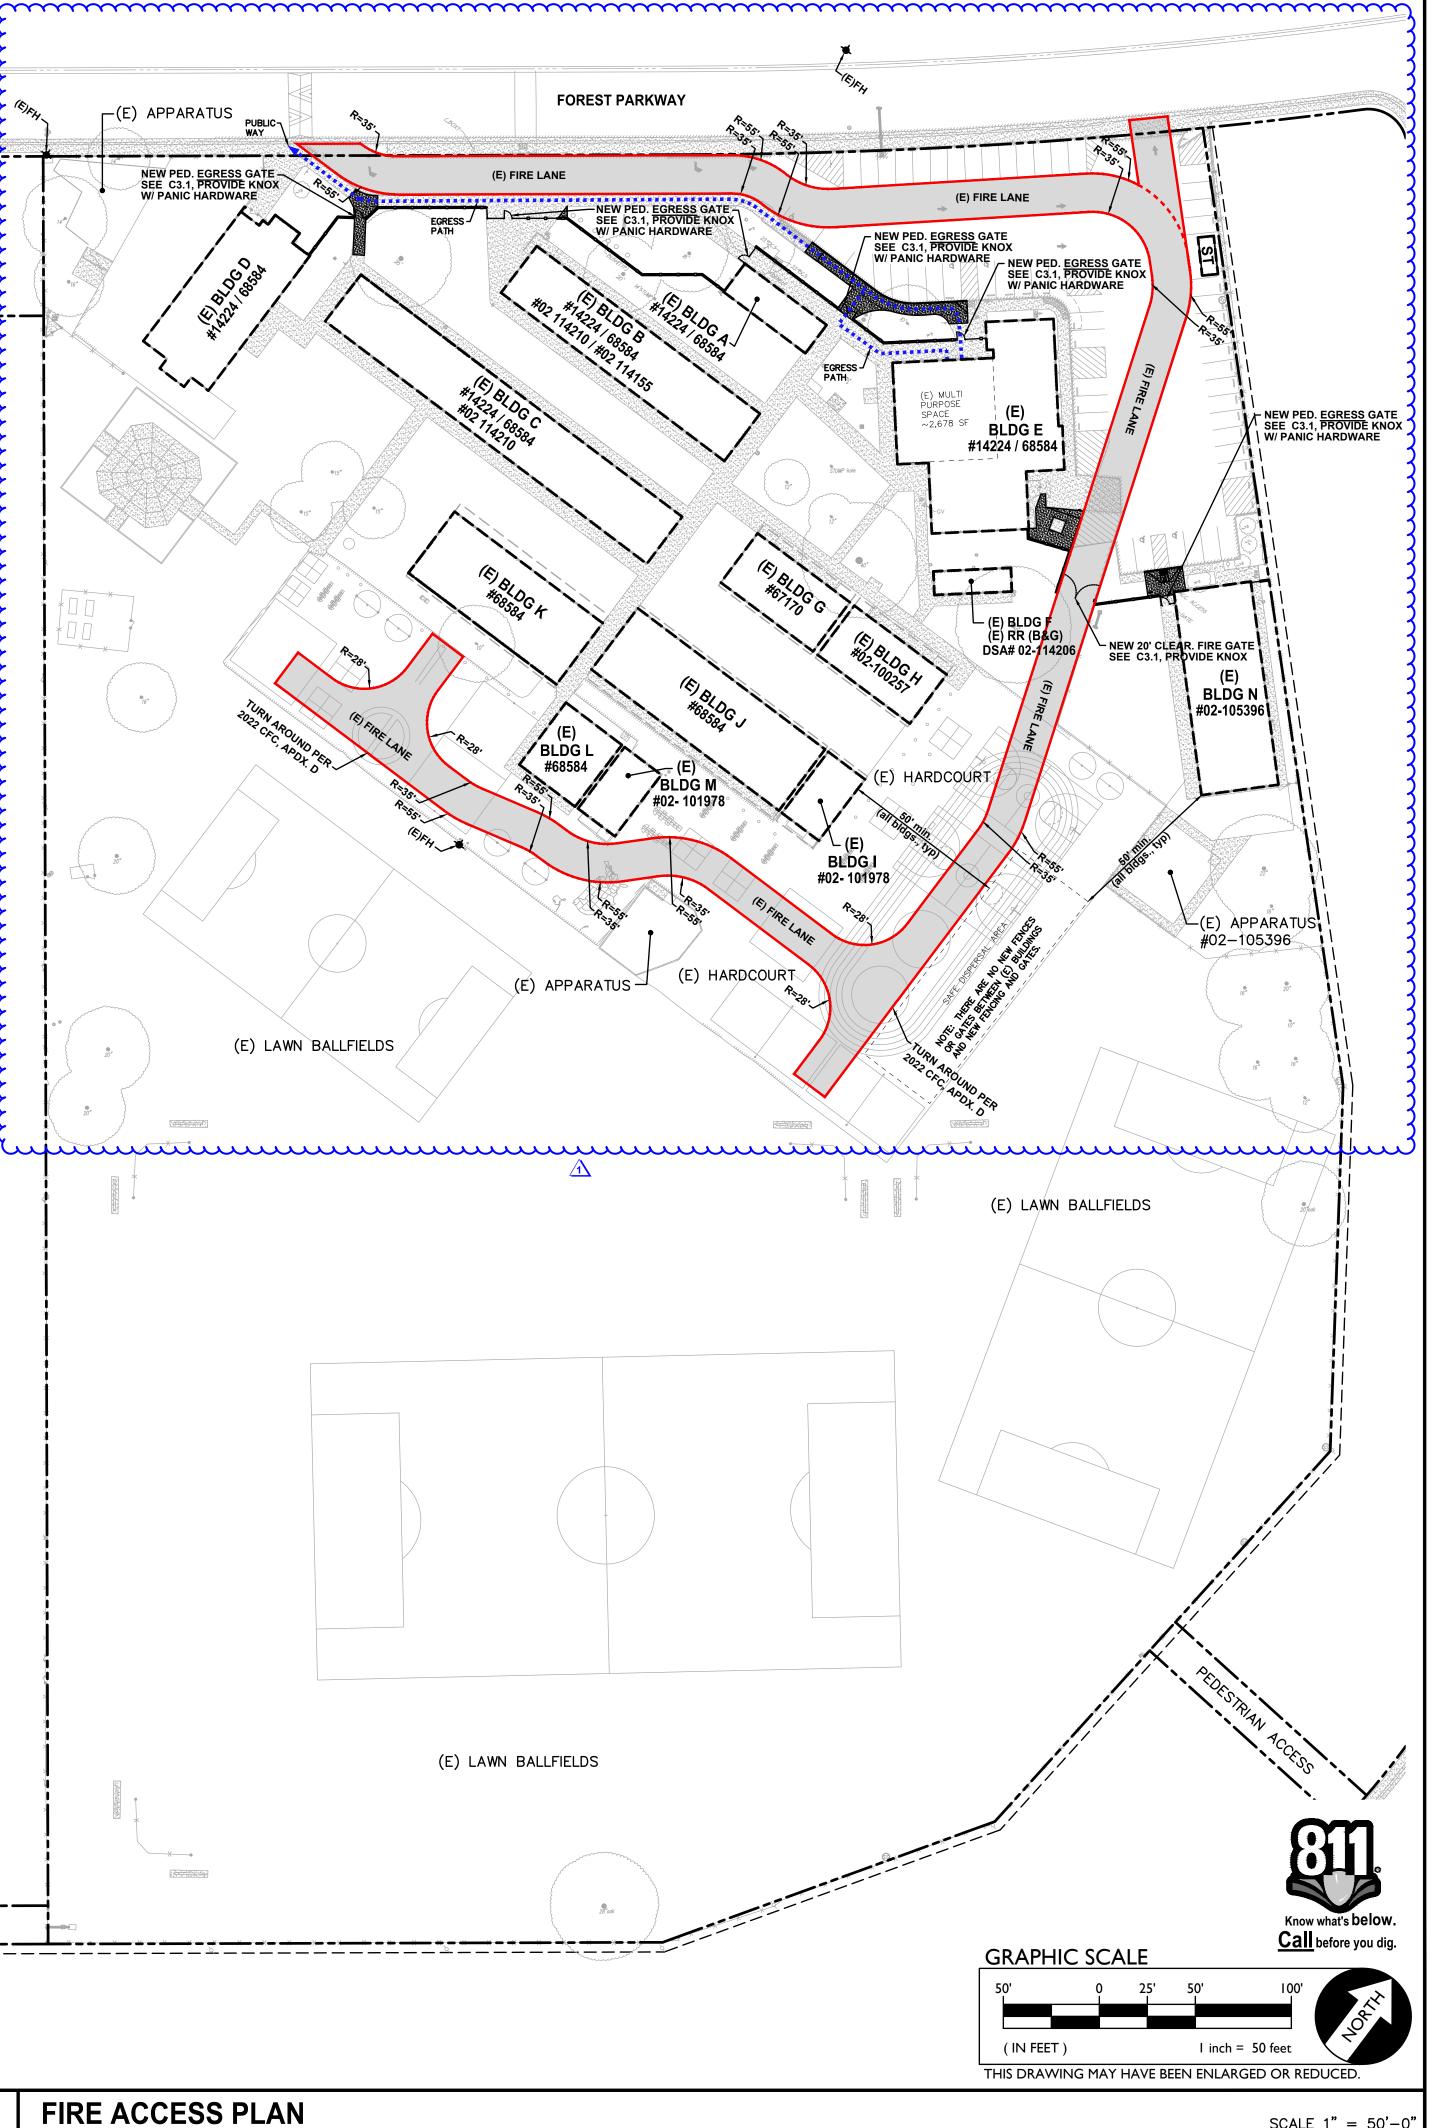

# **ADSA**

# FIRE & LIFE SAFETY SITE CONDITIONS SUBMITTAL


Division of the State Architect (DSA) documents referenced within this publication are available on the DSA Forms or DSA Publications webpages.

To facilitate the Division of the State Architect's (DSA) fire and life safety plan review of project site conditions, DSA requires the design professional to provide the following information at time of project submittal for projects consisting of construction of a new campus, construction of new building(s), additions to existing buildings, and for site alternate design means for fire department emergency vehicle access, and fire suppression water supply.

Information associated with compliance items 1 through 3 below is to be provided for all project types indicated above. Information associated with items 4 through 7 is to be completed when an alternate means is utilized. Acknowledgement by the school district and signature from the Local Fire Authority (LFA) is only required when an alternate design means is being requested.

The Project Information and Fire & Life Safety Information sections are to be completed for all projects and imaged onto the fire access site plan. When an alternate design/means is proposed, all sections on pages 1 and 2 are to be completed and imaged on the fire access site plan.

For additional information refer to the instructions at the end of this form and DSA Policy PL 09-01: Fire Flow for

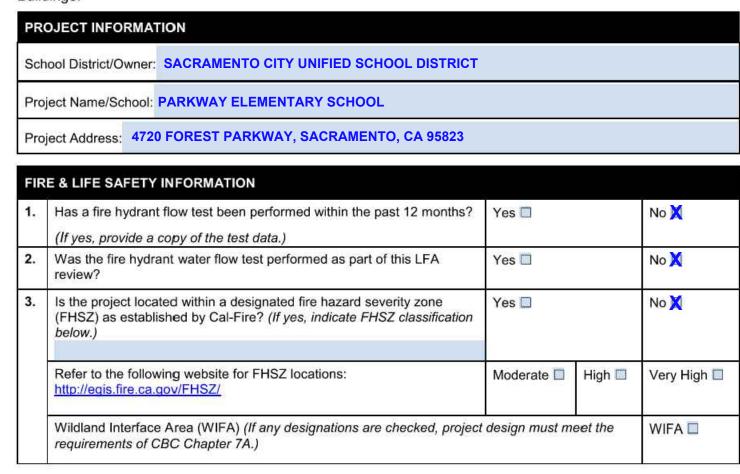

Page 1 of 4 DGS DSA 810 (revised 12/29/20) DEPARTMENT OF GENERAL SERVICES STATE OF CALIFORNIA DIVISION OF THE STATE ARCHITECT

# FIRE & LIFE SAFETY SITE CONDITIONS SUBMITTAL

| CON | CONDITION MEANS AND METHODS RESOLUTION   |     | ALTERNATE ACCEPTED |     |     |  |  |
|-----|--|-----|--------------------|-----|-----|--|--|
| 4.  | Emergency vehicle access roadways do not meet CFC requirements.  | Yes | No                 | N/A | N/I |  |  |
| ٠.  |  |     |                    | X   |     |  |  |
| 4a. | Acceptable Alternate: Emergency vehicle and personnel access as proposed by the project architect is acceptable for providing fire suppression and protection of life and property.                          |     |                    |     |     |  |  |
| 5.  | Fire Hydrants: Number and spacing does not meet CFC requirements.  |     |                    | X   |     |  |  |
| 5a. | Acceptable Alternate: Number of fire hydrants and spacing as proposed by the project architect is acceptable for fire suppression and protection of life and property.                                       |     |                    |     |     |  |  |
| 6.  | Fire Hydrants: Water flow and pressure are less than CFC minimum.  |     |                    | X   |     |  |  |
| 6a. | Acceptable Alternate: The available flow and pressure is acceptable for providing fire suppression and protection of life and property.  |     |                    |     |     |  |  |
| 7.  | Location of fire department connection(s) serving fire sprinkler systems or standpipe systems does not meet CFC requirements.  |     |                    | X   |     |  |  |
| 7a. | Acceptable Alternate: The location of fire department connection serving the fire sprinkler system and/or standpipe system is acceptable for providing fire suppression and protection of life and property. |     |                    |     |     |  |  |

# School District Acceptance of Acceptable Design Alternates

By signing this form, the school district acknowledges and accepts the proposed design as an alternative to California Building Code (CBC) and California Fire Code (CFC) minimum requirements, as indicated by one or more of the conditions indicated at items 4a, 5a, 6a or 7a, for providing fire and life safety protection of life and property.

N/A - NO VARIANCE PROPOSED

| LFA Agency Name:     | <b>City of Sacramento Fire Departr</b> | nent        |                |
|----------------------|--|-------------|----------------|
| LFA Review Official: | King Tunson                            |             |                |
| Title: Program       | Specialist                             | Work Phone: | (916) 808-1358 |
| Work Email: ktur     | son@sfd.cityofsacramento.org           |             |                |
|                      | •                                      |             |                |
| FA Reviewer's Signa  | ture:                                  | Date:       |                |

DGS DSA 810 (revised 12/29/20) DIVISION OF THE STATE ARCHITECT

SCALE 1" = 50'-0

DEPARTMENT OF GENERAL SERVICES

Page 2 of 4 STATE OF CALIFORNIA

1117 WINDFIELD WAY, SUITE 110 EL DORADO HILLS, CA 95762 | (916) 985-1870

Sacramento **City Unified** 

**School District** 

Sacramento City **Unified School District** 5735 47th Avenue Sacramento, CA 95824-4528

CONSULTANT:

ANTHONY J. TASSANO

Parkway Elementary 2023 Fencing

4720 Forest Parkway Sacramento, CA 95823

**REVISIONS** DESCRIPTION ADDENDUM NO.1

DRAWN: SCALE: AS NOTE CHECKED: PROJECT NO. 23-053 DESIGNED: SMN/AT 4/24/2023 ISSUANCE:


SHEET TITLE:


FIRE ACCESS

**PLAN** 

SHEET NO.

C1.0.2

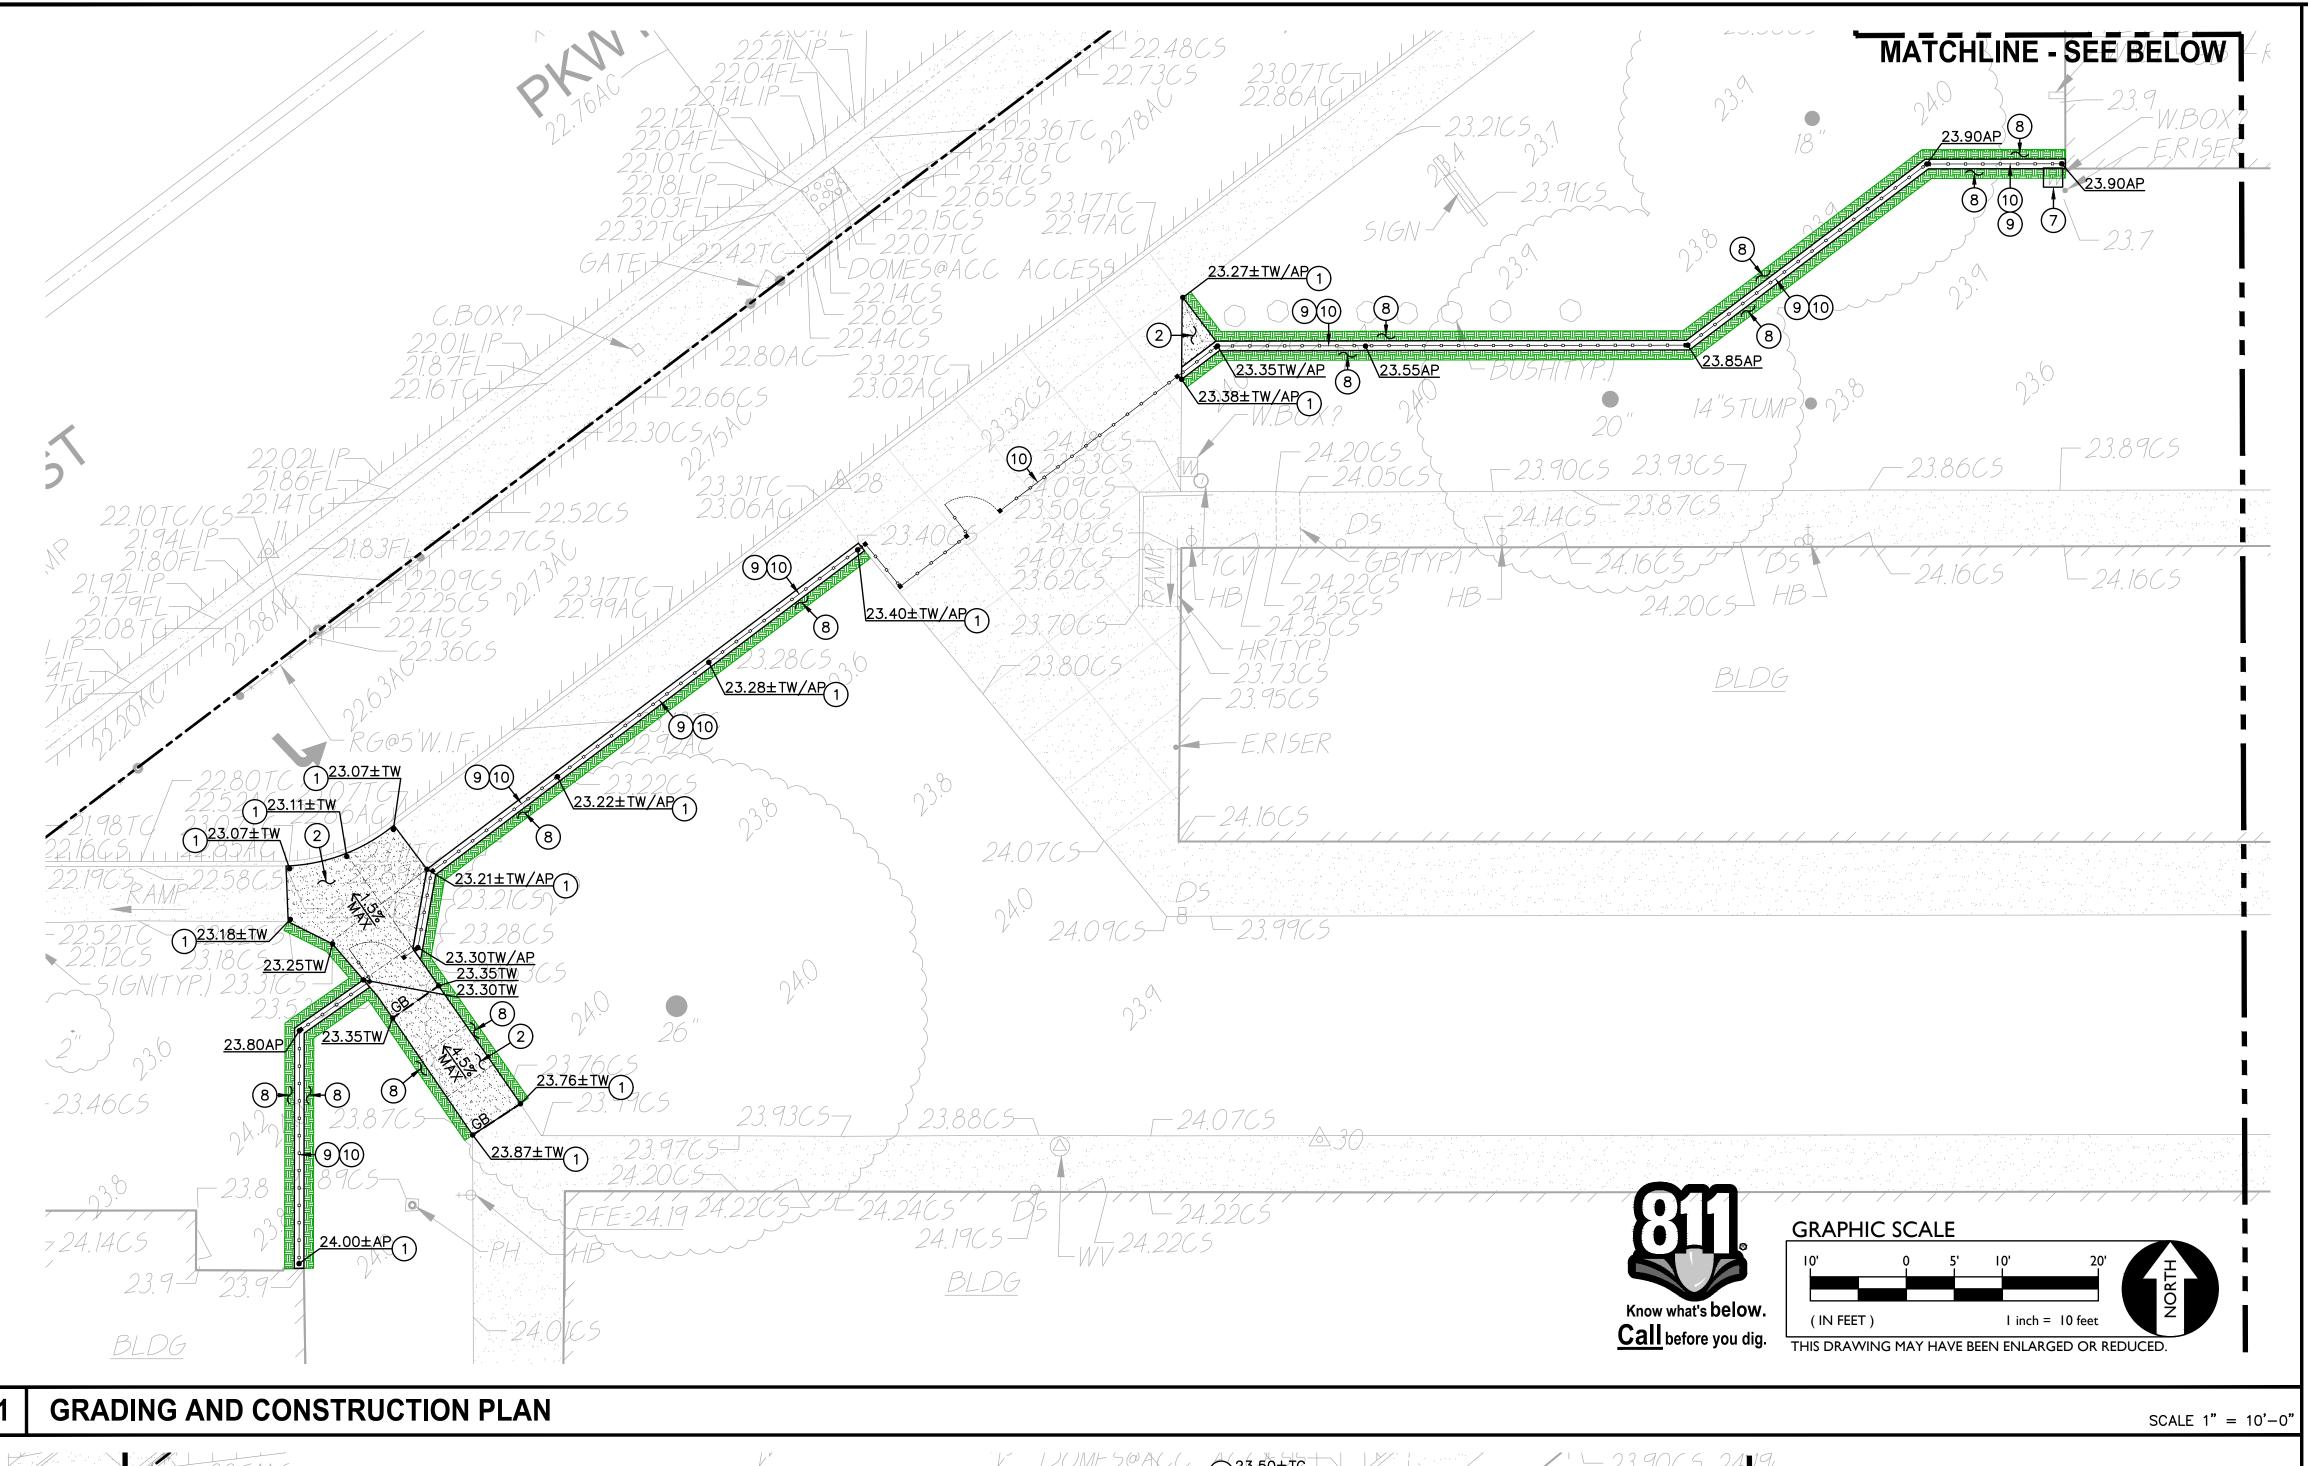

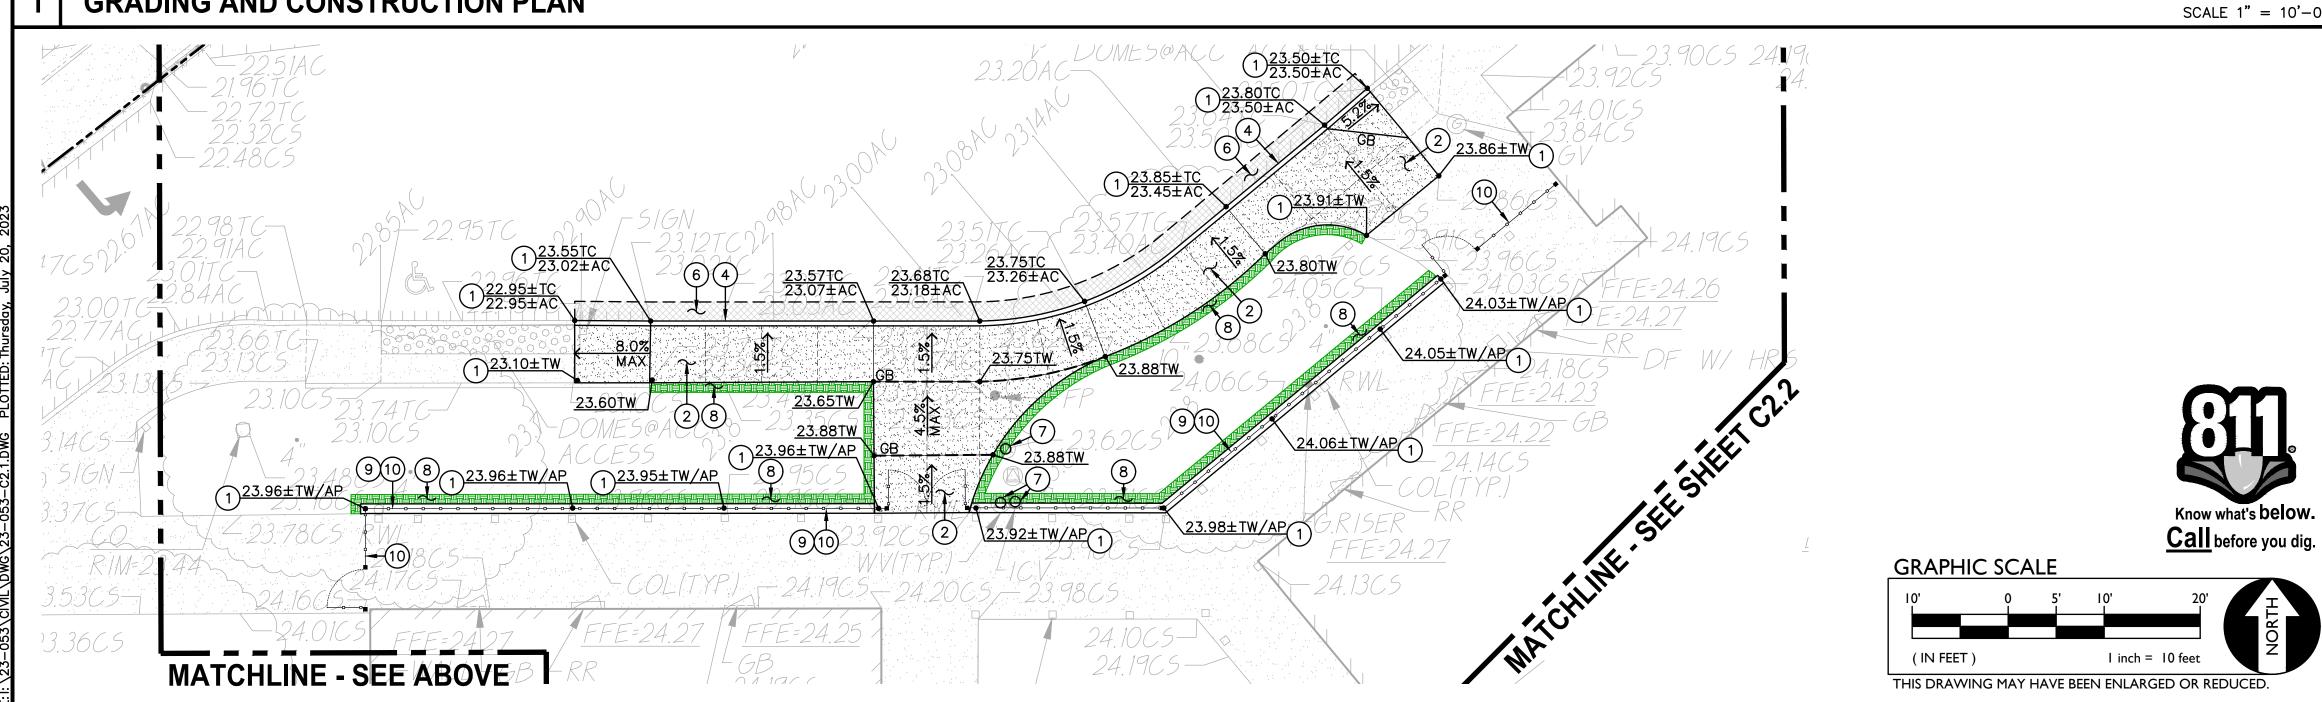



**GRADING AND CONSTRUCTION PLAN** 


LEGEND (\*) CONSTRUCTION NOTES

NOT ALL NOTES MAY BE USED ON THIS SHEET

1. MATCH EXISTING GRADE/ELEVATION. WHEN MATCHING NEW SLABS TO EXISTING, DOWEL SLABS PER THE DETAIL PROVIDED AT 24" O.C.

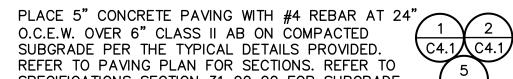

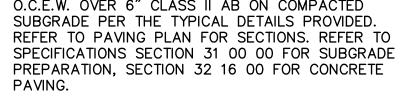

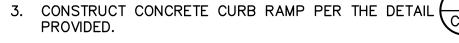

4. CONSTRUCT CONCRETE CURB PER THE DETAIL PROVIDED. (2.1)

5. CONSTRUCT FLUSH CONCRETE CURB PER THE DETAIL C4.1

PLACE 3" AC PAVING OVER 9" CLASS II AB, OR MATCH EXISTING SECTION, WHICHEVER IS GREATER. REFER TO SPECIFICATIONS SECTION 32 12 16 FOR MATERIALS AND CONSTRUCTION. REFER TO SECTION 31 00 00 FOR SUBGRADE PREPARATION.

7. INSTALL NEW TRAFFIC RATED UTILITY BOX OF SAME SIZE AND APPROPRIATE FOR UTILITY. SET NEW BOX FLUSH WITH PROPOSED FINISHED GRADE. WHEN IN NEW CONCRETE AREAS, ALIGN WITH NEW JOINT PATTERNS WHEN POSSIBLE. SEE DEMO PLAN FOR EXISTING BOX REMOVAL.



PATCH AND REPAIR EXISTING LANDSCAPING AND IRRIGATION ALONG EDGE OF NEW WORK. RELOCATE AND 2 C4.1 ADJUST EXISTING HEADS AS NEEDED TO MAIAIN COVERAGE. REPLACE ALL BROKEN HEADS RELOCATED. TAPER ALL GRADING AWAY FROM NEW CURBS AND APRONS AND SET GRADES BELOW APRONS, CURBS AND WALKS TO ALLOW FOR LAWN AND OTHER PLANTING PATCH BACK PER THE DETAILS PROVIDED. PROVIDE NEW SOD IN DISTURBED LAWN AREAS.

9. CONSTRUCT 12" WIDE CONCRETE APRON PER THE DETAIL C4.1



10. SEE FENCING PLAN FOR NEW FENCING.

11. CONSTRUCT RAISED CONCRETE MEDIAN, VARIABLE WIDTH AS SHOWN, AND PER THE DETAIL PROVIDED.




1117 WINDFIELD WAY, SUITE 110 EL DORADO HILLS, CA 95762 | (916) 985-1870



Sacramento City **Unified School District** 5735 47th Avenue Sacramento, CA 95824-4528

CONSULTANT:

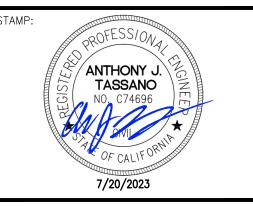

Parkway Elementary 2023 Fencing

4720 Forest Parkway Sacramento, CA 95823

|             | REVISIONS     |
|-------------|---------------|
| NO.         | DESCRIPTION   |
| $\triangle$ | ADDENDUM NO.1 |
|             |               |
|             |               |
|             |               |
|             |               |

DRAWN: SCALE: AS NOTE PROJECT NO. CHECKED: 23-053 DESIGNED: SMN/AT 4/24/2023 ISSUANCE:

**GRADING AND** CONSTRUCTION **PLAN** 

SHEET NO.

**C2.1** 


Regardless if shown or not, all existing improvements and landscaping cut, removed or damaged by the installation of new work shall be repaired. This is especially true along edges of new work. Contractor shall repair landscaping, and irrigation as needed to maintain system operation. Lawn

m

shall be repaired with sod in well maintained lawn areas. Sparse lawn areas


may be repaired with hydro/drilled seeding.

SCALE 1" = 10'-0'

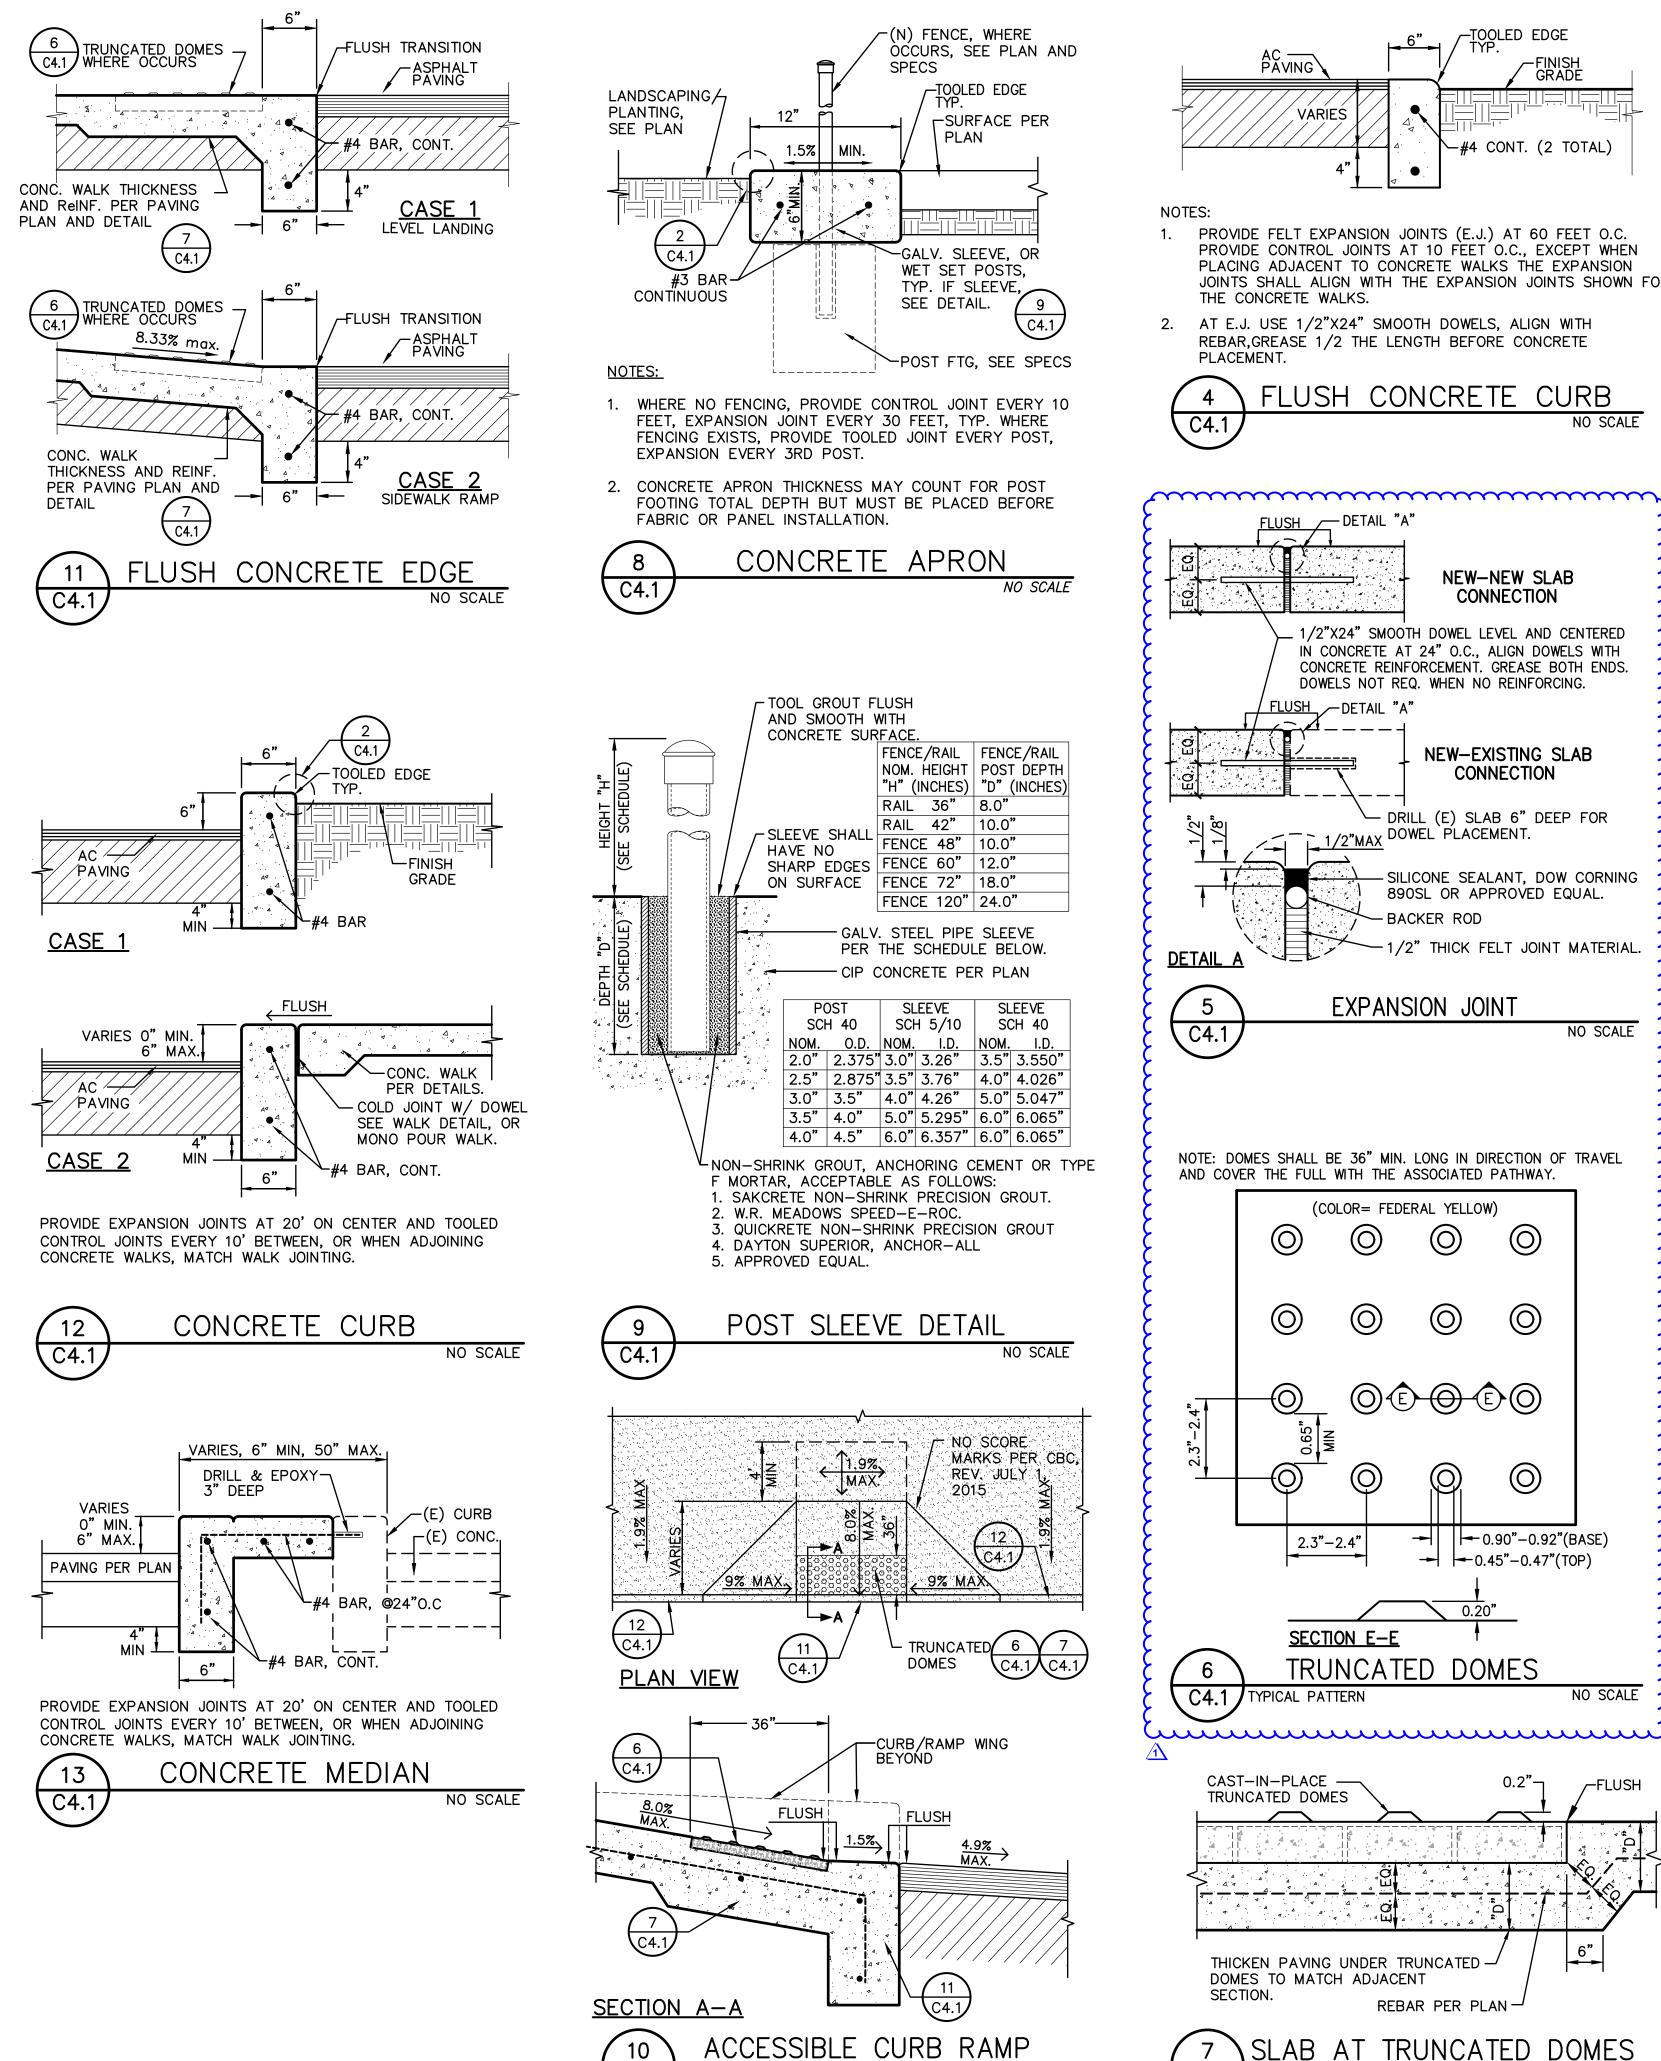

C4.1 TYPE 1


NO SCALE

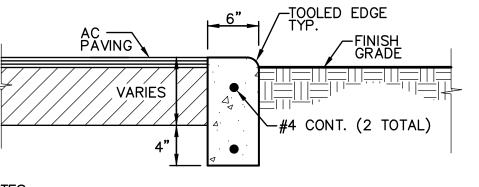



PROVIDE FELT EXPANSION JOINTS (E.J.) AT 60 FEET O.C. PROVIDE CONTROL JOINTS AT 10 FEET O.C., EXCEPT WHEN PLACING ADJACENT TO CONCRETE WALKS THE EXPANSION JOINTS SHALL ALIGN WITH THE EXPANSION JOINTS SHOWN FOR THE CONCRETE WALKS.

2. AT E.J. USE 1/2"X24" SMOOTH DOWELS, ALIGN WITH REBAR, GREASE 1/2 THE LENGTH BEFORE CONCRETE PLACEMENT.




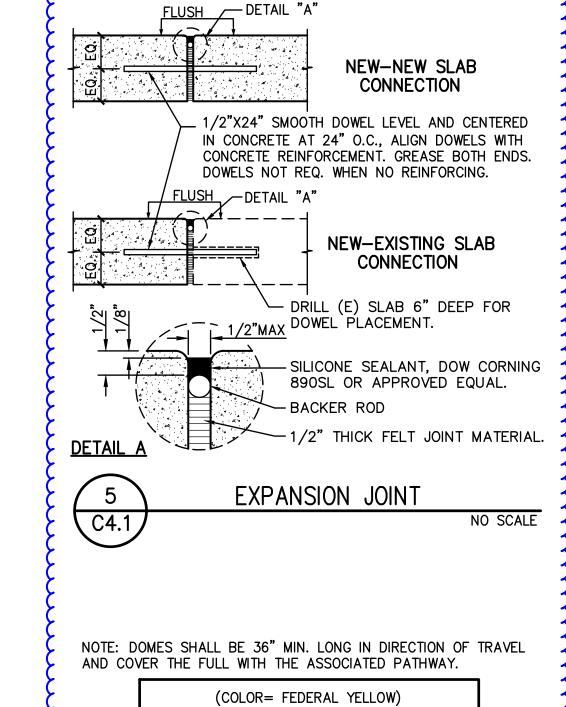


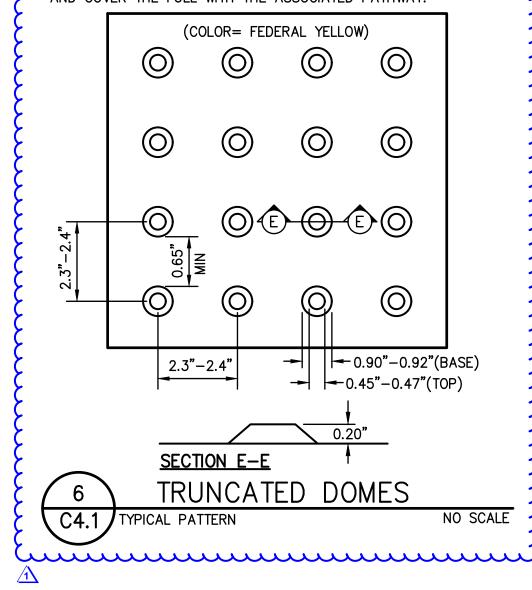


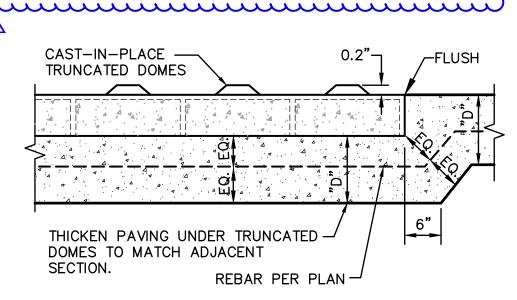





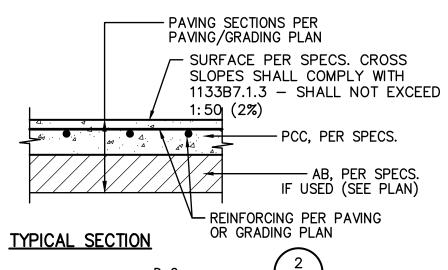


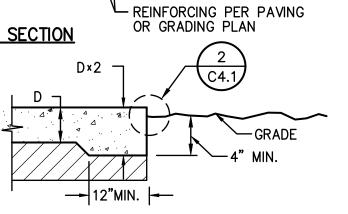


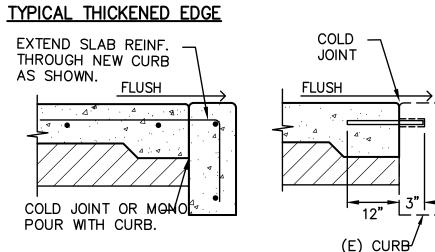


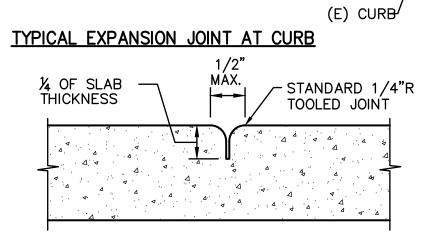


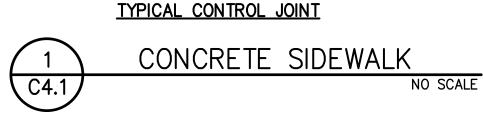

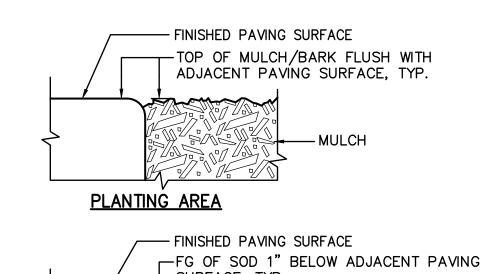

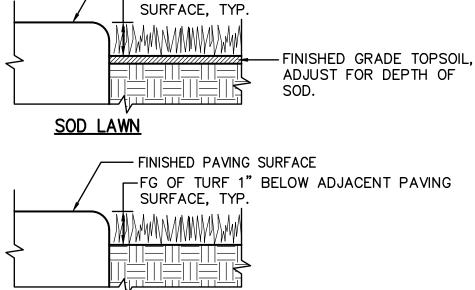

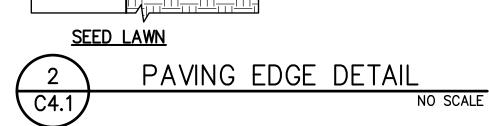

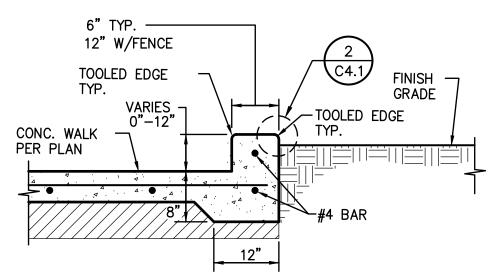


| 3     | WALKWAY | EDGE | CURB     |
|-------|---------|------|----------|
| C4.1/ |         |      | NO SCALE |

1117 WINDFIELD WAY, SUITE 110 EL DORADO HILLS, CA 95762 | (916) 985-1870

Sacramento **City Unified School District** 

Sacramento City **Unified School District** 5735 47th Avenue Sacramento, CA 95824-4528

CONSULTANT:

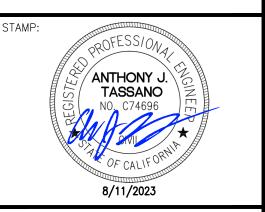

Parkway Elementary 2023 Fencing

4720 Forest Parkway Sacramento, CA 95823

|    | REVISIONS     |
|----|---------------|
| 0. | DESCRIPTION   |
| 7  | ADDENDUM NO.1 |
|    |               |
|    | ·             |

| DRAWN:    | SCALE:      |
|-----------|-------------|
| SMN       | AS NOTED    |
| CHECKED:  | PROJECT NO. |
| AT        | 23-053      |
| DESIGNED: | DATE:       |
| SMN/AT    | 4/24/2023   |
| ISSUANCE: |             |

SHEET TITLE:

**DETAILS AND SECTIONS** 

SHEET NO.

C4.1

# ROSA PARKS ELEMENTARY SCHOOL 2023 FENCING

2250 68th Avenue Sacramento, CA 95822

**PROJECT NARRATIVE** 





EL DORADO HILLS, CA 95762 | (916) 985-1870

Sacrament

Sacramento City

5735 47th Avenue

Unified School District

Sacramento, CA 95824-4528

ANTHONY J

Rosa Parks


Elementary


2023 Fencing

TASSANO

**City Unified** 

**School District** 

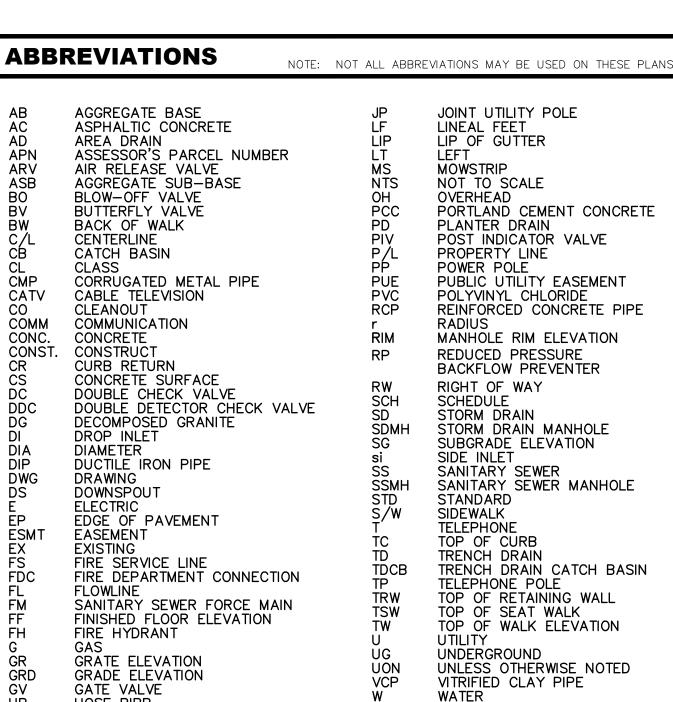

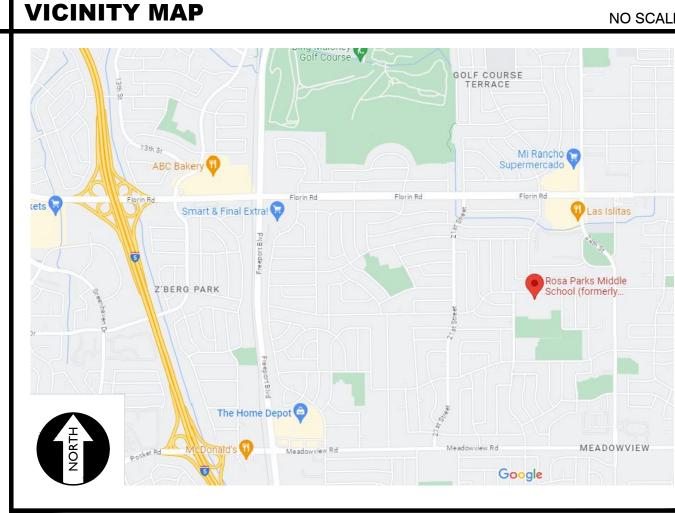

CONSTRUCTION OF SITE FENCING AND GATES, ONE OF WHICH SHALL BE INSTALLED WITH ELECTRONIC ACCESS CONTROLS FOR SITE SECURITY AND CONTROLLED ACCESS TOGETHER WITH ASSOCIATED FLATWORK AND PAVING REPAIRS FOR ACCESSIBILITY COMPLIANCE AS REQUIRED FOR THE INSTALLATION OF SUCH FENCING AND GATES, SUCH AS LEVEL LANDINGS ON EACH SIDE OF SUCH. NO ELECTIVE FLATWORK OR OTHER IMPROVEMENTS ARE PROPOSED EXCEPT AS REQUIRED FOR SUCH

COMPLIANCE UPGRADES FOR THE FENCING AND GATES

THERE ARE NO BUILDINGS OR STRUCTURES TO BE CONSTRUCTED, MODERNIZED OR OTHERWISE ALTERNATED BY THIS SET OF PLANS.

# APPLICABLE REGULATIONS

- ALL WORK SHALL CONFORM TO TITLE 24, CALIFORNIA CODE OF REGULATIONS (CCR).
- CHANGES TO THE APPROVED DRAWINGS AND SPECIFICATION SHALL BE MADE BY AN ADDENDA OR A CONSTRUCTION CHANGE DOCUMENT APPROVED BY DSA AS REQUIRED BY SECTION 4-338, PART 1, TITLE 24 CCR.
- SHOULD ANY EXISTING CONDITIONS SUCH AS DETERIORATION OR NON-COMPLYING CONSTRUCTION BE DISCOVERED WHICH IS NOT COVERED BY THE CONTRACT DOCUMENTS WHEREIN THE FINISHED WORK WILL NOT COMPLY WITH TITLE 24, CCR, A CONSTRUCTION CHANGE DOCUMENT (CCD), OR A SEPARATE SET OF PLANS AND SPECIFICATIONS. DETAILING AND SPECIFYING THE REQUIRED WORK SHALL BE SUBMITTED TO AND APPROVED BY DSA BEFORE PROCEEDING WITH THE WORK. (SECTION 4-317, PART 1, TITLE 24, CCR)
- A DSA CERTIFIED PROJECT INSPECTOR EMPLOYED BY THE DISTRICT (OWNER) AND APPROVED BY DSA SHALL PROVIDE CONTINUOUS INSPECTION OF THE WORK. THE DUTIES OF THE INSPECTOR ARE DEFINED IN SECTION 4-342, PART 1, TITLE 24,
- THIS PROJECT REQUIRES INSPECTOR CLASS 3
- GRADING PLANS, DRAINAGE IMPROVEMENTS, ROAD AND ACCESS REQUIREMENTS AND ENVIRONMENTAL HEALTH CONSIDERATIONS SHALL COMPLY WITH ALL LOCAL ORDINANCES.

# SPECIAL TESTING:

CONTRACTOR SHALL PROVIDE AND COORDINATE TESTING OF NEW LIGHTING CONTROLES MECHANICAL SYSTES, ENVELOPES AND PROCESS EQUIPMENT AND SYSTEMS IN ACCORDANCE WITH CALIFORNIA ENERGY CODE, SECTION 10-103.

# **DEFERRED APPROVALS**

# **STATEMENTS:**

THE TYPES, LOCATIONS, SIZES, AND/OR DEPTHS OF EXISTING UNDERGROUND UTILITIES AS SHOWN ON THESE PLANS WERE OBTAINED FROM SOURCES OF VARYING RELIABILITY. THE CONTRACTOR IS CAUTIONED THAT ONLY ACTUAL EXCAVATION WILL REVEAL THE TYPES. EXTENT, SIZES, LOCATIONS AND DEPTHS OF SUCH UNDERGROUND UTILITIES. A REASONABLE EFFORT HAS BEEN MADE TO LOCATE AND DELINEATE ALL KNOWN

**GENERAL NOTES** 

UNDERGROUND UTILITIES. HOWEVER, WARREN CONSULTING ENGINEERS CAN ASSUME NO RESPONSIBILITY FOR THE COMPLETENESS OR ACCURACY OF ITS DELINEATION OF SUCH UNDERGROUND UTILITIES, NOR FOR THE EXISTENCE OF OTHER BURIED OBJECTS OR UTILITIES WHICH MAY BE ENCOUNTERED BUT WHICH ARE NOT SHOWN ON THESE PLANS. THE CONTRACTOR OR ANY SUBCONTRACTOR FOR THIS CONTRACT SHALL NOTIFY MEMBERS OF UNDERGROUND SERVICE ALERT (USA) TWO (2) WORKING DAYS IN ADVANCE OF

PERFORMING ANY EXCAVATION WORK BY CALLING TOLL FREE 1-800-227-2600, OR 811

WARREN CONSULTING ENGINEERS, INC. (WCE) ASSUMES NO RESPONSIBILITY FOR ERRORS IN PHYSICAL LOCATION OF IMPROVEMENTS, HORIZONTAL OR VERTICAL, IF STAKED BY OTHERS. IN ADDITION, ANY SUCH ERRORS IN PHYSICAL LOCATION MAY AFFECT THE INTENDED DESIGN OF SUCH IMPROVEMENTS AND WCE CANNOT BE HELD RESPONSIBLE FOR SUCH CONDITIONS WHICH ARE A RESULT OF ERRORS IN SURVEYING, OR IMPROPER CONSTRUCTION.

- IF SUBSURFACE CULTURAL RESOURCES, REMAINS, AND/OR ARTIFACTS ARE UNCOVERED DURING PROJECT CONSTRUCTION, ALL WORK IN THE VICINITY SHALL BE STOPPED UNTIL SUCH ITEMS CAN BE ASSESSED BY AN APPROPRIATE MEMBER OF THE COUNTY ENVIRONMENTAL IMPACT SECTION STAFF.
- CONTRACTOR AGREES THAT HE/SHE SHALL ASSUME SOLE AND COMPLETE RESPONSIBILITY FOR JOB SITE CONDITIONS DURING THE COURSE OF CONSTRUCTION OF THIS PROJECT, INCLUDING SAFETY OF ALL PERSONS AND PROPERTY: THAT THIS REQUIREMENT SHALL APPLY CONTINUOUSLY AND SHALL NOT BE LIMITED TO NORMAL WORKING HOURS: AND THAT THE CONTRACTOR SHALL DEFEND, INDEMNIFY AND HOLD THE OWNER AND ENGINEER HARMLESS FROM ANY AND ALL LIABILITY, REAL OR ALLEGED, IN CONNECTION WITH THE PERFORMANCE OF WORK ON THIS PROJECT, EXCEPTING FOR LIABILITY ARISING FROM THE SOLE NEGLIGENCE OF THE OWNER OR ENGINEER
- THE CONTRACTOR SHALL OBTAIN AN EXCAVATION PERMIT FROM THE STATE OF CALIFORNIA DEPARTMENT OF INDUSTRIAL SAFETY FOR ALL EXCAVATIONS OF 5 FEET OR MORE IN DEPTH.
- IT SHALL BE THE CONTRACTOR'S RESPONSIBILITY TO MAKE ALL NECESSARY PRE-BID AND PRE-CONSTRUCTION SITE INSPECTION, AND/OR OBSERVATIONS ON THE SITE TO PRE-DETERMINE ALL HIS/HER MEANS AND METHODS NECESSARY TO COMPLETE THE IMPROVEMENTS SHOWN ON THESE PLANS AND PER THE PROJECT SPECIFICATIONS IT IS THE CONTRACTORS RESPONSIBILITY TO DETERMINE, AND INCLUDE IN HIS/HER CONTRACT, ALL MEANS AND METHODS NECESSARY TO PERFORM A COMPLETE AND ACCEPTABLE JOB.
- WHERE IMPROVEMENTS LIE WITHIN AN EXISTING DEVELOPED AREA, CONTRACTOR SHALL USE CAUTION WHEN ACCESSING THE SITE THROUGH THESE EXISTING IMPROVEMENTS. IT IS THE CONTRACTORS RESPONSIBILITY TO PROTECT ANY SUCH EXISTING IMPROVEMENTS OUTSIDE THE PROJECT BOUNDARY, OR EXISTING IMPROVEMENTS WITHIN THE BOUNDARY WHICH ARE TO REMAIN. PROPER PRECAUTIONS SHALL BE PROVIDED AND MAINTAINED THROUGHOUT CONSTRUCTION. ANY DAMAGE SHALL BE REPAIRED OR REPLACED TO THE SATISFACTION OF TH
- IT IS THE RESPONSIBILITY OF THE CONTRACTOR TO KEEP DETAILED RECORDS OF MINOR CHANGES OR ADJUSTMENTS MADE DURING CONSTRUCTION (WHICH WERE NOT FORMALLY ISSUED). UPON PROJECT COMPLETION, THESE RECORDS AND/OR INFORMATION SHALL BE PROVIDED TO THE OWNER AND WARREN CONSULTING ENGINEERS INC. UNLESS AN OFFICIAL "AS-BUILT" SET OF PLANS IS A REQUIREMENT OF THE CONTRACT. IF AS-BUILT PLANS ARE A REQUIREMENT OF THE CONTRACT, REFER TO SPECIFICATIONS FOR AS-BUILT DELIVERABLE REQUIREMENTS.
- IN VEHICULAR PATHWAYS, EXISTING ASPHALTIC AND/OR CONCRETE SURFACES SHALL BE CUT TO A NEAT AND STRAIGHT LINE, PARALLEL OR PERPENDICULAR TO THE VEHICULAR TRAVELED PATH. THIS IS TYPICALLY THE ROADWAY CENTERLINE, BUT MAY VARY. THAT SAWCUT EDGE SHALL BE PROTECTED FROM DAMAGE DURING CONSTRUCTION SO A CLEAN EDGE REMAINS FOR PATCH BACK.. IF EDGE IS DAMAGED, A NEW SAW CUT WILL BE REQUIRED. THE EXPOSED EDGE SHALL BE "TACKED" WITH EMULSION PRIOR TO PAVING.
- NO BURNING OR BLASTING SHALL BE ALLOWED ONSITE UNLESS SPECIFICALLY ADDRESSED ON PLANS, OR SPECIFICALLY APPROVED AND COORDINATED WITH THE ARCHITECT, ENGINEER, AND LOCAL AGENCY OR OTHER ADMINISTRATIVE AUTHORITY.
- SUBGRADE AND RESULTING FINISHED GRADE SHALL BE CONSTRUCTED SMOOTH AND UNIFORM BETWEEN SPOT ELEVATIONS, CONTOURS OR OTHER STRUCTURE ELEVATIONS SHOWN ON GRADING OR OTHER PLANS. NO MOUNDS, RUTS, DEPRESSIONS OR OTHER GRADING DEFICIENCIES WILL BE ALLOWED UNLESS SPECIFICALLY SHOWN ON PLANS.
- 12. ON NEW WATER SYSTEMS, SERVICE LATERALS SHALL BE MADE USING APPROPRIATE "TEE" AND "WYE" FITTINGS. SADDLE TAPS WILL ONLY BE ALLOWED WHEN MAKING CONNECTIONS TO EXISTING WATER MAINS.
- SHALL BE RECOATED IMMEDIATELY. APPLICATION SHALL BE INSPECTED BY PROJECT INSPECTOR DURING APPLICATION. EMBEDMENT OF FEATURES IN CONCRETE PAVING, CURBS, OR WALLS, SUCH AS SQUARE OR ROUND TUBING, POSTS,
- OR COLUMNS, STEEL BOLTED PLATES, OR OTHER STRUCTURES, SHALL REQUIRE ADDITIONAL SCORE OR EXPANSION JOINTS TO PREVENT UNCONTROLLED CRACKING. THOSE ADDITIONAL JOINTS MAY OR MAY NOT BE SPECIFICALLY SHOWN ON PLANS BUT SHALL BE PROVIDED BY THE CONTRACTOR.
- EMBEDMENT OF FEATURES IN CONCRETE PAVING, CURBS, OR WALLS, SUCH AS SQUARE OR ROUND TUBING, POSTS OR COLUMNS, STEEL BOLTED PLATES, OR OTHER STRUCTURES, SHALL REQUIRE A MINOR ADJUSTMENT OF REBAR WITHIN CONCRETE TO ALLOW FOR SUCH STRUCTURE. THAT REBAR ADJUSTMENT MAY NOT BE SPECIFICALLY SHOWN

CURING COMPOUND SHALL BE APPLIED IN A CONTINUOUS SOLID WET FLOWING COAT. ANY "SPOTTY" APPLICATIONS

- NO MORE THAN 1 GALLON OF WATER PER YARD OF CONCRETE CAN BE ADDED TO THE TRUCK AFTER ARRIVAL TO PROJECT SITE. THE ADDITION OF WATER CAN ONLY BE ADDED UNDER THE SUPERVISION OF THE CONCRETE INSPECTOR OR LABORATORY TECHNICIAN.
- WHEN PUMPING CONCRETE FOR PLACEMENT, ABSOLUTELY NO WATER IS TO BE ADDED TO PUMP HOPPER. ANY WATER ADDED TO HOPPER WILL BE REASON FOR CONCRETE REJECTION AT THE CONTRACTORS EXPENSE.
- 18. ALL CONTRACTION/CONSTRUCTION JOINTS "CJ" SHALL BE 1/4 THE SLAB THICKNESS DEEP, BUT NO LESS THAN 1' FOR CONTROLLING OF CRACKING. CONTRACTOR SHALL EXERCISE CAUTION WHEN FINAL TROWELING OF CONCRETE SO AS NOT TO FILL IN THESE JOINTS WITH CONCRETE CREAM. ANY CRACKS OUTSIDE OF JOINTS WHICH WERE CONSTRUCTED LESS THAN 1" DEEP, SHALL BE CAUSE FOR CONCRETE SLAB(S) TO BE REMOVED AND REPLACE AT CONTRACTORS EXPENSE.
- 19. ANY SCREED BOARDS SET WITHIN CONCRETE SLABS SHALL BE AN "OVERHEAD SCREED" SO THERE IS NO INTERFERENCE WITH THE PLACEMENT AND ALIGNMENT OF SLAB REINFORCING.
- 20. 3-1/2" FELT JOINTS WILL NOT BE ACCEPTED. PROVIDE A FULL 4" FELT JOINT FOR 4" SLAB CONSTRUCTION, AND A 6" FELT JOINT FOR A 6" SLAB SLAB CONSTRUCTION.
- . SHOULD ANY SHRINKAGE CRACKS OCCUR OUTSIDE OF EITHER THE EXPANSION JOINTS OR CRACK CONTROL JOINTS, THEN THE CONCRETE SLAB SHALL BE SAWCUT AT THE NEAREST JOINTS ON EACH SIDE OF THE CRACK AND THE CONCRETE SECTION SHALL BE, REMOVED AND REPLACED. NEW CONCRETE SHALL BE DOWELED INTO EXISTING CONCRETE PER DRAWING DETAIL.
- 22. ALL AREAS DISTURBED BY GRADING OPERATIONS WHETHER SHOWN ON THE DRAWINGS OR NOT SHALL BE HYDRO SEEDED UNLESS OTHERWISE NOTED. HYDRO SEEDING SHALL CONFORM TO LOCAL CITY/COUNTY STANDARDS. 23. REPAIR OR PATCHING OF GALVANIZED METALS, SUCH AS AFTER WELDING GALVANIZED COMPONENTS, SHALL BE
- MADE USING A ZINC COMPOSITION "HOT STICK" APPLICATION PER ASTM A 780-01. GALVANIZING PAINTS WILL NOT BE ALLOWED.

# **GENERAL PAVING SURFACE NOTES:**

- PROVIDE EQUIVALENT OF MEDIUM BROOM FINISH AT SLOPES UP TO 5.99%, TYPICAL. PROVIDE EQUIVALENT OF HEAVY BROOM FINISH AT SLOPES 6% AND GREATER. REFER TO SPECIFICATIONS.
- ALL NEW PEDESTRIAN WALKWAYS (NON-RAMP) SHALL BE SLOPED NO GREATER THAN 2.0%, AND NO LESS THAN 0.75% IN ANY DIRECTION, UNLESS SPECIFICALLY LABELED OTHERWISE. ALL CONCRETE SHALL MEET THE FOLLOWING SLOPE REQUIREMENTS:
- NO GREATER THAN 5% SLOPE IN THE DIRECTION OF TRAVEL. NO GREATER THAN 2% SLOPE CROSSING THE DIRECTION OF TRAVEL.
- NO GREATER THAN 2% SLOPE IN ANY DIRECTION IN COURTYARD OR PLAZA AREAS.

SHEET INDEX

NO. SHEET DESCRIPTION CO.O COVER SHEET

Know what's **below** 

Call before you dig.

C0.1 TOPOGRAPHIC SURVEY CO.2 TOPOGRAPHIC SURVEY CO.3 TOPOGRAPHIC SURVEY CO.4 TOPOGRAPHIC SURVEY

C1.0.1 SITE ACCESS PLAN C1.0.2 FIRE ACCESS PLAN

C1.1 DEMOLITION PLAN C1.2 DEMOLITION PLAN C1.3 DEMOLITION PLAN

C1.4 DEMOLITION PLAN C1.5 DEMOLITION PLAN GRADING AND CONSTRUCTION PLAN

GRADING AND CONSTRUCTION PLAN GRADING AND CONSTRUCTION PLAN

C2.4 GRADING AND CONSTRUCTION PLAN

C2.5 GRADING AND CONSTRUCTION PLAN C3.1 FENCING PLAN

C3.2 FENCING PLAN C3.3 FENCING PLAN

C3.4 FENCING PLAN C4.1 DETAILS AND SECTIONS

C4.2 DETAILS AND SECTIONS

C4.3 DETAILS AND SECTIONS C4.4 DETAILS AND SECTIONS

TOOO TECHNOLOGY COVER SHEET

T200 TECHNOLOGY FLOOR PLAN T900 TECHNOLOGY DETAILS

2250 68th Avenue Sacramento, CA 95822

TOTAL SHEET COUNT = 28

OWNER/USER

SACRAMENTO CITY OWNER: UNIFIED SCHOOL DISTRICT 5735 47TH AVE. SACRAMENTO, CA 95824-4528 PHONE: (916) 643-9000

> **DISTRICT CONTACT:** [CONTACT] FACILITIES SUPPORT SERVICES (916) 264-4075 [EMAIL]

**ADDITIONAL CONTACTS:** TROY MIETZ TROY-MIETZ@SCUSD.EDU

AS NOTE PROJECT NO. CHECKED: 23-054 DESIGNED: 4/24/2023 ISSUANCE:

**COVER SHEET** 

SCALE:

REVISIONS

DESCRIPTION

ADDENDUM NO.1

DRAWN:

SHEET TITLE:

WARREN CONSULTING ENGINEERS. INC. CIVIL: 1117 WINDFIELD WAY, SUITE 110 EL DORADO HILLS, CA 95762 PHONE: (916) 985-1870


KMM SERVICES, INC. 5433 EL CAMINO AVE #5 CARMICHAEL, CA 95608

PROJECT TEAM


PHONE: (916) 359-4000

FAX: (916) 985-1877

SHEET NO.

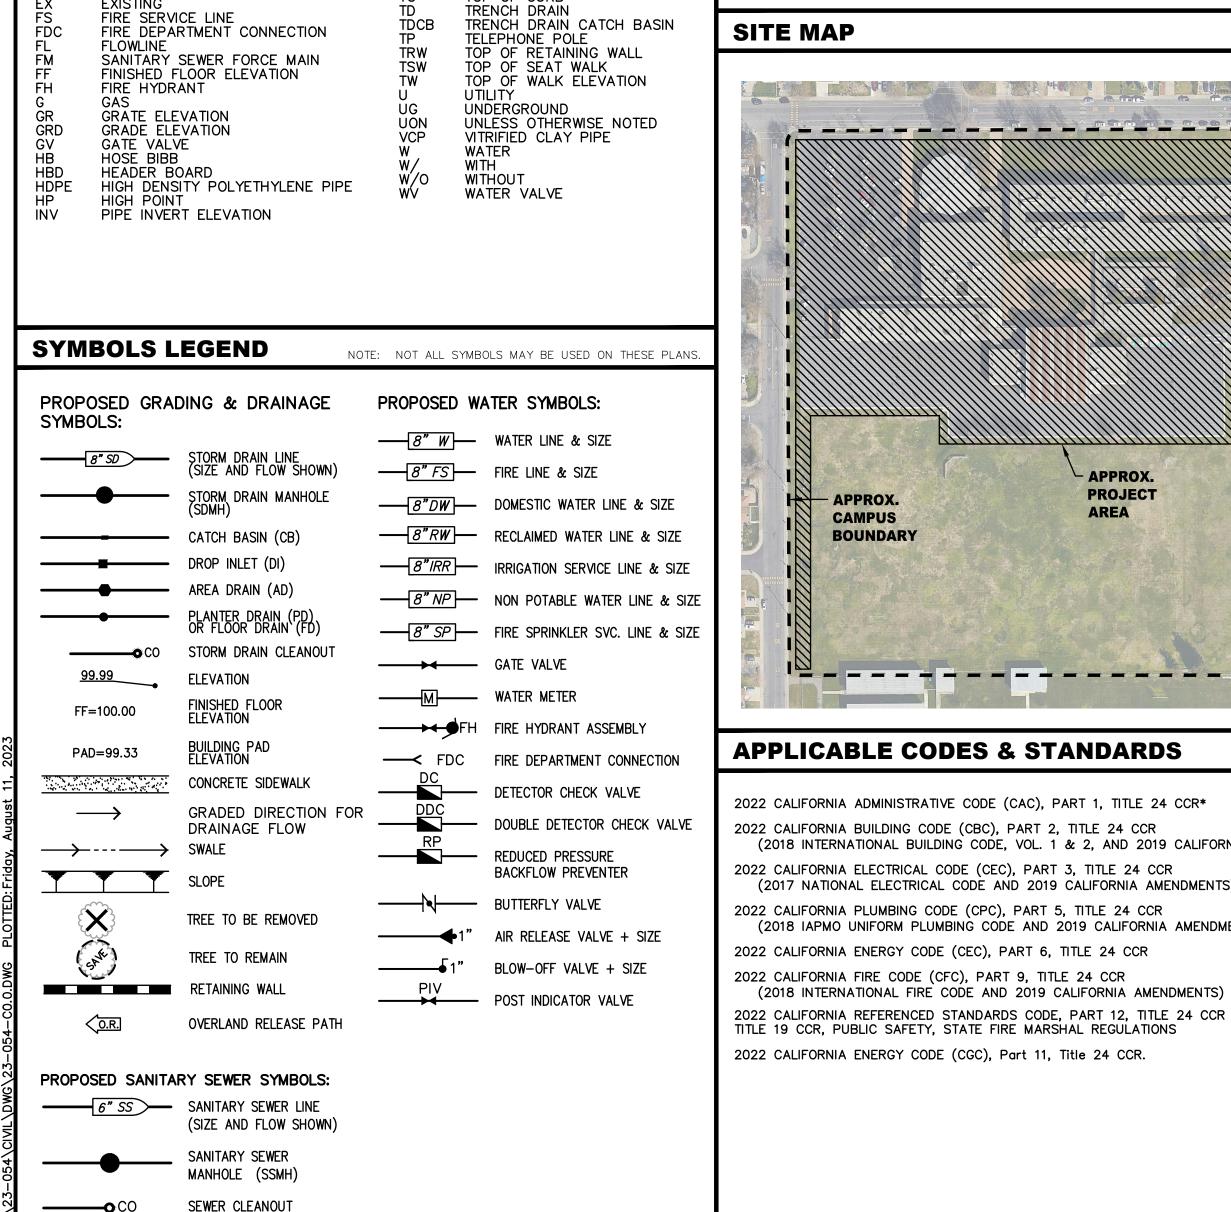

FLUSHER BRANCH

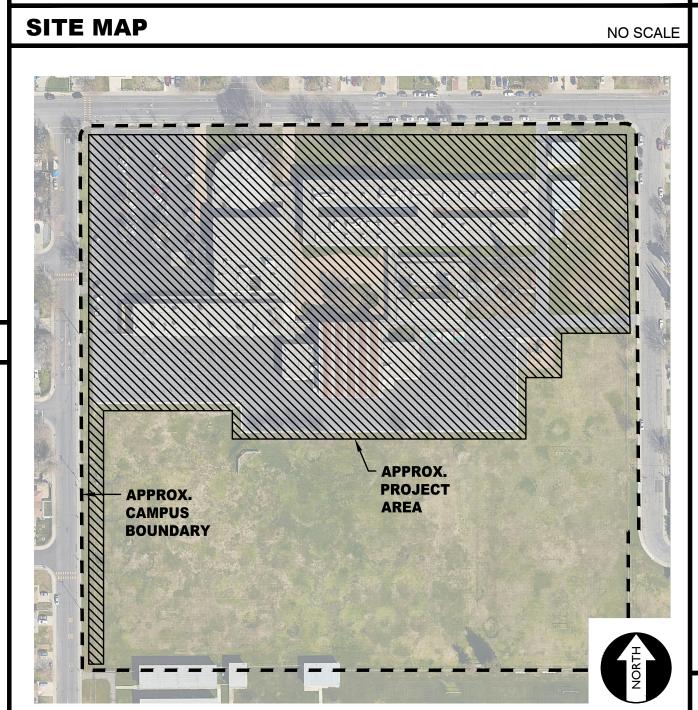


(2018 INTERNATIONAL BUILDING CODE, VOL. 1 & 2, AND 2019 CALIFORNIA AMENDMENTS)

(2017 NATIONAL ELECTRICAL CODE AND 2019 CALIFORNIA AMENDMENTS)

(2018 INTERNATIONAL FIRE CODE AND 2019 CALIFORNIA AMENDMENTS)

(2018 IAPMO UNIFORM PLUMBING CODE AND 2019 CALIFORNIA AMENDMENTS)

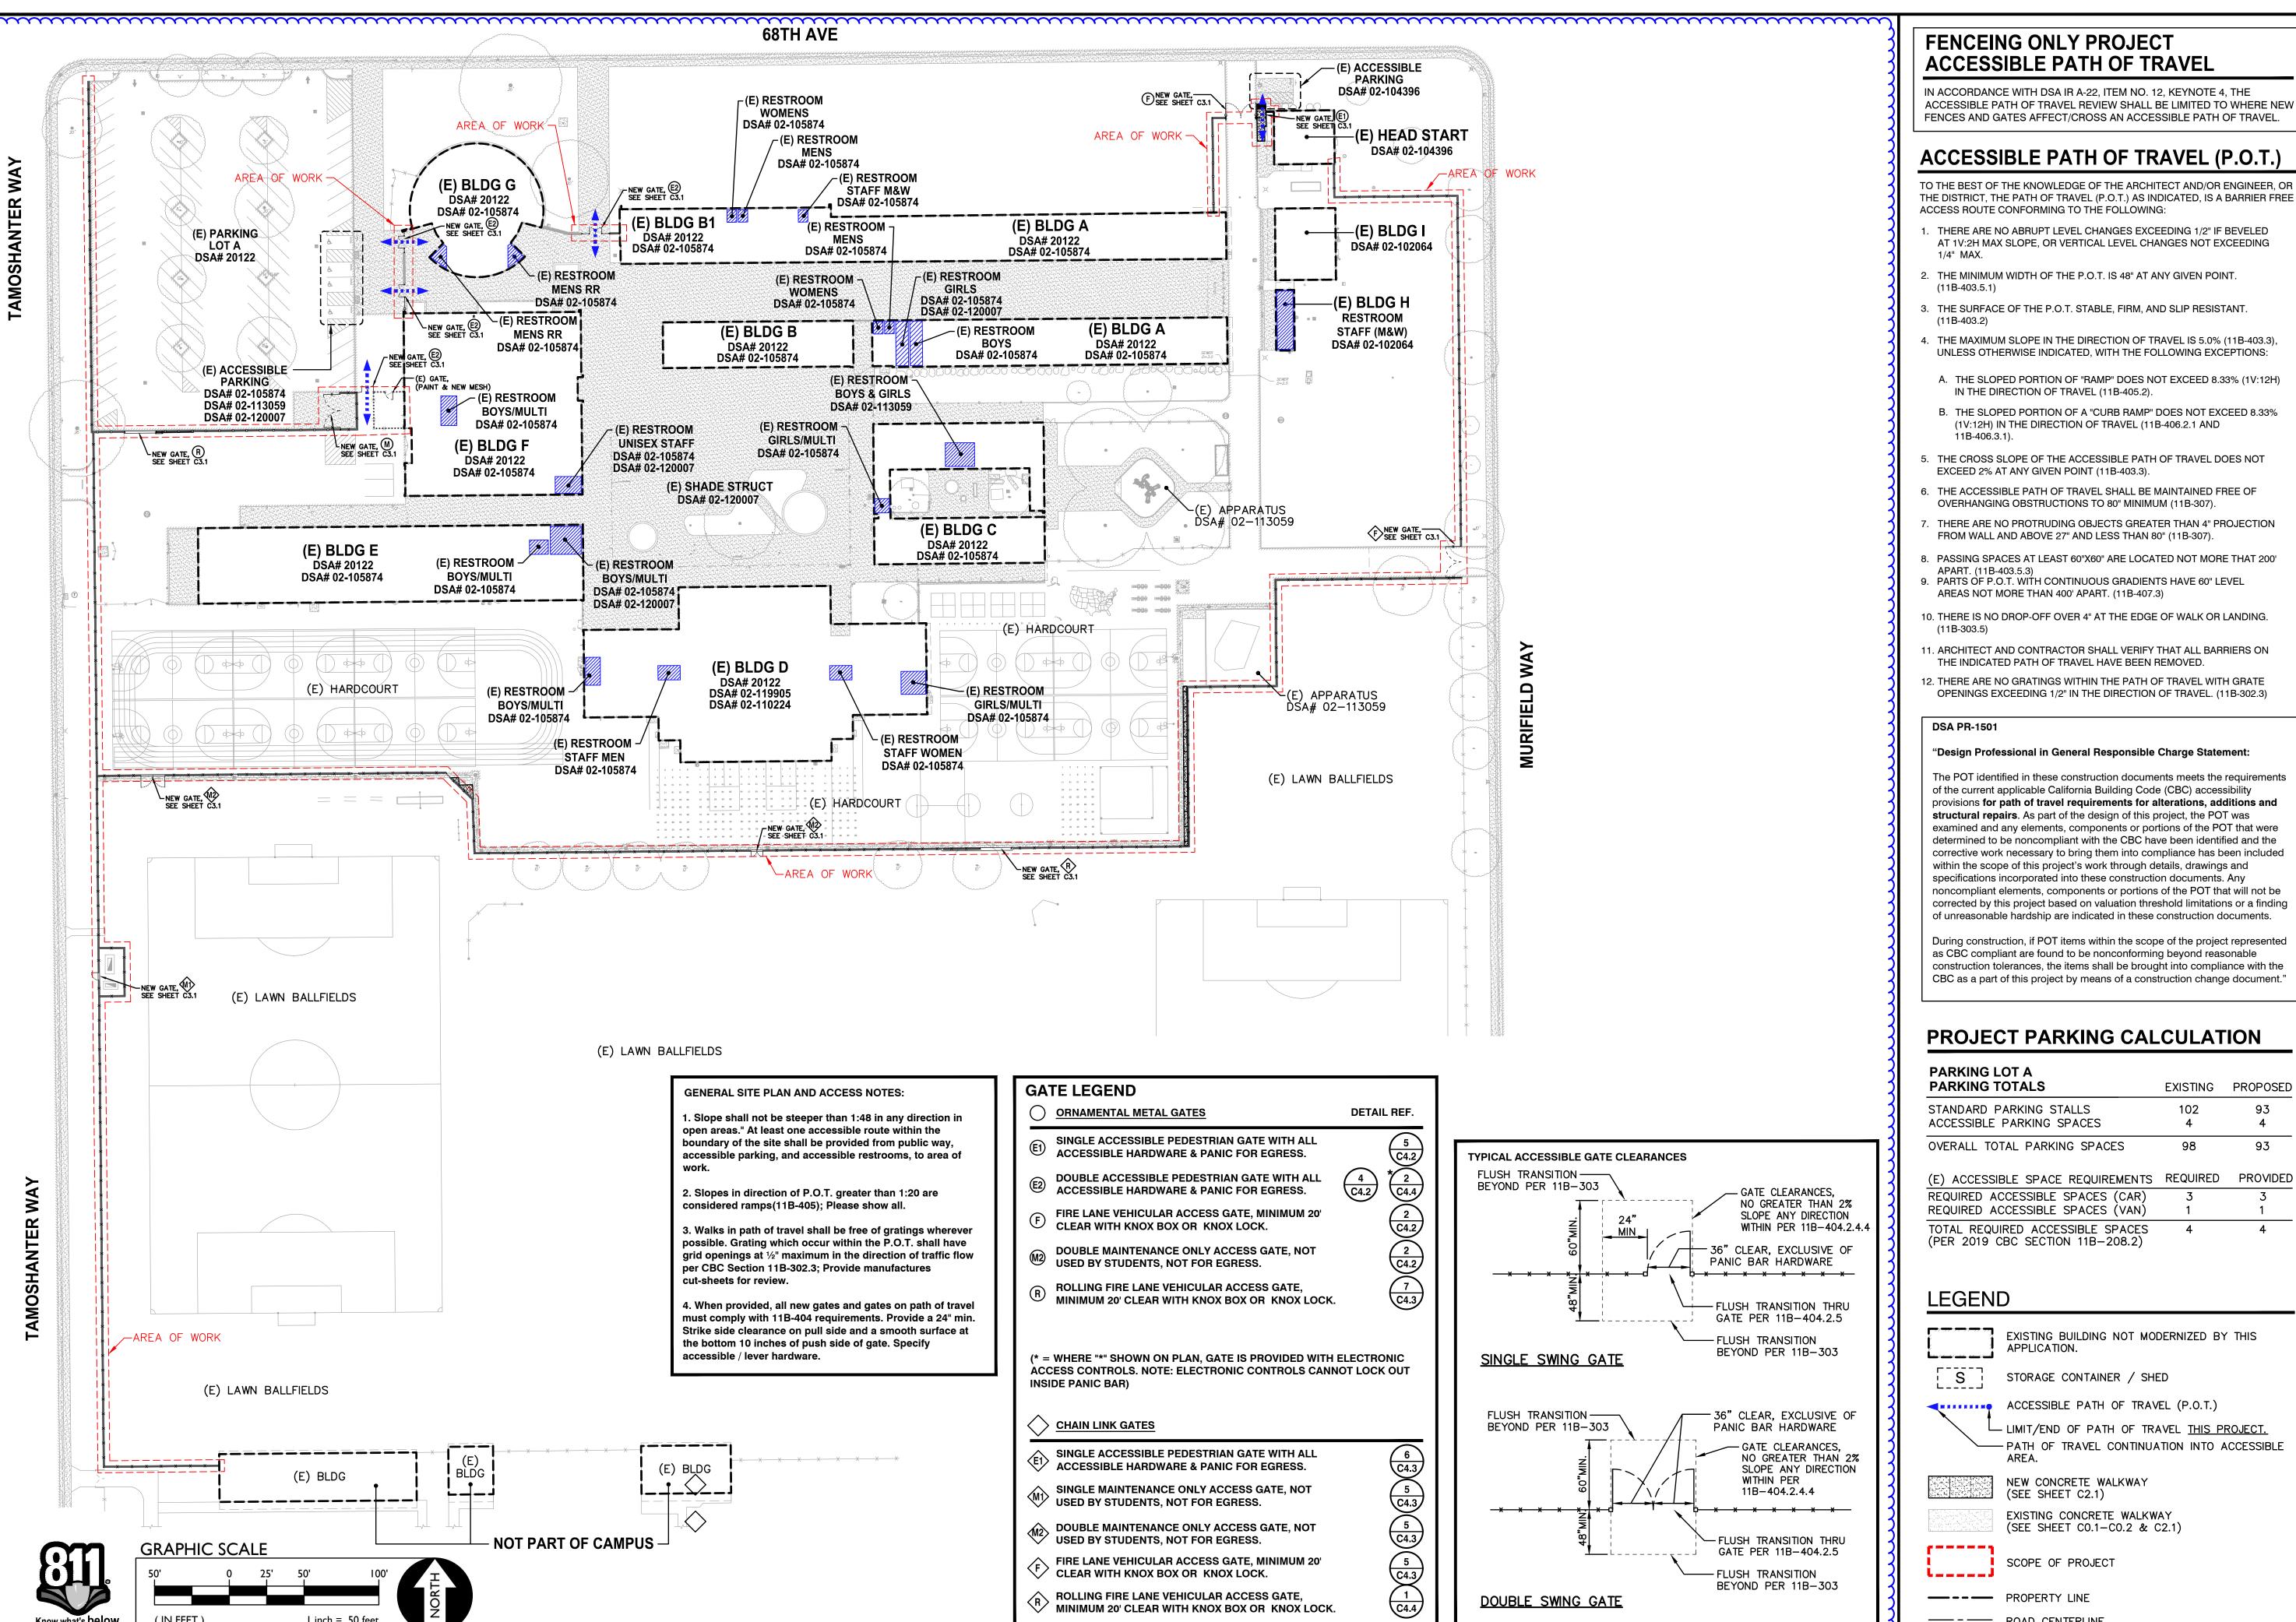

ROLLING FIRE LANE VEHICULAR ACCESS GATE,

MINIMUM 20' CLEAR WITH KNOX BOX OR KNOX LOCK.

# **FENCEING ONLY PROJECT ACCESSIBLE PATH OF TRAVEL**

IN ACCORDANCE WITH DSA IR A-22, ITEM NO. 12, KEYNOTE 4, THE ACCESSIBLE PATH OF TRAVEL REVIEW SHALL BE LIMITED TO WHERE NEW FENCES AND GATES AFFECT/CROSS AN ACCESSIBLE PATH OF TRAVEL.

# **ACCESSIBLE PATH OF TRAVEL (P.O.T.)**

TO THE BEST OF THE KNOWLEDGE OF THE ARCHITECT AND/OR ENGINEER. OR THE DISTRICT, THE PATH OF TRAVEL (P.O.T.) AS INDICATED, IS A BARRIER FREE ACCESS ROUTE CONFORMING TO THE FOLLOWING:

- THERE ARE NO ABRUPT LEVEL CHANGES EXCEEDING 1/2" IF BEVELED AT 1V:2H MAX SLOPE, OR VERTICAL LEVEL CHANGES NOT EXCEEDING
- 2. THE MINIMUM WIDTH OF THE P.O.T. IS 48" AT ANY GIVEN POINT.
- 3. THE SURFACE OF THE P.O.T. STABLE, FIRM, AND SLIP RESISTANT. (11B-403.2)
- 4. THE MAXIMUM SLOPE IN THE DIRECTION OF TRAVEL IS 5.0% (11B-403.3), UNLESS OTHERWISE INDICATED, WITH THE FOLLOWING EXCEPTIONS:
- A. THE SLOPED PORTION OF "RAMP" DOES NOT EXCEED 8.33% (1V:12H) IN THE DIRECTION OF TRAVEL (11B-405.2).
- B. THE SLOPED PORTION OF A "CURB RAMP" DOES NOT EXCEED 8.33% (1V:12H) IN THE DIRECTION OF TRAVEL (11B-406.2.1 AND 11B-406.3.1).
- 5. THE CROSS SLOPE OF THE ACCESSIBLE PATH OF TRAVEL DOES NOT EXCEED 2% AT ANY GIVEN POINT (11B-403.3).
- 6. THE ACCESSIBLE PATH OF TRAVEL SHALL BE MAINTAINED FREE OF OVERHANGING OBSTRUCTIONS TO 80" MINIMUM (11B-307).
- THERE ARE NO PROTRUDING OBJECTS GREATER THAN 4" PROJECTION FROM WALL AND ABOVE 27" AND LESS THAN 80" (11B-307).
- 8. PASSING SPACES AT LEAST 60"X60" ARE LOCATED NOT MORE THAT 200' APART. (11B-403.5.3)
- . PARTS OF P.O.T. WITH CONTINUOUS GRADIENTS HAVE 60" LEVEL AREAS NOT MORE THAN 400' APART. (11B-407.3)
- 10. THERE IS NO DROP-OFF OVER 4" AT THE EDGE OF WALK OR LANDING. (11B-303.5)
- 11. ARCHITECT AND CONTRACTOR SHALL VERIFY THAT ALL BARRIERS ON THE INDICATED PATH OF TRAVEL HAVE BEEN REMOVED.
- 12. THERE ARE NO GRATINGS WITHIN THE PATH OF TRAVEL WITH GRATE OPENINGS EXCEEDING 1/2" IN THE DIRECTION OF TRAVEL. (11B-302.3)

#### DSA PR-1501

#### "Design Professional in General Responsible Charge Statement:

The POT identified in these construction documents meets the requirements of the current applicable California Building Code (CBC) accessibility provisions for path of travel requirements for alterations, additions and **structural repairs**. As part of the design of this project, the POT was examined and any elements, components or portions of the POT that were determined to be noncompliant with the CBC have been identified and the corrective work necessary to bring them into compliance has been included within the scope of this project's work through details, drawings and specifications incorporated into these construction documents. Any oncompliant elements, components or portions of the POT that will not be corrected by this project based on valuation threshold limitations or a finding of unreasonable hardship are indicated in these construction documents.

During construction, if POT items within the scope of the project represented as CBC compliant are found to be nonconforming beyond reasonable construction tolerances, the items shall be brought into compliance with the CBC as a part of this project by means of a construction change document."

EXISTING PROPOSED

93

93

102


98

1117 WINDFIELD WAY, SUITE 110 EL DORADO HILLS, CA 95762 | (916) 985-1870



Sacramento City **Unified School District** 5735 47th Avenue Sacramento, CA 95824-4528

ONSULTANT:

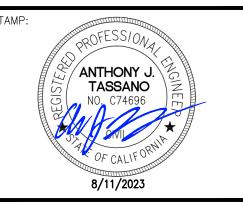

# Rosa Parks 2023 Fencing

2250 68th Avenue Sacramento, CA 95822

|     | REVISIONS     |
|-----|---------------|
| 10. | DESCRIPTION   |
| 1   | ADDENDUM NO.1 |
|     |               |


| ORAWN:    | SCALE:      |
|-----------|-------------|
| SMN       | AS NOTED    |
| CHECKED:  | PROJECT NO. |
| AT        | 23-054      |
| DESIGNED: | DATE:       |
| SMN/AT    | 4/24/2023   |

SHEET TITLE:

ISSUANCE:

SITE ACCESS **PLAN** 

C1.0.1

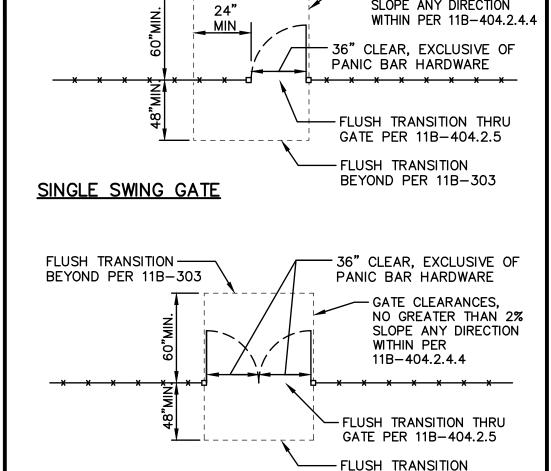

**DOUBLE SWING GATE** 

EXISTING BUILDING NOT MODERNIZED BY THIS APPLICATION.

STORAGE CONTAINER / SHED

ACCESSIBLE PATH OF TRAVEL (P.O.T.) - LIMIT/END OF PATH OF TRAVEL THIS PROJECT. PATH OF TRAVEL CONTINUATION INTO ACCESSIBLE

NEW CONCRETE WALKWAY (SEE SHEET C2.1)

EXISTING CONCRETE WALKWAY (SEE SHEET CO.1-CO.2 & C2.1)

SCOPE OF PROJECT


— PROPERTY LINE — - — ROAD CENTERLINE

**ST** STORAGE, SHED/CONTAINER

ACCESSIBLE RESTROOM (PROJECT COMPLIANCE)

Know what's **below**.

BEYOND PER 11B-303

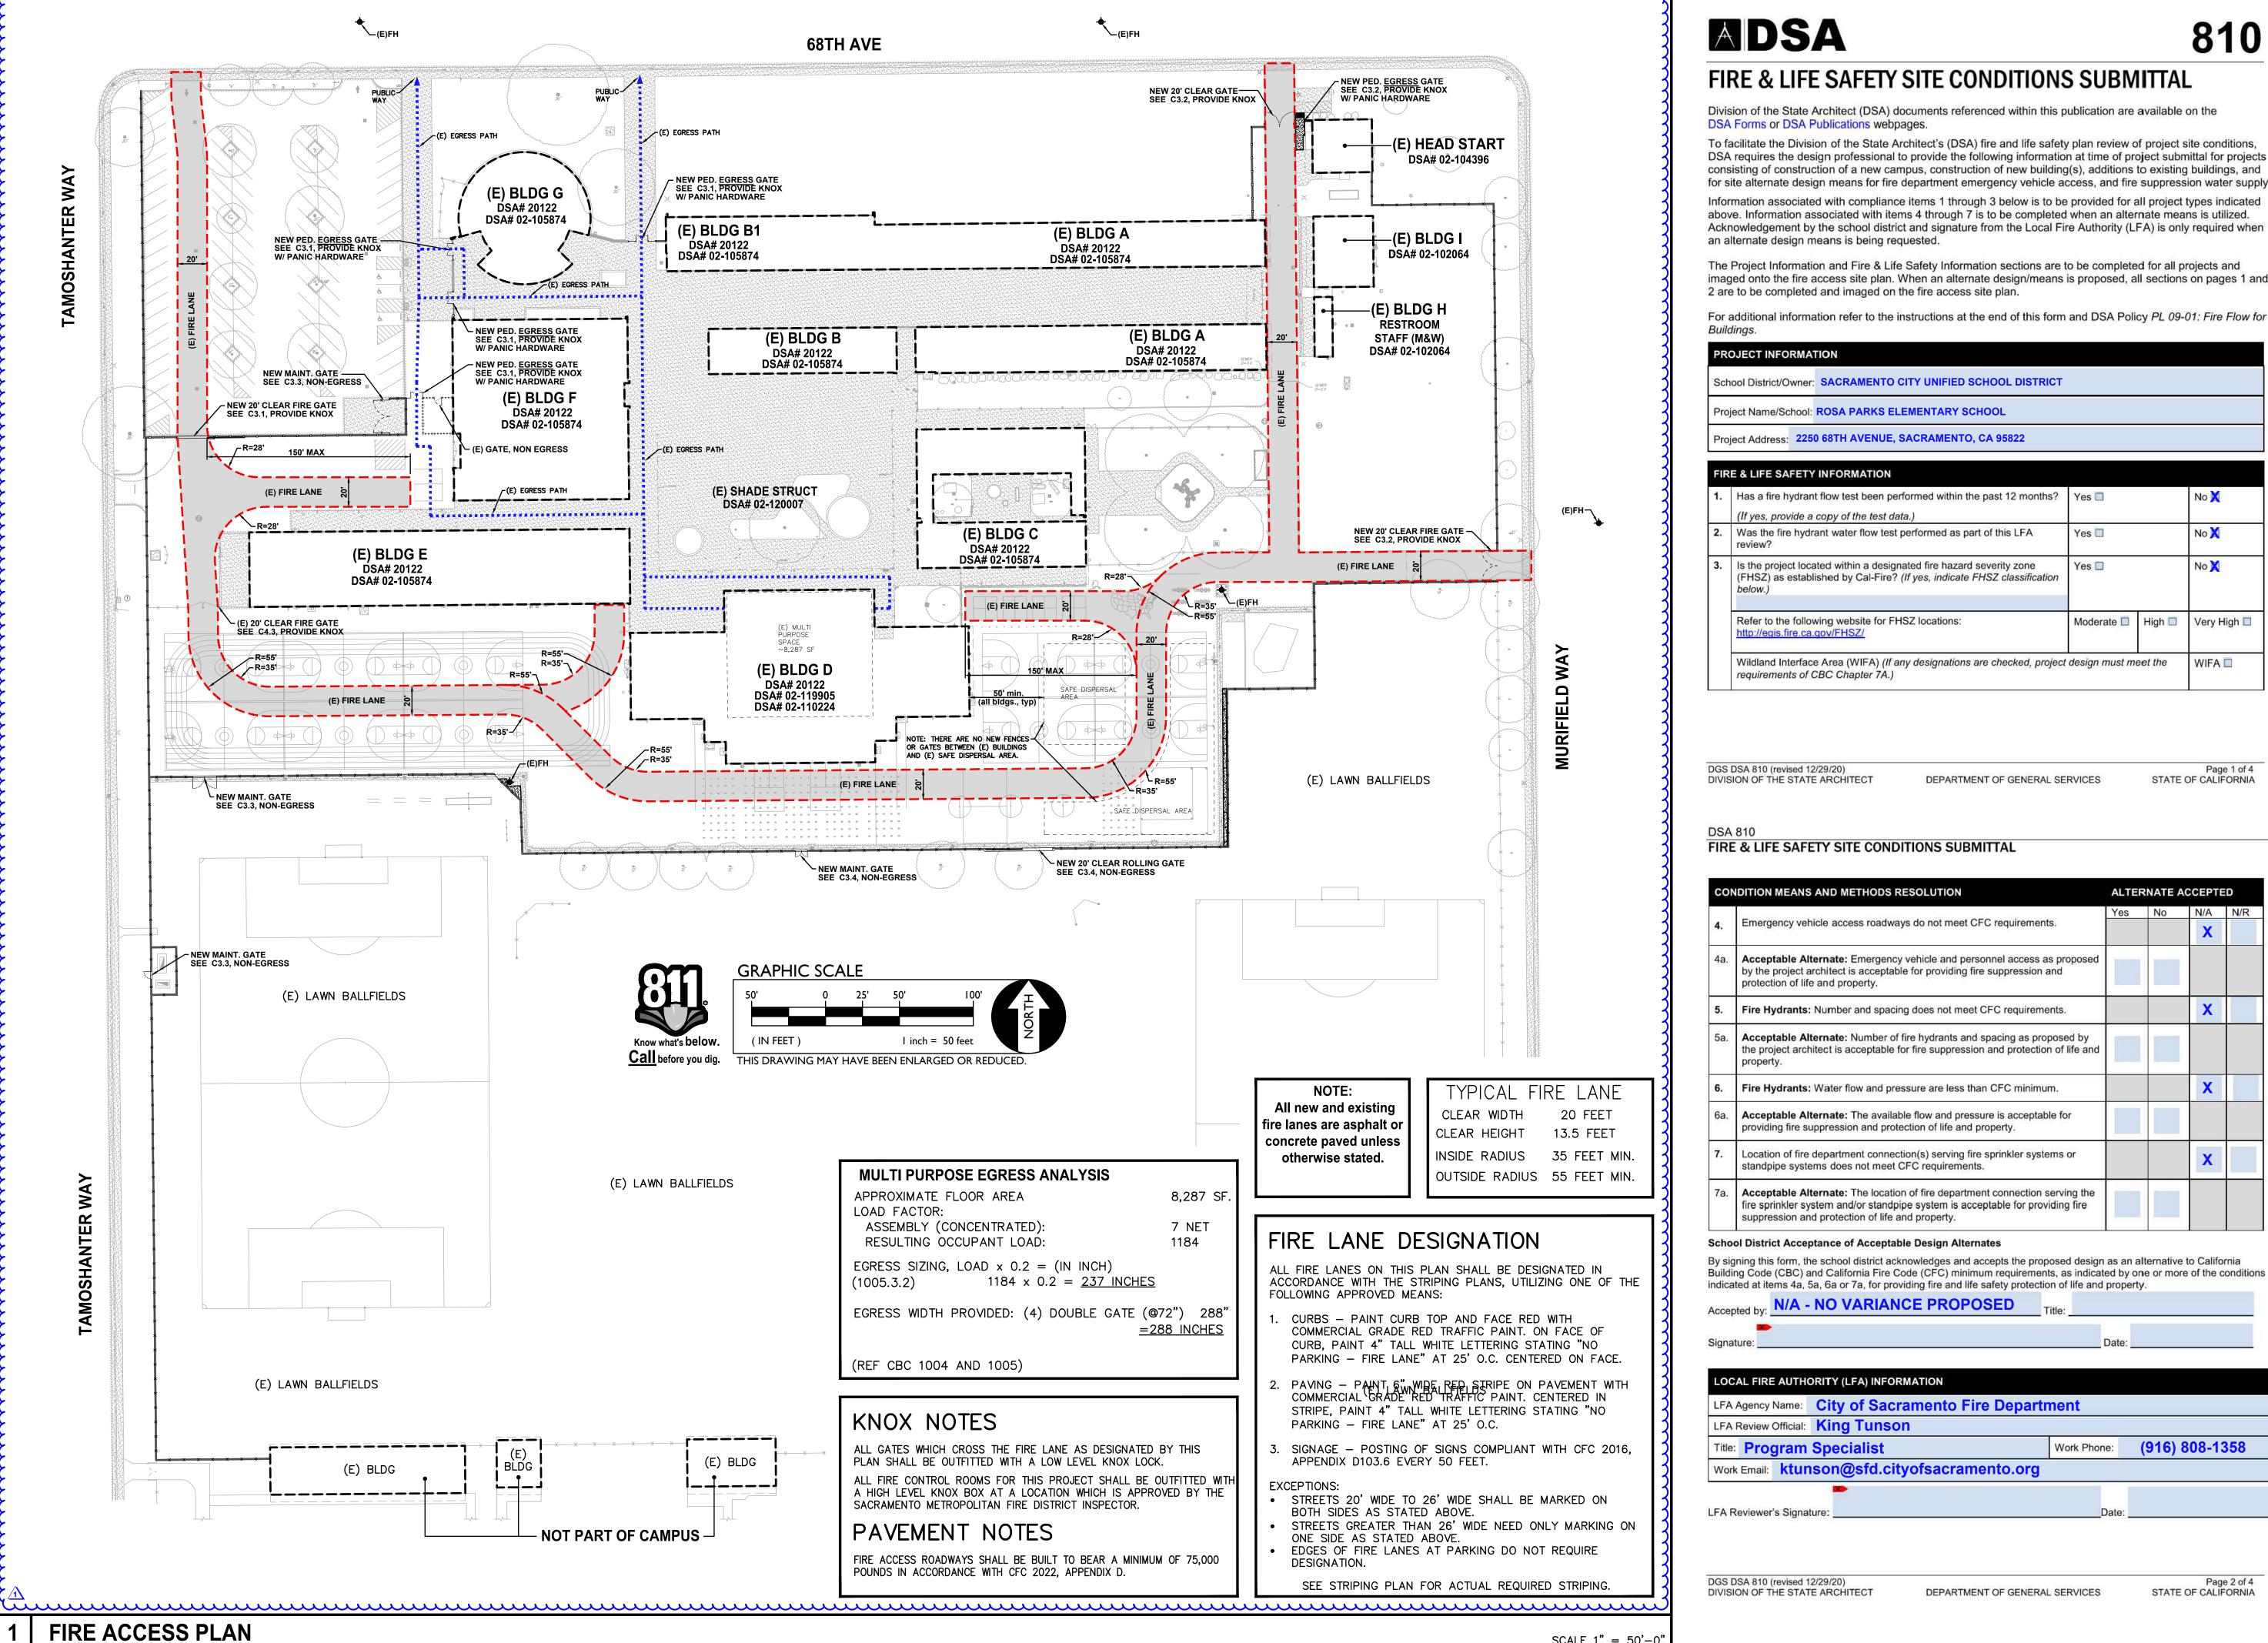

**ADSA** 

# FIRE & LIFE SAFETY SITE CONDITIONS SUBMITTAL


Division of the State Architect (DSA) documents referenced within this publication are available on the DSA Forms or DSA Publications webpages.

To facilitate the Division of the State Architect's (DSA) fire and life safety plan review of project site conditions, DSA requires the design professional to provide the following information at time of project submittal for projects consisting of construction of a new campus, construction of new building(s), additions to existing buildings, and

Information associated with compliance items 1 through 3 below is to be provided for all project types indicated above. Information associated with items 4 through 7 is to be completed when an alternate means is utilized. Acknowledgement by the school district and signature from the Local Fire Authority (LFA) is only required when an alternate design means is being requested.

The Project Information and Fire & Life Safety Information sections are to be completed for all projects and imaged onto the fire access site plan. When an alternate design/means is proposed, all sections on pages 1 and 2 are to be completed and imaged on the fire access site plan.

For additional information refer to the instructions at the end of this form and DSA Policy PL 09-01: Fire Flow for

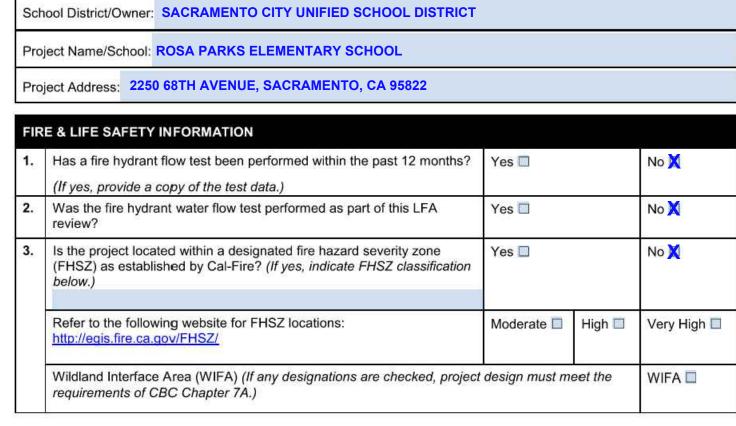

DGS DSA 810 (revised 12/29/20) Page 1 of 4 DEPARTMENT OF GENERAL SERVICES STATE OF CALIFORNIA DIVISION OF THE STATE ARCHITECT

SCALE 1" = 50' - 0'

FIRE & LIFE SAFETY SITE CONDITIONS SUBMITTAL

| CON | IDITION MEANS AND METHODS RESOLUTION   | ALTE | RNATE | ACCEPT | Ξ |
|-----|--|------|-------|--------|---|
|     | Emergency vehicle access roadways do not meet CFC requirements.  | Yes  | No    | N/A    |   |
| 4.  | Emergency vehicle access roadways do not meet CPC requirements.  |      | 3     | X      |   |
| 4a. | Acceptable Alternate: Emergency vehicle and personnel access as proposed by the project architect is acceptable for providing fire suppression and protection of life and property.                          |      |       |        |   |
| 5.  | Fire Hydrants: Number and spacing does not meet CFC requirements.  |      |       | X      |   |
| 5a. | Acceptable Alternate: Number of fire hydrants and spacing as proposed by the project architect is acceptable for fire suppression and protection of life and property.                                       |      |       |        |   |
| 6.  | Fire Hydrants: Water flow and pressure are less than CFC minimum.  |      |       | X      |   |
| 6a. | Acceptable Alternate: The available flow and pressure is acceptable for providing fire suppression and protection of life and property.  |      |       |        |   |
| 7.  | Location of fire department connection(s) serving fire sprinkler systems or standpipe systems does not meet CFC requirements.  |      |       | X      |   |
| 7a. | Acceptable Alternate: The location of fire department connection serving the fire sprinkler system and/or standpipe system is acceptable for providing fire suppression and protection of life and property. |      |       |        |   |

# School District Acceptance of Acceptable Design Alternates

By signing this form, the school district acknowledges and accepts the proposed design as an alternative to California Building Code (CBC) and California Fire Code (CFC) minimum requirements, as indicated by one or more of the conditions

indicated at items 4a, 5a, 6a or 7a, for providing fire and life safety protection of life and property. N/A - NO VARIANCE PROPOSED

| LFA Agency Name:        | City of Sacramento Fire Department |             |                |  |  |
|-------------------------|------------------------------------|-------------|----------------|--|--|
| FA Review Official:     | King Tunson                        |             |                |  |  |
| Title: Program          | Specialist                         | Work Phone: | (916) 808-1358 |  |  |
| Work Email: <b>ktur</b> | nson@sfd.cityofsacramento.org      |             |                |  |  |

DGS DSA 810 (revised 12/29/20) DIVISION OF THE STATE ARCHITECT DEPARTMENT OF GENERAL SERVICES 1117 WINDFIELD WAY, SUITE 110

EL DORADO HILLS, CA 95762 | (916) 985-1870

Sacramento **City Unified School District** 

Sacramento City **Unified School District** 5735 47th Avenue Sacramento, CA 95824-4528

ONSULTANT:

ANTHONY J **TASSANO** 

Rosa Parks 2023 Fencing

2250 68th Avenue Sacramento, CA 95822

**REVISIONS** DESCRIPTION 1 ADDENDUM NO.1

DRAWN: SCALE: AS NOTE CHECKED: PROJECT NO. 23-054 DESIGNED: 4/24/2023 ISSUANCE:

SHEET TITLE:


FIRE ACCESS **PLAN** 

SHEET NO.

Page 2 of 4

STATE OF CALIFORNIA


C1.0.2

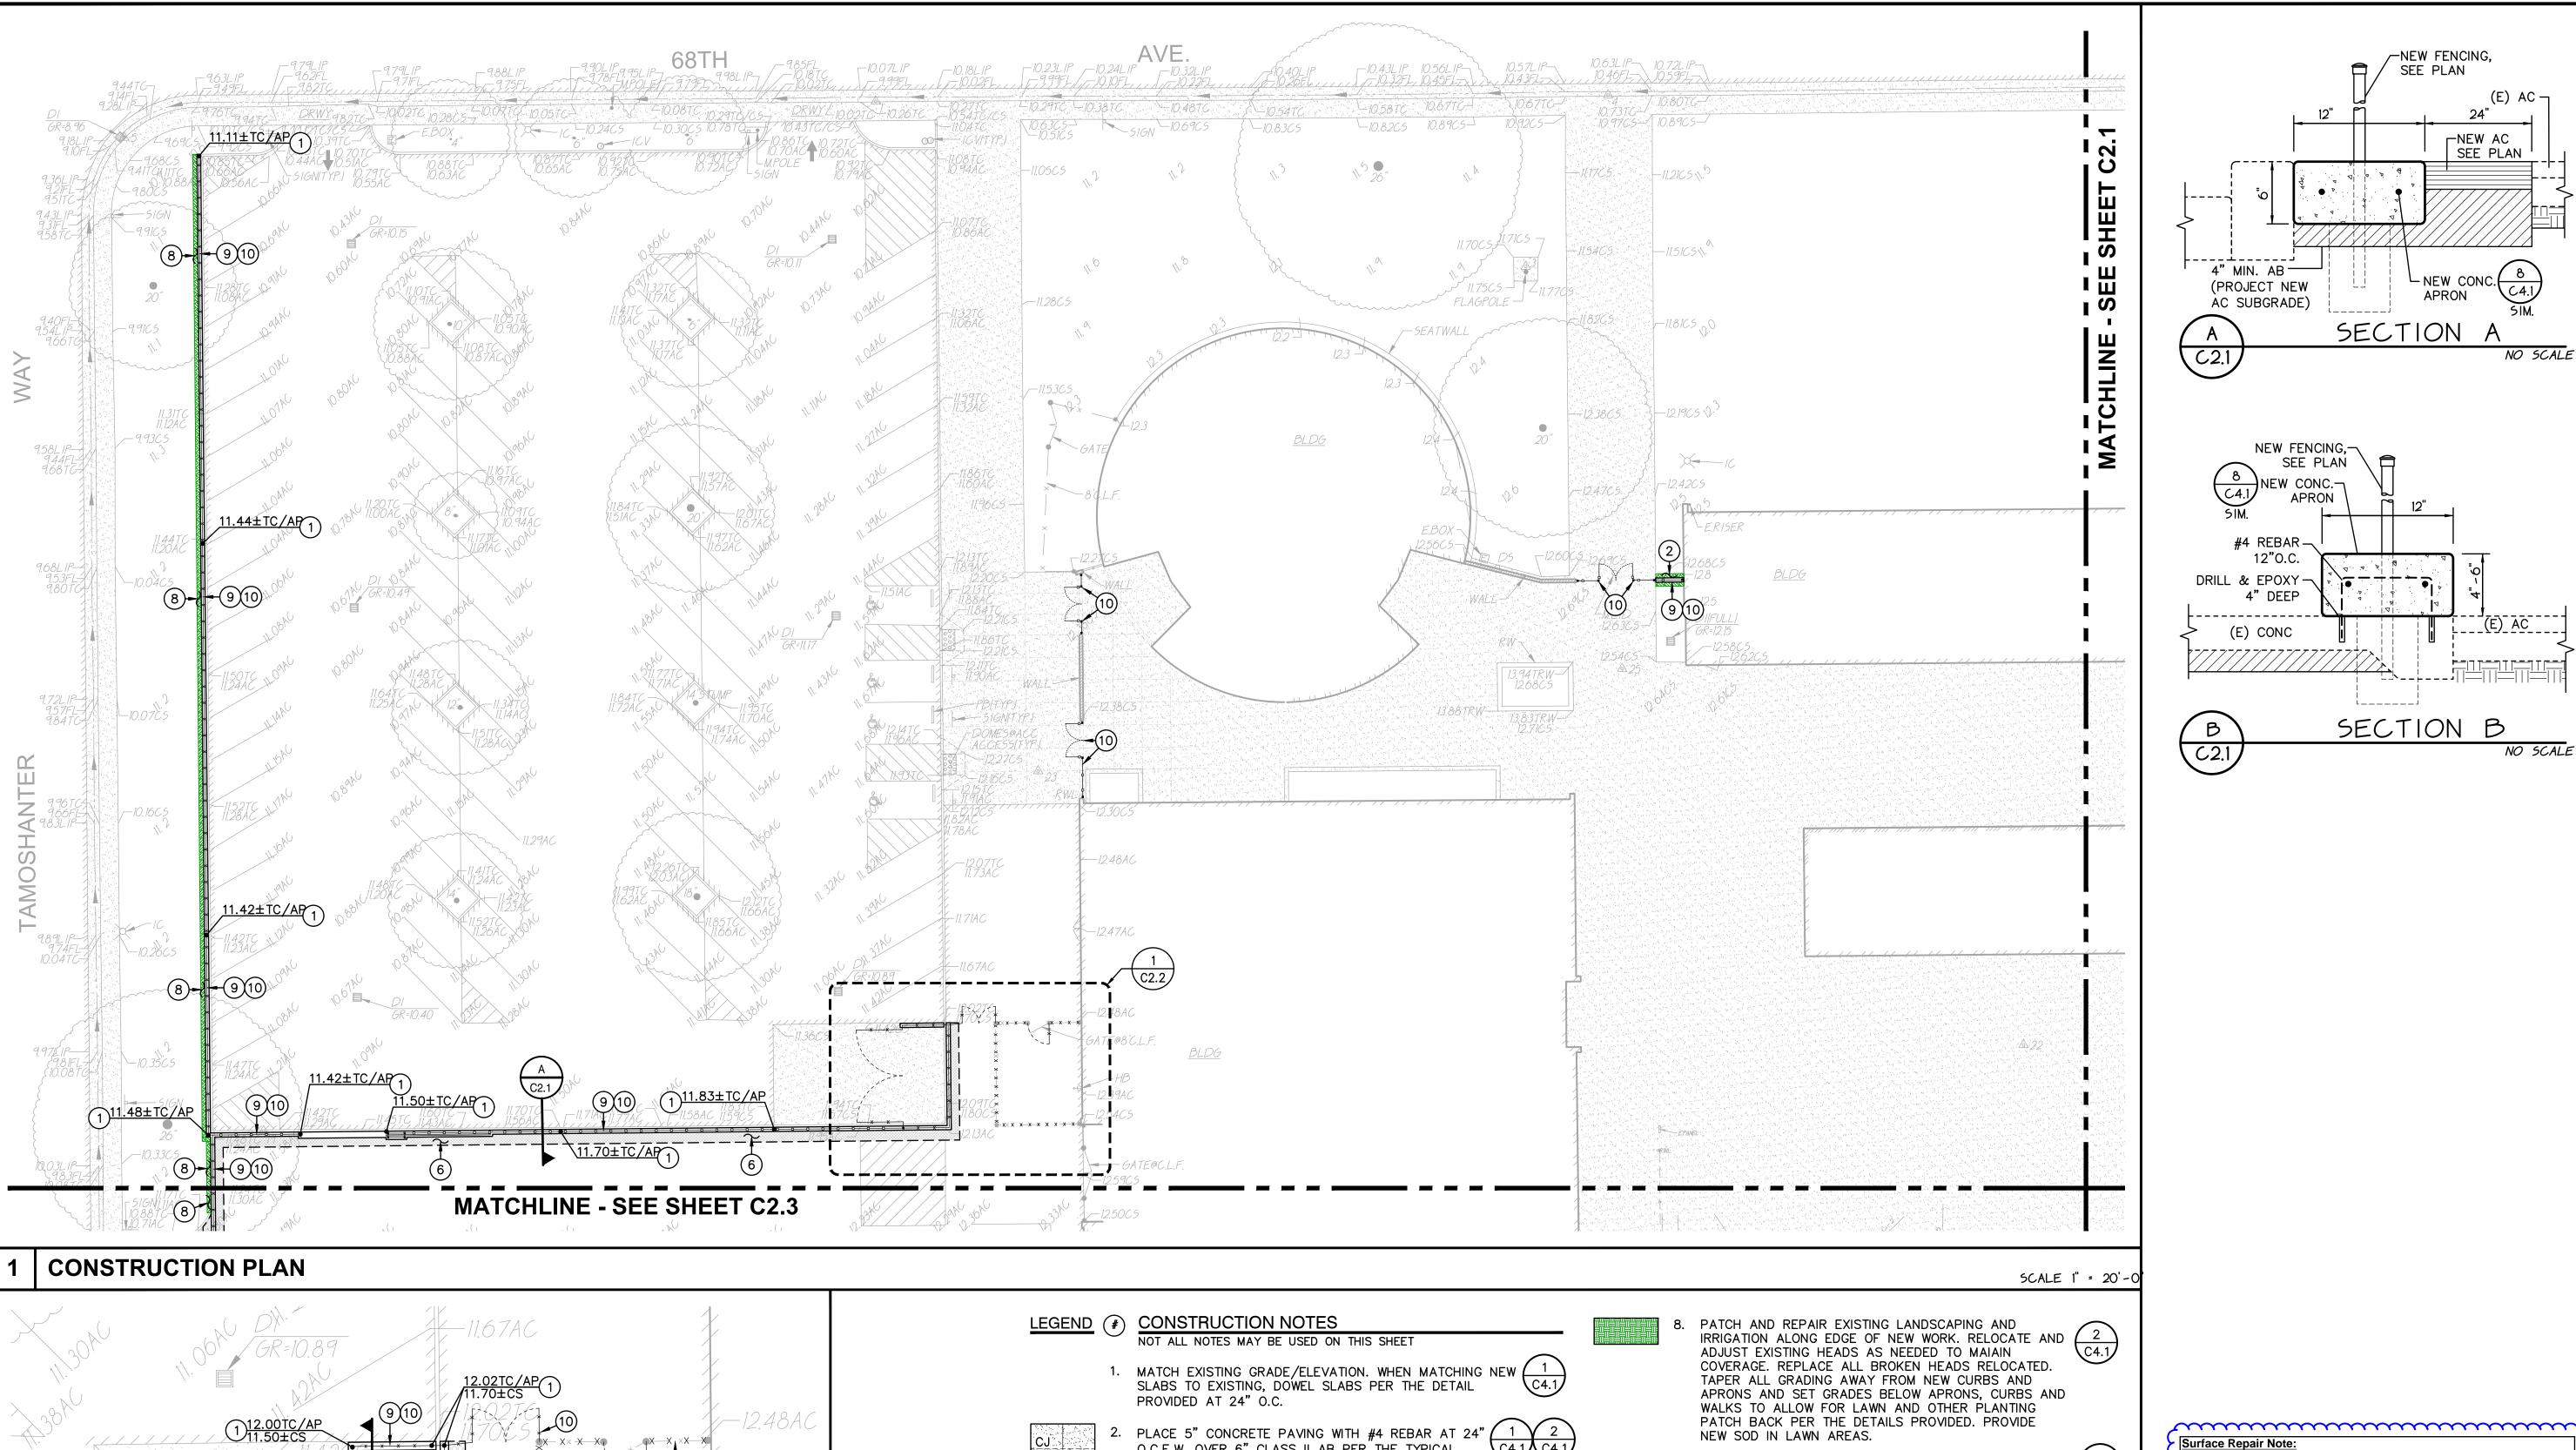

-NEW FENCING, SEE PLAN NEW AC SEE PLAN 4" MIN. AB NEW CONC.

APRON

SIM. (PROJECT NEW ÀC SUBGRADE) SECTION A

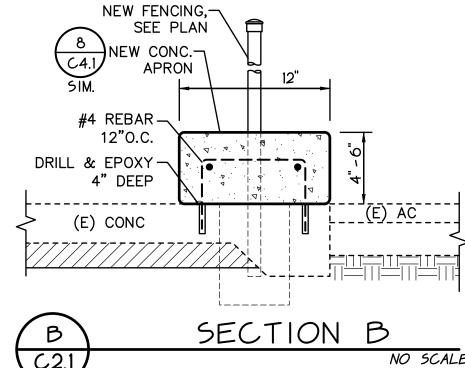



Sacramento **City Unified School District** 

Sacramento City Unified School District 5735 47th Avenue Sacramento, CA 95824-4528

ANTHONY J

Rosa Parks Elementary 2023 Fencing

2250 68th Avenue Sacramento, CA 95822

**REVISIONS** DESCRIPTION 1 ADDENDUM NO.1

DRAWN: SCALE: AS NOTED PROJECT NO. CHECKED: 23-054 DESIGNED: DATE: 4/24/2023 ISSUANCE:

may be repaired with hydro/drilled seeding.

Know what's below. <u>Call</u> before you dig.

**GRAPHIC SCALE** THIS DRAWING MAY HAVE BEEN ENLARGED OR REDUCED.

Regardless if shown or not, all existing improvements and landscaping cut,

landscaping, and irrigation as needed to maintain system operation. Lawn

shall be repaired with sod in well maintained lawn areas. Sparse lawn areas

is especially true along edges of new work. Contractor shall repair

removed or damaged by the installation of new work shall be repaired. This

SHEET TITLE:

**GRADING AND** CONSTRUCTION **PLAN** 

SHEET NO.

C2.1

SCALE 1" = 10'-0

C2.1

(A) (C2.1)

C2.1

11.83±TC/AP(1)

**CONSTRUCTION PLAN** 

O.C.E.W. OVER 6" CLASS II AB PER THE TYPICAL DETAILS PROVIDED. REFER TO PAVING PLAN FOR SECTIONS. REFER TO SPECIFICATIONS SECTION 31 00 00 FOR SUBGRADE PREPARATION, SECTION 32 16 00

FOR CONCRETE PAVING. 3. CONSTRUCT FLUSH CONCRETE EDGE WITH TRUNCATED  $(\frac{4}{C4.1})$ DOMES PER THE DETAIL PROVIDED.

4. SEE FENCING PLAN AND DETAILS FOR ROLLING
GATES AND ADDITIONAL CONCRETE WORK, I.E.
APRONS, TRACKS, ETC.

5. CUT OUT AND PATCH IN CONCRETE CURB FOR NEW  $\sqrt{5}$ GATE POST, PATCH BACK TO MATCH EXISTING GATE POST, PATCH BACK TO MATCH EXISTING SECTION. PROVIDE 2 DOWELS, EACH END, SIM. TO DETAIL.

PLACE 3" AC PAVING OVER 12" CLASS II AB, OR MATCH EXISTING SECTION, WHICHEVER IS GREATER. REFER TO SPECIFICATIONS SECTION 32 12 16 FOR MATERIALS AND CONSTRUCTION. REFER TO SECTION 31 00 00 FOR SUBGRADE PREPARATION.

7. INSTALL NEW TRAFFIC RATED UTILITY BOX OF SAME SIZE AND APPROPRIATE FOR UTILITY. SET NEW BOX FLUSH WITH PROPOSED FINISHED GRADE. WHEN IN NEW CONCRETE AREAS, ALIGN WITH NEW JOINT PATTERNS WHEN POSSIBLE. SEE DEMO PLAN FOR EXISTING BOX REMOVAL.

9. CONSTRUCT 12" WIDE CONCRETE APRON PER THE DETAIL C4.1

10. SEE FENCING PLAN FOR NEW FENCING.

# SUTTERVILLE ELEMENTARY SCHOOL 2023 FENCING


4967 Monterey Way Sacramento, CA 95822

NO SCAL

**PROJECT NARRATIVE** 



# **School District** 1117 WINDFIELD WAY, SUITE 110 L DORADO HILLS, CA 95762 | (916) 985-187

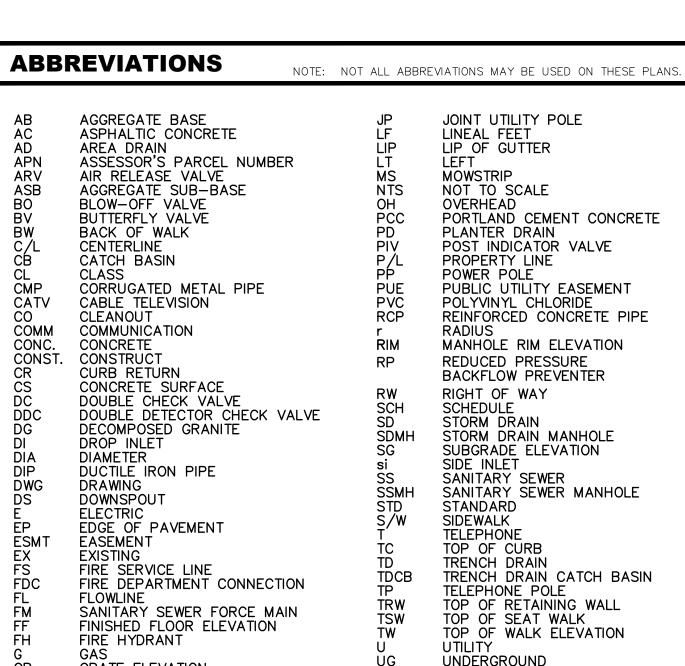

GRADE ELEVATION

HEADER BOARD

PIPE INVERT ELEVATION

PROPOSED GRADING & DRAINAGE

CATCH BASIN (CB)

AREA DRAIN (AD)

STORM DRAIN CLEANOUT

CONCRETE SIDEWALK

DRAINAGE FLOW

TREE TO BE REMOVED

GRADED DIRECTION FOR

DROP INLET (DI)

ELEVATION

ELEVATION

HIGH DENSITY POLYETHYLENE PIPE

GATE VALVE

HOSE BIBB

HIGH POINT

SYMBOLS LEGEND

SYMBOLS:

FF=100.00

PAD=99.33

 $\longrightarrow$  --- $\longrightarrow$ 

UNLESS OTHERWISE NOTED

VITRIFIED CLAY PIPE

WATER

WITHOUT

WATER VALVE

NOTE: NOT ALL SYMBOLS MAY BE USED ON THESE PLANS

—— 8"DW — DOMESTIC WATER LINE & SIZE

RECLAIMED WATER LINE & SIZE

8"IRR I IRRIGATION SERVICE LINE & SIZE

8"NP NON POTABLE WATER LINE & SIZE

## FIRE SPRINKLER SVC. LINE & SIZE

PROPOSED WATER SYMBOLS:

8" FS FIRE LINE & SIZE

───── GATE VALVE

——M—— WATER METER

→ → FH FIRE HYDRANT ASSEMBLY

DETECTOR CHECK VALVE

BUTTERFLY VALVE

FDC FIRE DEPARTMENT CONNECTION


REDUCED PRESSURE

BACKFLOW PREVENTER

AIR RELEASE VALVE + SIZE

DOUBLE DETECTOR CHECK VALVE

WITH

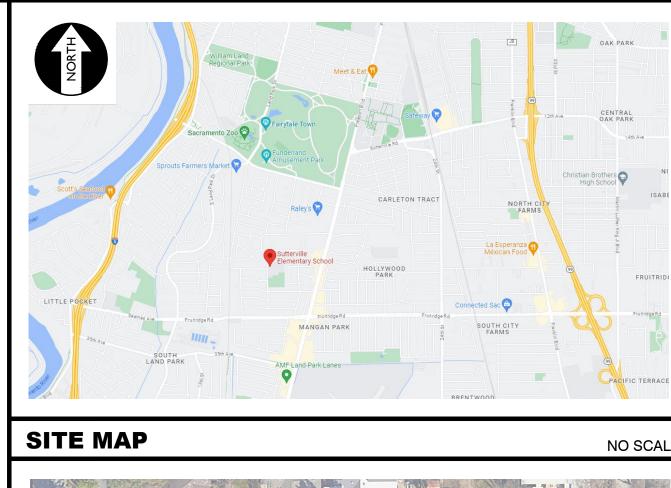

**PROJECT** 

**APPLICABLE CODES & STANDARDS** 

2022 CALIFORNIA ADMINISTRATIVE CODE (CAC), PART 1, TITLE 24 CCR\*

APPROX. CAMPUS BOUNDARY

SCALE

**VICINITY MAP** 

CONSTRUCTION OF SITE FENCING AND GATES ALONG SCHOOL FRONTAGE, ONE ACCESSIBLE EGRESS GATE OF WHICH TO BE PROVIDED WITH ELECTRONIC ACCESS CONTROLS. ADDITIONAL ACCESSIBLE PEDESTRIAN EGRESS AND MAINTENANCE GATES HAVE ALSO BEEN ADDED. ALL PEDESTRIAN GATES IN A KNOWN OR POTENTIAL MEANS OF EGRESS HAVE BEEN PROVIDED WITH PANIC HARDWARE. CONCRETE FLATWORK UPGRADES TO PROVIDE LEVEL LANDINGS AND CORRECT SLOPES OF CONNECTING WALKWAYS IS ALSO PROPOSED AT EACH PEDESTRIAN GATE, BUT ALL FLATWORK PROPOSED IS ONLY FOR COMPLIANCE UPGRADES NECESSARY FOR THE FENCING AND GATE INSTALLATIONS, NO OTHER ELECTIVE FLATWORK IS PROPOSED, ONLY WORK FOR COMPLIANCE.

THERE ARE NO BUILDINGS OR STRUCTURES TO BE CONSTRUCTED, MODERNIZED OR OTHERWISE ALTERNATED BY THIS SET OF PLANS.

# APPLICABLE REGULATIONS

- ALL WORK SHALL CONFORM TO TITLE 24, CALIFORNIA CODE OF REGULATIONS (CCR)
- CHANGES TO THE APPROVED DRAWINGS AND SPECIFICATION SHALL BE MADE BY AN ADDENDA OR A CONSTRUCTION CHANGE DOCUMENT APPROVED BY DSA AS REQUIRED BY SECTION 4-338, PART 1, TITLE 24 CCR.
- SHOULD ANY EXISTING CONDITIONS SUCH AS DETERIORATION OR NON-COMPLYING CONSTRUCTION BE DISCOVERED WHICH IS NOT COVERED BY THE CONTRACT DOCUMENTS WHEREIN THE FINISHED WORK WILL NOT COMPLY WITH TITLE 24, CCR, A CONSTRUCTION CHANGE DOCUMENT (CCD), OR A SEPARATE SET OF PLANS AND SPECIFICATIONS. DETAILING AND SPECIFYING THE REQUIRED WORK SHALL BE SUBMITTED TO AND APPROVED BY DSA BEFORE PROCEEDING WITH THE WORK. (SECTION 4-317, PART 1, TITLE 24, CCR)
- A DSA CERTIFIED PROJECT INSPECTOR EMPLOYED BY THE DISTRICT (OWNER) AND APPROVED BY DSA SHALL PROVIDE CONTINUOUS INSPECTION OF THE WORK. THE DUTIES OF THE INSPECTOR ARE DEFINED IN SECTION 4-342, PART 1, TITLE 24,
- THIS PROJECT REQUIRES INSPECTOR CLASS 3
- GRADING PLANS, DRAINAGE IMPROVEMENTS, ROAD AND ACCESS REQUIREMENTS AND ENVIRONMENTAL HEALTH CONSIDERATIONS SHALL COMPLY WITH ALL LOCAL ORDINANCES.

# SPECIAL TESTING:

CONTRACTOR SHALL PROVIDE AND COORDINATE TESTING OF NEW LIGHTING CONTROLES MECHANICAL SYSTES, ENVELOPES AND PROCESS EQUIPMENT AND SYSTEMS IN ACCORDANCE WITH CALIFORNIA ENERGY CODE, SECTION 10-103.

# **DEFERRED APPROVALS**

THE TYPES, LOCATIONS, SIZES, AND/OR DEPTHS OF EXISTING UNDERGROUND UTILITIES AS SHOWN ON THESE PLANS WERE OBTAINED FROM SOURCES OF VARYING RELIABILITY. THE CONTRACTOR IS CAUTIONED THAT ONLY ACTUAL EXCAVATION WILL REVEAL THE TYPES, EXTENT, SIZES, LOCATIONS AND DEPTHS OF SUCH UNDERGROUND UTILITIES. A REASONABLE EFFORT HAS BEEN MADE TO LOCATE AND DELINEATE ALL KNOWN UNDERGROUND UTILITIES. HOWEVER, WARREN CONSULTING ENGINEERS CAN ASSUME NO

**GENERAL NOTES** 

APPLICATION.

RESPONSIBILITY FOR THE COMPLETENESS OR ACCURACY OF ITS DELINEATION OF SUCH UNDERGROUND UTILITIES, NOR FOR THE EXISTENCE OF OTHER BURIED OBJECTS OR UTILITIES WHICH MAY BE ENCOUNTERED BUT WHICH ARE NOT SHOWN ON THESE PLANS. THE CONTRACTOR OR ANY SUBCONTRACTOR FOR THIS CONTRACT SHALL NOTIFY MEMBERS OF UNDERGROUND SERVICE ALERT (USA) TWO (2) WORKING DAYS IN ADVANCE OF PERFORMING ANY EXCAVATION WORK BY CALLING TOLL FREE 1-800-227-2600, OR 811

IMPROVEMENTS, HORIZONTAL OR VERTICAL, IF STAKED BY OTHERS. IN ADDITION, ANY SUCH ERRORS IN PHYSICAL LOCATION MAY AFFECT THE INTENDED DESIGN OF SUCH IMPROVEMENTS AND WCE CANNOT BE HELD RESPONSIBLE FOR SUCH CONDITIONS WHICH ARE A RESULT OF ERRORS IN SURVEYING, OR IMPROPER CONSTRUCTION.

SUBSURFACE CULTURAL RESOURCES, REMAINS, AND/OR ARTIFACTS ARE UNCOVERED DURING PROJECT CONSTRUCTION, ALL WORK IN THE VICINITY SHALL BE STOPPED UNTIL SUCH ITEMS CAN BE ASSESSED BY AN APPROPRIATE MEMBER OF THE COUNTY ENVIRONMENTAL IMPACT SECTION STAFF

CONTRACTOR AGREES THAT HE/SHE SHALL ASSUME SOLE AND COMPLETE RESPONSIBILITY FOR JOB SITE CONDITIONS DURING THE COURSE OF CONSTRUCTION OF THIS PROJECT, INCLUDING SAFETY OF ALL PERSONS AND PROPERTY: THAT THIS REQUIREMENT SHALL APPLY CONTINUOUSLY AND SHALL NOT BE LIMITED TO NORMAL WORKING HOURS: AND THAT THE CONTRACTOR SHALL DEFEND, INDEMNIFY AND HOLD THE OWNER AND ENGINEER HARMLESS FROM ANY AND ALL LIABILITY, REAL OR ALLEGED, IN CONNECTION WITH THE PERFORMANCE OF WORK ON THIS PROJECT, EXCEPTING FOR LIABILITY ARISING FROM THE SOLE NEGLIGENCE OF THE OWNER OR ENGINEER.

THE CONTRACTOR SHALL OBTAIN AN EXCAVATION PERMIT FROM THE STATE OF CALIFORNIA DEPARTMENT OF INDUSTRIAL SAFETY FOR ALL EXCAVATIONS OF 5 FEET OR MORE IN DEPTH.

IT SHALL BE THE CONTRACTOR'S RESPONSIBILITY TO MAKE ALL NECESSARY PRE-BID AND PRE-CONSTRUCTION SITE INSPECTION, AND/OR OBSERVATIONS ON THE SITE TO PRE-DETERMINE ALL HIS/HER MEANS AND METHODS NECESSARY TO COMPLETE THE IMPROVEMENTS SHOWN ON THESE PLANS AND PER THE PROJECT SPECIFICATIONS IT IS THE CONTRACTORS RESPONSIBILITY TO DETERMINE, AND INCLUDE IN HIS/HER CONTRACT, ALL MEANS AND METHODS NECESSARY TO PERFORM A COMPLETE AND ACCEPTABLE JOB

WHERE IMPROVEMENTS LIE WITHIN AN EXISTING DEVELOPED AREA, CONTRACTOR SHALL USE CAUTION WHEN ACCESSING THE SITE THROUGH THESE EXISTING IMPROVEMENTS. IT IS THE CONTRACTORS RESPONSIBILITY TO PROTECT ANY SUCH EXISTING IMPROVEMENTS OUTSIDE THE PROJECT BOUNDARY, OR EXISTING IMPROVEMENTS WITHIN THE BOUNDARY WHICH ARE TO REMAIN. PROPER PRECAUTIONS SHALL BE PROVIDED AND MAINTAINED THROUGHOUT CONSTRUCTION. ANY DAMAGE SHALL BE REPAIRED OR REPLACED TO THE SATISFACTION OF THE

IT IS THE RESPONSIBILITY OF THE CONTRACTOR TO KEEP DETAILED RECORDS OF MINOR CHANGES OR ADJUSTMENTS MADE DURING CONSTRUCTION (WHICH WERE NOT FORMALLY ISSUED). UPON PROJECT COMPLETION, THESE RECORDS AND/OR INFORMATION SHALL BE PROVIDED TO THE OWNER AND WARREN CONSULTING ENGINEERS INC. UNLESS AN OFFICIAL "AS-BUILT" SET OF PLANS IS A REQUIREMENT OF THE CONTRACT. IF AS-BUILT PLANS ARE A REQUIREMENT OF THE CONTRACT, REFER TO SPECIFICATIONS FOR AS-BUILT DELIVERABLE REQUIREMENTS.

IN VEHICULAR PATHWAYS, EXISTING ASPHALTIC AND/OR CONCRETE SURFACES SHALL BE CUT TO A NEAT AND STRAIGHT LINE, PARALLEL OR PERPENDICULAR TO THE VEHICULAR TRAVELED PATH. THIS IS TYPICALLY THE ROADWAY CENTERLINE, BUT MAY VARY. THAT SAWCUT EDGE SHALL BE PROTECTED FROM DAMAGE DURING CONSTRUCTION SO A CLEAN EDGE REMAINS FOR PATCH BACK.. IF EDGE IS DAMAGED, A NEW SAW CUT WILL BE REQUIRED. THE EXPOSED EDGE SHALL BE "TACKED" WITH EMULSION PRIOR TO PAVING.

NO BURNING OR BLASTING SHALL BE ALLOWED ONSITE UNLESS SPECIFICALLY ADDRESSED ON PLANS, OR SPECIFICALLY APPROVED AND COORDINATED WITH THE ARCHITECT, ENGINEER, AND LOCAL AGENCY OR OTHER ADMINISTRATIVE AUTHORITY.

SUBGRADE AND RESULTING FINISHED GRADE SHALL BE CONSTRUCTED SMOOTH AND UNIFORM BETWEEN SPOT ELEVATIONS, CONTOURS OR OTHER STRUCTURE ELEVATIONS SHOWN ON GRADING OR OTHER PLANS. NO MOUNDS, RUTS, DEPRESSIONS OR OTHER GRADING DEFICIENCIES WILL BE ALLOWED UNLESS SPECIFICALLY SHOWN ON PLANS.

12. ON NEW WATER SYSTEMS, SERVICE LATERALS SHALL BE MADE USING APPROPRIATE "TEE" AND "WYE" FITTINGS.

SADDLE TAPS WILL ONLY BE ALLOWED WHEN MAKING CONNECTIONS TO EXISTING WATER MAINS. CURING COMPOUND SHALL BE APPLIED IN A CONTINUOUS SOLID WET FLOWING COAT. ANY "SPOTTY" APPLICATIONS SHALL BE RECOATED IMMEDIATELY. APPLICATION SHALL BE INSPECTED BY PROJECT INSPECTOR DURING

EMBEDMENT OF FEATURES IN CONCRETE PAVING, CURBS, OR WALLS, SUCH AS SQUARE OR ROUND TUBING, POSTS, OR COLUMNS, STEEL BOLTED PLATES, OR OTHER STRUCTURES, SHALL REQUIRE ADDITIONAL SCORE OR EXPANSION JOINTS TO PREVENT UNCONTROLLED CRACKING. THOSE ADDITIONAL JOINTS MAY OR MAY NOT BE SPECIFICALLY SHOWN ON PLANS BUT SHALL BE PROVIDED BY THE CONTRACTOR.

EMBEDMENT OF FEATURES IN CONCRETE PAVING, CURBS, OR WALLS, SUCH AS SQUARE OR ROUND TUBING, POSTS, OR COLUMNS, STEEL BOLTED PLATES, OR OTHER STRUCTURES, SHALL REQUIRE A MINOR ADJUSTMENT OF REBAR WITHIN CONCRETE TO ALLOW FOR SUCH STRUCTURE. THAT REBAR ADJUSTMENT MAY NOT BE SPECIFICALLY SHOWN

NO MORE THAN 1 GALLON OF WATER PER YARD OF CONCRETE CAN BE ADDED TO THE TRUCK AFTER ARRIVAL TO PROJECT SITE. THE ADDITION OF WATER CAN ONLY BE ADDED UNDER THE SUPERVISION OF THE CONCRETE INSPECTOR OR LABORATORY TECHNICIAN.

WHEN PUMPING CONCRETE FOR PLACEMENT, ABSOLUTELY NO WATER IS TO BE ADDED TO PUMP HOPPER. ANY WATER ADDED TO HOPPER WILL BE REASON FOR CONCRETE REJECTION AT THE CONTRACTORS EXPENSE.

18. ALL CONTRACTION/CONSTRUCTION JOINTS "CJ" SHALL BE 1/4 THE SLAB THICKNESS DEEP, BUT NO LESS THAN 1' FOR CONTROLLING OF CRACKING. CONTRACTOR SHALL EXERCISE CAUTION WHEN FINAL TROWELING OF CONCRETE SO AS NOT TO FILL IN THESE JOINTS WITH CONCRETE CREAM. ANY CRACKS OUTSIDE OF JOINTS WHICH WERE CONSTRUCTED LESS THAN 1" DEEP, SHALL BE CAUSE FOR CONCRETE SLAB(S) TO BE REMOVED AND REPLACE AT CONTRACTORS EXPENSE.

19. ANY SCREED BOARDS SET WITHIN CONCRETE SLABS SHALL BE AN "OVERHEAD SCREED" SO THERE IS NO INTERFERENCE WITH THE PLACEMENT AND ALIGNMENT OF SLAB REINFORCING.

20. 3-1/2" FELT JOINTS WILL NOT BE ACCEPTED. PROVIDE A FULL 4" FELT JOINT FOR 4" SLAB CONSTRUCTION, AND A 6" FELT JOINT FOR A 6" SLAB SLAB CONSTRUCTION.

SHOULD ANY SHRINKAGE CRACKS OCCUR OUTSIDE OF EITHER THE EXPANSION JOINTS OR CRACK CONTROL JOINTS, THEN THE CONCRETE SLAB SHALL BE SAWCUT AT THE NEAREST JOINTS ON EACH SIDE OF THE CRACK AND THE CONCRETE SECTION SHALL BE, REMOVED AND REPLACED. NEW CONCRETE SHALL BE DOWELED INTO EXISTING CONCRETE PER DRAWING DETAIL.

23. REPAIR OR PATCHING OF GALVANIZED METALS, SUCH AS AFTER WELDING GALVANIZED COMPONENTS, SHALL BE

MADE USING A ZINC COMPOSITION "HOT STICK" APPLICATION PER ASTM A 780-01. GALVANIZING PAINTS WILL NOT

- EQUIVALENT OF HEAVY BROOM FINISH AT SLOPES 6% AND GREATER. REFER TO SPECIFICATIONS.
- ALL NEW PEDESTRIAN WALKWAYS (NON-RAMP) SHALL BE SLOPED NO GREATER THAN 2.0%, AND NO LESS THAN 0.75% IN ANY DIRECTION, UNLESS SPECIFICALLY LABELED OTHERWISE. ALL

**SHEET INDEX** 

NO. SHEET DESCRIPTION

CO.O COVER SHEET

C1.0.1 SITE ACCESS PLAN C1.0.2 FIRE ACCESS PLAN **Call** before you dig.

Know what's **below** 

C1.1 DEMOLITION PLAN C2.1 GRADING AND CONSTRUCTION PLAN

TOPOGRAPHIC SURVEY

C2.2 GRADING AND CONSTRUCTION PLAN

C2.3 GRADING AND CONSTRUCTION PLAN

C3.1 FENCING PLAN

C4.1 DETAILS AND SECTIONS C4.2 DETAILS AND SECTIONS

C4.4 DETAILS AND SECTIONS

C4.3 DETAILS AND SECTIONS

**ELECTRICAL** 

T000 TECHNOLOGY COVER SHEET T200 TECHNOLOGY FLOOR PLAN MAIN GATE

T201 TECHNOLOGY FLOOR PLAN SOUTH MAN GATE

T900 TECHNOLOGY SIGNLE LINE AND DETAILS

ANTHONY J TASSANO

Sacramento City

5735 47th Avenue

**Unified School District** 

Sacramento, CA 95824-4528

Sacrament

**City Unified** 

**School District** 

Sutterville Elementary 2023 Fencing

4967 Monterey Way Sacramento, CA 95822

**BEVISIONS** 

SCALE:

TOTAL SHEET COUNT = 16

| OWNER/USER    |   |   | NEVISIONS     |  |  |  |
|---------------|---|---|---------------|--|--|--|
|               |   |   | DESCRIPTION   |  |  |  |
| OWNER:        | SACRAMENTO CITY   | 1 | ADDENDUM NO.1 |  |  |  |
| · · · · · · · | UNIFIED SCHOOL DISTRICT<br>5735 47TH AVE. SACRAMENTO, CA<br>95824-4528<br>PHONE: (916) 643-9000 |   |               |  |  |  |
|               |   |   |               |  |  |  |
|               |   |   |               |  |  |  |
|               | <u>DISTRICT_CONTACT:</u><br>[CONTACT]   |   |               |  |  |  |
|               | FACILITIES SUPPORT SERVICES   |   |               |  |  |  |

(916) 264-4075 ADDITIONAL CONTACTS: TROY MIETZ TROY-MIETZ@SCUSD.EDU

AS NOTE PROJECT NO. CHECKED: 23-056 DESIGNED: 4/24/2023 ISSUANCE:

DRAWN:


# PROJECT TEAM


WARREN CONSULTING ENGINEERS. INC. CIVIL: 1117 WINDFIELD WAY, SUITE 110 EL DORADO HILLS, CA 95762 PHONE: (916) 985-1870 FAX: (916) 985-1877

ELEC: KMM SERVICES, INC. 5433 EL CAMINO AVE #5 CARMICHAEL, CA 95608 PHONE: (916) 359-4000 **COVER SHEET** 

SHEET NO.

TREE TO REMAIN **STATEMENTS:** BLOW-OFF VALVE + SIZE 22. ALL AREAS DISTURBED BY GRADING OPERATIONS WHETHER SHOWN ON THE DRAWINGS OR NOT SHALL BE HYDRO 2022 CALIFORNIA BUILDING CODE (CBC), PART 2, TITLE 24 CCR SEEDED UNLESS OTHERWISE NOTED. HYDRO SEEDING SHALL CONFORM TO LOCAL CITY/COUNTY STANDARDS. (2018 INTERNATIONAL BUILDING CODE, VOL. 1 & 2, AND 2019 CALIFORNIA AMENDMENTS) RETAINING WALL POST INDICATOR VALVE 2022 CALIFORNIA ELECTRICAL CODE (CEC), PART 3, TITLE 24 CCR OVERLAND RELEASE PATH (2017 NATIONAL ELECTRICAL CODE AND 2019 CALIFORNIA AMENDMENTS) 2022 CALIFORNIA PLUMBING CODE (CPC), PART 5, TITLE 24 CCR (2018 IAPMO UNIFORM PLUMBING CODE AND 2019 CALIFORNIA AMENDMENTS) **GENERAL PAVING SURFACE NOTES:** PROPOSED SANITARY SEWER SYMBOLS: 2022 CALIFORNIA ENERGY CODE (CEC), PART 6, TITLE 24 CCR 6" SS SANITARY SEWER LINE PROVIDE EQUIVALENT OF MEDIUM BROOM FINISH AT SLOPES UP TO 5.99%, TYPICAL. PROVIDE 2022 CALIFORNIA FIRE CODE (CFC), PART 9, TITLE 24 CCR (SIZE AND FLOW SHOWN) (2018 INTERNATIONAL FIRE CODE AND 2019 CALIFORNIA AMENDMENTS) 2022 CALIFORNIA REFERENCED STANDARDS CODE, PART 12. TITLE 24 CCR SANITARY SEWER TITLE 19 CCR, PUBLIC SAFETY, STATE FIRE MARSHAL REGULATIONS MANHOLE (SSMH) CONCRETE SHALL MEET THE FOLLOWING SLOPE REQUIREMENTS: 2022 CALIFORNIA ENERGY CODE (CGC), Part 11, Title 24 CCR. SEWER CLEANOU? - NO GREATER THAN 5% SLOPE IN THE DIRECTION OF TRAVEL. FLUSHER BRANCH NO GREATER THAN 2% SLOPE CROSSING THE DIRECTION OF TRAVEL - NO GREATER THAN 2% SLOPE IN ANY DIRECTION IN COURTYARD OR PLAZA AREAS.

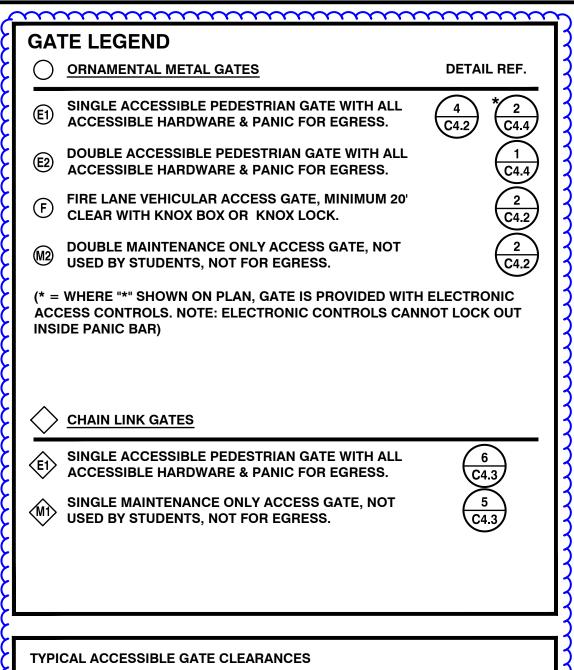

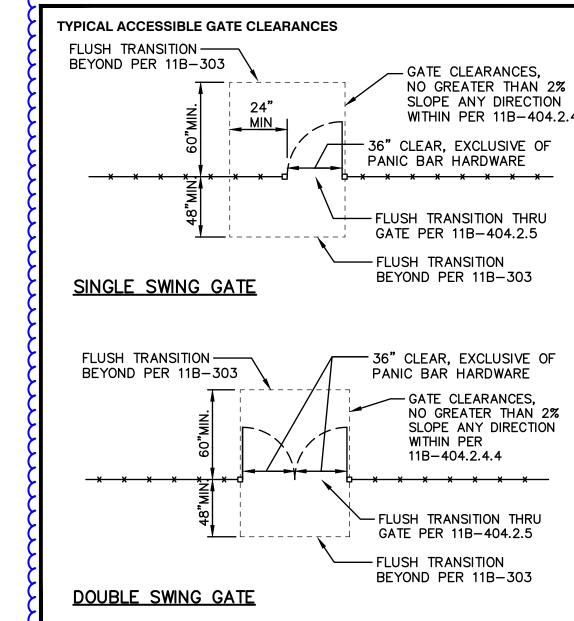


**GENERAL SITE PLAN AND ACCESS NOTES:** 

1. Slope shall not be steeper than 1:48 in any direction in open areas." At least one accessible route within the boundary of the site shall be provided from public way, accessible parking, and accessible restrooms, to area of work.

2. Slopes in direction of P.O.T. greater than 1:20 are considered ramps(11B-405); Please show all.

3. Walks in path of travel shall be free of gratings wherever possible. Grating which occur within the P.O.T. shall have grid openings at  $\frac{1}{2}$ " maximum in the direction of traffic flow per CBC Section 11B-302.3; Provide manufactures cut-sheets for review.

4. When provided, all new gates and gates on path of travel must comply with 11B-404 requirements. Provide a 24" min. Strike side clearance on pull side and a smooth surface at the bottom 10 inches of push side of gate. Specify accessible / lever hardware.

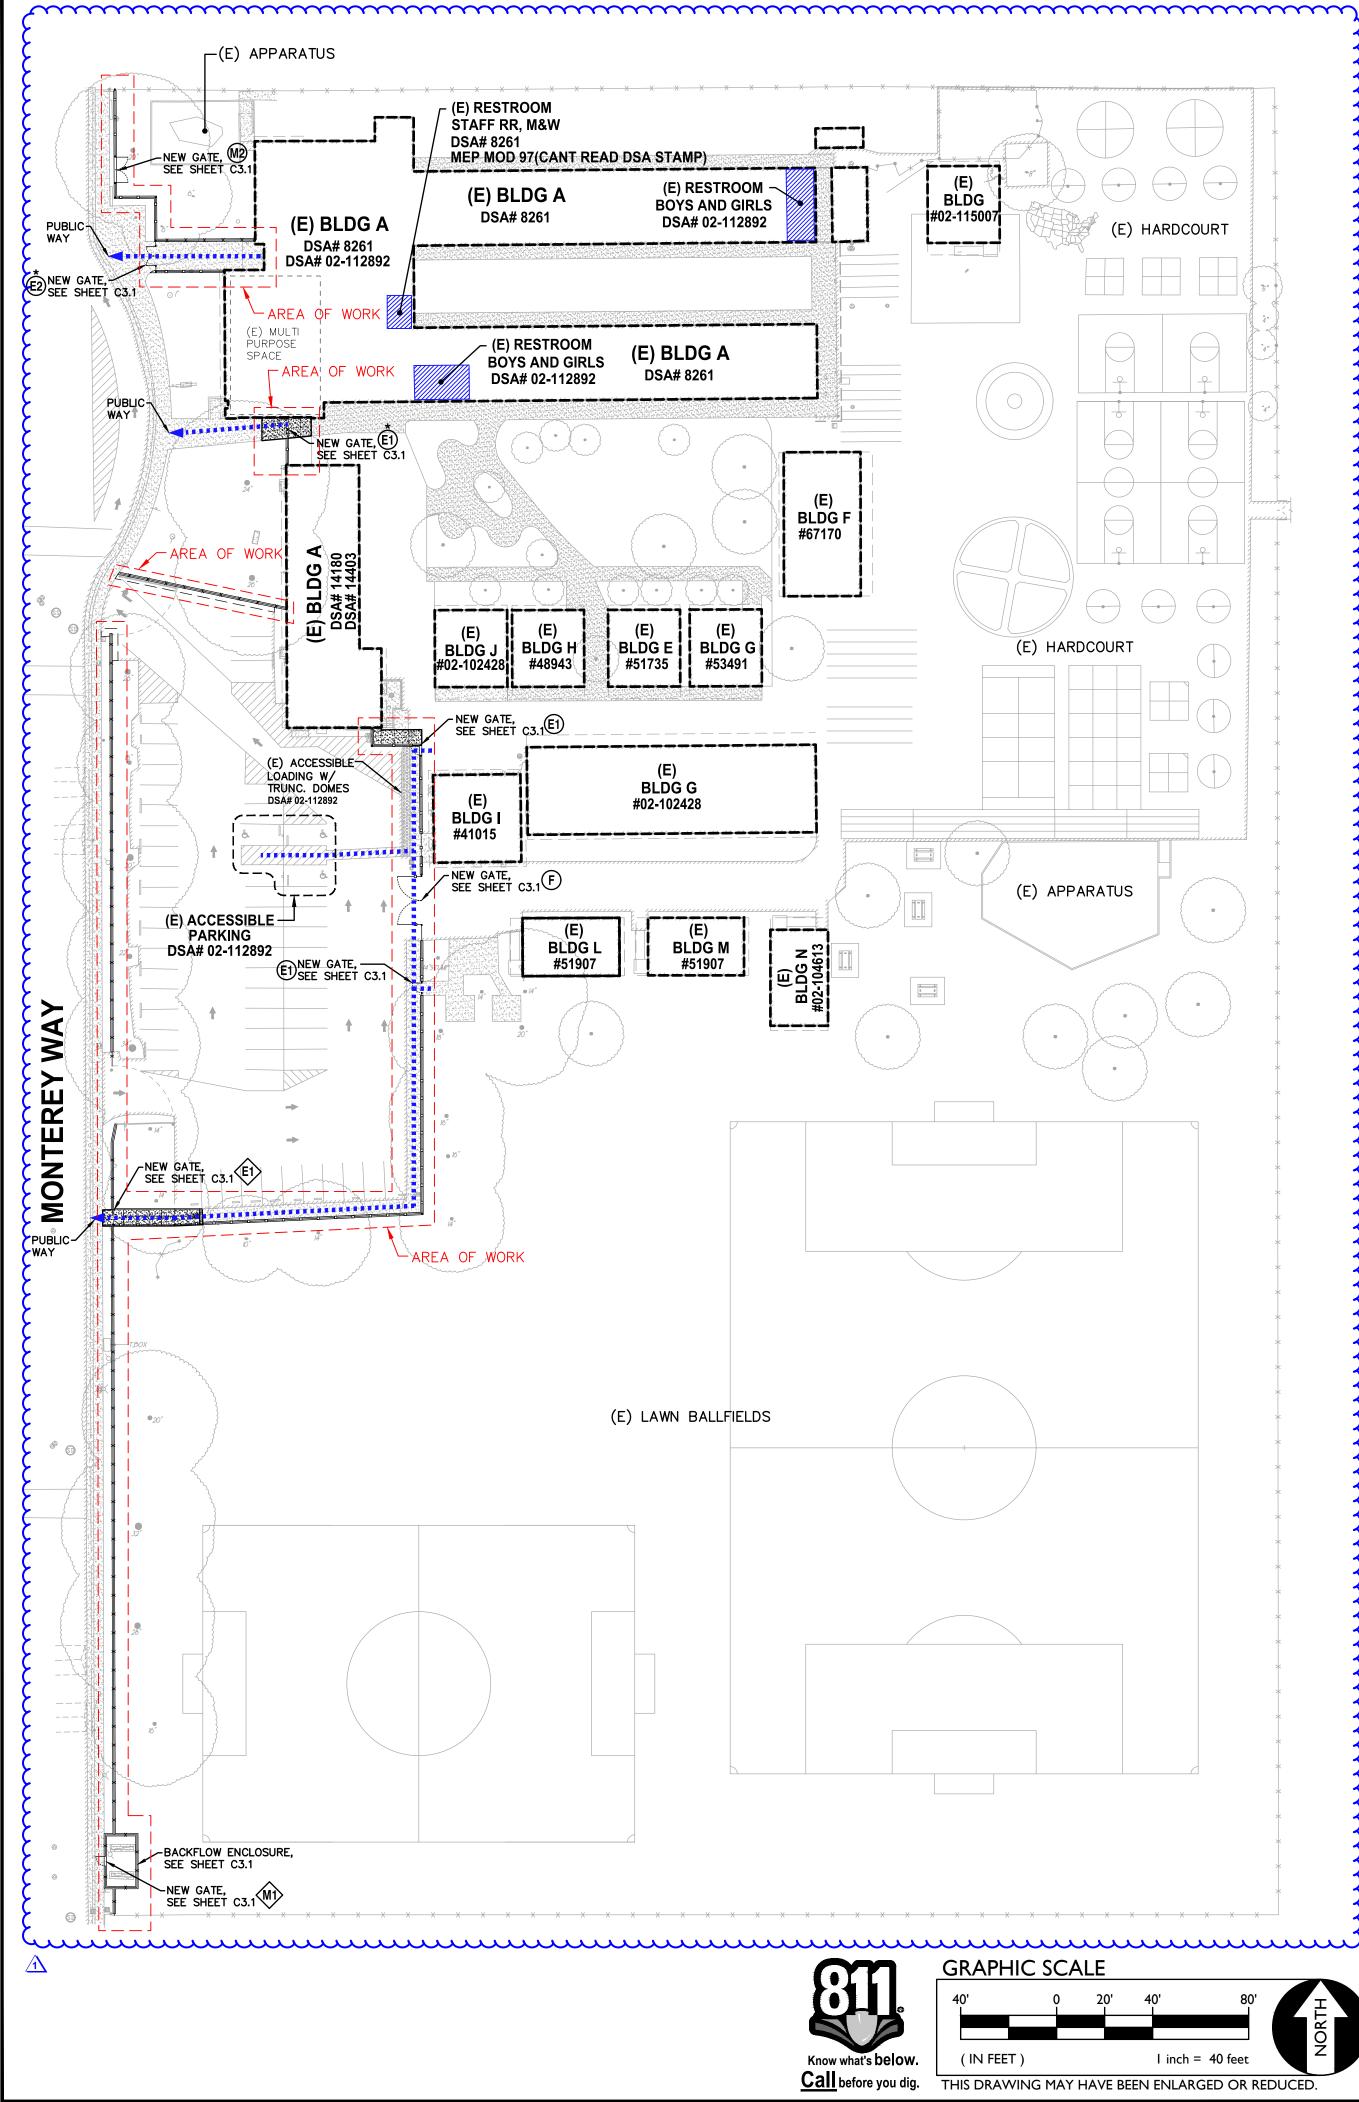

# **FENCEING ONLY PROJECT ACCESSIBLE PATH OF TRAVEL**

IN ACCORDANCE WITH DSA IR A-22, ITEM NO. 12, KEYNOTE 4, THE ACCESSIBLE PATH OF TRAVEL REVIEW SHALL BE LIMITED TO WHERE NEW FENCES AND GATES AFFECT/CROSS AN ACCESSIBLE PATH OF TRAVEL.

# **ACCESSIBLE PATH OF TRAVEL (P.O.T.)**

TO THE BEST OF THE KNOWLEDGE OF THE ARCHITECT AND/OR ENGINEER, OR THE DISTRICT, THE PATH OF TRAVEL (P.O.T.) AS INDICATED, IS A BARRIER FREE ACCESS ROUTE CONFORMING TO THE FOLLOWING:

- THERE ARE NO ABRUPT LEVEL CHANGES EXCEEDING 1/2" IF BEVELED AT 1V:2H MAX SLOPE, OR VERTICAL LEVEL CHANGES NOT EXCEEDING
- THE MINIMUM WIDTH OF THE P.O.T. IS 48" AT ANY GIVEN POINT.
- THE SURFACE OF THE P.O.T. STABLE, FIRM, AND SLIP RESISTANT.
- THE MAXIMUM SLOPE IN THE DIRECTION OF TRAVEL IS 5.0% (11B-403.3), UNLESS OTHERWISE INDICATED, WITH THE FOLLOWING EXCEPTIONS:
- A. THE SLOPED PORTION OF "RAMP" DOES NOT EXCEED 8.33% (1V:12H) IN THE DIRECTION OF TRAVEL (11B-405.2).
- B. THE SLOPED PORTION OF A "CURB RAMP" DOES NOT EXCEED 8.33% (1V:12H) IN THE DIRECTION OF TRAVEL (11B-406.2.1 AND 11B-406.3.1).
- THE CROSS SLOPE OF THE ACCESSIBLE PATH OF TRAVEL DOES NOT EXCEED 2% AT ANY GIVEN POINT (11B-403.3).
- THE ACCESSIBLE PATH OF TRAVEL SHALL BE MAINTAINED FREE OF OVERHANGING OBSTRUCTIONS TO 80" MINIMUM (11B-307).
- THERE ARE NO PROTRUDING OBJECTS GREATER THAN 4" PROJECTION FROM WALL AND ABOVE 27" AND LESS THAN 80" (11B-307).
- PASSING SPACES AT LEAST 60"X60" ARE LOCATED NOT MORE THAT 200'
- APART. (11B-403.5.3) PARTS OF P.O.T. WITH CONTINUOUS GRADIENTS HAVE 60" LEVEL

AREAS NOT MORE THAN 400' APART. (11B-407.3)

- 10. THERE IS NO DROP-OFF OVER 4" AT THE EDGE OF WALK OR LANDING. (11B-303.5)
- 11. ARCHITECT AND CONTRACTOR SHALL VERIFY THAT ALL BARRIERS ON
- 12. THERE ARE NO GRATINGS WITHIN THE PATH OF TRAVEL WITH GRATE

THE INDICATED PATH OF TRAVEL HAVE BEEN REMOVED.

OPENINGS EXCEEDING 1/2" IN THE DIRECTION OF TRAVEL. (11B-302.3)

#### **DSA PR-1501**

(11B-403.5.1)

#### "Design Professional in General Responsible Charge Statement:

The POT identified in these construction documents meets the requirements of the current applicable California Building Code (CBC) accessibility provisions for path of travel requirements for alterations, additions and **structural repairs**. As part of the design of this project, the POT was examined and any elements, components or portions of the POT that were determined to be noncompliant with the CBC have been identified and the corrective work necessary to bring them into compliance has been included within the scope of this project's work through details, drawings and specifications incorporated into these construction documents. Any noncompliant elements, components or portions of the POT that will not be corrected by this project based on valuation threshold limitations or a finding of unreasonable hardship are indicated in these construction documents.

During construction, if POT items within the scope of the project represented as CBC compliant are found to be nonconforming beyond reasonable construction tolerances, the items shall be brought into compliance with the CBC as a part of this project by means of a construction change document."

PROJECT PARKING CALCULATION







EL DORADO HILLS, CA 95762 | (916) 985-1870

Sacramento City **Unified School District** 5735 47th Avenue Sacramento, CA 95824-4528

ONSULTANT:

ANTHONY J. TASSANO

Sutterville 2023 Fencing

4967 Monterey Way Sacramento, CA 95822

| PARKING LOT A<br>PARKING TOTALS                                    | EXISTING | PROPOSED |
|--|----------|----------|
| TANDARD PARKING STALLS   | 54       | 54       |
| CCESSIBLE PARKING SPACES   | 3        | 3        |
| VERALL TOTAL PARKING SPACES  | 57       | 57       |
| E) ACCESSIBLE SPACE REQUIREMENTS                                   | REQUIRED | PROVIDED |
| EQUIRED ACCESSIBLE SPACES (CAR)                                    | 2        | 2        |
| EQUIRED ACCESSIBLE SPACES (VAN)                                    | 1        | 1        |
| OTAL REQUIRED ACCESSIBLE SPACES<br>PER 2019 CBC SECTION 11B-208.2) | 3        | 3        |
|  |          |          |

# **LEGEND**

EXISTING BUILDING NOT MODERNIZED BY THIS S STORAGE CONTAINER / SHED ACCESSIBLE PATH OF TRAVEL (P.O.T.) - LIMIT/END OF PATH OF TRAVEL THIS PROJECT. —— PATH OF TRAVEL CONTINUATION INTO ACCESSIBLE NEW CONCRETE WALKWAY (SEE SHEET C3.1) EXISTING CONCRETE WALKWAY (SEE SHEET CO.1-CO.2 & C2.1)

SCOPE OF PROJECT

— PROPERTY LINE ---- ROAD CENTERLINE

ST STORAGE, SHED/CONTAINER ACCESSIBLE RESTROOM (PROJECT COMPLIANCE)

DRAWN: SCALE: AS NOTED CHECKED: PROJECT NO. 23-056 DESIGNED: SMN/AT 4/24/2023 ISSUANCE:

**REVISIONS** 

DESCRIPTION

ADDENDUM NO.1

SHEET TITLE:

SITE ACCESS **PLAN** 

SHEET NO.

C1.0.1

SITE ACCESS PLAN

SCALE 1" = 40'-0"

# FIRE LANE DESIGNATION

ALL FIRE LANES ON THIS PLAN SHALL BE DESIGNATED IN ACCORDANCE WITH THE STRIPING PLANS, UTILIZING ONE OF THE FOLLOWING APPROVED MEANS:

- CURBS PAINT CURB TOP AND FACE RED WITH COMMERCIAL GRADE RED TRAFFIC PAINT. ON FACE OF CURB. PAINT 4" TALL WHITE LETTERING STATING "NO PARKING - FIRE LANE" AT 25' O.C. CENTERED ON FACE.
- PAVING PAINT, 6" WIDE REP STRIPE ON PAVEMENT WITH COMMERCIAL GRADE RED TRAFFIC PAINT. CENTERED IN STRIPE, PAINT 4" TALL WHITE LETTERING STATING "NO PARKING - FIRE LANE" AT 25' O.C.
- . SIGNAGE POSTING OF SIGNS COMPLIANT WITH CFC 2016, APPENDIX D103.6 EVERY 50 FEET.

#### **EXCEPTIONS:**

- STREETS 20' WIDE TO 26' WIDE SHALL BE MARKED ON BOTH SIDES AS STATED ABOVE.
- STREETS GREATER THAN 26' WIDE NEED ONLY MARKING ON ONE SIDE AS STATED ABOVE.
- EDGES OF FIRE LANES AT PARKING DO NOT REQUIRE DESIGNATION.
  - SEE STRIPING PLAN FOR ACTUAL REQUIRED STRIPING.

# KNOX NOTES

ALL GATES WHICH CROSS THE FIRE LANE AS DESIGNATED BY THIS PLAN SHALL BE OUTFITTED WITH A LOW LEVEL KNOX LOCK. ALL FIRE CONTROL ROOMS FOR THIS PROJECT SHALL BE OUTFITTED WITH A HIGH LEVEL KNOX BOX AT A LOCATION WHICH IS APPROVED BY THE SACRAMENTO METROPOLITAN FIRE DISTRICT INSPECTOR.


# PAVEMENT NOTES

FIRE ACCESS ROADWAYS SHALL BE BUILT TO BEAR A MINIMUM OF 75,000 POUNDS IN ACCORDANCE WITH CFC 2022, APPENDIX D.

> TYPICAL FIRE LANE CLEAR WIDTH 20 FEET CLEAR HEIGHT 13.5 FEET INSIDE RADIUS 35 FEET MIN. OUTSIDE RADIUS 55 FEET MIN.

> > NOTE: All new and existing fire lanes are asphalt or concrete paved unless otherwise stated.

#### m**MULTI PURPOSE EGRESS ANALYSIS** APPROXIMATE FLOOR AREA 2,351 SF LOAD FACTOR: 7 NET ASSEMBLY (CONCENTRATED): RESULTING OCCUPANT LOAD: EGRESS SIZING, LOAD $\times$ 0.2 = (IN INCH) $335 \times 0.2 = 67 \text{ INCHES}$ EGRESS WIDTH PROVIDED: (1) DOUBLE GATE (1) (E) DOOR =108 INCHES (REF CBC 1004 AND 1005)

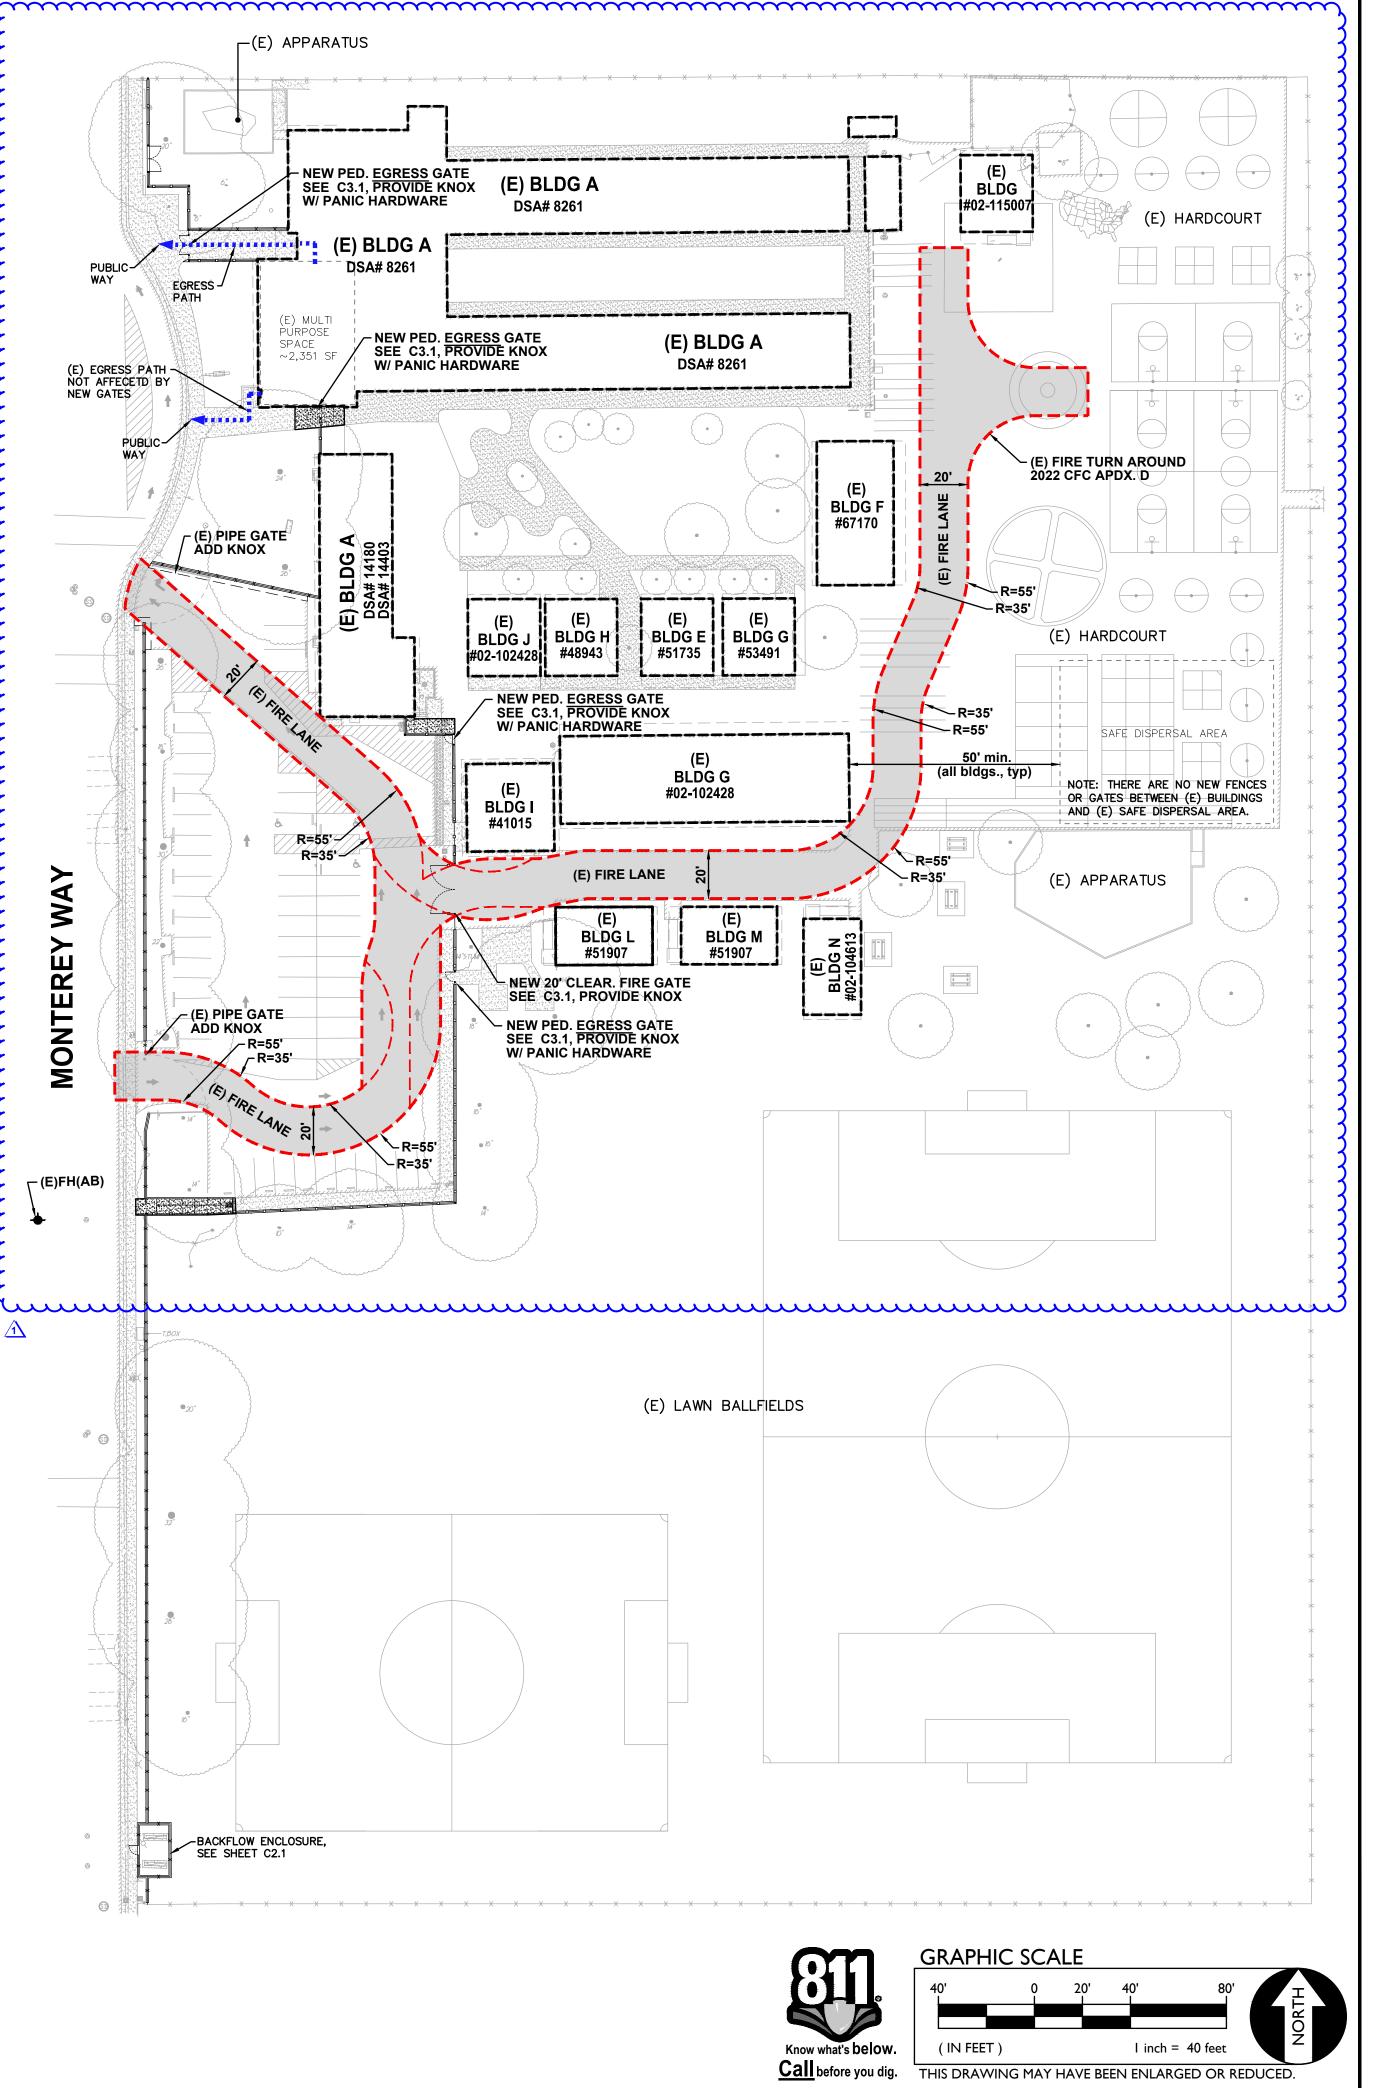

# **ADSA**

# FIRE & LIFE SAFETY SITE CONDITIONS SUBMITTAL


Division of the State Architect (DSA) documents referenced within this publication are available on the DSA Forms or DSA Publications webpages.

To facilitate the Division of the State Architect's (DSA) fire and life safety plan review of project site conditions, DSA requires the design professional to provide the following information at time of project submittal for projects consisting of construction of a new campus, construction of new building(s), additions to existing buildings, and for site alternate design means for fire department emergency vehicle access, and fire suppression water supply.

Information associated with compliance items 1 through 3 below is to be provided for all project types indicated above. Information associated with items 4 through 7 is to be completed when an alternate means is utilized. Acknowledgement by the school district and signature from the Local Fire Authority (LFA) is only required when an alternate design means is being requested.

The Project Information and Fire & Life Safety Information sections are to be completed for all projects and imaged onto the fire access site plan. When an alternate design/means is proposed, all sections on pages 1 and 2 are to be completed and imaged on the fire access site plan.

For additional information refer to the instructions at the end of this form and DSA Policy PL 09-01: Fire Flow for Buildings.

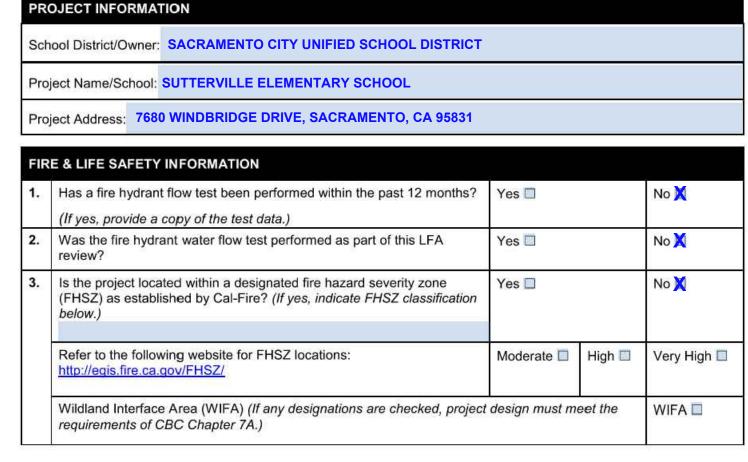

Page 1 of 4 DGS DSA 810 (revised 12/29/20) STATE OF CALIFORNIA DEPARTMENT OF GENERAL SERVICES DIVISION OF THE STATE ARCHITECT

FIRE & LIFE SAFETY SITE CONDITIONS SUBMITTAL

| CON | IDITION MEANS AND METHODS RESOLUTION   | ALTE | RNATE | ACCEPTE | ED  |
|-----|--|------|-------|---------|-----|
| 4.  | Emergency vehicle access roadways do not meet CFC requirements.  | Yes  | No    | N/A     | N/R |
| 4a. | Acceptable Alternate: Emergency vehicle and personnel access as proposed by the project architect is acceptable for providing fire suppression and protection of life and property.                          |      |       |         |     |
| 5.  | Fire Hydrants: Number and spacing does not meet CFC requirements.  |      |       | X       |     |
| 5a. | Acceptable Alternate: Number of fire hydrants and spacing as proposed by the project architect is acceptable for fire suppression and protection of life and property.                                       |      |       |         |     |
| 6.  | Fire Hydrants: Water flow and pressure are less than CFC minimum.  |      |       | X       |     |
| 6a. | Acceptable Alternate: The available flow and pressure is acceptable for providing fire suppression and protection of life and property.  |      |       |         |     |
| 7.  | Location of fire department connection(s) serving fire sprinkler systems or standpipe systems does not meet CFC requirements.  |      |       | X       |     |
| 7a. | Acceptable Alternate: The location of fire department connection serving the fire sprinkler system and/or standpipe system is acceptable for providing fire suppression and protection of life and property. |      |       |         |     |

# School District Acceptance of Acceptable Design Alternates

LFA Reviewer's Signature:

By signing this form, the school district acknowledges and accepts the proposed design as an alternative to California Building Code (CBC) and California Fire Code (CFC) minimum requirements, as indicated by one or more of the conditions indicated at items 4a, 5a, 6a or 7a, for providing fire and life safety protection of life and property.

I/A - NO VARIANCE PROPOSED

| OCAL FIRE AUTHORITY (LFA) INFORMATION                |  |  |  |  |  |  |
|--|--|--|--|--|--|--|
| LFA Agency Name:                                     | ame: City of Sacramento Fire Department      |  |  |  |  |  |
| LFA Review Official:                                 | FA Review Official: King Tunson              |  |  |  |  |  |
| Title: Program Specialist Work Phone: (916) 808-1358 |  |  |  |  |  |  |
| Work Email: <b>ktur</b>                              | Vork Email: ktunson@sfd.cityofsacramento.org |  |  |  |  |  |
|  |  |  |  |  |  |  |

DGS DSA 810 (revised 12/29/20) STATE OF CALIFORNIA DIVISION OF THE STATE ARCHITECT DEPARTMENT OF GENERAL SERVICES

1117 WINDFIELD WAY, SUITE 110 EL DORADO HILLS, CA 95762 | (916) 985-1870

Sacramento **City Unified School District** 

Sacramento City **Unified School District** 5735 47th Avenue Sacramento, CA 95824-4528

ONSULTANT:

ANTHONY J. TASSANO

Sutterville Elementary 2023 Fencing

4967 Monterey Way Sacramento, CA 95822

**REVISIONS** DESCRIPTION ADDENDUM NO.1

DRAWN: SCALE: AS NOTE CHECKED: PROJECT NO. 23-056 DESIGNED: SMN/AT 4/24/2023 ISSUANCE:

SHEET TITLE:

FIRE ACCESS **PLAN** 


SHEET NO.

Page 2 of 4

C1.0.2

FIRE ACCESS PLAN

SCALE 1" = 40'-0

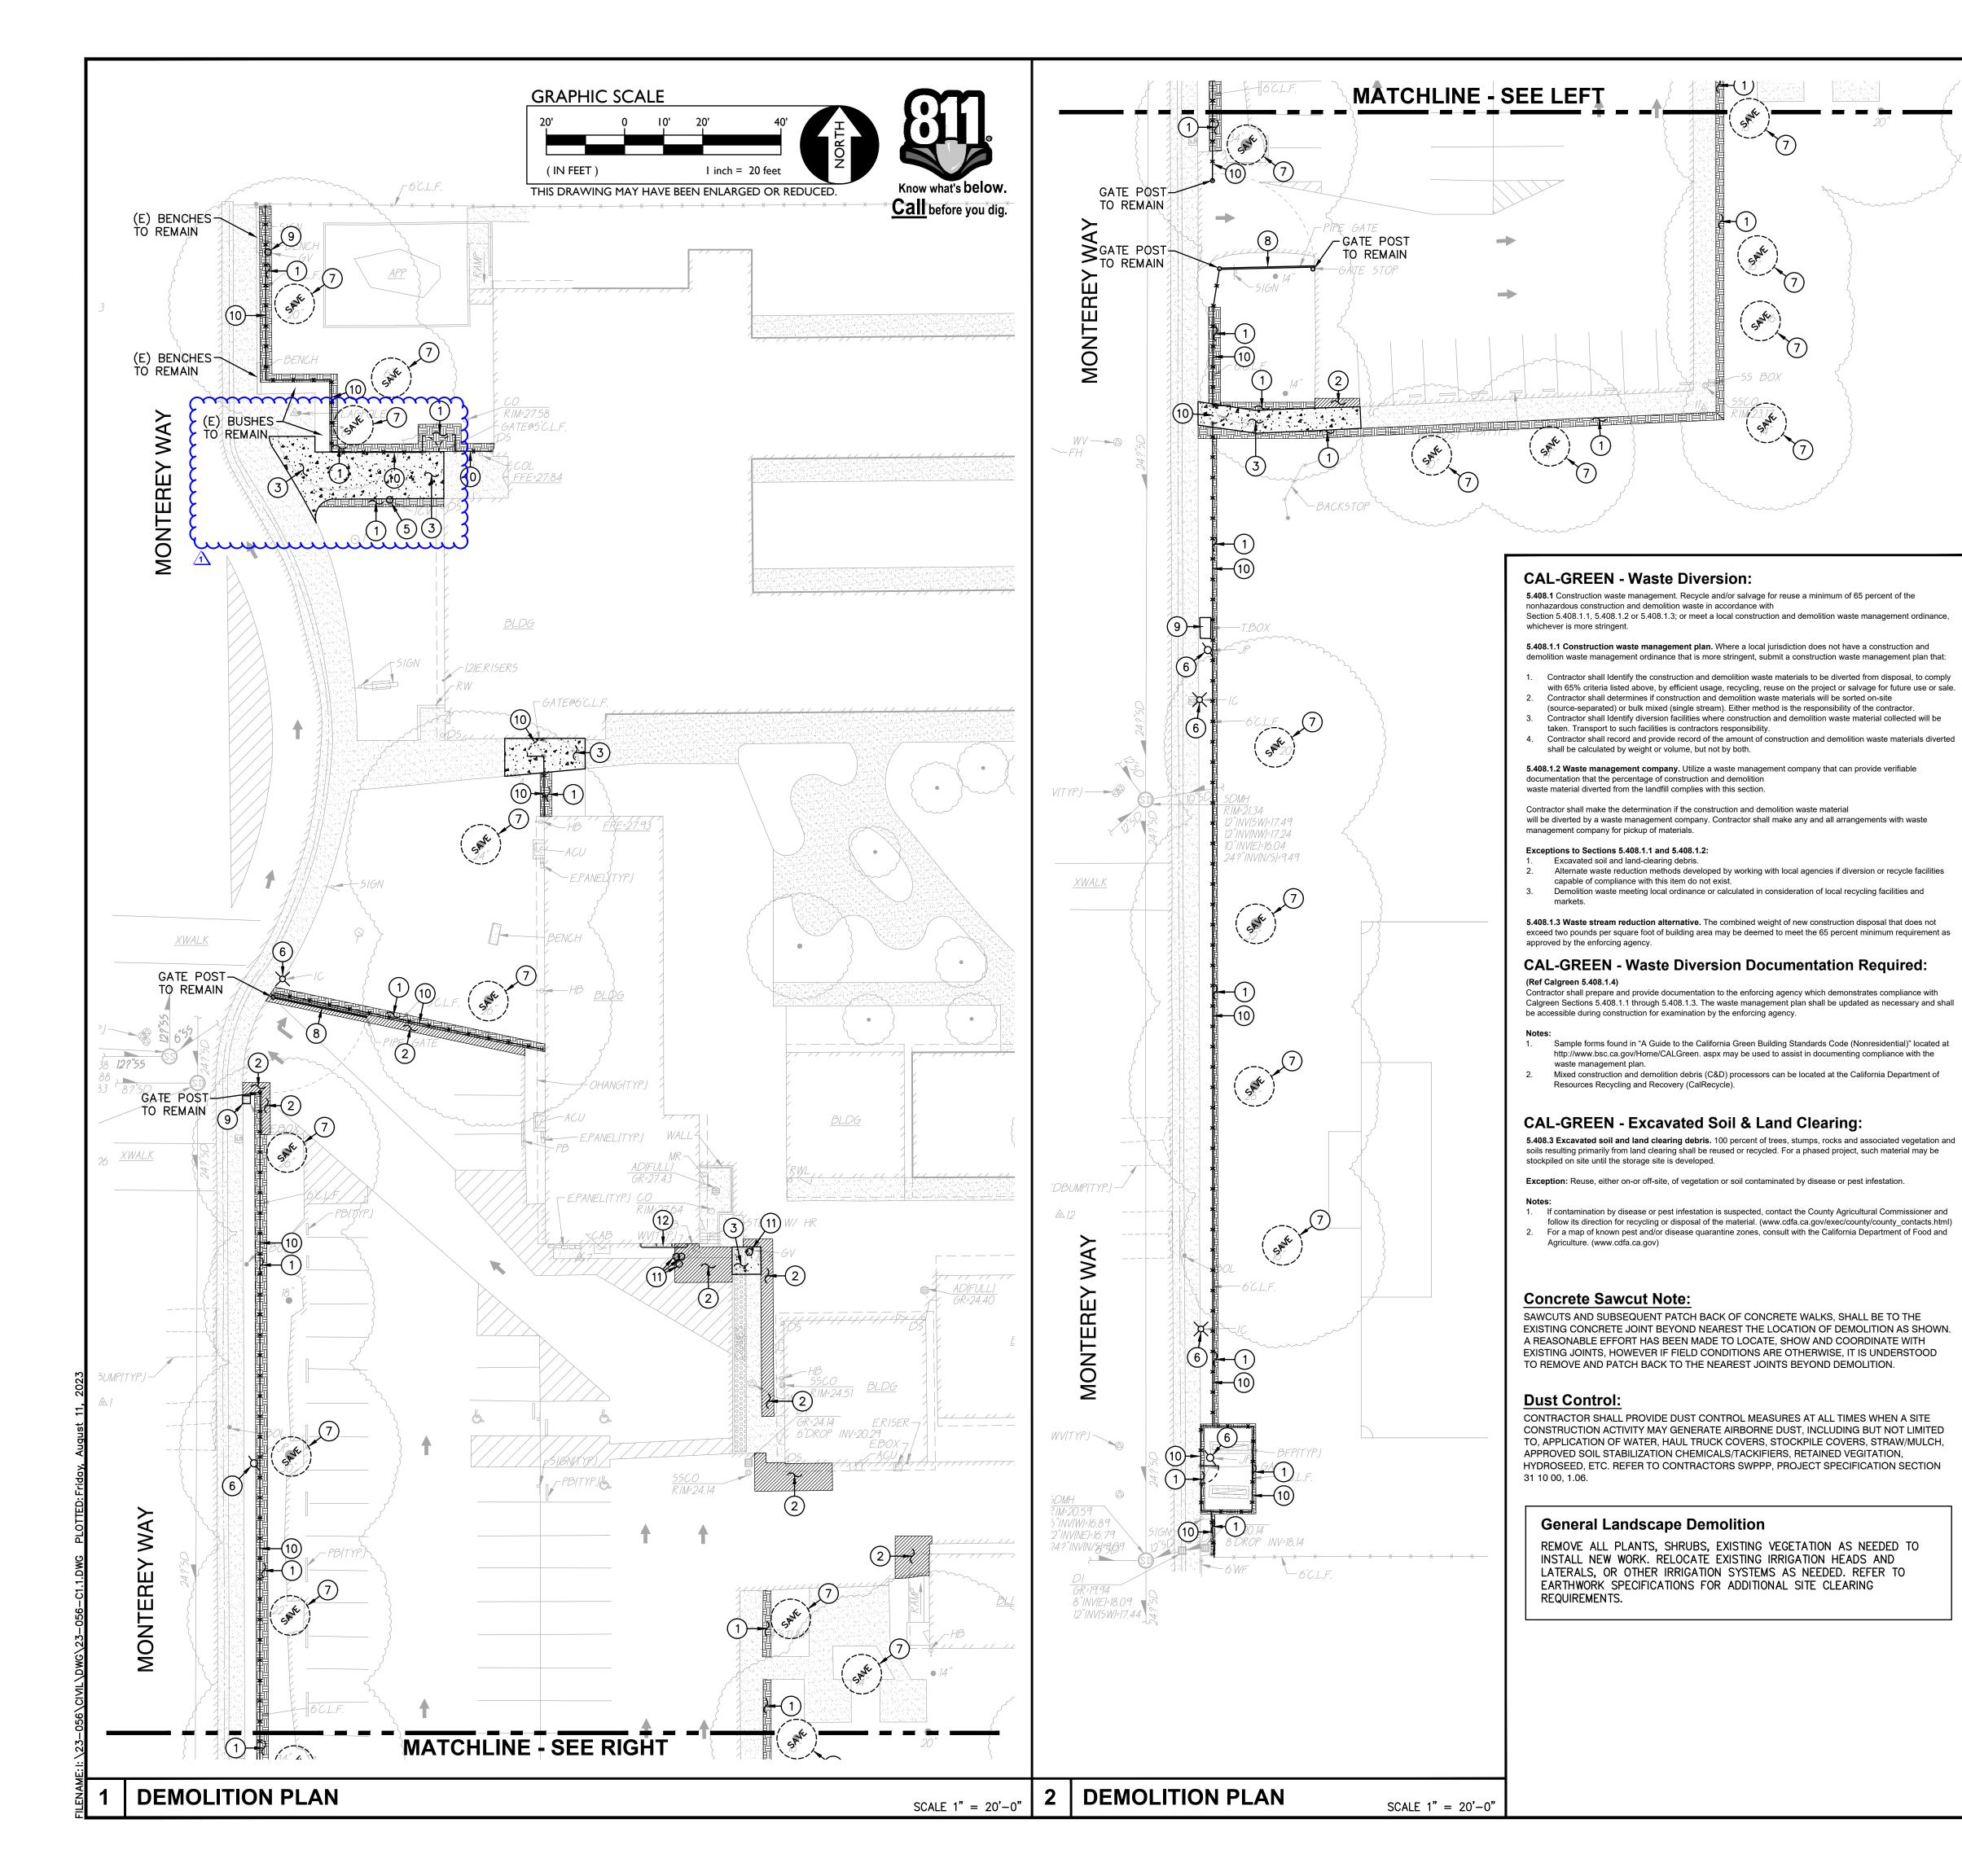

#### **DEMOLITION GENERAL NOTES**

- IN THE EVENT THAT ANY UNUSUAL CONDITIONS NOT COVERED BY THE GEOTECHNICAL INVESTIGATION REPORT OR ARE ENCOUNTERED DURING GRADING OPERATIONS THE GEOTECHNICAL ENGINEER AND THE ENGINEER SHALL BE IMMEDIATELY NOTIFIED FOR
- DIRECTIONS.
  2. NO BURNING OR BLASTING SHALL BE PERMITTED.
- ADDITIONAL DEMOLITION INFORMATION MAY BE SHOWN ON THE GRADING, DRAINAGE, AND UTILITY PLANS, AND THOSE PLANS PREPARED BY OTHER DISCIPLINES FOR THIS PROJECT.
- H. ALL DEMOLISHED ITEMS SHALL BE DISPOSED OF OFFSITE AT A SUITABLE, LEGAL, DUMP SITE OR OTHER FACILITY.
- 5. ALL DISPOSED OF MATERIALS SHALL BE RECYCLED IF POSSIBLE.
- 6. THE TYPES, LOCATIONS, SIZES AND/OR DEPTHS OF EXISTING UNDERGROUND UTILITIES AS SHOWN IN THESE PLANS WERE OBTAINED FROM SOURCES OF VARYING RELIABILITY. THE CONTRACTOR IS CAUTIONED THAT ONLY ACTUAL EXCAVATION WILL REVEAL THE TYPES, EXTENT, SIZES, LOCATIONS, AND DEPTHS OF SUCH UNDERGROUND UTILITIES. A REASONABLE EFFORT HAS BEEN MADE TO LOCATE AND DELINEATE ALL KNOWN UNDERGROUND UTILITIES. HOWEVER, WARREN CONSULTING ENGINEERS CAN ASSUME NO RESPONSIBILITY FOR THE COMPLETENESS OR ACCURACY OF ITS DELINEATION OF SUCH UNDERGROUND UTILITIES, NOR FOR THE EXISTENCE OF OTHER BURIED OBJECTS OR UTILITIES WHICH MAY BE ENCOUNTERED BUT WHICH ARE NOT SHOWN ON THESE DRAWINGS. THE CONTRACTOR OR ANY SUBCONTRACTOR FOR THIS CONTRACT SHALL NOTIFY THE DISTRICT TWO (2) WORKING DAYS IN ADVANCE OF PERFORMING ANY EXCAVATION WORK IN ORDER TO VERIFY TO THE GREATEST EXTENT POSSIBLE THE EXISTING UTILITY LINES, CONFLICTS AND PROPOSED UTILITY CONNECTION POINTS.
- THE SCHOOL DISTRICT SHALL HAVE SALVAGE RIGHTS TO ANY DEMOLISHED ITEMS SHOWN HEREON. THE CONTRACTOR SHALL GIVE THE DISTRICT NOTICE 7 DAYS PRIOR TO THE START OF DEMOLITION. THE DISTRICT SHALL MOVE ANY RETAINED ITEMS OUT OF THE CONTRACTORS WORK AREA, UNLESS ANOTHER ARRANGEMENT IS MADE WITH THE CONTRACTOR. ANY REMAINING ITEMS BECOME THE PROPERTY OF THE CONTRACTOR AND SHALL BE REMOVED FROM THE SITE. ANY ITEMS NOT SHOWN FOR REMOVAL SHALL REMAIN AND SHALL BE PROTECTED FROM DAMAGE DURING CONSTRUCTION TO A REASONABLE EXTEND.
- EXISTING UTILITY STRUCTURES IN AREAS OF NEW PAVING SHALL BE REMOVED AND REINSTALLED AT NEW GRADE UNLESS SPECIFICALLY NOTED OTHERWISE.
- 9. ITEMS OUTSIDE THE LIMITS OF DEMOLITION SHALL REMAIN AND BE PROTECTED FROM DAMAGE DURING CONSTRUCTION..
- 10. CONTRACTOR SHALL COMPLY WITH CHAPTER 33 OF THE 2019 CFC, "FIRE SAFETY DURING CONSTRUCTION AND DEMOLITION" AT ALL TIMES DURING CONSTRUCTION.
- CONTRACTOR SHALL HIRE A UTILITY LOCATING COMPANY AND SHALL SCAN THE ENTIRE AREA WITHIN THE LIMITS OF NEW WORK. ALL UTILITIES LOCATED SHALL BE MARKED AND PROTECTED DURING THE LIMING OPERATIONS AS WELL AS ANY EXCAVATING TASKS. ANY LOCATED UTILITY DAMAGED WITHIN THE LIMITS OF WORK WILL BE THE RESPONSIBILITY OF THE CONTRACTOR TO REPAIR.
- 12. ALL DEMOLITION SHALL BE APPROPRIATELY SUPPORTED AND REINFORCED DURING REMOVAL TO PREVENT INJURY FROM FALLING, PROJECTILE, OR OTHERWISE MOVING DEBRIS OR OTHER DELETERIOUS MATERIAL. ONSITE SAFETY WITHIN THE LIMITS OF WORK IS THE CONTRACTORS SOLE RESPONSIBILITY.

#### **DEMOLITION NOTES**

NOTE: NOT ALL NOTES MAY BE USED ON THIS SHEET LEGEND (#) DEMOLITION NOTES



REMOVE ALL PLANTS, SHRUBS, EXISTING VEGETATION AS NEEDED TO COMPLETE NEW WORK. SEE GENERAL LANDSCAPE DEMOLITION NOTE, THIS



USED AS FILL, REFER TO EARTHWORK SPECIFICATIONS. 3. REMOVE EXISTING CONCRETE PAVING AND BASE ROCK, WHERE SAWCUTS ARE NECESSARY, THEY SHALL BE A NEAT STRAIGHT LINE. CUT SHALL BE

REMOVE EXISTING ASPHALT PAVING AND BASE TO ALLOW FOR NEW WORK.

AC MAY BE GRINDED AND BLENDED WITH EXISTING BASE, EXCAVATED AND

4. REMOVE EXISTING CONCRETE CURB, MOWBAND, APRON OR GUTTER AS

MADE AT NEAREST EXISTING JOINT TO LOCATION SHOWN.

- - 5. REMOVE AND RELOCATE IRRIGATION VALVE. SEE CONSTRUCTION PLAN. 6. EXISTING POWER/LIGHT POLE TO REMAIN. PROTECT FROM DAMAGE.
- EXISTING TREE TO REMAIN AND BE PROTECTED FROM DAMAGE. PROVIDE PROTECTIVE FENCING IF NEEDED. TREES WITHIN 20 FEET OF EQUIPMENT TRAFFIC SHALL BE PROVIDED WITH TEMPORARY 2x4'S STRAPPED VERTICALLY ON TRUNK OF TREE FOR VEHICULAR IMPACT PROTECTION. 2x4'S SHALL BE SPACED WITH NO GREATER THAN A 6" GAP BUT ONLY NEED BE PLACED ON THE HALF CIRCUMFERENCE FACING EQUIPMENT
- 8. EXISTING PIPE GATE TO REMAIN. CLEAN AND PREP FOR PAINT. SEE CONSTRUCTION PLAN.
- 9. EXISTING UTILITY BOX/VAULT TO REMAIN. PROTECT FROM DAMAGE.
- SHOWN. REMOVE POST TO INCLUDE CONCRETE FOOTINGS.
  - 11. REMOVE EXISTING UTILITY BOX. PROTECT UTILITIES. PROVIDE NEW TRAFFIC RATED UTILITY BOX OF SAME SIZE AND APPROPRIATE FOR UTILITY, REFER TO SPECIFICATIONS. SET FLUSH WITH PROPOSED FINISHED GRADE.
  - 12. REMOVE EXISTING PROTECTION BAR AND SHIFT DOWN 1 MOUNTING POSITION AND RE-INSTALL. DRILL HOLES AND PROVIDE NEW HARDWARE AS NEEDED.

1117 WINDFIELD WAY, SUITE 110

EL DORADO HILLS, CA 95762 | (916) 985-1870



Sacramento City **Unified School District** 5735 47th Avenue Sacramento, CA 95824-4528



Sutterville Elementary 2023 Fencing

4967 Monterey Way Sacramento, CA 95822

**REVISIONS** DESCRIPTION ADDENDUM NO.1

DRAWN: SCALE: AS NOTE CHECKED: PROJECT NO. 23-056 DESIGNED: DATE: SMN/AT 4/24/2023


SHEET TITLE:

ISSUANCE:

**DEMOLITION PLAN** 

SHEET NO.

C1.1

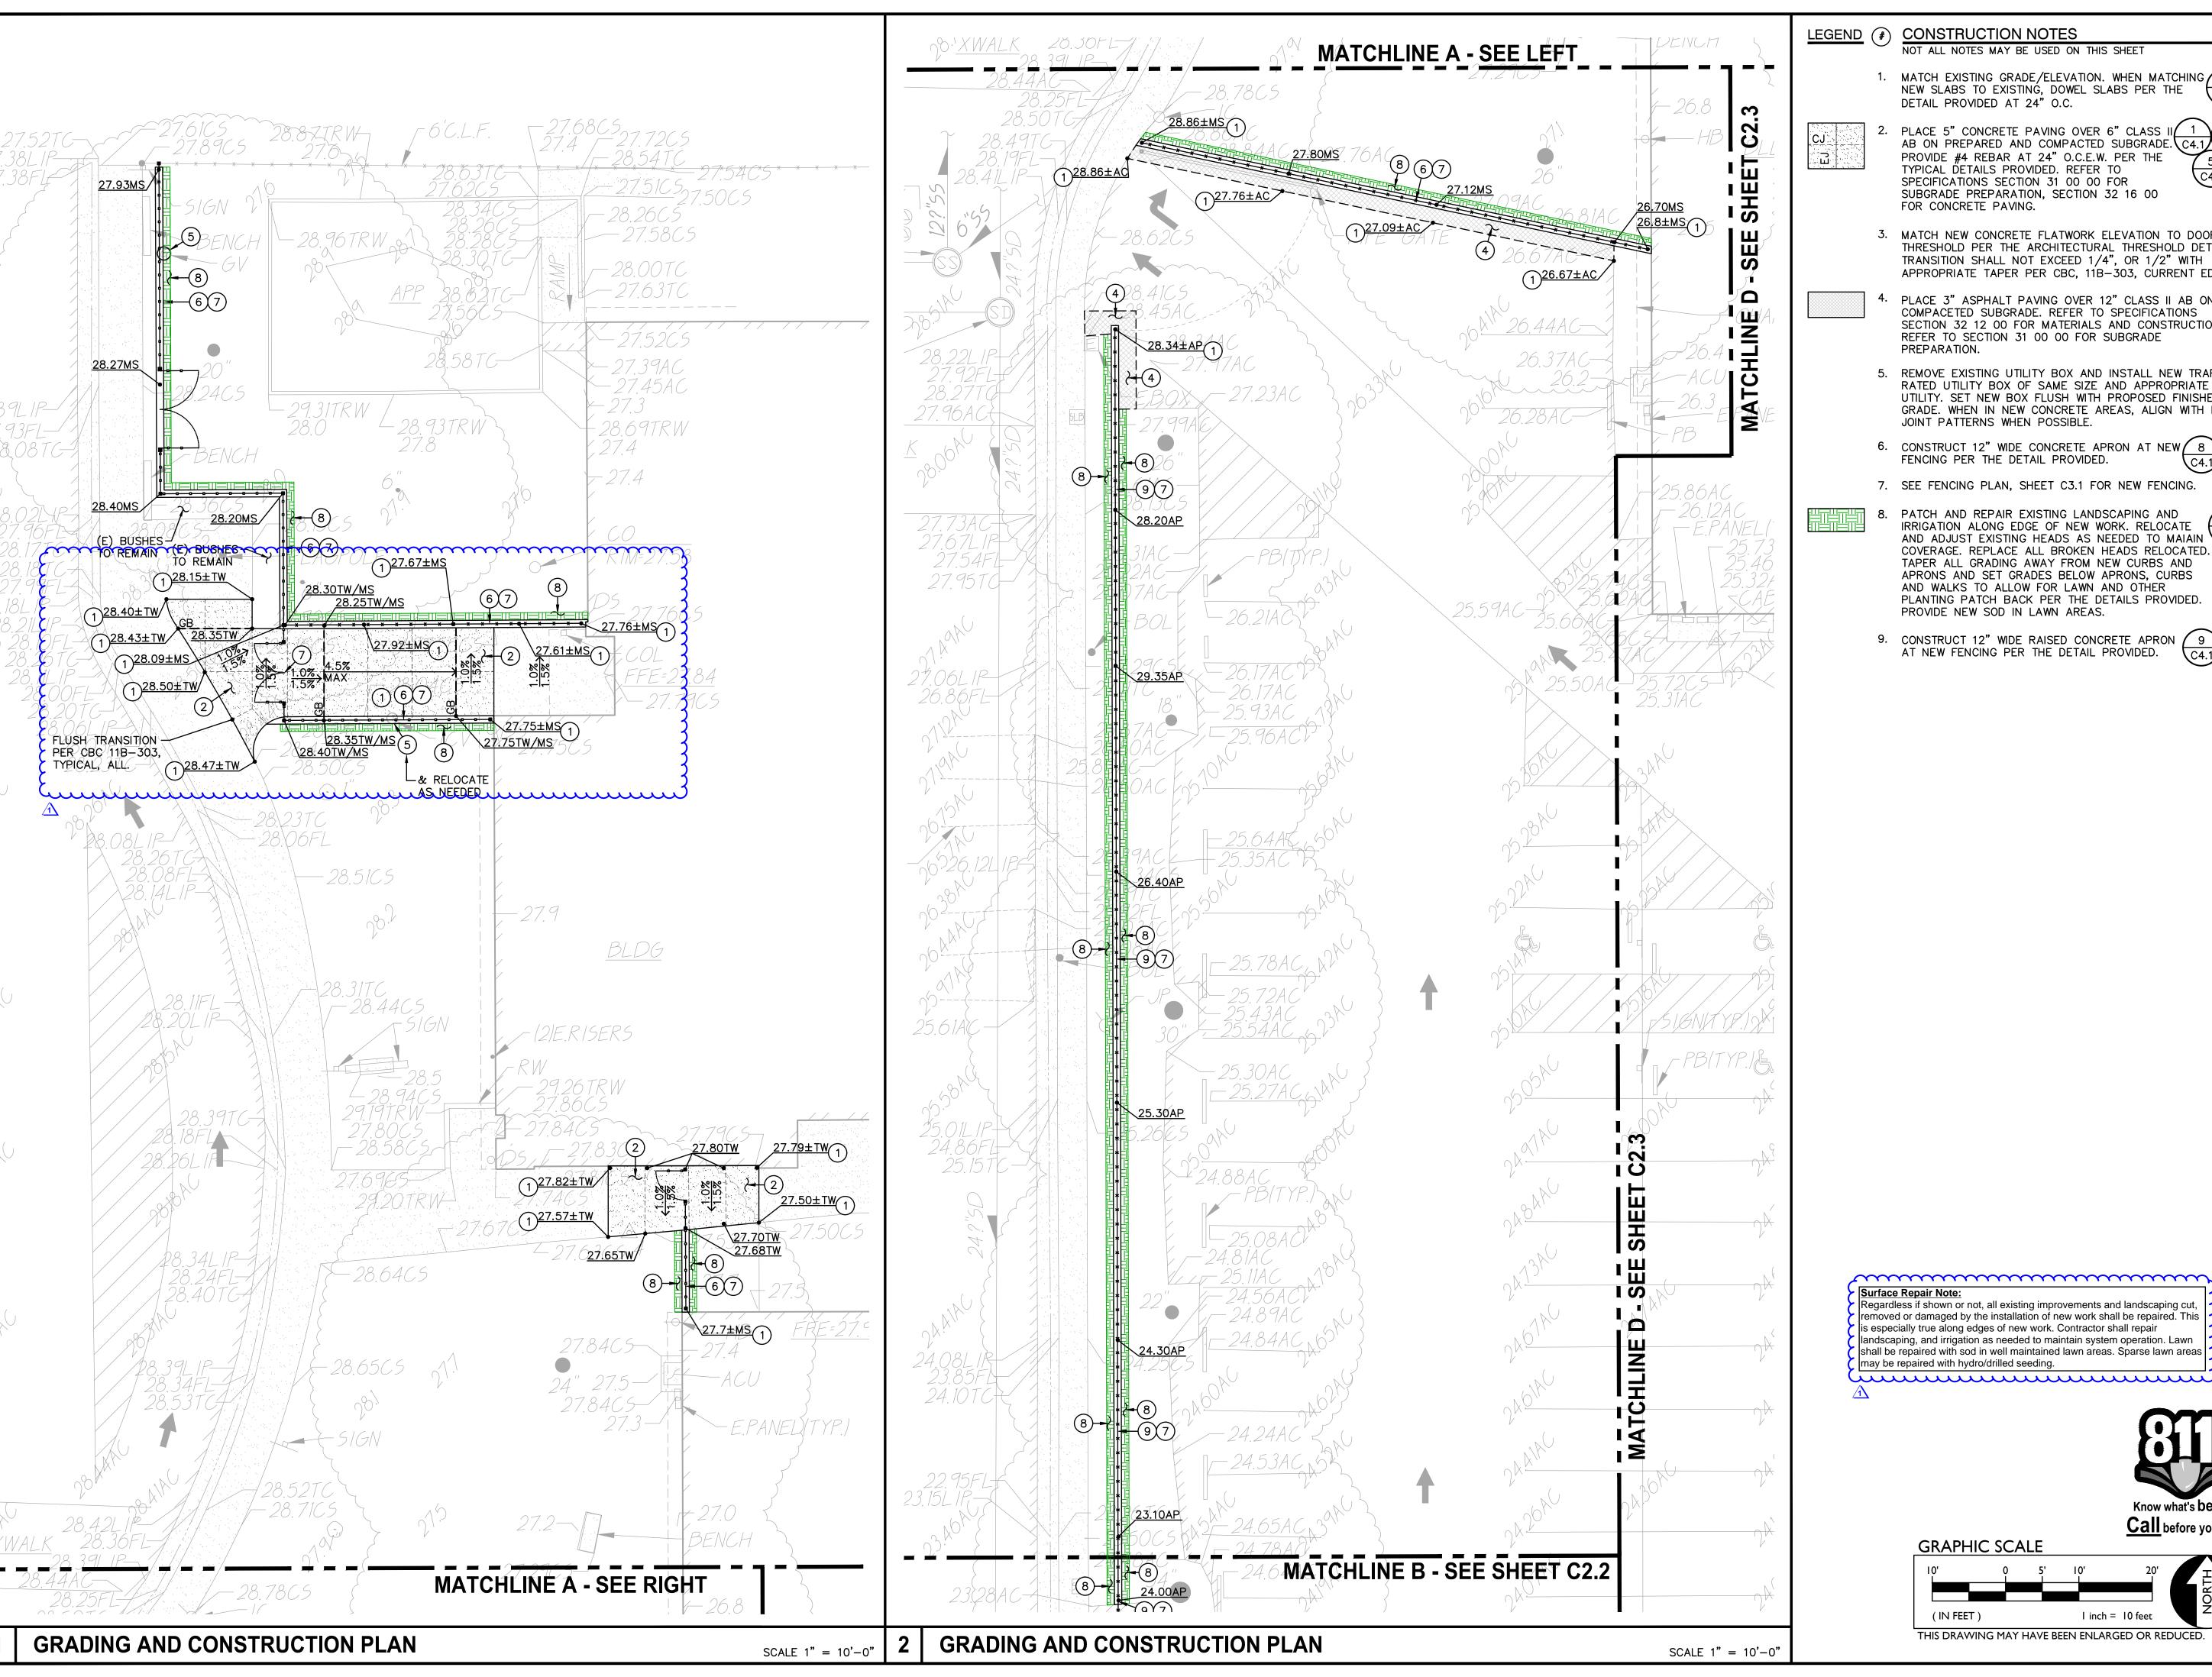



LEGEND (#) CONSTRUCTION NOTES

NOT ALL NOTES MAY BE USED ON THIS SHEET

1. MATCH EXISTING GRADE/ELEVATION. WHEN MATCHING 1 NEW SLABS TO EXISTING, DOWEL SLABS PER THE DETAIL PROVIDED AT 24" O.C.

PLACE 5" CONCRETE PAVING OVER 6" CLASS II AB ON PREPARED AND COMPACTED SUBGRADE. C4.1 C4.1 PROVIDE #4 REBAR AT 24" O.C.E.W. PER THE TYPICAL DETAILS PROVIDED. REFER TO SPECIFICATIONS SECTION 31 00 00 FOR SUBGRADE PREPARATION, SECTION 32 16 00 C4.1 FOR CONCRETE PAVING.

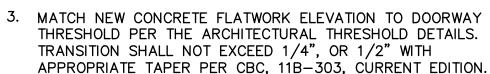

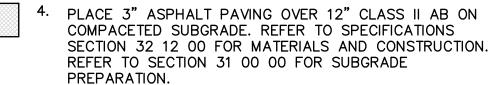

- 5. REMOVE EXISTING UTILITY BOX AND INSTALL NEW TRAFFIC RATED UTILITY BOX OF SAME SIZE AND APPROPRIATE FOR UTILITY. SET NEW BOX FLUSH WITH PROPOSED FINISHED GRADE. WHEN IN NEW CONCRETE AREAS, ALIGN WITH NEW JOINT PATTERNS WHEN POSSIBLE.
- 6. CONSTRUCT 12" WIDE CONCRETE APRON AT NEW 8 FENCING PER THE DETAIL PROVIDED.
- 7. SEE FENCING PLAN, SHEET C3.1 FOR NEW FENCING.



PATCH AND REPAIR EXISTING LANDSCAPING AND IRRIGATION ALONG EDGE OF NEW WORK. RELOCATE AND ADJUST EXISTING HEADS AS NEEDED TO MAIAIN C4.1 COVERAGE. REPLACE ALL BROKEN HEADS RELOCATED. TAPER ALL GRADING AWAY FROM NEW CURBS AND APRONS AND SET GRADES BELOW APRONS, CURBS AND WALKS TO ALLOW FOR LAWN AND OTHER PLANTING PATCH BACK PER THE DETAILS PROVIDED. PROVIDE NEW SOD IN LAWN AREAS.

9. CONSTRUCT 12" WIDE RAISED CONCRETE APRON 9
AT NEW FENCING PER THE DETAIL PROVIDED. (24.1) C4.1/






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Sacramento City **Unified School District** 5735 47th Avenue Sacramento, CA 95824-4528

ONSULTANT:

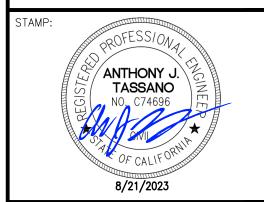

Sutterville Elementary 2023 Fencing

4967 Monterey Way Sacramento, CA 95822

|     | REVISIONS     |  |  |
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| NO. | DESCRIPTION   |  |  |
| 1   | ADDENDUM NO.1 |  |  |
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| CHECKED:  | PROJECT NO. |
| AT        | 23-056      |
| DESIGNED: | DATE:       |
| SMN/AT    | 4/24/2023   |
| SSUANCE:  |             |

GRADING AND

CONSTRUCTION

Know what's below.


**GRAPHIC SCALE** 

THIS DRAWING MAY HAVE BEEN ENLARGED OR REDUCED.

<u>Call</u> before you dig.

**C2.1** 

**PLAN** 

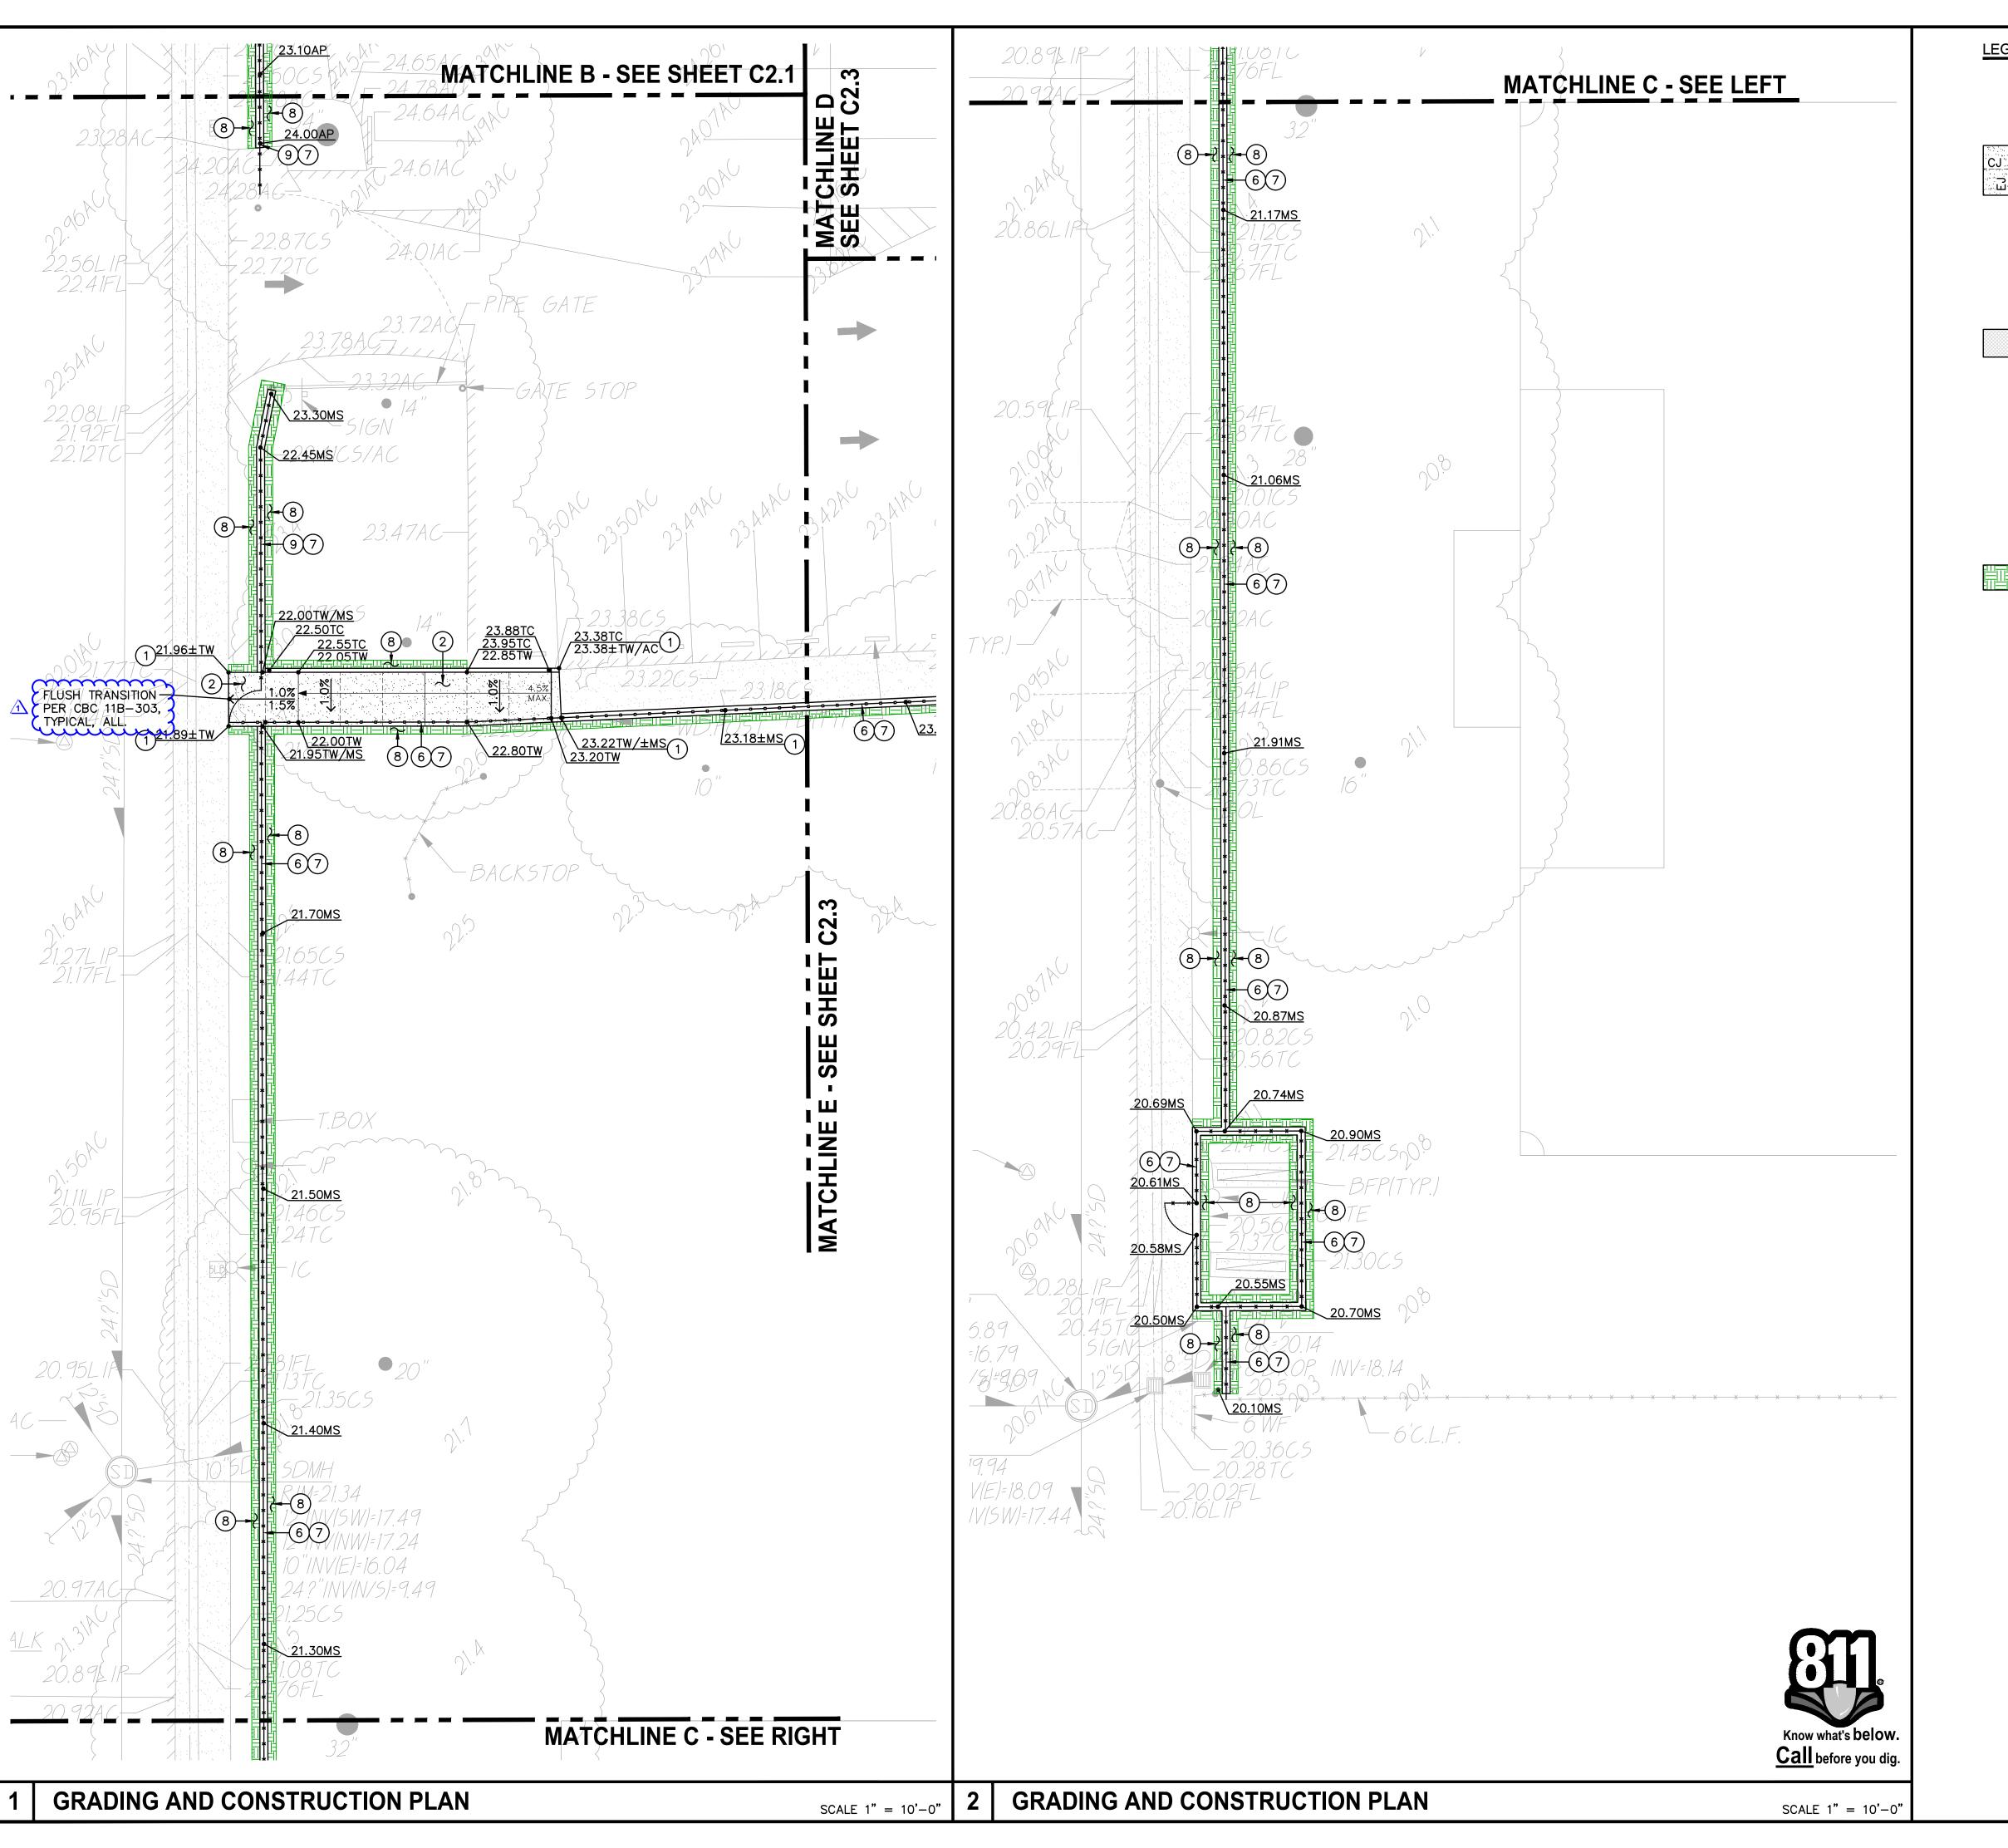

LEGEND # CONSTRUCTION NOTES

NOT ALL NOTES MAY BE USED ON THIS SHEET


1. MATCH EXISTING GRADE/ELEVATION. WHEN MATCHING 1 NEW SLABS TO EXISTING, DOWEL SLABS PER THE DETAIL PROVIDED AT 24" O.C.




2. PLACE 5" CONCRETE PAVING OVER 6" CLASS II 2
AB ON PREPARED AND COMPACTED SUBGRADE.

"4 PERAR AT 24" O.C.E.W. PER THE

5 PROVIDE #4 REBAR AT 24" O.C.E.W. PER THE TYPICAL DETAILS PROVIDED. REFER TO SPECIFICATIONS SECTION 31 00 00 FOR SUBGRADE PREPARATION, SECTION 32 16 00 C4.1 FOR CONCRETE PAVING.

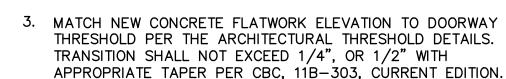

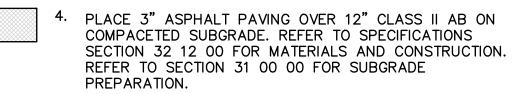

- 5. REMOVE EXISTING UTILITY BOX AND INSTALL NEW TRAFFIC RATED UTILITY BOX OF SAME SIZE AND APPROPRIATE FOR UTILITY. SET NEW BOX FLUSH WITH PROPOSED FINISHED GRADE. WHEN IN NEW CONCRETE AREAS, ALIGN WITH NEW JOINT PATTERNS WHEN POSSIBLE.
- 6. CONSTRUCT 12" WIDE CONCRETE APRON AT NEW 8 FENCING PER THE DETAIL PROVIDED.
- 7. SEE FENCING PLAN, SHEET C3.1 FOR NEW FENCING.




8. PATCH AND REPAIR EXISTING LANDSCAPING AND IRRIGATION ALONG EDGE OF NEW WORK. RELOCATE AND ADJUST EXISTING HEADS AS NEEDED TO MAIAIN C4.1 COVERAGE. REPLACE ALL BROKEN HEADS RELOCATED. TAPER ALL GRADING AWAY FROM NEW CURBS AND APRONS AND SET GRADES BELOW APRONS, CURBS AND WALKS TO ALLOW FOR LAWN AND OTHER PLANTING PATCH BACK PER THE DETAILS PROVIDED. PROVIDE NEW SOD IN LAWN AREAS.





Sacramento City **Unified School District** 5735 47th Avenue Sacramento, CA 95824-4528

CONSULTANT:

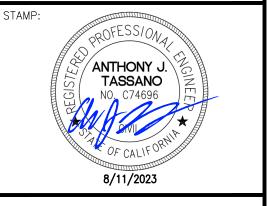

# Sutterville Elementary 2023 Fencing

4967 Monterey Way Sacramento, CA 95822


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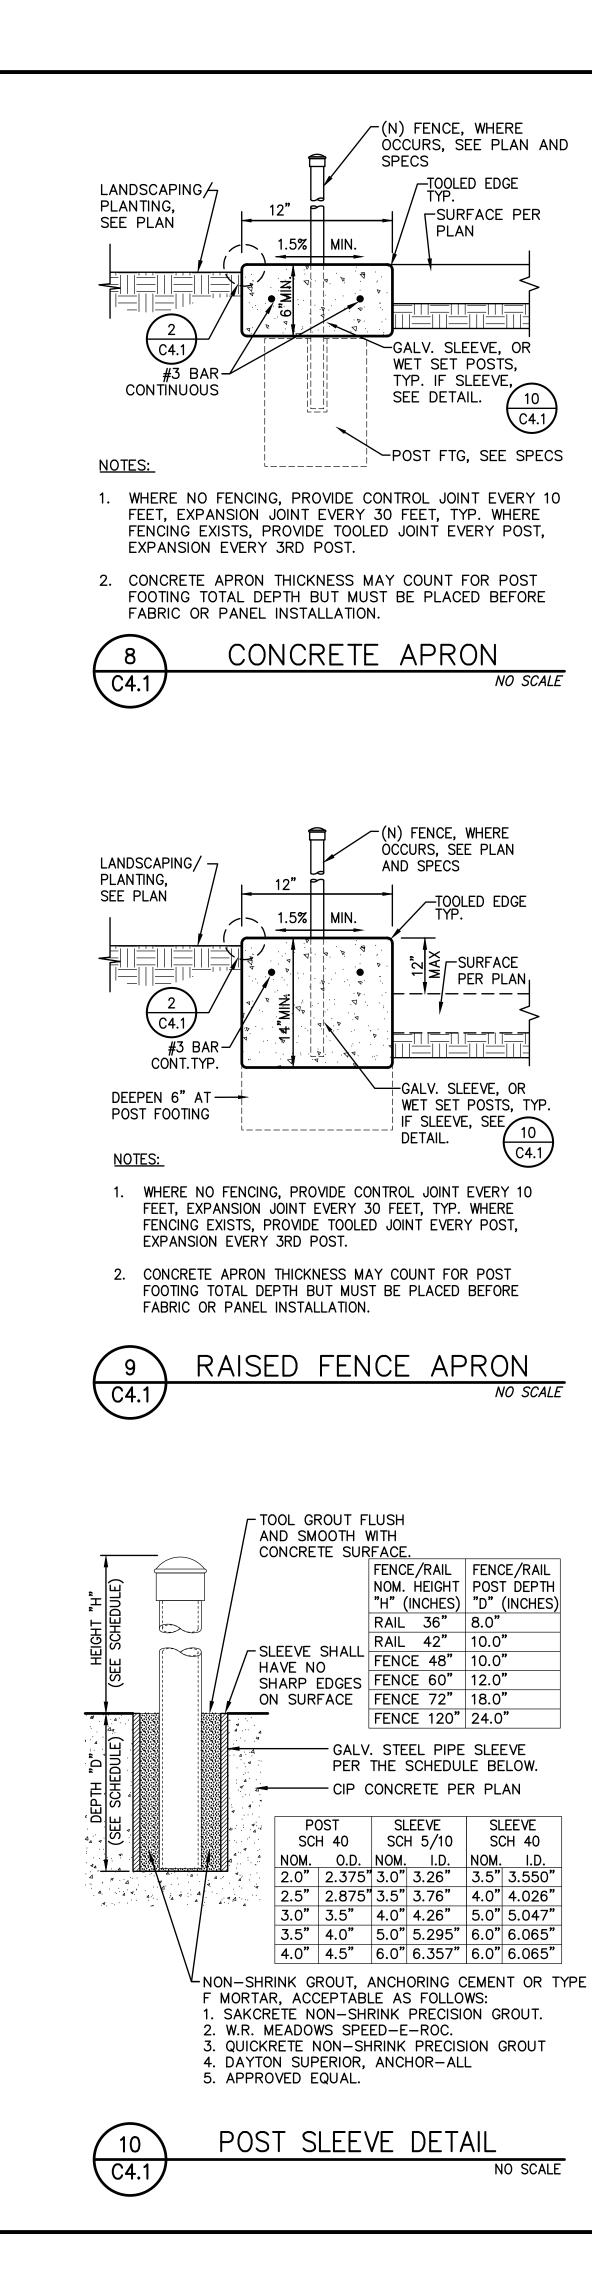
GRADING AND CONSTRUCTION **PLAN** 

**GRAPHIC SCALE** 



THIS DRAWING MAY HAVE BEEN ENLARGED OR REDUCED.

**C2.2** 

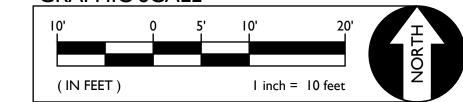

-(N) FENCE, WHERE

OCCURS, SEE PLAN AND

TOOLED EDGE

PLAN

-GALV. SLEEVE, OR

WET SET POSTS,

TYP. IF SLEEVE,

←POST FTG, SEE SPECS

NO SCALE

SEE DETAIL. /

(N) FENCE, WHERE

AND SPECS

OCCURS, SEE PLAN

-TOOLED EDGE

SURFACE
PER PLAN

+GALV. SLEEVE, OR

FENCE/RAIL FENCE/RAIL

NOM. HEIGHT POST DEPTH

"H" (INCHES) | "D" (INCHES)

SLEEVE SLEEVE

NO SCALE

RAIL 36" 8.0"

RAIL 42" 10.0"

FENCE 120" 24.0"

GALV. STEEL PIPE SLEEVE

DETAIL.

WET SET POSTS, TYP. IF SLEEVE, SEE 10

-SURFACE PER

AC PAVING

THE CONCRETE WALKS.

NOTES:

VARIES


PROVIDE FELT EXPANSION JOINTS (E.J.) AT 60 FEET O.C.


PROVIDE CONTROL JOINTS AT 10 FEET O.C., EXCEPT WHEN

PLACING ADJACENT TO CONCRETE WALKS THE EXPANSION

JOINTS SHALL ALIGN WITH THE EXPANSION JOINTS SHOWN FOR

#4 CONT. (2 TOTAL)

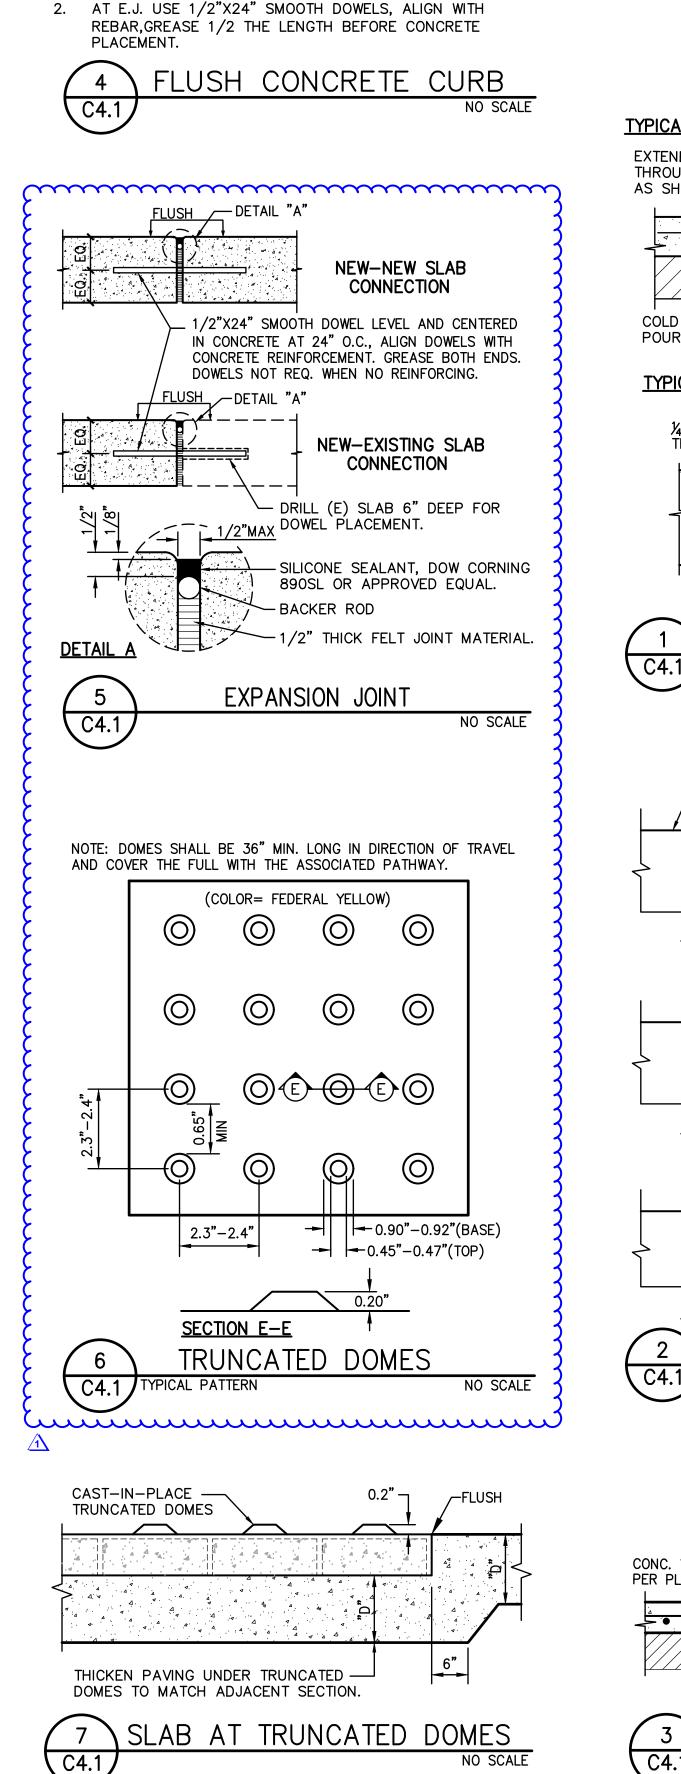


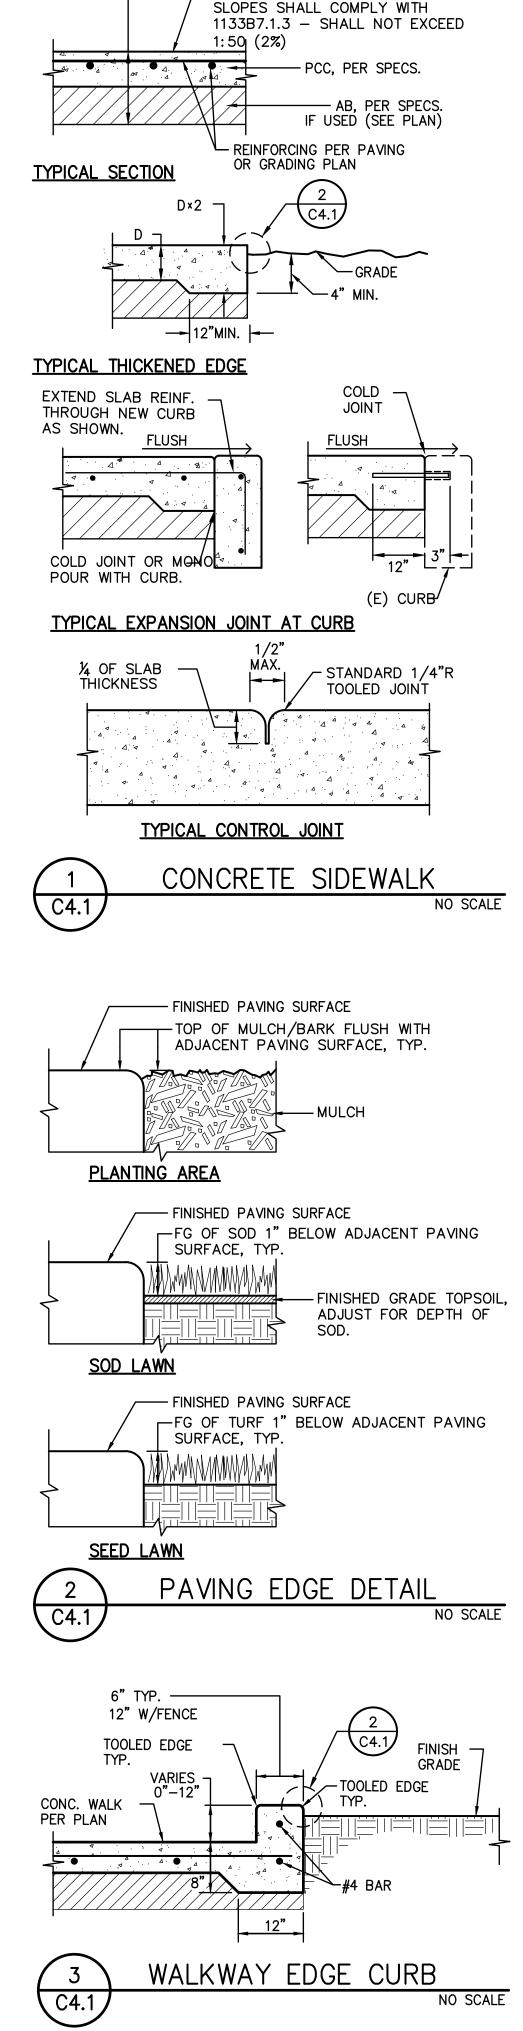

PAVING SECTIONS PER

PAVING/GRADING PLAN

- SURFACE PER SPECS. CROSS

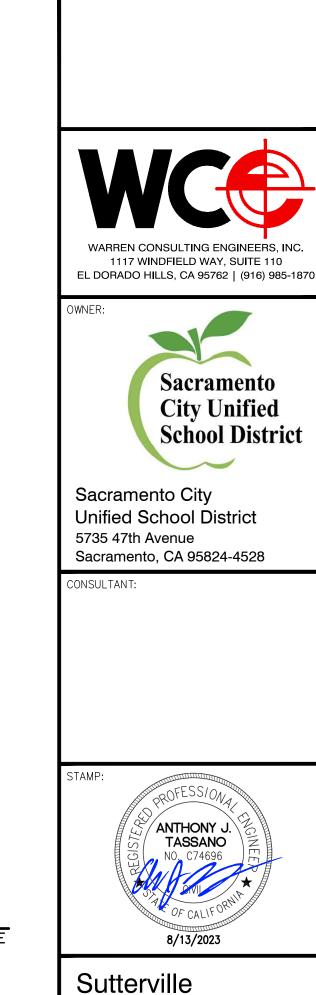

4967 Monterey Way Sacramento, CA 95822

2023 Fencing

Elementary

**REVISIONS** DESCRIPTION ADDENDUM NO.1

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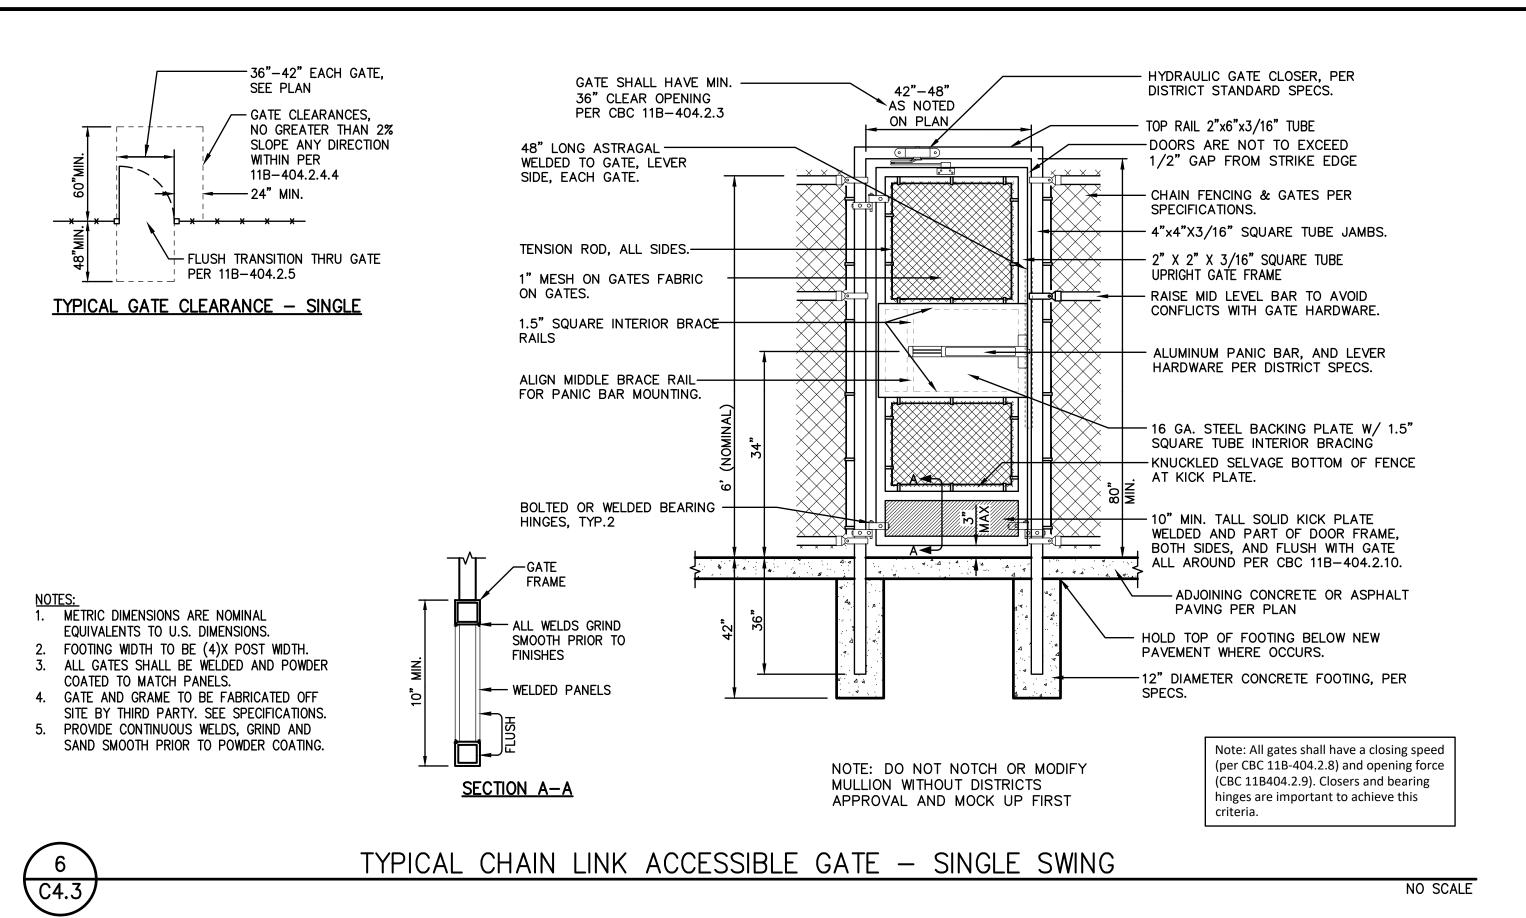
SMN/AT


SHEET TITLE:

**DETAILS AND SECTIONS** 

SHEET NO.

C4.1




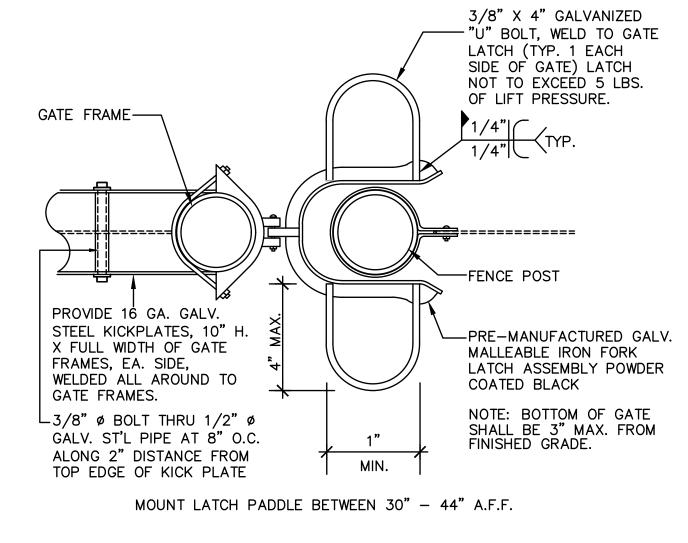

GATE LATCH

NO SCALE

C4.3

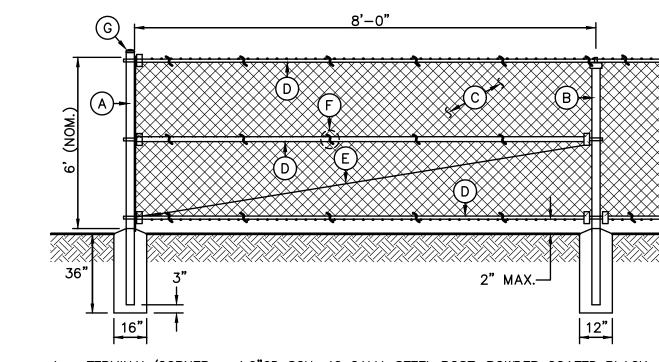

A - TERMINAL/CORNER - 4.0"OD SCH. 40 GALV. STEEL POST, POWDER COATED BLACK.
B - LINE POST - 2.875"OD SCH. 40 GALV. STEEL POST, POWDER COATED BLACK.

C - 9 GA. CHAIN LINK FENCE. BLACK VINYL. MESH PER PLAN.

TYPE A - 1.75" MESH - GALV. FINISH.

TYPE B - 1.0" MESH - BLACK VINYL COATING

TYPE C - 2.0" MESH - BLACK VINTL COATING

TYPE D - 3.5"x5" DIAMOND MESH WITH PRIVACY SLATS

D - 1.66" OD SCH. 40 GALV. STEEL RAILS, POWDER COATED BLACK. TOP AND BOTTOM ALL SECTIONS, MID AT ALL CORNER AND TERMINAL POSTS.

E — 3/8" OD ADJUSTABLE INDUSTRIAL TRUSS ROD, POWDER COATED BLACK. F — 9 GA. GALVANIZED STEEL TIES AT 12" OC HORIZ. AND VERT.

G - ALL CAPS AND FITTINGS HEAVY INDUSTRIAL GALV. GRADE, POWDER COATED BLACK.

6' TALL CHAIN LINK FENCING

BLACK VINYL COATED NO SCA

NO SCALE

- GATE FRAME WITH MITERED CORNERS AND COPED INTERSECTIONS, WELDED ALL AROUND, GRIND SMOOTH. - PROVIDE INTERMEDIATE FRAME AT TOP OF KICK PLATE, SAME DIA. AS GATE FRAME — PROVIDE 16 GA. GALV. STEEL KICKPLATES, 10" HIGH, FOR THE FULL WIDTH BOTH SIDES OF GATE. ₩ELDED TO GATE FRAME ALL AROUND - NOTE: BOTTOM OF GATE FINISHED GRADE. SHALL BE 2" MAX. FROM FINISHED GRADE.

NOT USED

C4.3

ACCESSIBLE KICKPLATE
C4.3

Sacramento, CA 95822

NO. DESCRIPTION

ADDENDUM NO.1

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Sacramento

**City Unified** 

Sacramento City

5735 47th Avenue

CONSULTANT:

**Unified School District** 

Sacramento, CA 95824-4528

ANTHONY J.

8/11/2023

Sutterville

Elementary

2023 Fencing

4967 Monterey Way

TASSANO

**School District** 

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DESIGNED:
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SMN/AT ISSUANCE:


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DETAILS AND SECTIONS

SHEET NO.

NO SCALE

**C4.3** 

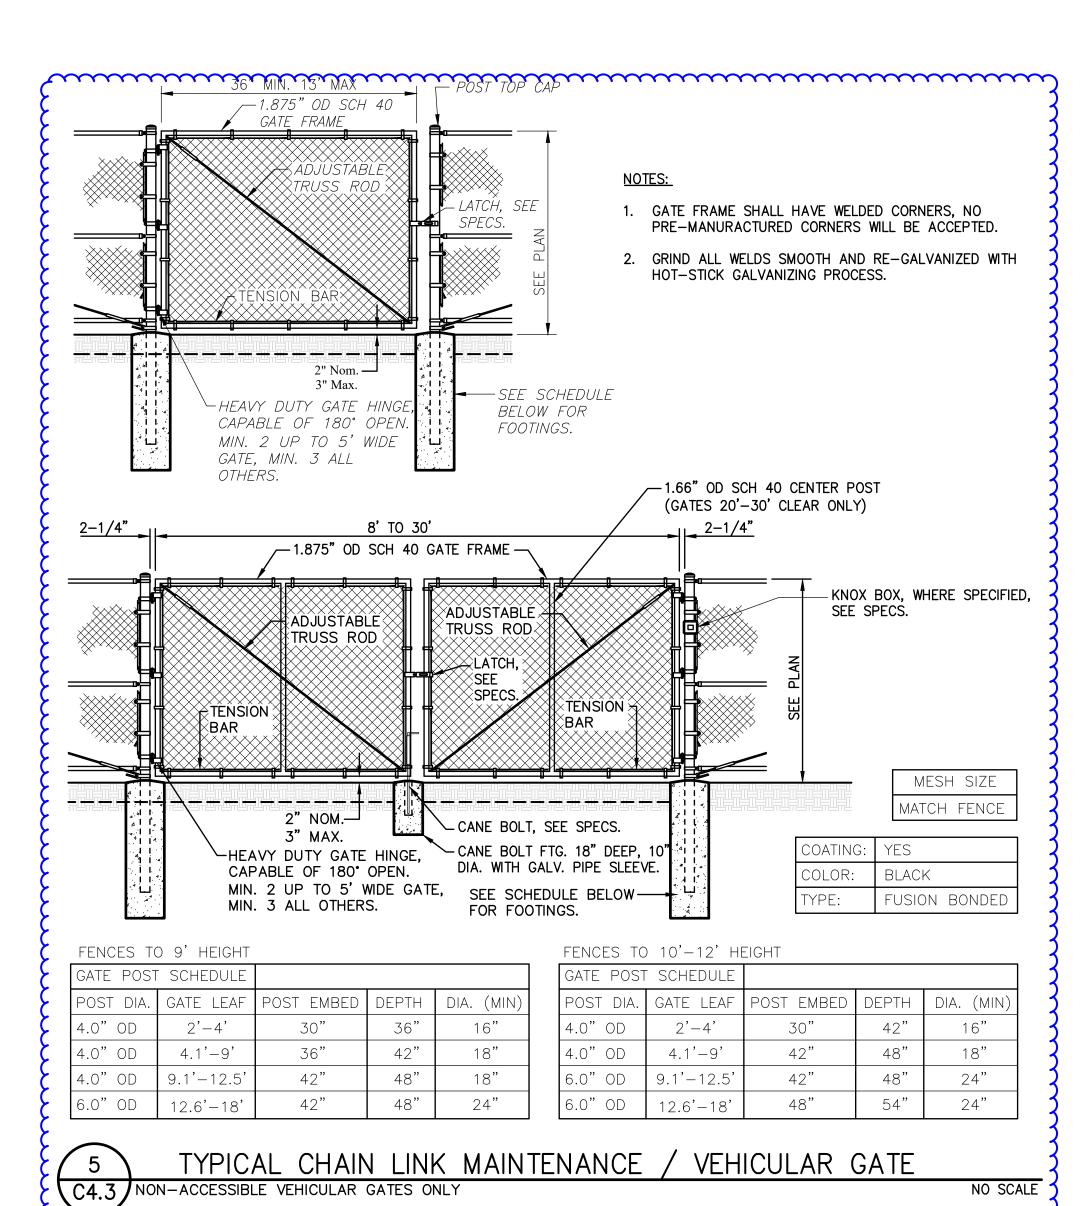

| ABBREVIATIONS:   |  |  |
|--|--|--|
| AFF AFG ANN AP BFF BFG BICSI BLDG CATV CD CFCI CO DN (E) EMT EOL FACP FTC GRC GORGB IACP IIDF IIMC JORJB MPOE (N) NFPA NTS N/A OFE OFOI OSP PVC RCWY RM SR TYP UG UL UNO V | MPERE MBOVE FINISHED FLOOR MBOVE FINISHED GRADE NANUNCIATOR MCCESS POINT SELOW FINISHED FLOOR SUILDING CONDUIT CARBON MOUNT FLOOR CONTRACTOR FURNISHED/CONTRACTOR INSTALLED SENTER LINE CARBON MONOXIDE CONTRACTOR FURNISHED/CONTRACTOR INSTALLED SENTER LINE CARBON MONOXIDE CONTRACTOR FURNISHED/CONTRACTOR INSTALLED SENTER ALARM CONTROL PANEL FIRE FLEMINIAL CABINET SEROUND BOX NTRUSION ALARM CONTROL PANEL TERMINAL CABINET SEROUND BOX NTRUSION ALARM CONTROL PANEL TERMEDIATE DISTRIBUTION FRAME NTERMEDIATE DISTRIBUTION FRAME NTERMEDIATE METAL CONDUIT UNCTION BOX AECHANICAL / ELECTRICAL / PLUMBING MAIN DISTRIBUTION FRAME MINIMUM PONT OF ENTRY JEW MATIONAL FIRE PROTECTION ASSOCIATION TO TO SCALE TOT APPLICABLE TOT APPLICABLE TOWNER FURNISHED EQUIPMENT TOWNER FURNISHED CONTRACTOR INSTALLED TOWNER FURNISHED CONTRACTOR INSTALLED TOWNER FURNISHED FOON TO THE TOTAL TO THE T |  |
|  | VATT<br>VEATHERPROOF   |  |
| ı  |  |  |

#### TECHNOLOGY SYMBOL LEGEND: ALL EQUIPMENT AND MATERIALS ARE CONTRACTOR FURNISHED, INSTALLED AND CONFIGURED (UNO) PART NOTES / DETAIL SYMBOL DESCRIPTION MODEL NUMBER REFERENCES MDF / IDF (E) DATA RACK / CABINET EXISTING EXISTING (N) SURFACE MOUNTED JUNCTION BOX COMMERCIAL COMMERCIAL GREY = EXISTING (E) SURFACE MOUNTED 4-SQUARE EXISTING EXISTING JUNCTION BOX, WALL / CEILING (E) SURFACE RACEWAY - WM5400 EXISTING EXISTING \_\_2300\_\_\_\_2300\_\_\_ | (N) SURFACE RACEWAY WM2300 WIREMOLD QTY. AND SIZE **- - - -** (N) UNDERGROUND BACKBONE CONDUIT AS PER PLAN QTY. AND SIZE (N) BACKBONE CONDUIT EMT / GRC AS PER PLAN (N) BACKBONE CONDUIT STUB ACCESS CONTROL MANAGEMENT AC-MER-CONT-INSTALL AT MDF LOCATION AVIGILON EMBEDDED CONTROLLER LP1501 ACCESS CONTROL MANAGEMENT AC-MER-CONT-AVIGILON INSTALL AT IDF LOCATION EMBEDDED CONTROLLER MR51E <del>......</del> AC-ING-READ-CARD READER AVIGILON APTIQ-SNG-MT15 ACCESS CONTROL POWER SUPPLY UNIT W/ AC-LSP-2DR-AVIGILON INSTALL AT MDF LOCATION BATTERY BACKUP MER-LCK ELECTRONIC LATCH VON DUPRIN 6300 VIDEO INTERCOM WITH SURFACE MOUNTED AVIGILON H4VI-RO1-IR, H4VI-MT-SURF1 (N) DATA NETWORK POE SWITCH WITH SFP LMP-1002G ANTAIRA SINGLE MODE TRANSCEIVER -10G-SFP (N) POWER SUPPLY ANTAIRA SDR-960-48 (N) NETWORK VIDEO RECORDER NVR-RL-2-24TB-V4 INSTALL AT MDF LOCATION NOT USED NOT USED NOT USED **M** QUANTITY 100. SERIALIZED PER RFID CARDS SCHLAGE 8520 DISTRICT REQUIREMENTS. PROGRAM SOFT KEY AT (E) PHONE SET (E) ADMINISTRATIVE DESK PHONE SET CISCO EXISTING FOR GATE UNLOCK

# PROJECT CODES AND STANDARDS:

PARTIAL LIST OF APPLICABLE CODES AND STANDARDS EFFECTIVE : JANUARY 1, 2023:

2022 CALIFORNIA ADMINISTRATIVE CODE (CAC), CCR, TITLE 24, PART 1

2022 CALIFORNIA BUILDING CODE (CBC), CCR, TITLE 24, PART 2 (2018 INTERNATIONAL BUILDING CODE WITH CALIFORNIA AMENDMENTS)
2022 CALIFORNIA ELECTRICAL CODE (CEC), CCR, TITLE 24, PART 3 (2017

NATIONAL ELECTRICAL CODE WITH CALIFORNIA AMENDMENTS)

2022 CALIFORNIA MECHANICAL CODE (CMC), CCR, TITLE 24, PART 4 (2018
UNIFORM MECHANICAL CODE, WITH CALIFORNIA AMENDMENTS)

2022 CALIFORNIA ENERGY CODE, CCR, TITLE 24, PART 6
2022 CALIFORNIA FIRE CODE (CFC), CCR, TITLE 24, PART 9 (2018
INTERNATIONAL FIRE CODE WITH CALIFORNIA AMENDMENTS)
2022 CALIFORNIA GREEN BUILDING STANDARDS CODE, CCR, TITLE 24,

PART 11
2022 CALIFORNIA REFERENCED STANDARDS CODE, CCR, TITLE 24, PART
12

2022 NFPA 72: NATIONAL FIRE ALARM AND SIGNALING CODE, NATIONAL FIRE PROTECTION ASSOCIATION

# SCOPE OF WORK:

- 1. FURNISH AND DELIVER (N) VIDEO INTERCOMS AND (N) ELECTRONIC ACCESS CONTROLLERS TO DISTRICT FOR PROGRAMMING.
- 2. PROVIDE AND INSTALL (N) NETWORK VIDEO RECORDER IN MDF.
  REMOVE (E) NETWORK VIDEO RECORDER AND RETURN TO
- 3. FURNISH AND INSTALL VIDEO INTERCOM, CARD READER AND ELECTRONIC LATCH ON CENTER GATE MULLION. SEE DETAIL 8/T900 FOR MORE INFORMATION.
- FURNISH AND INSTALL 1" CONDUIT FROM MULLION TO GROUND BOX
- FURNISH AND INSTALL 12"X12"X4" NEMA 3R J-BOX AND PENETRATE WALL. SEAL WATERTIGHT.
- 6. FURNISH AND INSTALL WIREMOLD 2300 PATHWAY, 2-GANG BOXES, AND PENETRATE WALL INTO EXISTING J-BOX IN ENTRY CORRIDOR.
- 7. FURNISH AND INSTALL CCTV SWITCH AND POWER SUPPLY IN (E) MDF AND IDF CABINET.
- FURNISH AND INSTALL ELECTRONIC ACCESS CONTROLLER AND POWER SUPPLY IN MDF AND IDF. MODIFICATIONS TO ELECTRIC POWER TO BE PERFORMED BY A LICENSED ELECTRICIAN.
- COORDINATE WITH DISTRICT TO PROGRAM ADMIN PHONE SET FOR RINGDOWN FROM VIDEO INTERCOM.

# SHEET INDEX:

| SHEET NO.    | DESCRIPTION  |
|--------------|--|
| Т000         | TECHNOLOGY COVER SHEET   |
| T200<br>T200 | TECHNOLOGY FLOOR PLAN - MAIN GATE TECHNOLOGY FLOOR PLAN - SOUTH MAN GATE |
| Т800         | TECHNOLOGY DETAILS   |



1117 WINDFIELD WAY, SUITE 110

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Sacramento City Unified School District 5735 47th Avenue Sacramento, CA 95824-4528

MSULTANT:



ANTHONY J.
TASSANO
NO. C74696

CIVIL
8/14/2023

Sutterville Elementary 2023 Fencing

4967 Monterey Way Sacramento, CA 95822

REVISIONS

NO. DESCRIPTION

ABIDDENCOLUM TECO2023-08-14

DRAWN:

JG
AS NOTED

CHECKED:

CS
23-056

DESIGNED:

CC
4/24/2023


SSUANCE:

SHEET TITLE:

TECHNOLOGY COVER SHEET

SHEET NO.

T000

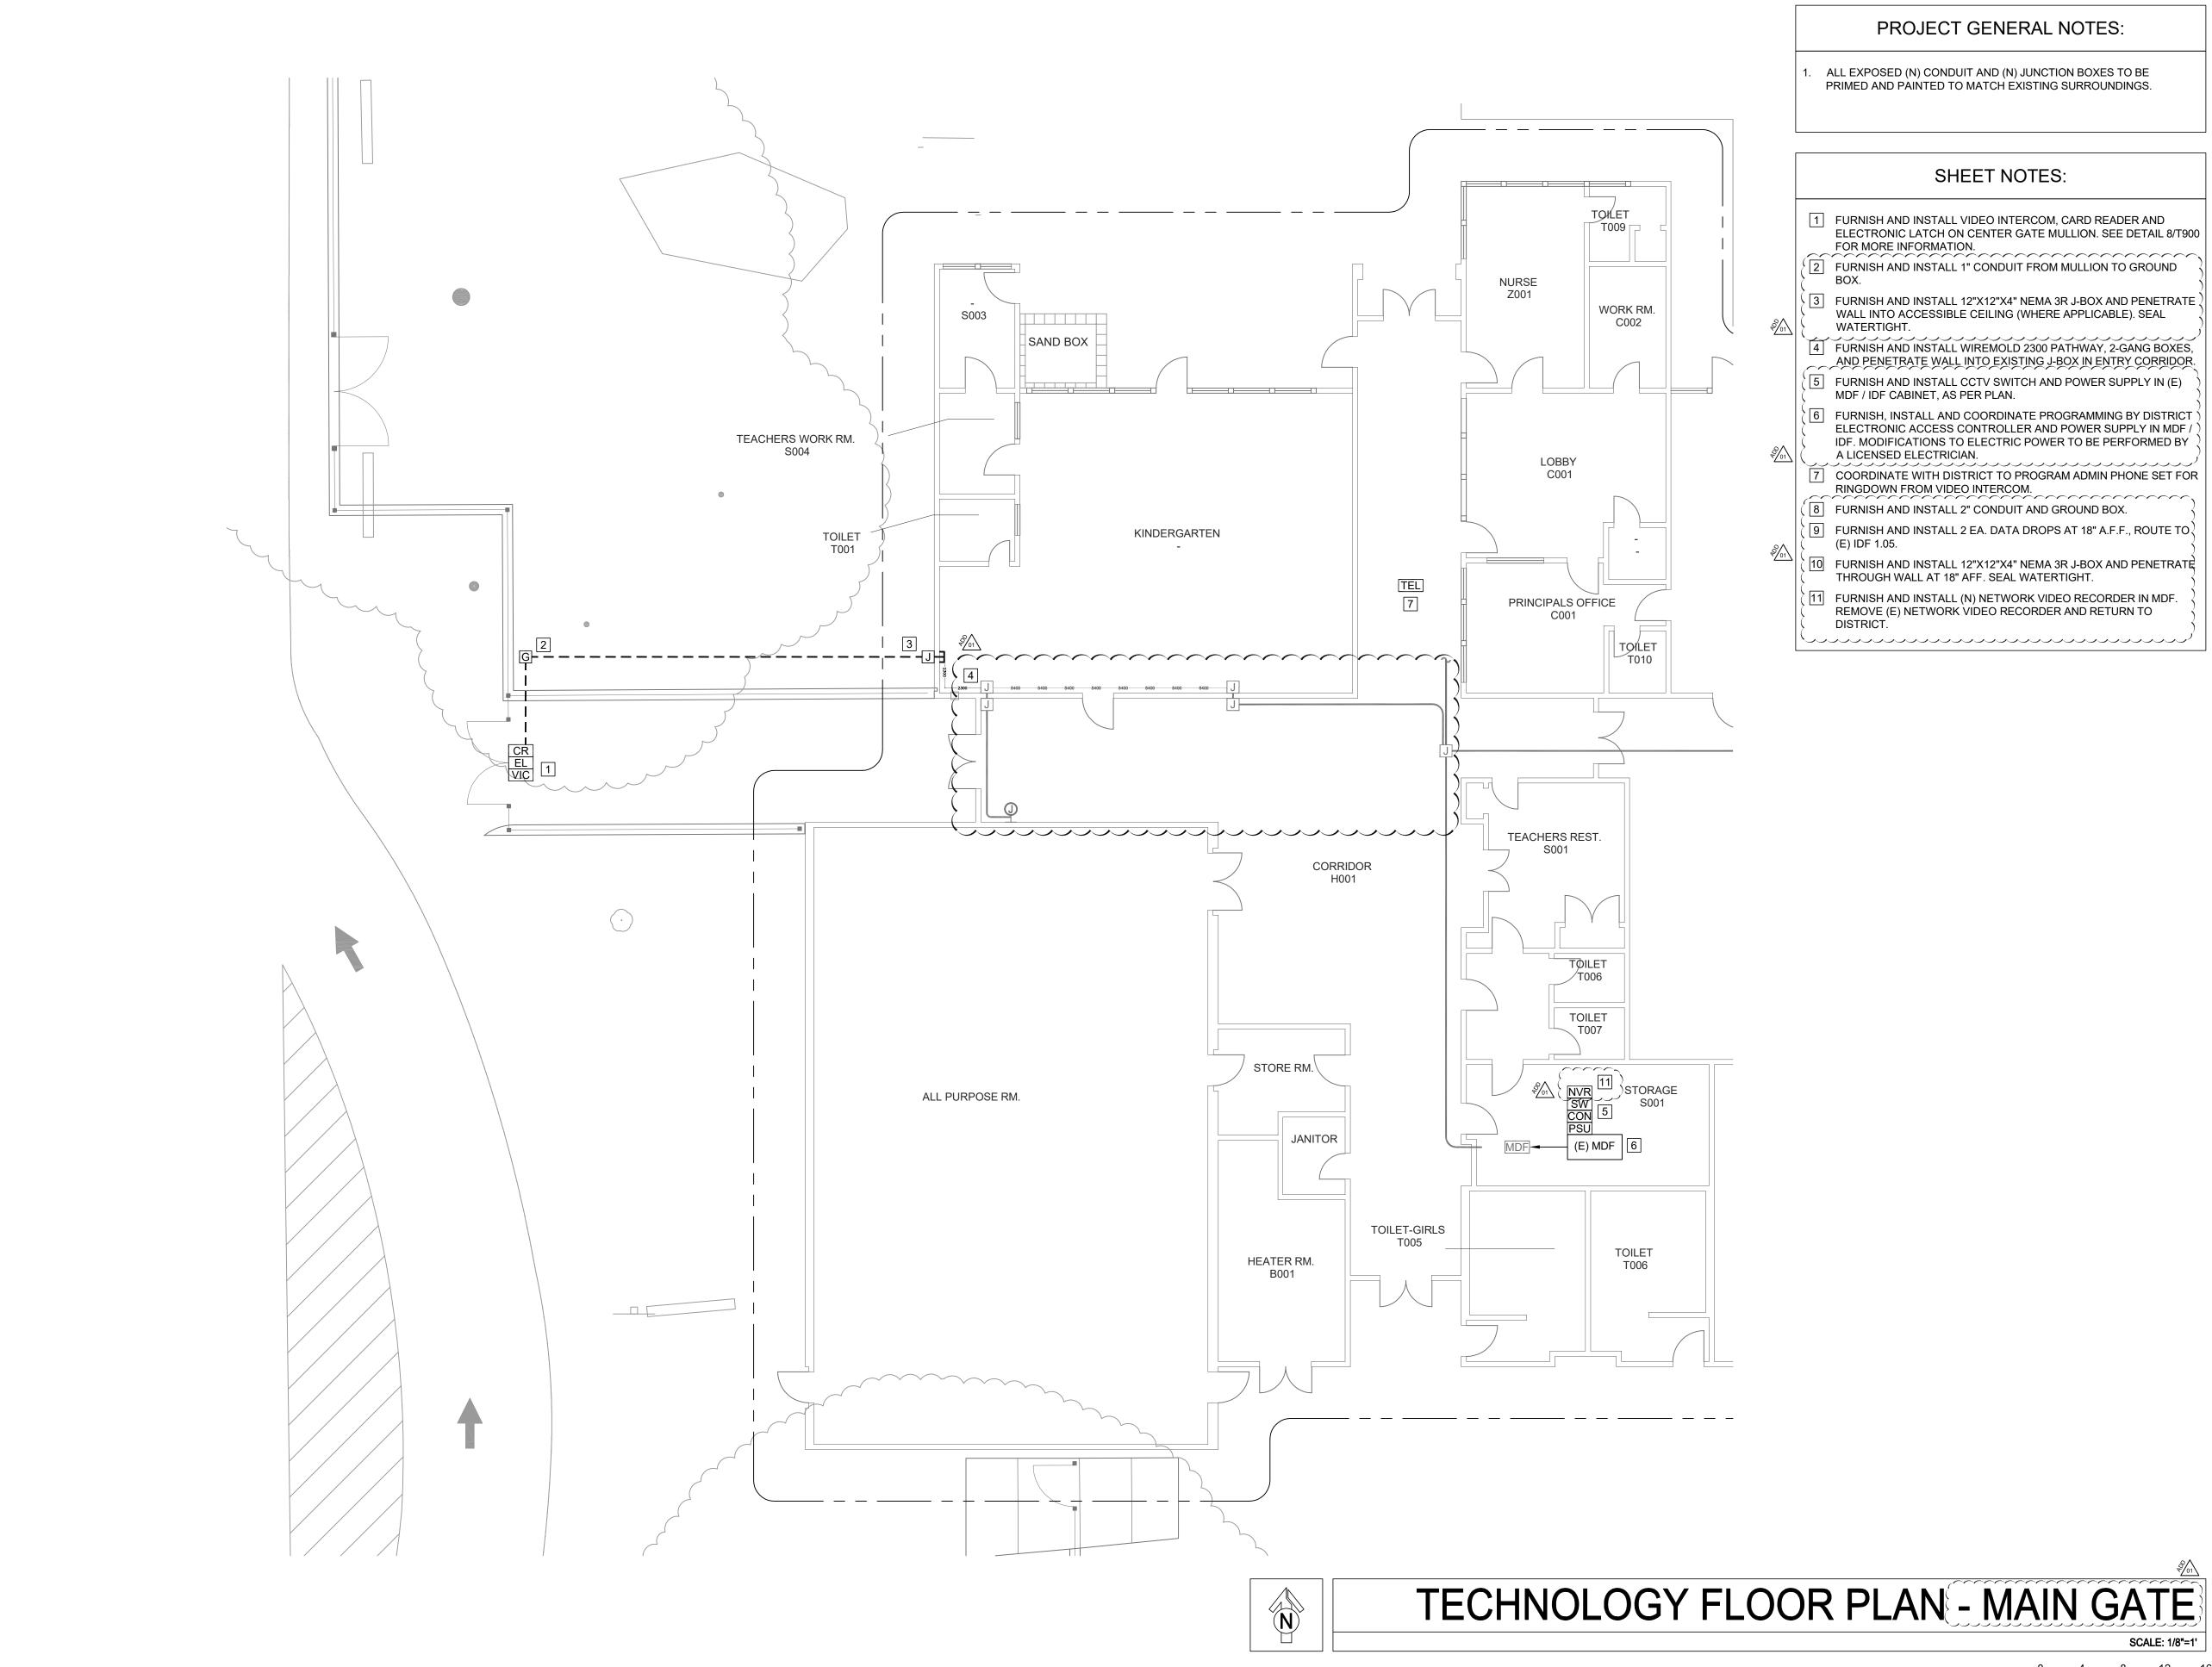

- 1 FURNISH AND INSTALL VIDEO INTERCOM, CARD READER AND
- WALL INTO ACCESSIBLE CEILING (WHERE APPLICABLE). SEAL
- 6 FURNISH, INSTALL AND COORDINATE PROGRAMMING BY DISTRICT ELECTRONIC ACCESS CONTROLLER AND POWER SUPPLY IN MDF /
- COORDINATE WITH DISTRICT TO PROGRAM ADMIN PHONE SET FOR
- (9) FURNISH AND INSTALL 2 EA. DATA DROPS AT 18" A.F.F., ROUTE TO
- FURNISH AND INSTALL (N) NETWORK VIDEO RECORDER IN MDF. REMOVE (E) NETWORK VIDEO RECORDER AND RETURN TO



WARREN CONSULTING ENGINEERS, INC. 1117 WINDFIELD WAY, SUITE 110 EL DORADO HILLS, CA 95762 | (916) 985-1870



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**REVISIONS** DESCRIPTION ABODENO LIM NEC 2023 - 08 - 14

CHECKED: PROJECT NO. ESIGNED:


SSUANCE:

**TECHNOLOGY** FLOOR PLAN - MAIN GATE

SHEET NO.

T200



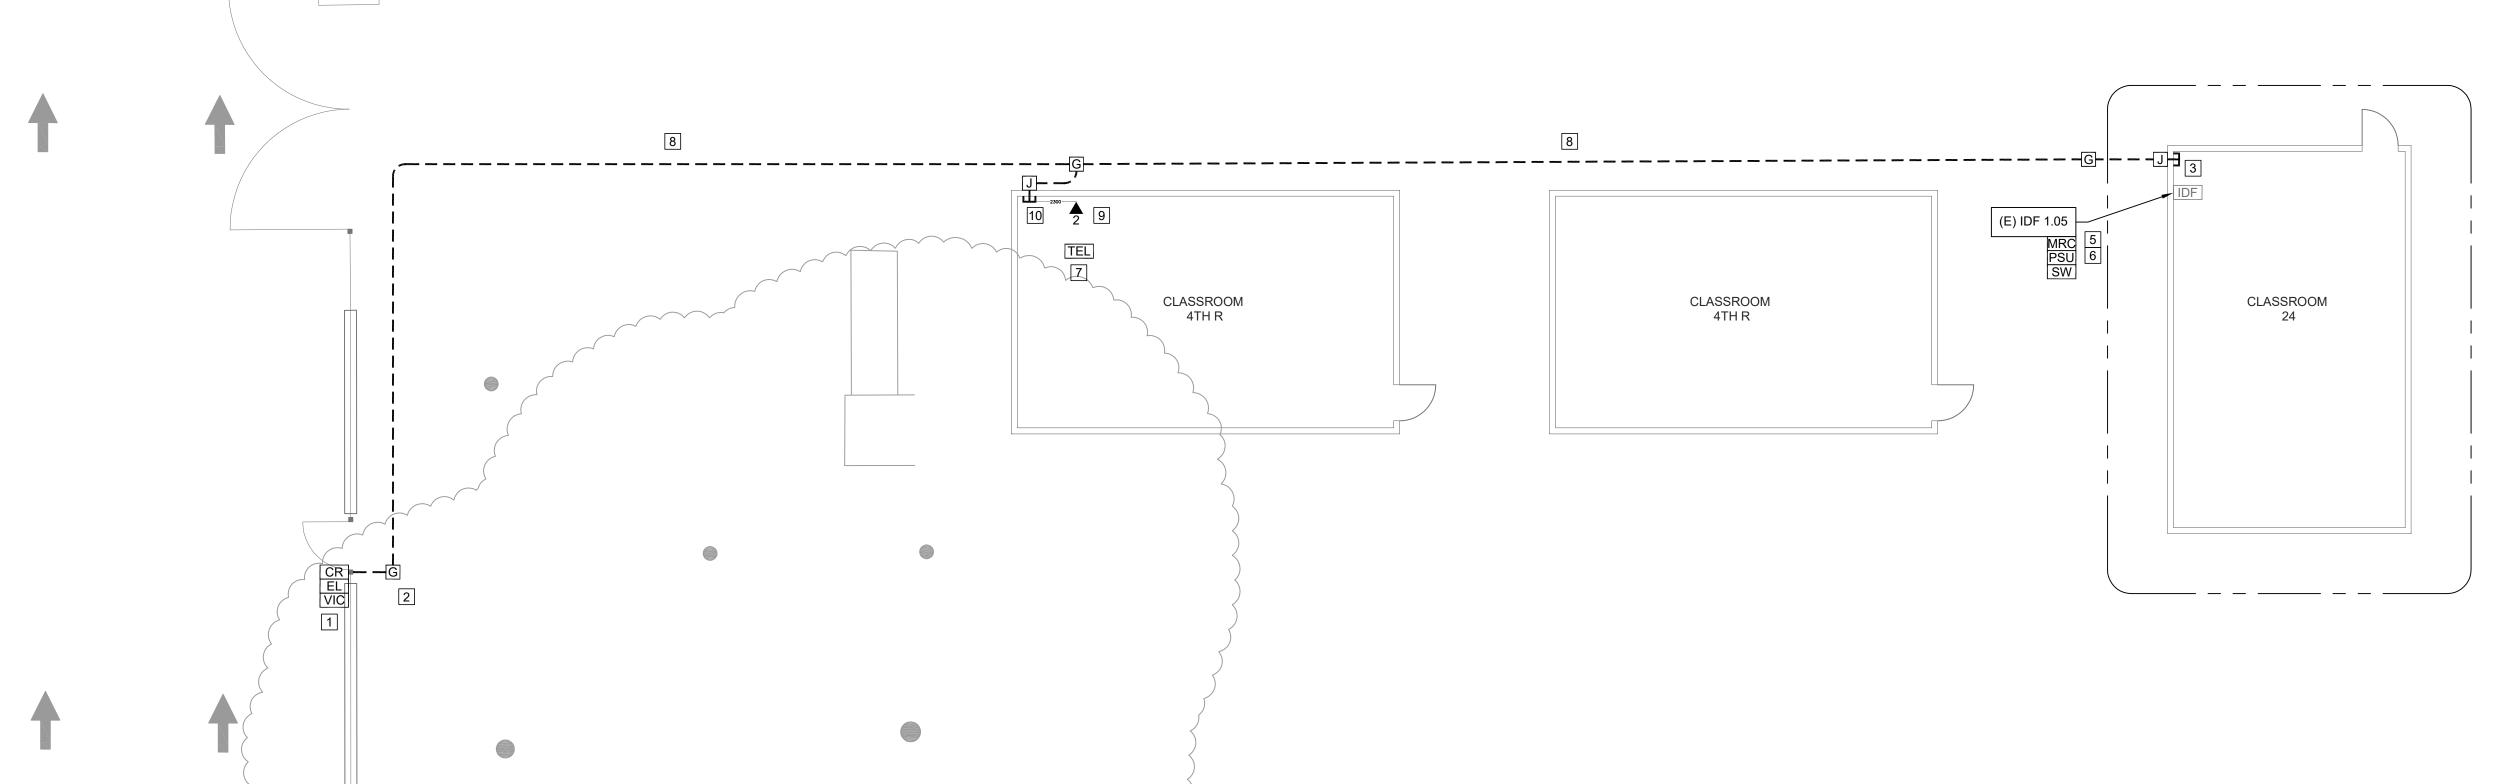




# TECHNOLOGY FLOOR PLAN - SOUTH MAN GATE

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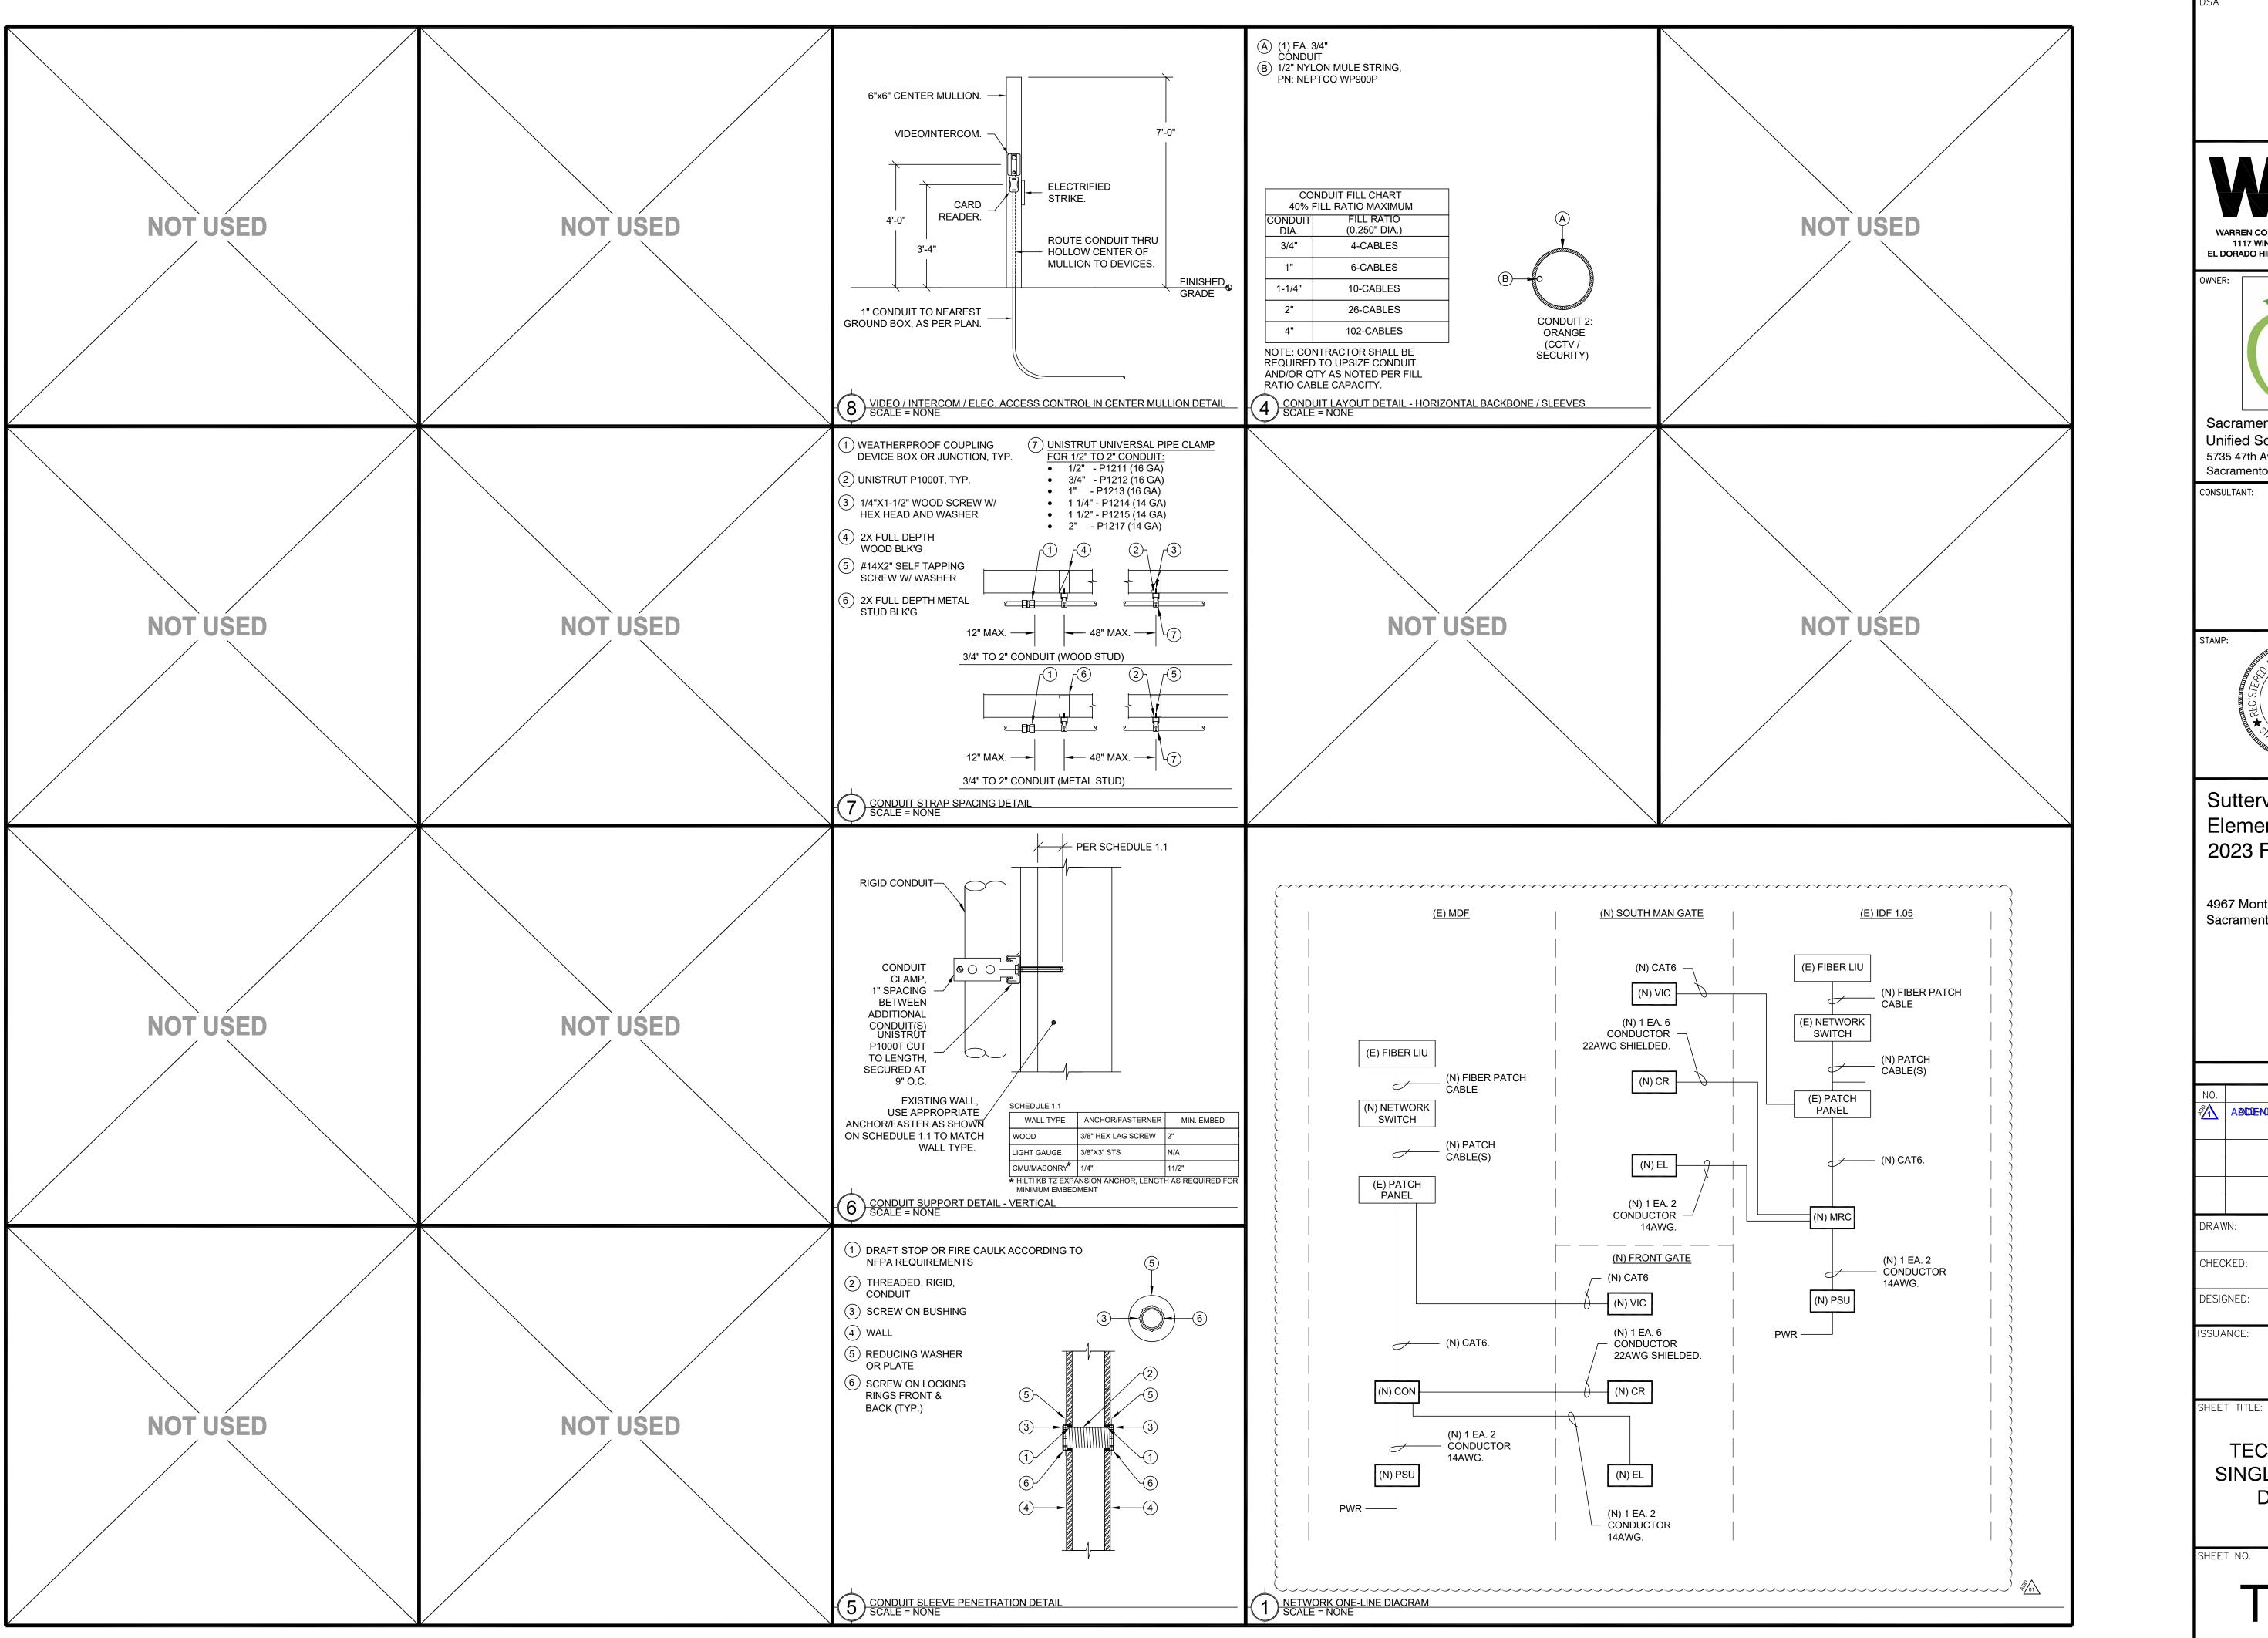
**REVISIONS** DESCRIPTION ABDDENO LIM NEC 2023 - 08 - 14

CHECKED: PROJECT NO. ESIGNED:

SSUANCE:

**TECHNOLOGY** FLOOR PLAN - SOUTH MAN GATE

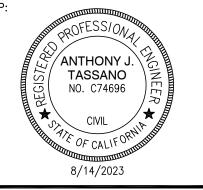





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8/14/2023

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**REVISIONS** DESCRIPTION ABDDENOD LDM TNEO2023-08-14

DRAWN: SCALE: AS NOTE CHECKED: PROJECT NO. 23-05 DESIGNED: DATE: 4/24/202

**TECHNOLOGY** SINGLE LINE AND **DETAILS**