

1 **GLULAM RAFTER @ WALL CONNECTION DETAIL**
 SCALE: 1 1/2" = 1'-0"



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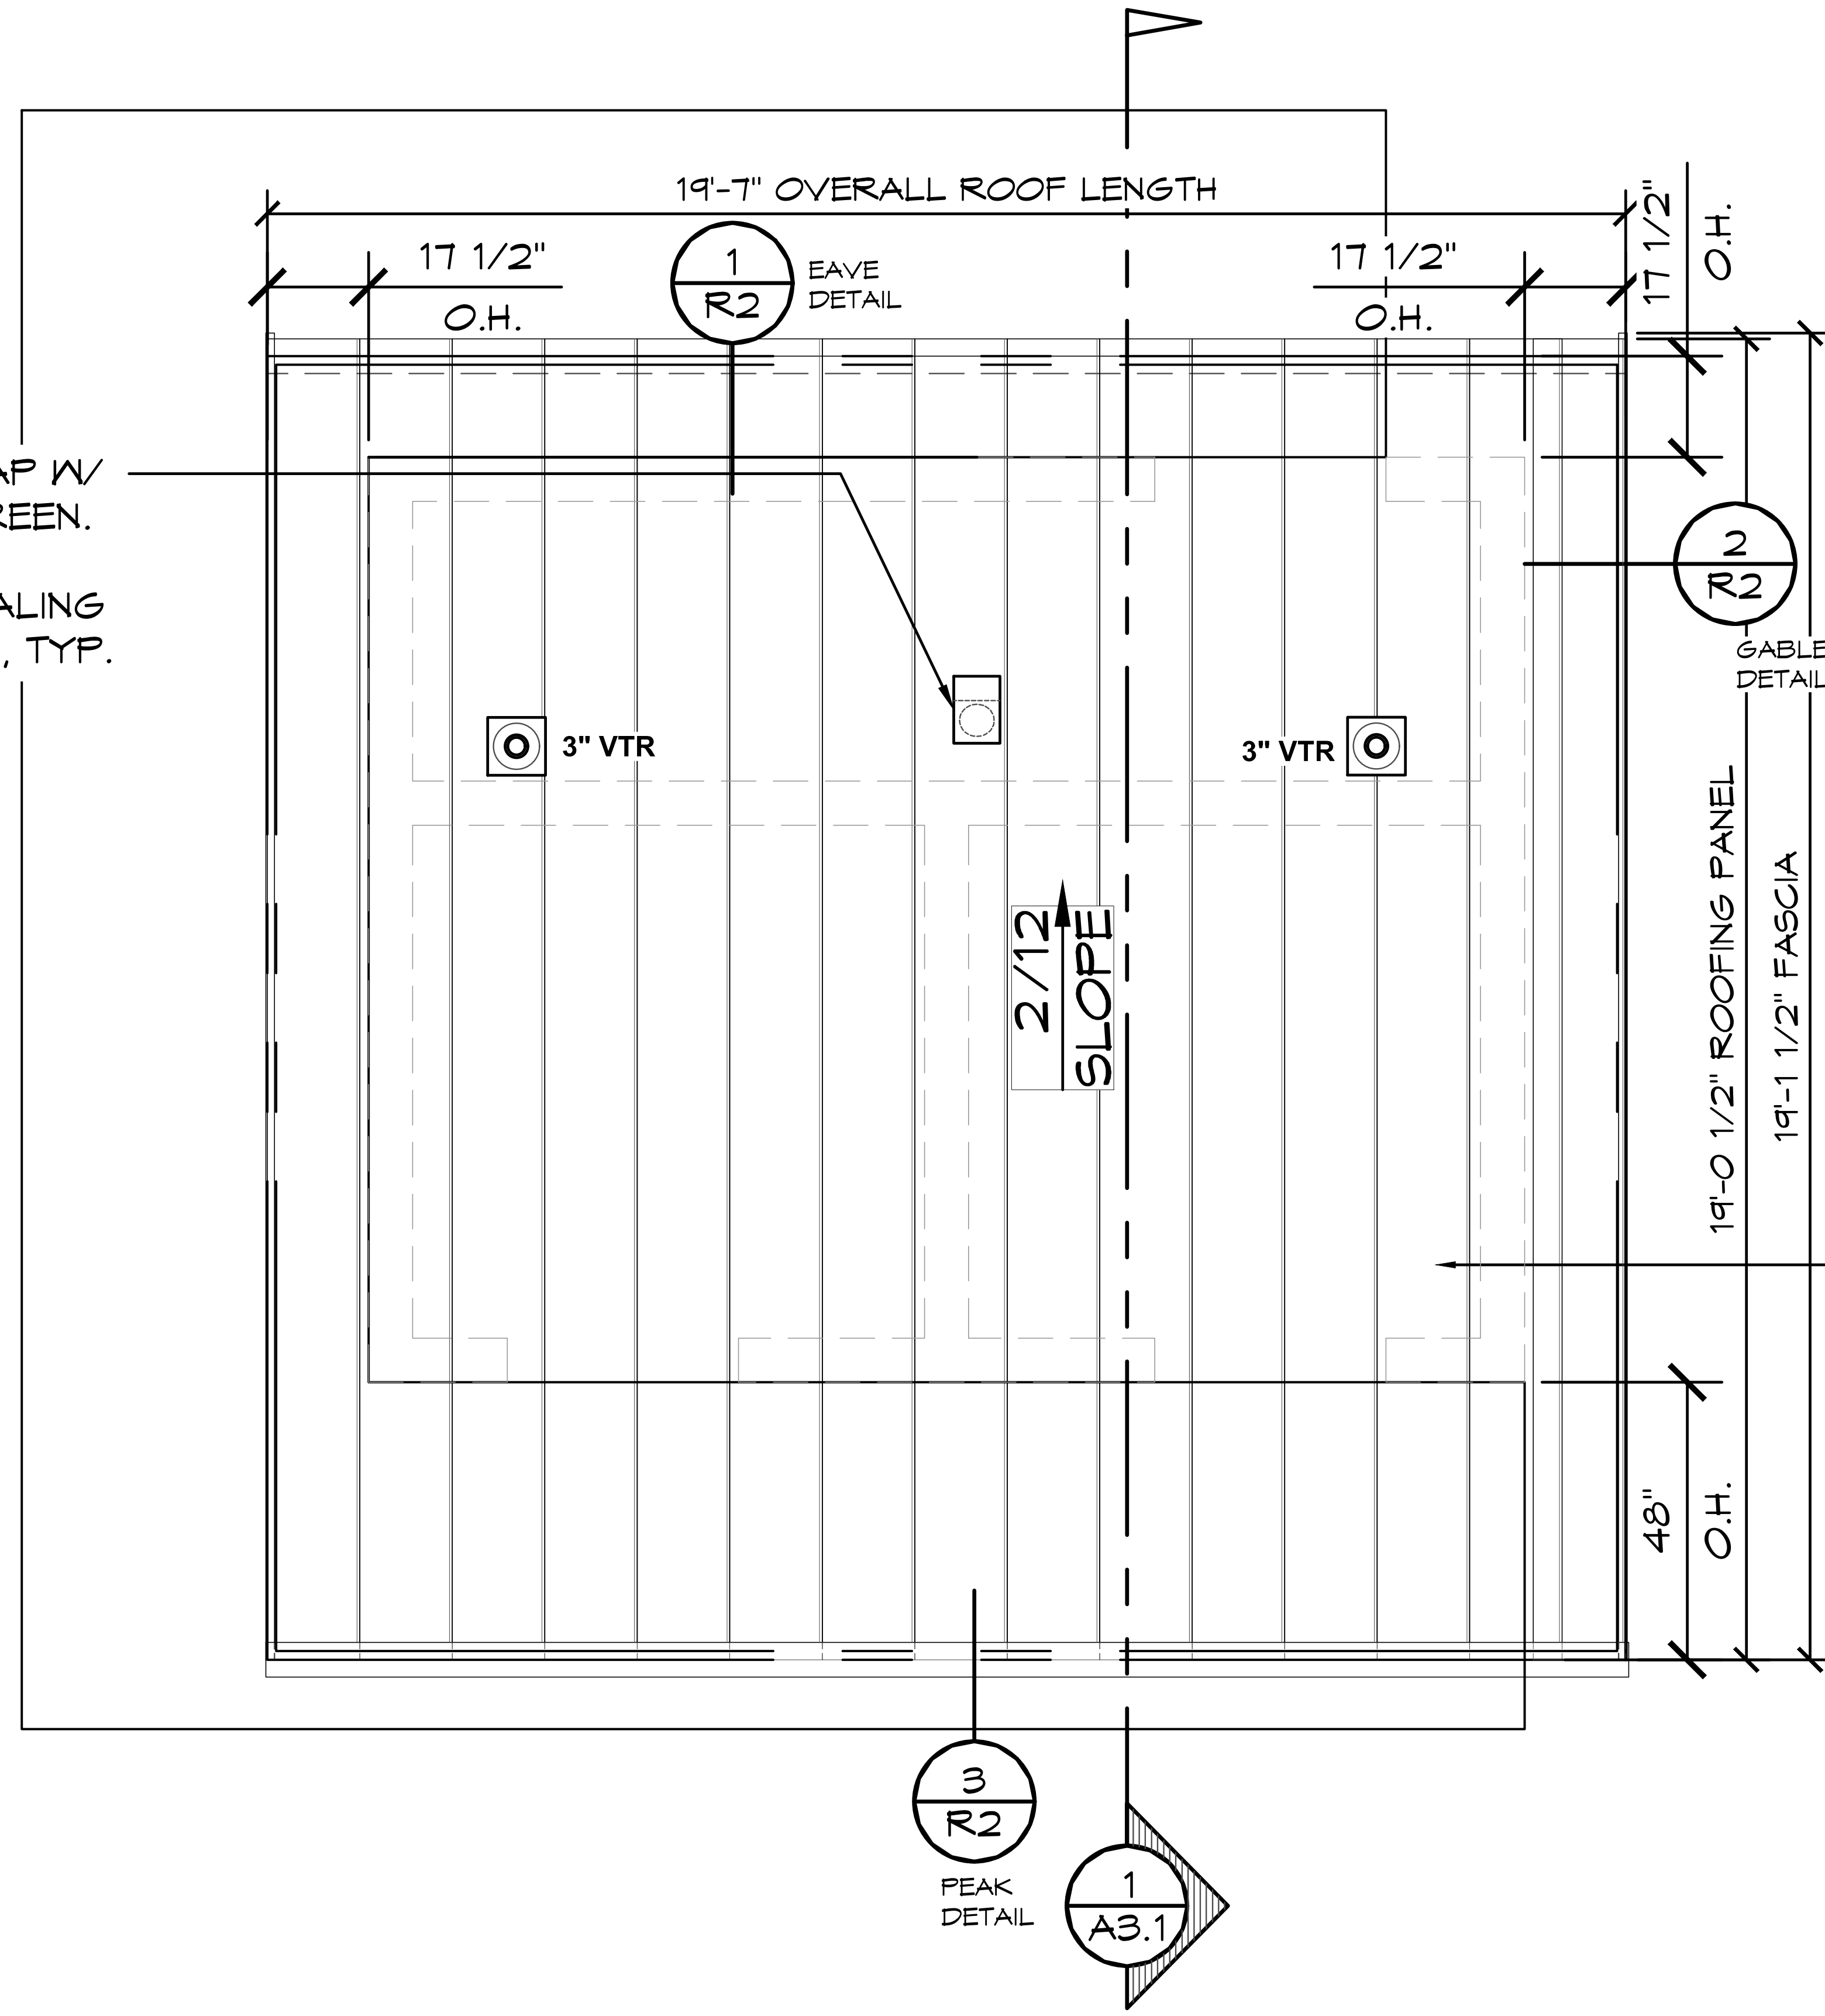
ROMTEC

PROJECT: 2022 SIERRA II COMPACT 16'-8" W/ MECH RM
 JOHN F. KENNEDY RR FACILITY
 SACRAMENTO, CALIFORNIA
 SHEET TITLE: CONNECTION DETAILS

PLAN SET#	LFK01		
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SHEET NO. **S10.3**


EXHAUST FAN ROOF CAP W/
 6" COLLAR & BIRD SCREEN.
 SEAL PENETRATION W/
 METAL ROOF VENT SEALING
 ADAPTER MULTI-FLASH, TYP.



NOTE:
 FLASHING SECTIONS OVER
 10'-6" IN LENGTH SHALL BE
 OVERLAPPED BY 4" AND
 EVERY EFFORT MUST BE
 MADE TO ENSURE A
 SYMMETRICAL APPEARANCE

STANDING SNAP LOCKING SEAM METAL ROOFING
 CUSTOM-BILT METALS SL-1750-18" WIDTH PANEL
 (ICC-ES ESL-1441), OVER UNDERLAYMENT - ICE &
 WATER SHIELD SHALL EXTEND 24" PAST
 EXTERIOR WALL AT PERIMETER WITH #30
 ROOFING FELT IN FIELD, TYP.

1 ROOFING PLAN
 SCALE: 1/4" = 1'-0"

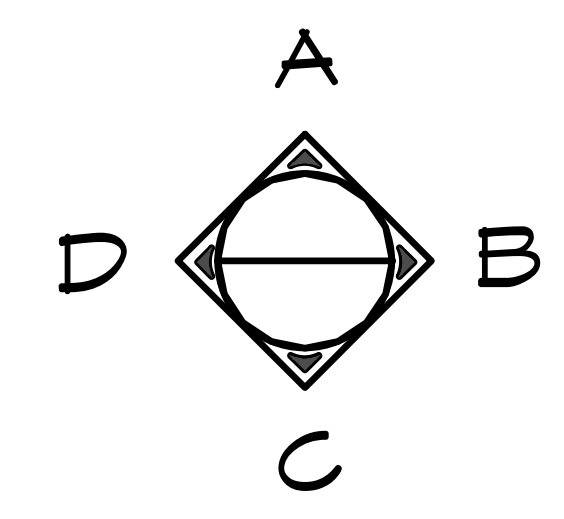


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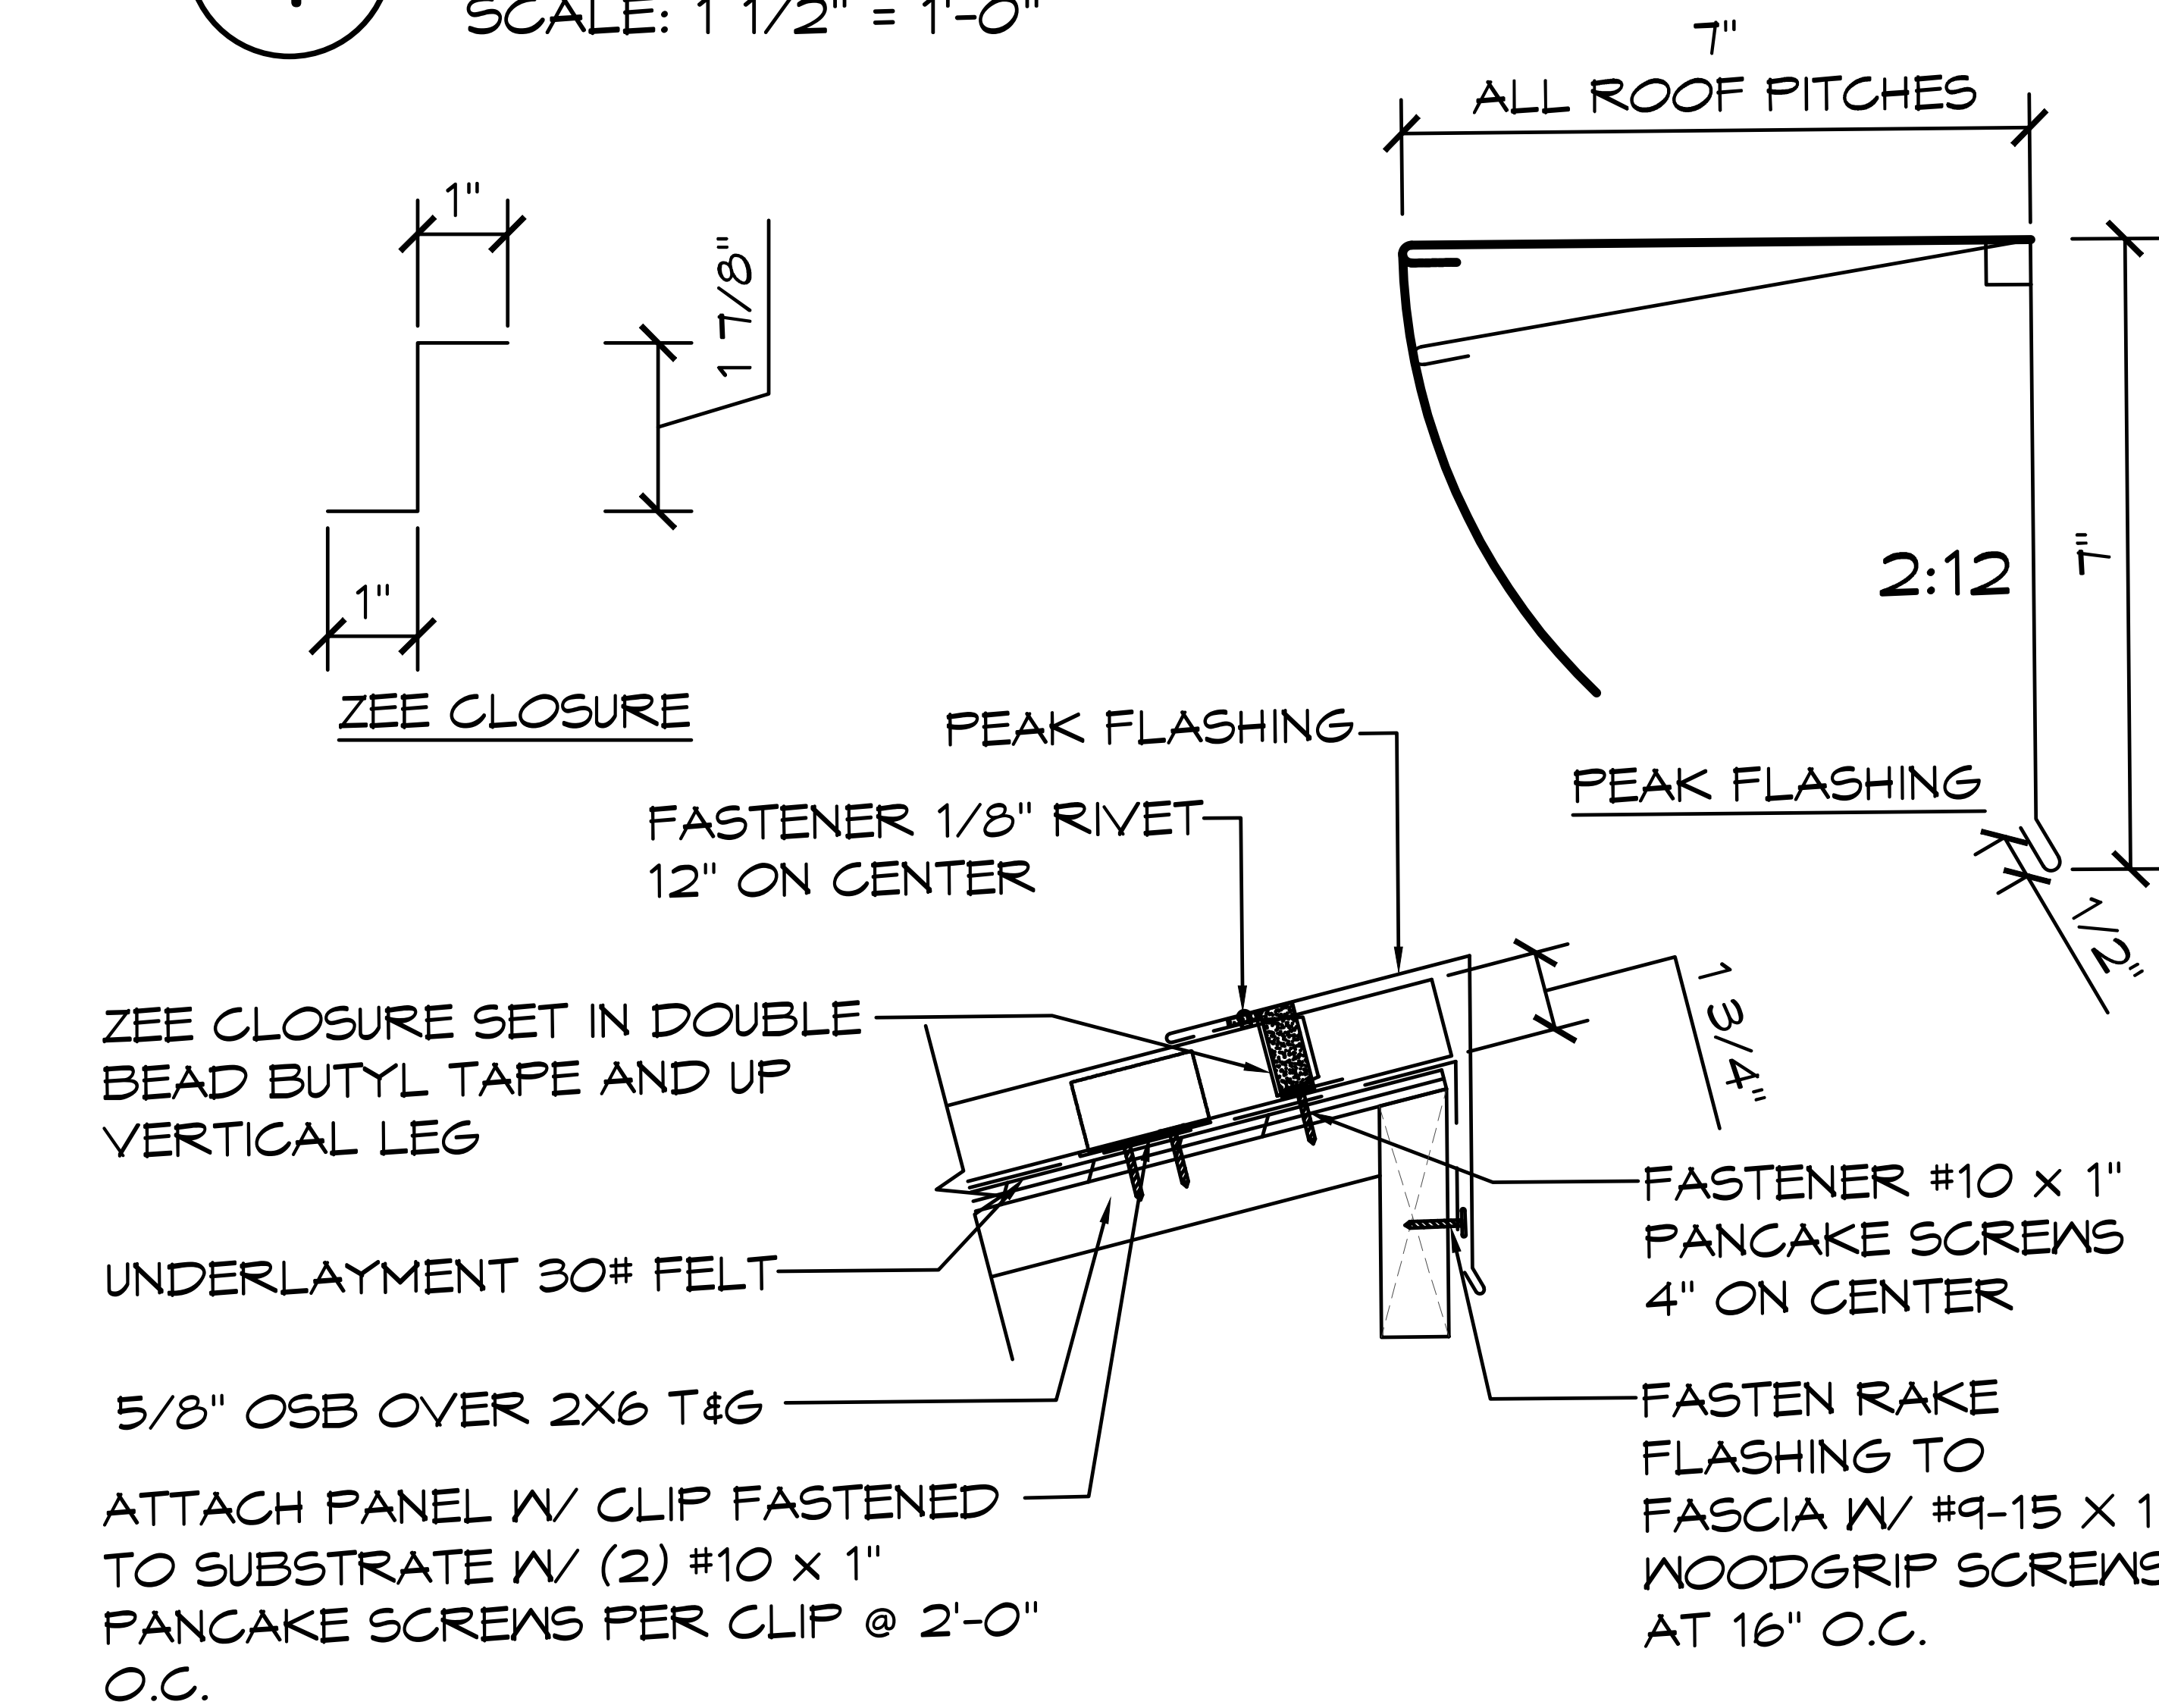
PROJECT: 2022 SIERRA II COMPACT 16'-8" W/ MECH RM
 JOHN F. KENNEDY RR FACILITY
 SACRAMENTO, CALIFORNIA
 SHEET TITLE: ROOFING PLAN

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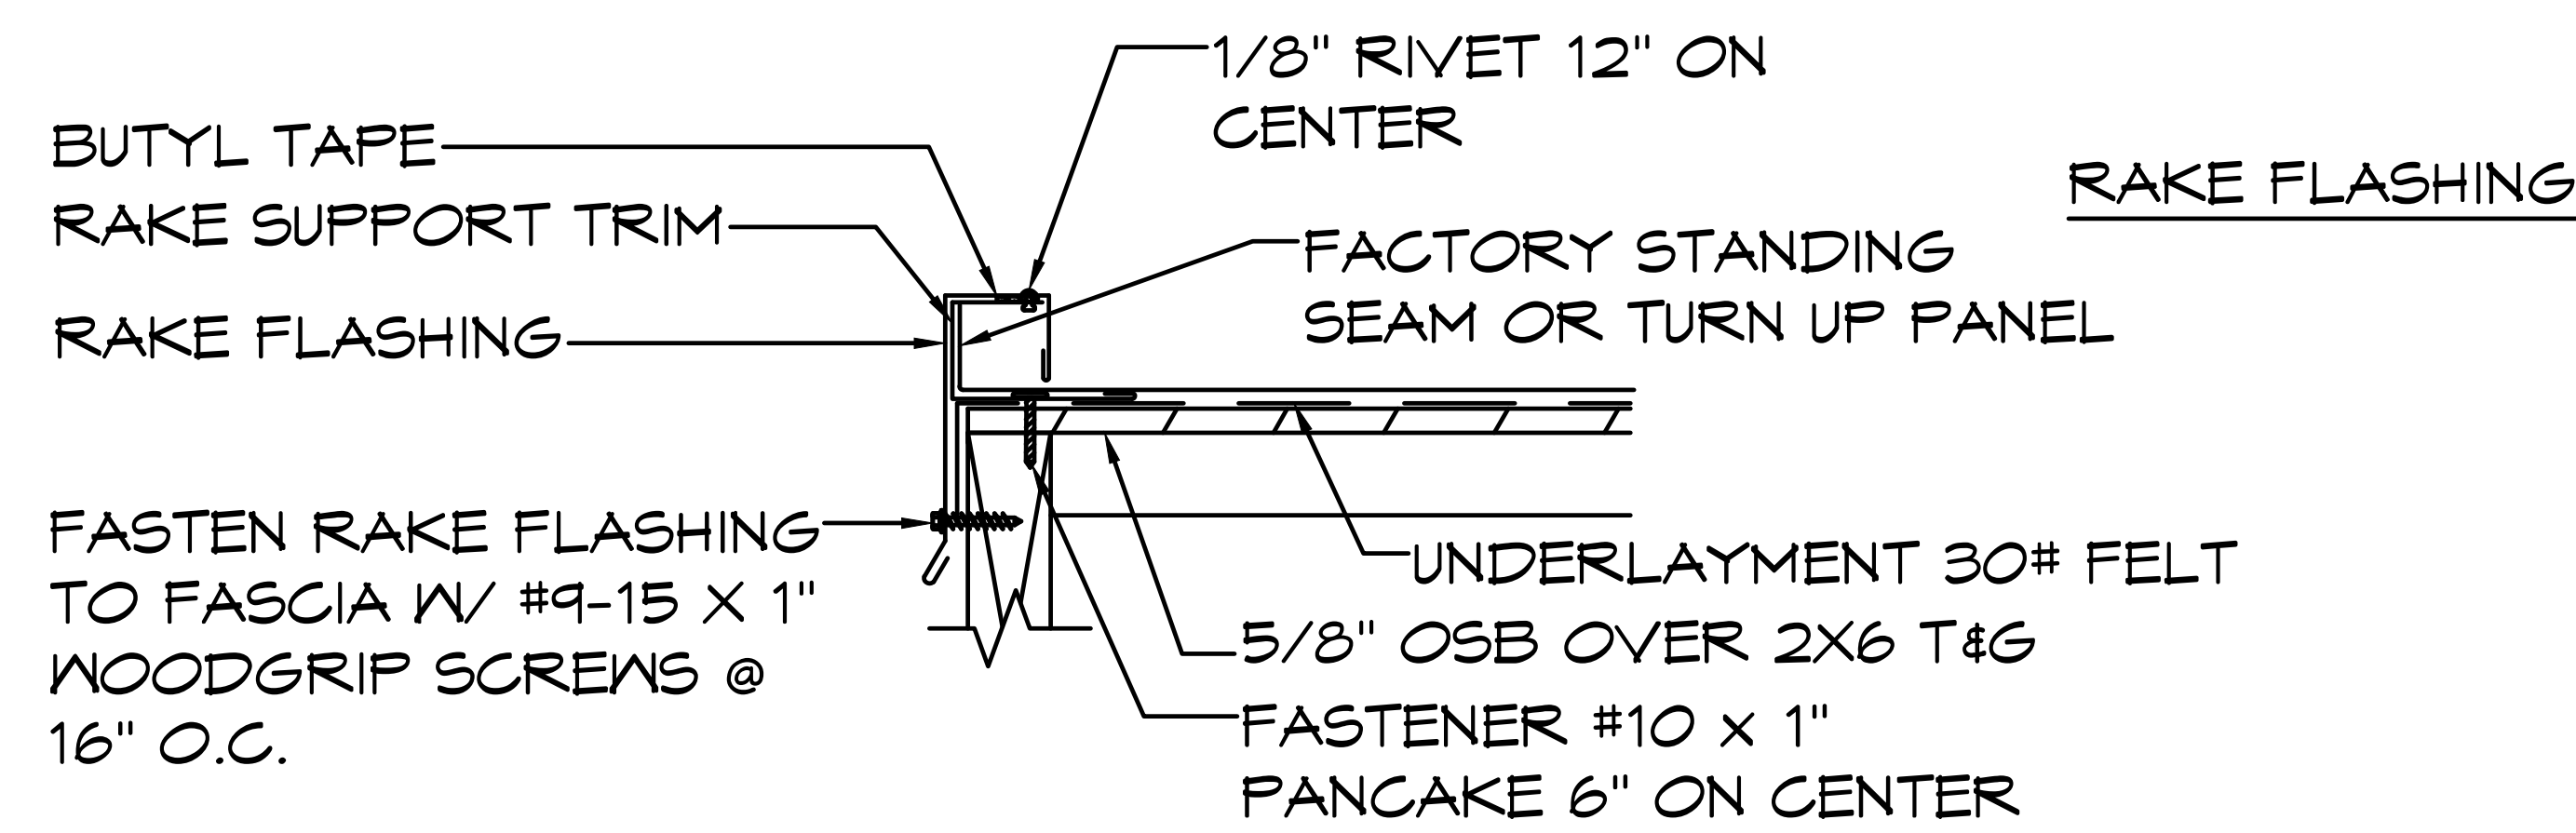
SHEET NO. **R1**



1 EAVE ROOFING DETAIL (SL1)
 SCALE: 1 1/2" = 1'-0"

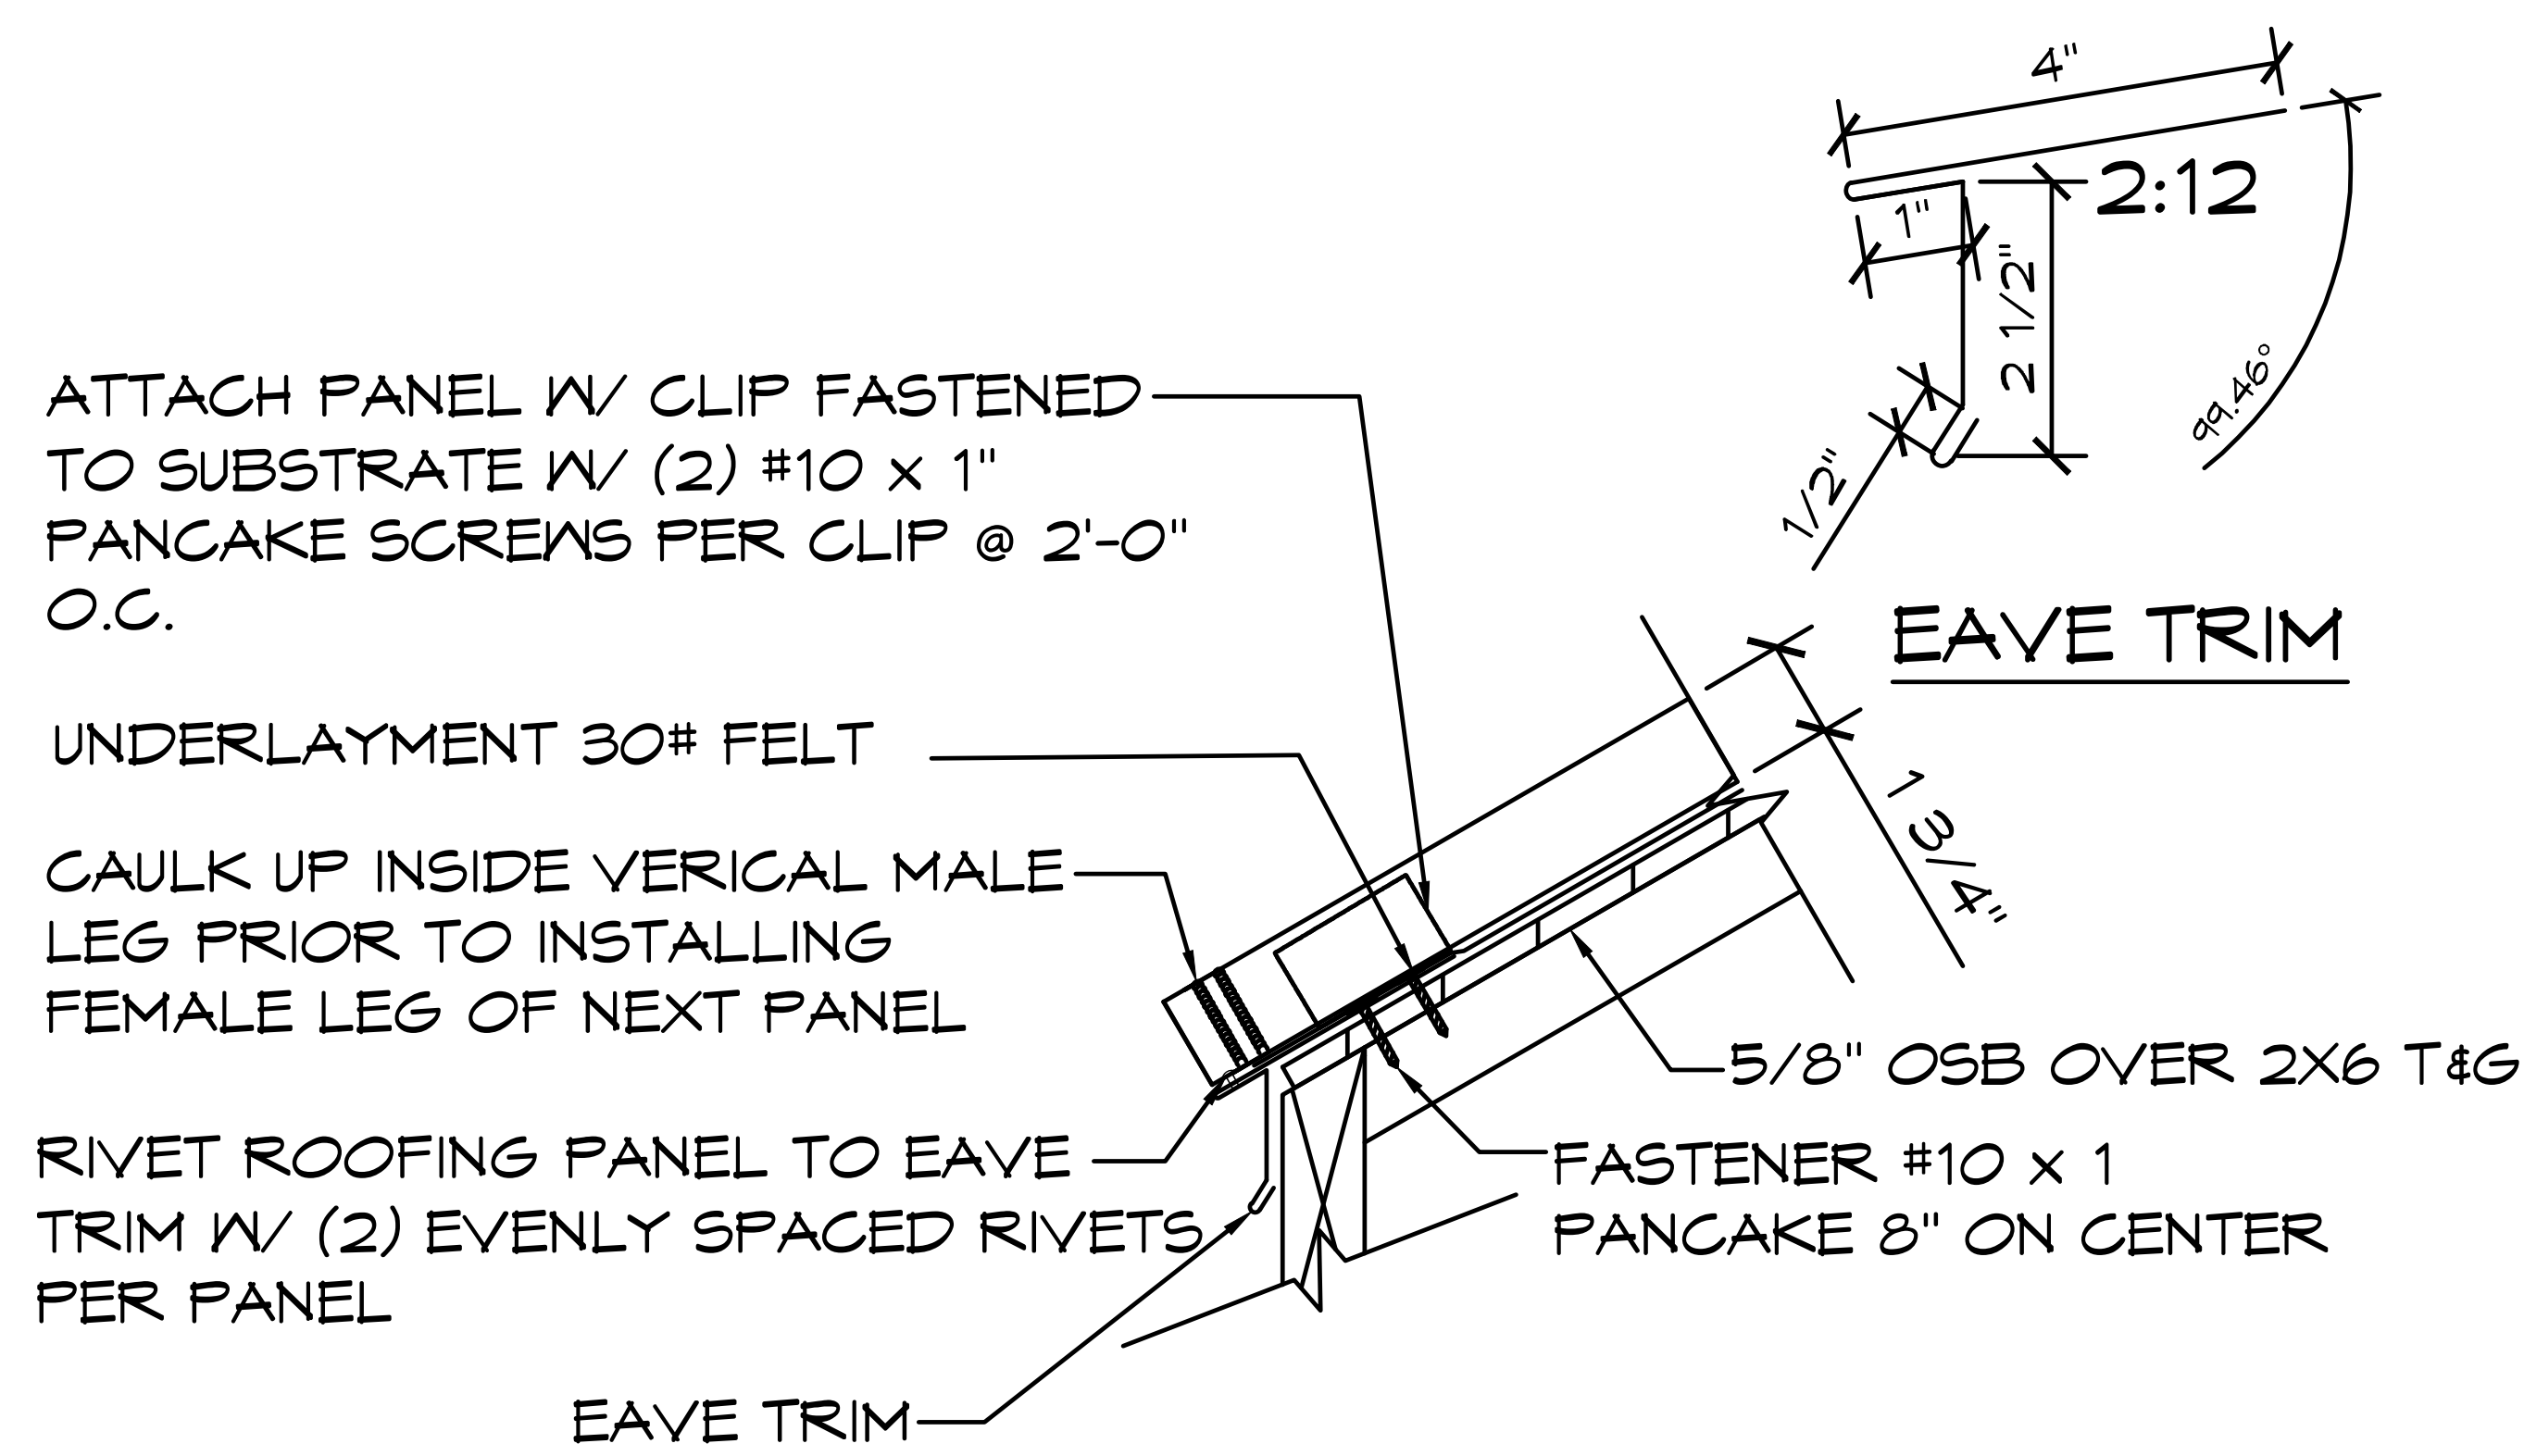


3 PEAK ROOFING DETAIL (SL8)
 SCALE: 1 1/2" = 1'-0"



2 RAKE ROOFING DETAIL (SL11)
 SCALE: 1 1/2" = 1'-0"

NOTE:
 ALL ROOF FLASHING IS 26 GAUGE SHEET METAL
 CONTRACTOR SHALL INSTALL ROOFING IN STRICT ACCORDANCE WITH INSTALLATION REQUIREMENTS OF ROOFING MANUFACTURER.
 SPECIAL TOOLS REQUIRED:
 POP RIVET GUN COMPATIBLE WITH 1/8" Ø RIVETS

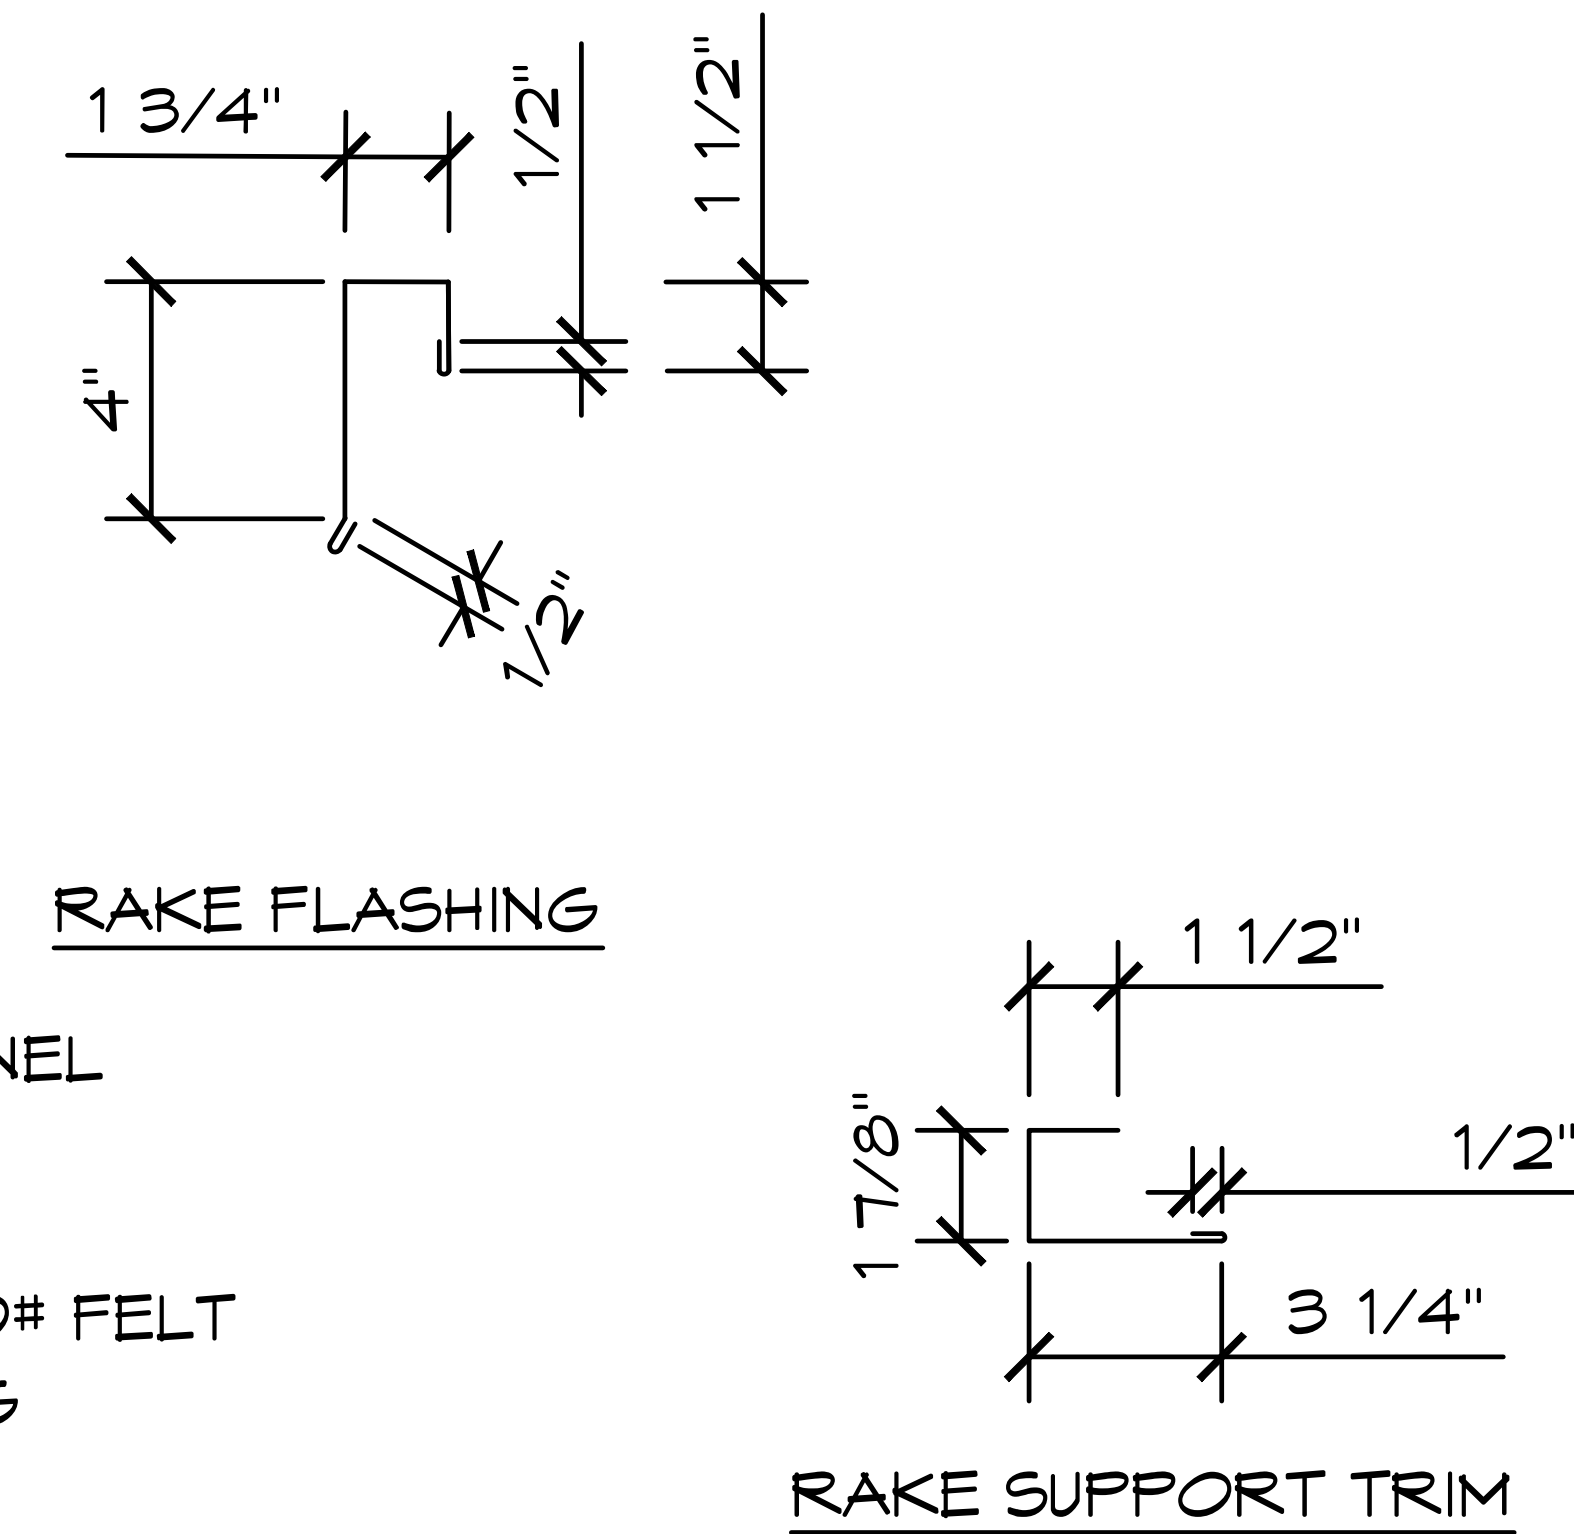

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R2


CALIFORNIA PLUMBING CODE (BASED OFF UPC)

SYM	FIXTURE TYPE	SEWER	VENT	COLD WATER	HOT WATER	MIXED WATER	NO OF FIXT.	W. FIXT. UNITS/EA	TOTAL W. FIXT UNITS	DR. FIXT UNITS	TOTAL DR. FIXT. UNITS
WC	ADA TOILET	3"	2"	1"	X	-	2	40,30,20,15,10	70	4	8
LAV	HAND SINK	1 1/4"	1 1/2"	X	X	1/2"	2	1	2	1	2
S-1	UTILITY/MOP SINK	2"	1 1/2"	1/2"	X	1/2"	1	3	3	3	3
DF-1	DRINKING FOUNTAIN	1 1/2"	1 1/2"	1/2"	X	-	3	.5	1.5	.5	1.5
HB-1	WALL HYDRANT ANTI-FREEZE	X	X	3/4"	X	-	1	2.5	2.5	NA	NA
HB-2	WALL FAUCET	X	X	1/2"	X	-	1	1	1	NA	NA
FD-1	FLOOR DRAIN	3"	1 1/2"	X	X	-	1	NA	NA	2	2
FD-2	FLOOR DRAIN (EMERGENCY)	3"	1 1/2"	X	X	-	2	NA	NA	NA	NA
WH-2	WATER HEATER (INSTANT)	X	X	3/8"c	3/8"c	3/8"c	1	NA	NA	NA	NA
								TOTAL	80	TOTAL	16.5

GENERAL PLUMBING NOTES:


- ALL PIPE (WATER, SEWER, VENT), JOINTS, AND WORK SHALL CONFORM TO 2022 CALIFORNIA PLUMBING CODE AND LOCAL CODES.
- CONTRACTOR TO CONFIRM LOCATIONS OF SEWER AND WATER TIE-INS.
- CONTRACTOR TO SOLIDLY BRACE ALL PIPING TIGHT AGAINST WALLS. FOR LONG OR COMPLICATED RUNS, SECURELY MOUNT USING UNI-STRUT, IN STRAIGHT AND UNIFORM MANNER FOR FINISHED APPEARANCE. PIPING SHOWN IS DIAGRAMMATIC ONLY AND ACTUAL DESIGN TO BE BY CONTRACTOR.
- CONTRACTOR MAY CHANGE PIPE SIZING IN FIELD TO PROVIDE ADEQUATE WATER PRESSURE TO ALL PLUMBING FIXTURES AS APPROVED BY INSPECTOR. ROMTEC BUILDINGS ARE DESIGNED TO HAVE 40-60 PSI WATER PRESSURE FOR THE PLUMBING FIXTURES. IF THE SITE HAS A PRESSURE OTHER THAN THIS, IT IS THE OWNER'S RESPONSIBILITY TO PROVIDE THE PRESSURE REDUCER OR BOOSTER PUMP NECESSARY.
- CONTRACTOR TO DETERMINE AND PROVIDE MEANS FOR GRAVITY DRAINING ALL PLUMBING FIXTURES TO SEPTIC OR SANITARY SEWER SYSTEM. INSTALLER TO PROVIDE A CLEAN-OUT BENEATH ALL SINKS AND LAVATORY AS REQUIRED BY CODE.
- CONTRACTOR TO DETERMINE AND PROVIDE MEANS FOR SUPPLYING WATER TO ALL PLUMBING FIXTURES AND INSTALL WATER SERVICE SHUTOFF VALVE; TYPICALLY LOCATED WITHIN THE MECHANICAL ROOM.
- IF THE SITE REQUIRES AN ACCESSIBLE BACK FLOW PREVENTER AND/OR PRESSURE REDUCER OR BOOSTER PUMP IT IS THE OWNER'S RESPONSIBILITY TO PROVIDE.
- WHEN INCLUDED, HOT WATER TANKS REQUIRE A TEMPERATURE AND PRESSURE RELIEF VALVE AND A DRAIN LINE TO THE EXTERIOR OF THE BUILDING PER 2022 CPC SECTIONS 608.4 & 608.5. CONTRACTOR TO PROVIDE = FURNISH & INSTALL TWO STRAPS TO THE NEAREST WALL, ONE STRAP AT TOP 1/3 OF TANK AND ONE STRAP AT BOTTOM 1/3 OF TANK, IN COMPLIANCE WITH 2022 CPC SECTION 507.2.
- PLUMBING FIXTURES SHALL BE CERTIFIED BY THE CALIFORNIA ENERGY COMMISSION, SHALL COMPLY WITH 2022 CALIFORNIA PLUMBING CODE (CPC) SECTIONS 401.3 AND 403, AND SHALL COMPLY WITH 2022 CALIFORNIA GREEN BUILDING STANDARDS CODE (CGBSC) SECTION 5.303.3. FLUSHOMETERS ASSOCIATED WITH TOILETS SHALL USE NO MORE THAN 1.28 GALLONS PER FLUSH. FLUSHOMETERS ASSOCIATED WITH URINALS USE NO MORE THAN 0.5 GALLONS PER FLUSH. BOTH FLUSHOMETERS ABOVE SHALL MEET PERFORMANCE STANDARDS BY ANSI A112.19.2 H&S CODE, SECTION 17921.3(B). SINK FAUCET SHALL USE NO MORE THAN 1.8 GPM MEASURED AT 60 PSI.
- WHEN FIXTURES REQUIRE WALL CARRIERS, THEY SHALL BE SUPPLIED BY CONTRACTOR.
- NON-REMOVABLE BACKFLOW PREVENTION DEVICE SHALL BE INSTALLED ON ALL HOSE BIBBS AND POTABLE WATER OUTLETS WITH HOSE ATTACHMENTS. CPC 603.5.7.
- UNLESS SPECIFIED IN THE ROMTEC SUBMITTAL, ROMTEC DOES NOT SUPPLY INSULATION OR "FREEZE PROTECTION" FOR PLUMBING. "THE OWNER MAY NEED TO WINTERIZE THEIR BUILDING."

SIoux CHIEF
(3" W/6" STRAINER)

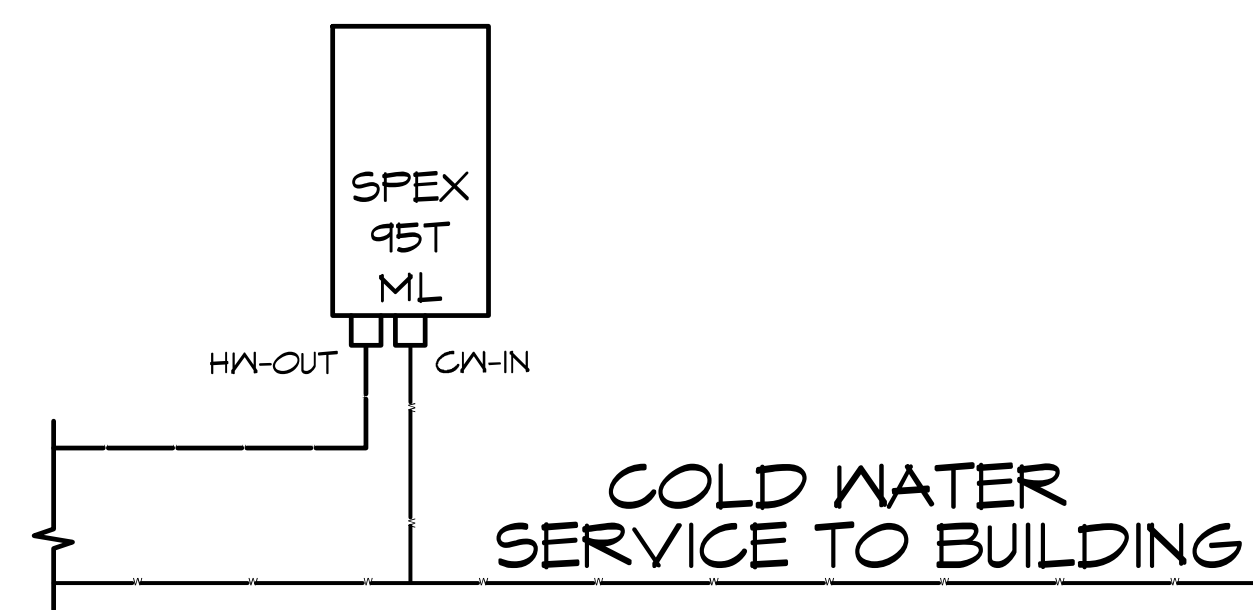

1 WATER HEATER DETAIL
3/4" = 1'-0"

*REFER TO THE FIXTURE CUT SHEET FOR ROUGH-IN MEASUREMENTS

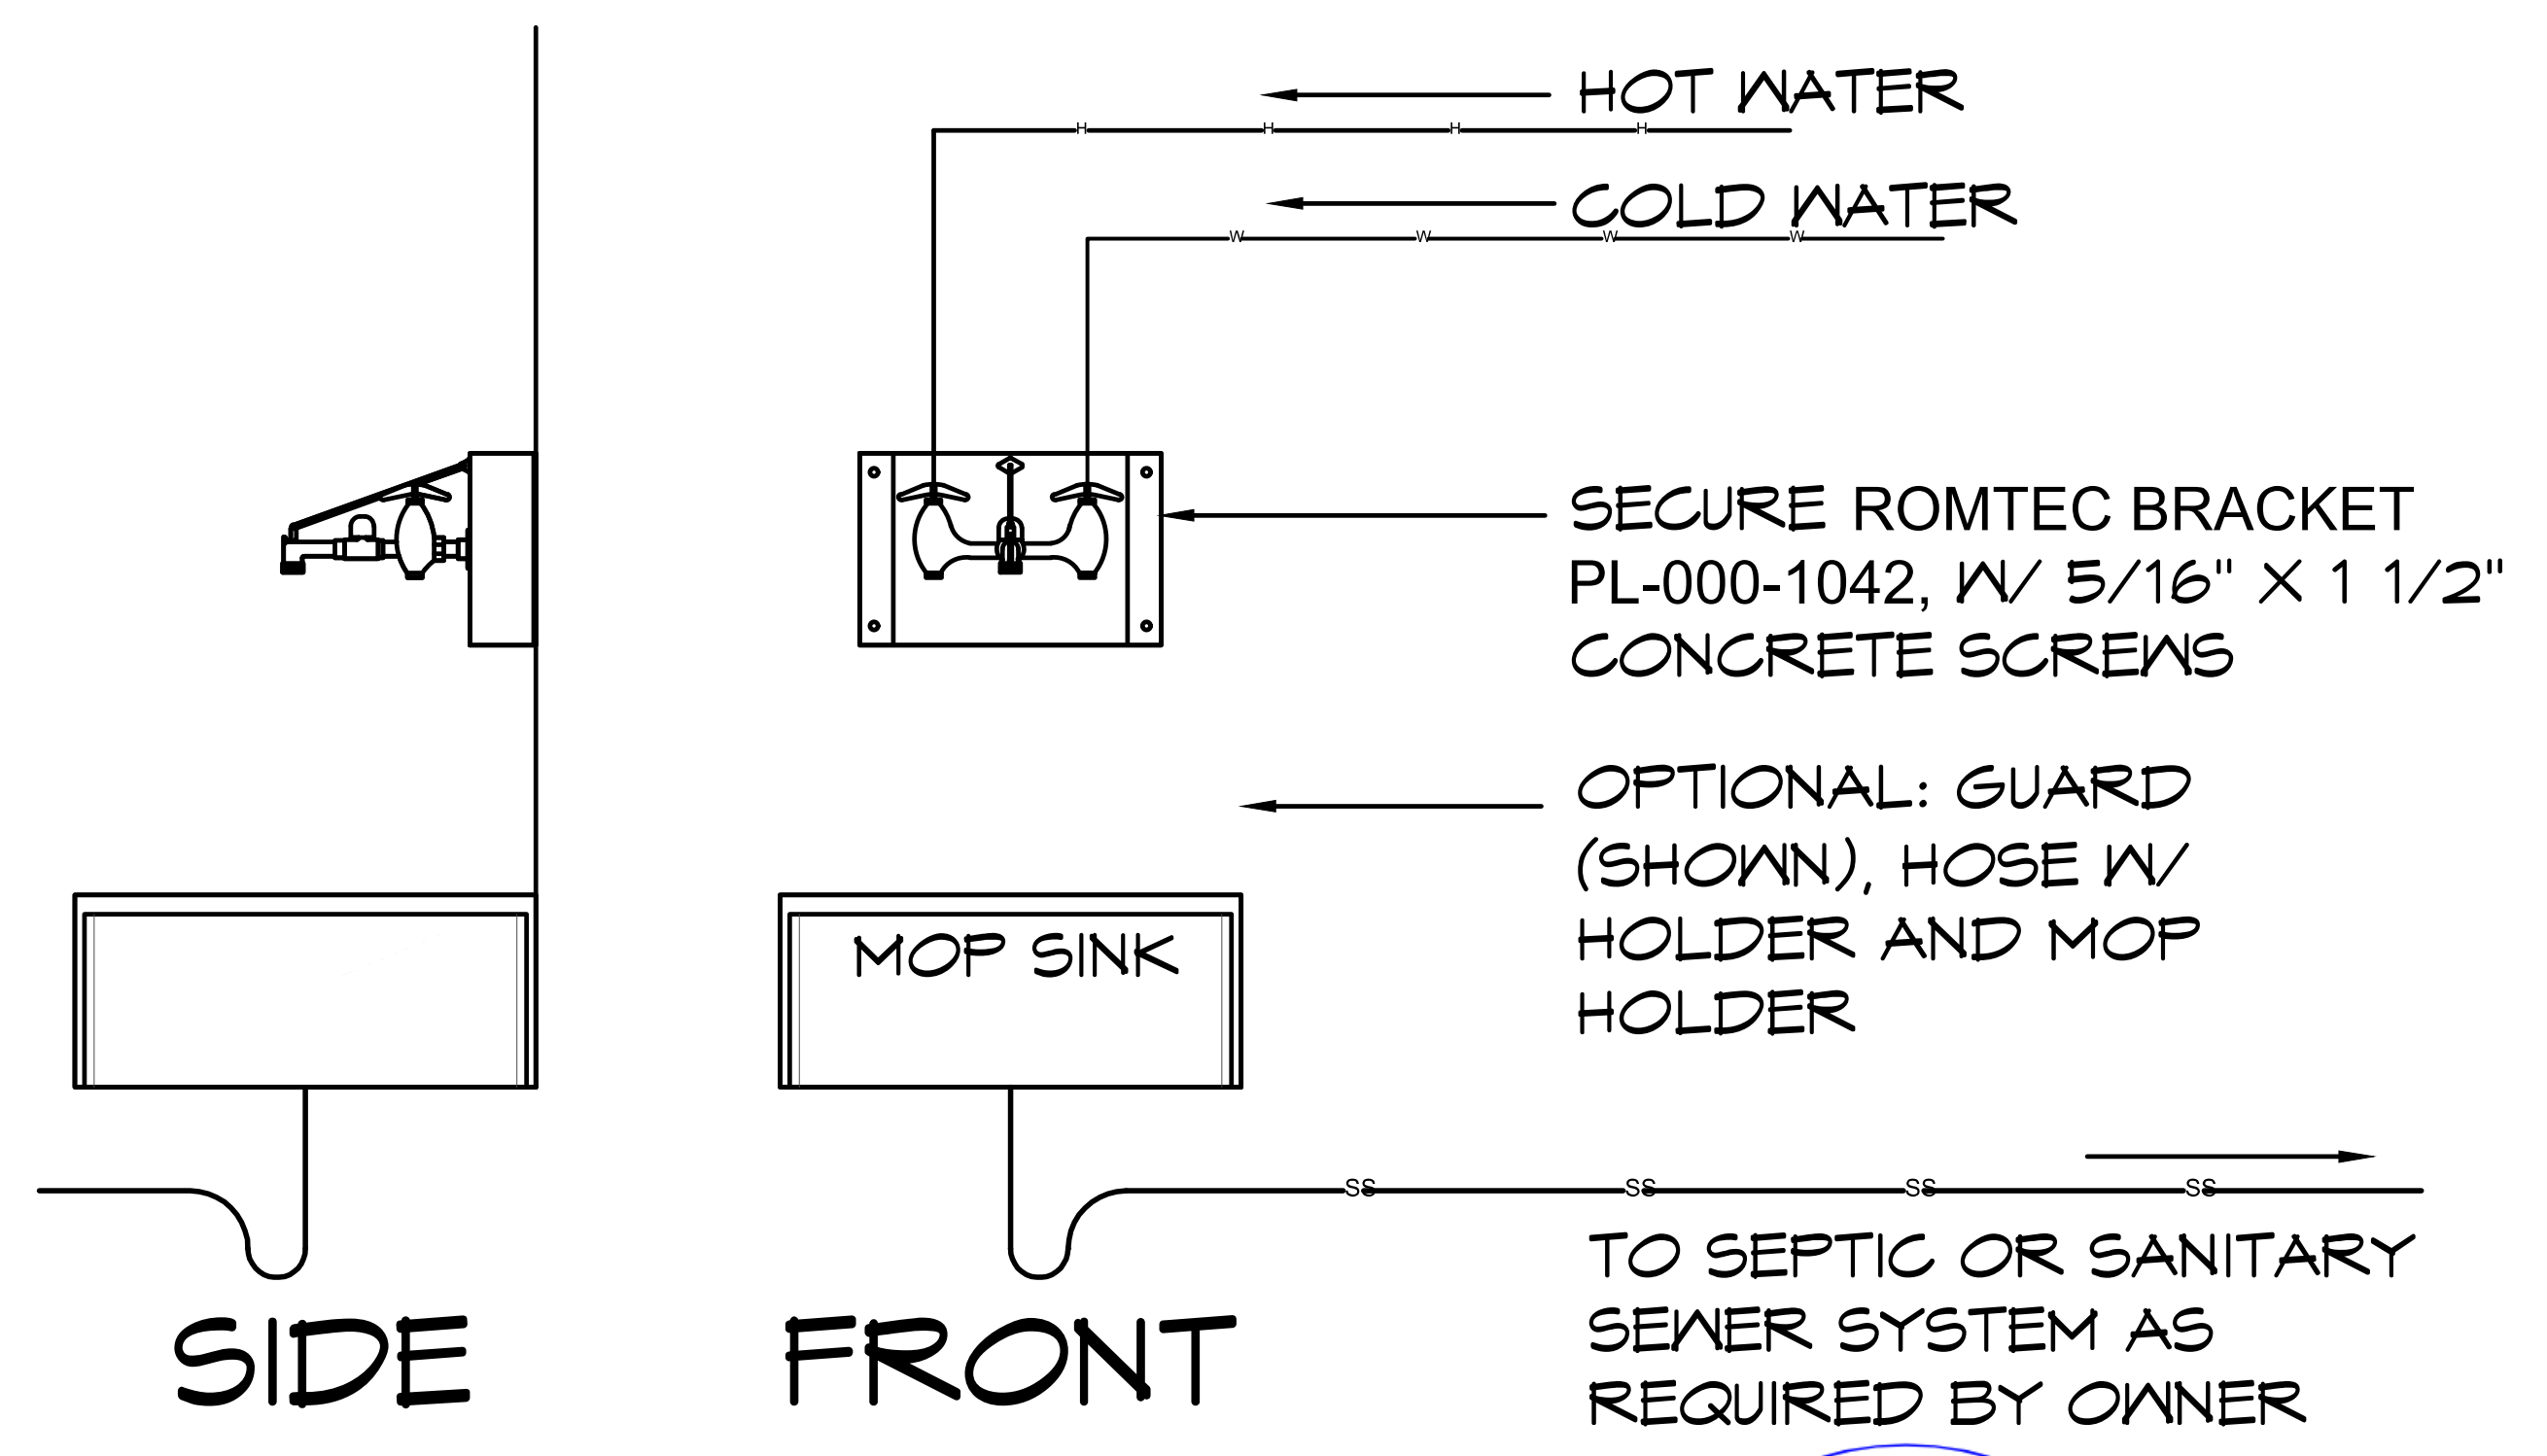

1 24" x 24" MOP SINK
SCALE: 1/2" = 1'-0"



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 JOHN F. KENNEDY RR FACILITY
 SACRAMENTO, CALIFORNIA
 SHEET TITLE: PLUMBING SCHEDULE


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NOTE:
 FIXTURES ARE SYMBOLIC ONLY
 REFER TO SPECIFICATIONS AND
 PRODUCT LITERATURE FOR
 INSTALLATION DETAILS



WATER-PLUMBING LEGEND

- W — COLD WATER
- MW — MIXED WATER

SEWER-PLUMBING LEGEND

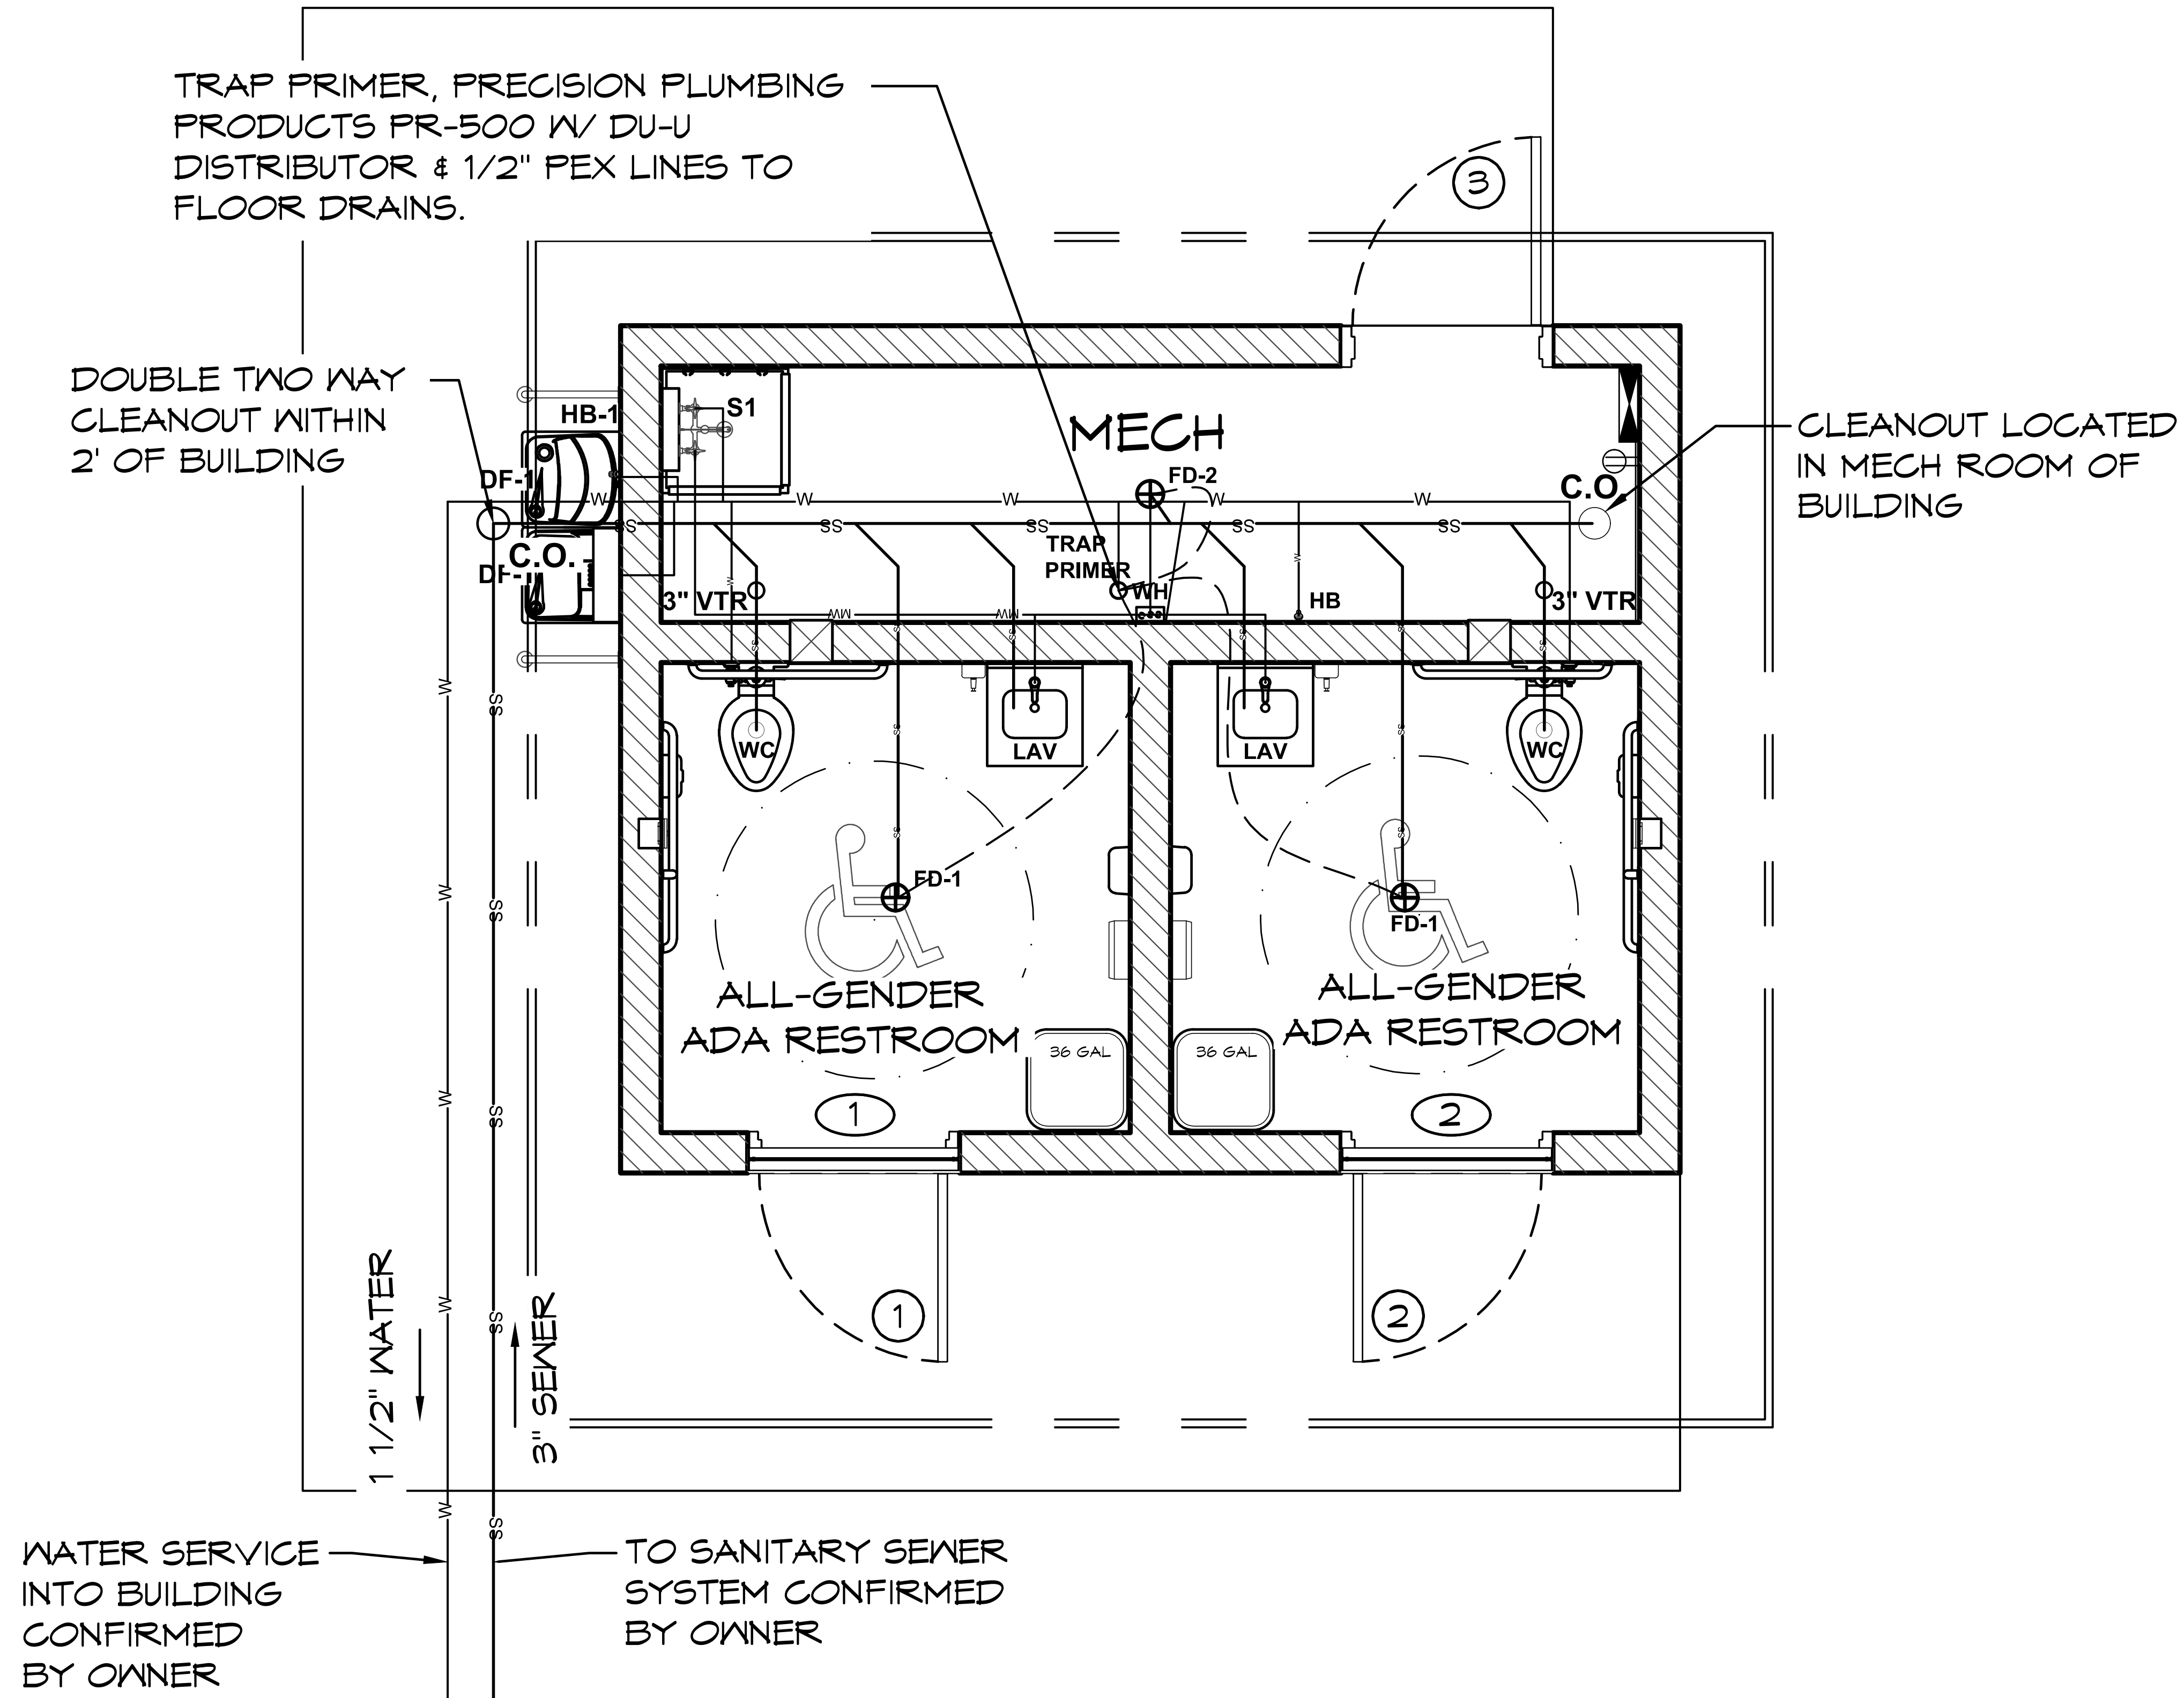- SS — SANITARY SEWER
- V — VENT LINE

*REFER TO THE FIXTURE CUT SHEET
 FOR ROUGH-IN MEASUREMENTS

CPC NOTES

- NOTES:
1. WATER PIPE SIZE AND PRESSURE REQUIREMENTS MUST BE CONFIRMED BY PLUMBING CONTRACTOR BASED ON LOCAL SUPPLY.
 2. FIXTURE & FIXTURE CONNECTIONS ARE SYMBOLIC IN NATURE ONLY. REFER TO MANUFACTURER LITERATURE FOR EXACT FIXTURE SPECIFICATIONS.
 3. ALL SANITARY, DRAINAGE, WASTE, AND VENT LINES SCHEDULE 40 PVC OR ABS.
 4. ALL WATER LINES SHALL BE COPPER OR PER LOCAL CODE. NO JOINTS IN OR UNDER THE SLAB.
 5. WATER PIPE SIZING IS A MINIMUM SUGGESTION. PLUMBING CONTRACTOR WILL MAKE THE FINAL DETERMINATION.
 7. ALL FLOOR SINKS AND DRAINS SHALL HAVE TRAP PRIMERS AS NOTED IN PLANS, PER CPC 1007.0

1 PLUMBING PLAN
 SCALE: 1/4" = 1'-0"
 A B C D


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 JOHN F. KENNEDY RR FACILITY
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 SHEET TITLE: PLUMBING PLAN

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GENERAL ELECTRICAL NOTES:

1. ALL WORK SHALL COMPLY WITH 2022 CALIFORNIA ELECTRICAL CODE AND LOCAL CODES.
2. OWNER TO PROVIDE TEMPORARY POWER AS REQUIRED DURING COURSE OF CONSTRUCTION.
3. ELECTRICAL SERVICE EQUIPMENT SUPPLIED BY OTHERS UNDER SEPARATE SUBMITTAL.
4. THE AIC VALUES SHOWN ON THESE ROMTEC PLANS ARE TO BE MADE CLEARLY AVAILABLE TO THE ELECTRICAL ENGINEER OF RECORD THAT WILL DESIGN THE MAIN SERVICE.
5. THE INSTALLER SHALL FURNISH & INSTALL SPECIFICATION GRADE CIRCUIT BREAKERS, WIRING, CONDUIT, SWITCHES AND GFI RECEPTACLES THROUGHOUT. INTERIOR RECEPTACLES & SWITCHES SHALL HAVE STAINLESS STEEL COVERPLATES AND EXTERIOR RECEPTACLES SHALL BE INSTALLED WITH A WEATHERPROOF IN USE COVER.
6. ELECTRICAL CONDUIT IS TO BE RUN WITHIN THE WALL WHEN POSSIBLE, EXCEPT IN THE MECHANICAL ROOM.
7. FOR MECHANICAL ROOM ALL EXPOSED CONDUIT IS TO BE SURFACE MOUNTED AND RUN TIGHT TO CEILING AS REQUIRED.
8. COORDINATE AC OUTLET HEIGHTS WITH OWNER PRIOR TO ROUGH-IN.

ELECTRICAL SCHEDULE & SYMBOL LEGEND:

QTY	SYMBOL	DESCRIPTION
1		200 AMP BREAKER PANEL
PER PLAN		HOME RUN TO BREAKER PANEL
PER PLAN		110 VAC DUPLEX RECEPTACLE, GROUND FAULT PROTECTED MOUNTED MIN OF 15" TO MAX OF 48" ABOVE THE FLOOR CONFIRM EXACT LOCATION & HEIGHT WITH OWNER OR OWNERS REPRESENTATIVE.
1		SWITCH, SINGLE POLE MOUNTED A MAX OF 48" ABOVE THE FLOOR
4		LIGHT FIXTURE, WALL MOUNT UL LISTED TO U.S. SAFETY STANDARDS FOR ALL WET LOCATIONS WALL MOUNT, LED DOWN LIGHT, LITHONIA OLLND: (9W) (.08A)
2		LIGHT FIXTURE, WALL MOUNT UL LISTED TO U.S. SAFETY STANDARDS FOR ALL WET LOCATIONS WALL MOUNT LED UP/DOWN LIGHT LITHONIA OLLNU: (14W) (.12A)
1		48" LED VAPOR TIGHT CEILING/WALL MOUNT LIGHT LITHONIA CSVT L48 5000LM 40K 80CRI 4,298LM 40K: (35.3 W) (.2942 A)
1		PHOTO CELL, W/ WEATHER PROOF COVER
2		OCCUPANCY SENSOR WALL MOUNT ACUITY SENSOR SWITCH WVR PDT 16 WIDE VIEW SENSOR: 2 POLE (120/277,347 VAC 13 AMPS/POLE 347 VAC MUST BE SAME PHASE)
2		HAND DRYER WALL MOUNT, THINAIR TA-SB: (915W) (7.7A)
1		DRINKING FOUNTAIN W/ BOTTLE FILLER ELKAY: VRCTLDDWSK - (15W) (1.0A)
1		INSTANT WATER HEATER EEMAX, SPEX95TML: 1 GPM @ 65°F (9500W) (40A) 240V

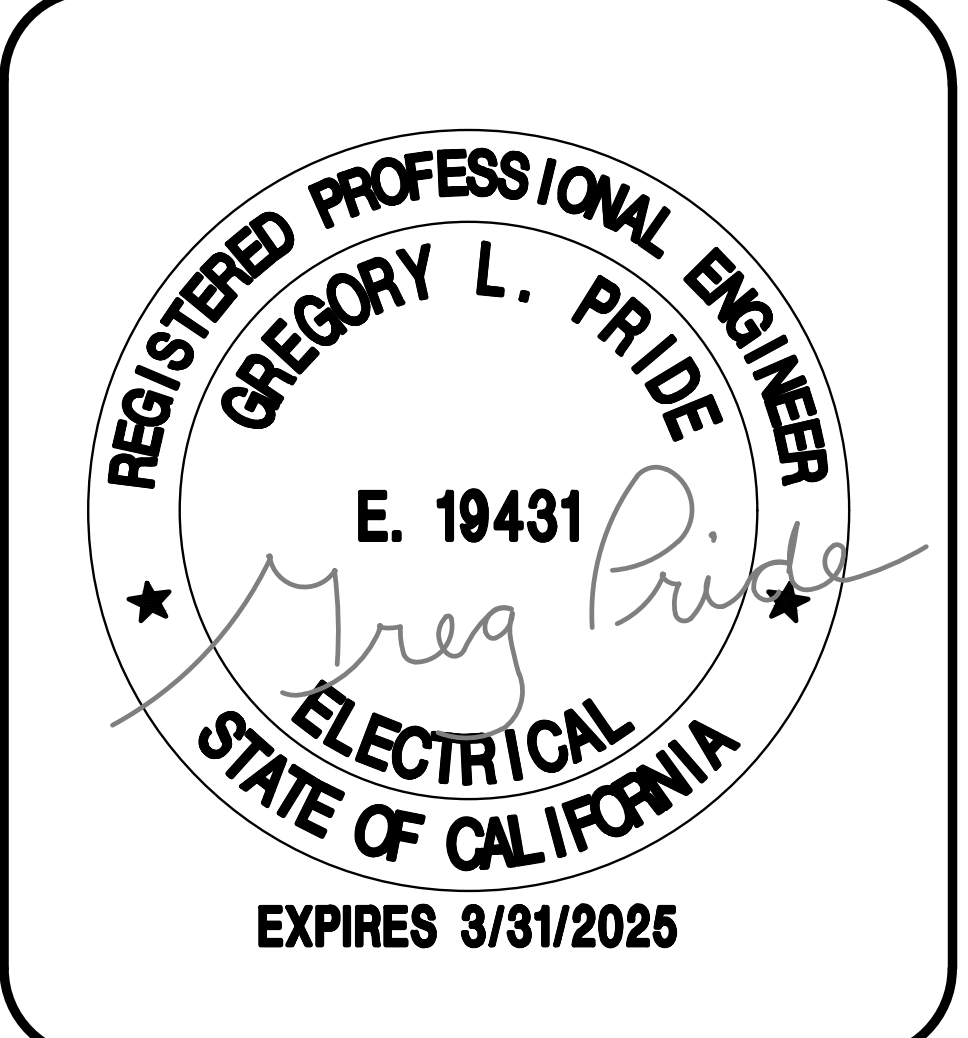3



INLINE DUCT EXHAUST FAN SYSTEM
 S&P, TD-100 - 4": (26W) (0.22A)

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PROJECT: 2022 SIERRA II COMPACT 16'-8" W/ MECH RM

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 www.ee-engineering.com

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 SACRAMENTO, CALIFORNIA

SHEET TITLE: ELECTRICAL SCHEDULE

PLAN SET# JFK01


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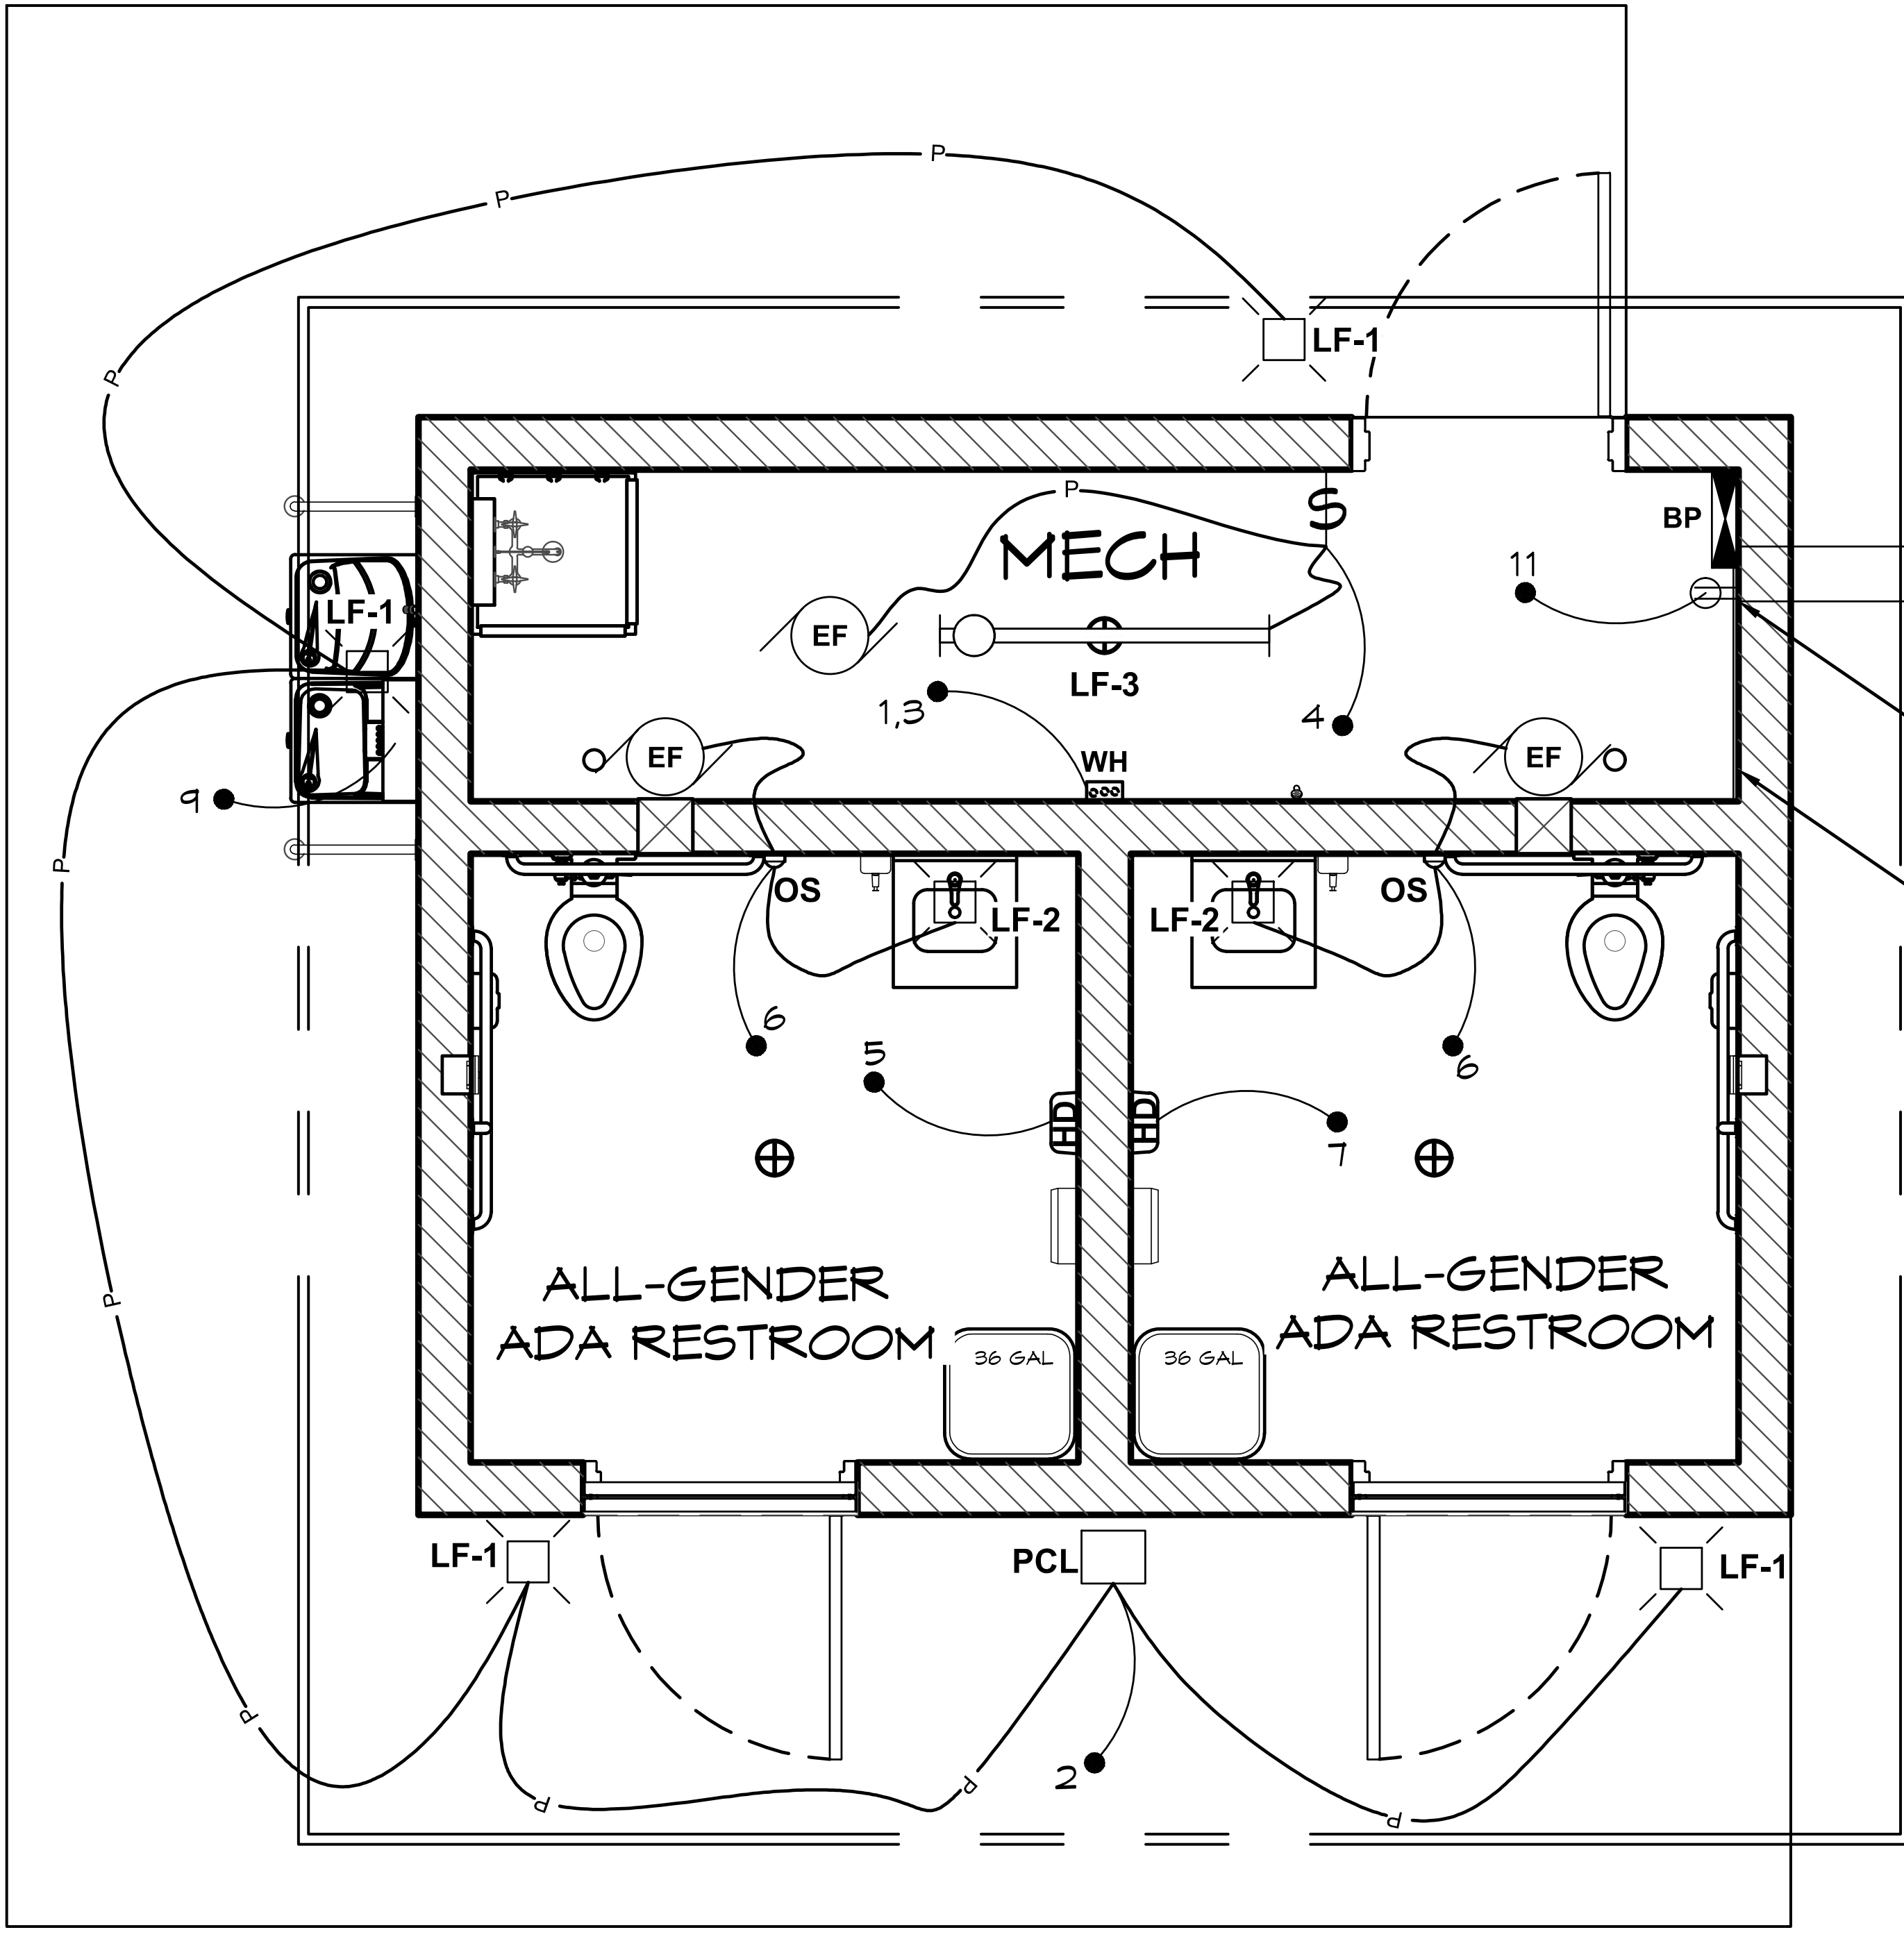
E1



NOTE:
 SEE SHEETS A1.4, A2.1, & A2.2
 FOR LOCATIONS - HEIGHTS OF
 ELECTRICAL FIXTURES.

NOTE: ELECTRICAL PANEL MAY BE
 RELOCATED AT THE DISCRETION OF THE
 INSTALLER, PANEL MUST MAINTAIN ALL
 APPLICABLE CODE CLEARANCES.


ROMTEC HAS DESIGNED THIS ELECTRICAL SYSTEM
 TO MEET THE NEEDS OF THIS SPECIFIC FACILITY.
 SITE DESIGN AND ENGINEERING BY OTHERS.
 OWNER IS RESPONSIBLE TO PROVIDE ALL SERVICE
 AND/OR UTILITY ENTRANCE DESIGN. FIELD VERIFY
 THAT SERVICE CONDUCTOR SIZE IS ADEQUATE FOR
 VOLTAGE DROP. ANY ADDITIONAL POWER OR
 LIGHTING LOADS NOT SHOWN ON THESE PLANS
 SHALL BE ENGINEERED BY OTHERS.

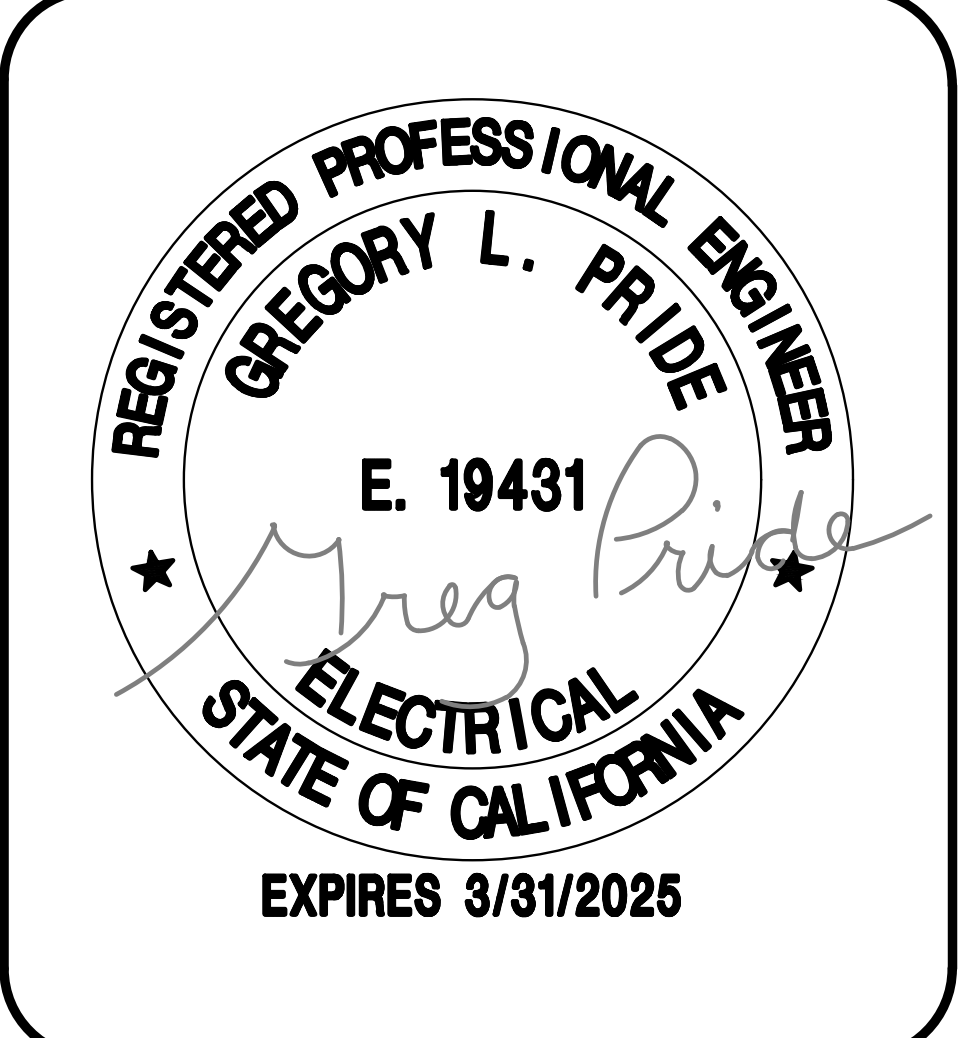

- 2" PVC CONDUIT - FOR INCOMING POWER TO RESTROOM, STUB CONDUIT 5' FROM WALL
- (2) 1 1/4" PVC CONDUITS - FOR OUTGOING POWER TO SECURITY LIGHTS, STUB CONDUITS 5' FROM WALL
- PROVIDE (2) 20A/1P & (1) 30A/1P FOR SECURITY LIGHTS
- 3' x 5' x 3/4" PLYWOOD FOR SECURITY LIGHTING CONTROLLER

NOTE: PROVIDE WP/GFCI PROTECTION FOR ANY OUTLETS SUBJECT TO WEATHER OR MOISTURE.

1 ELECTRICAL PLAN
 SCALE: 1/4" = 1'-0"

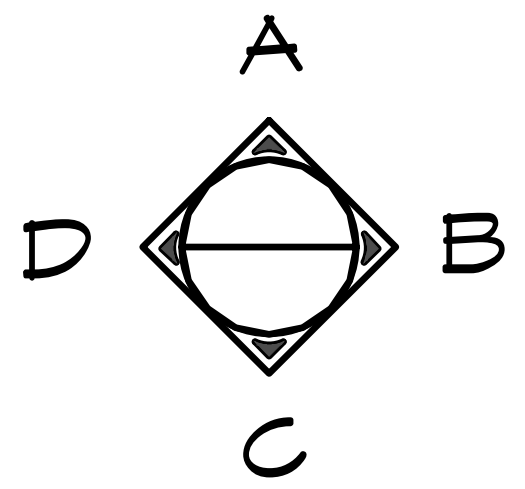

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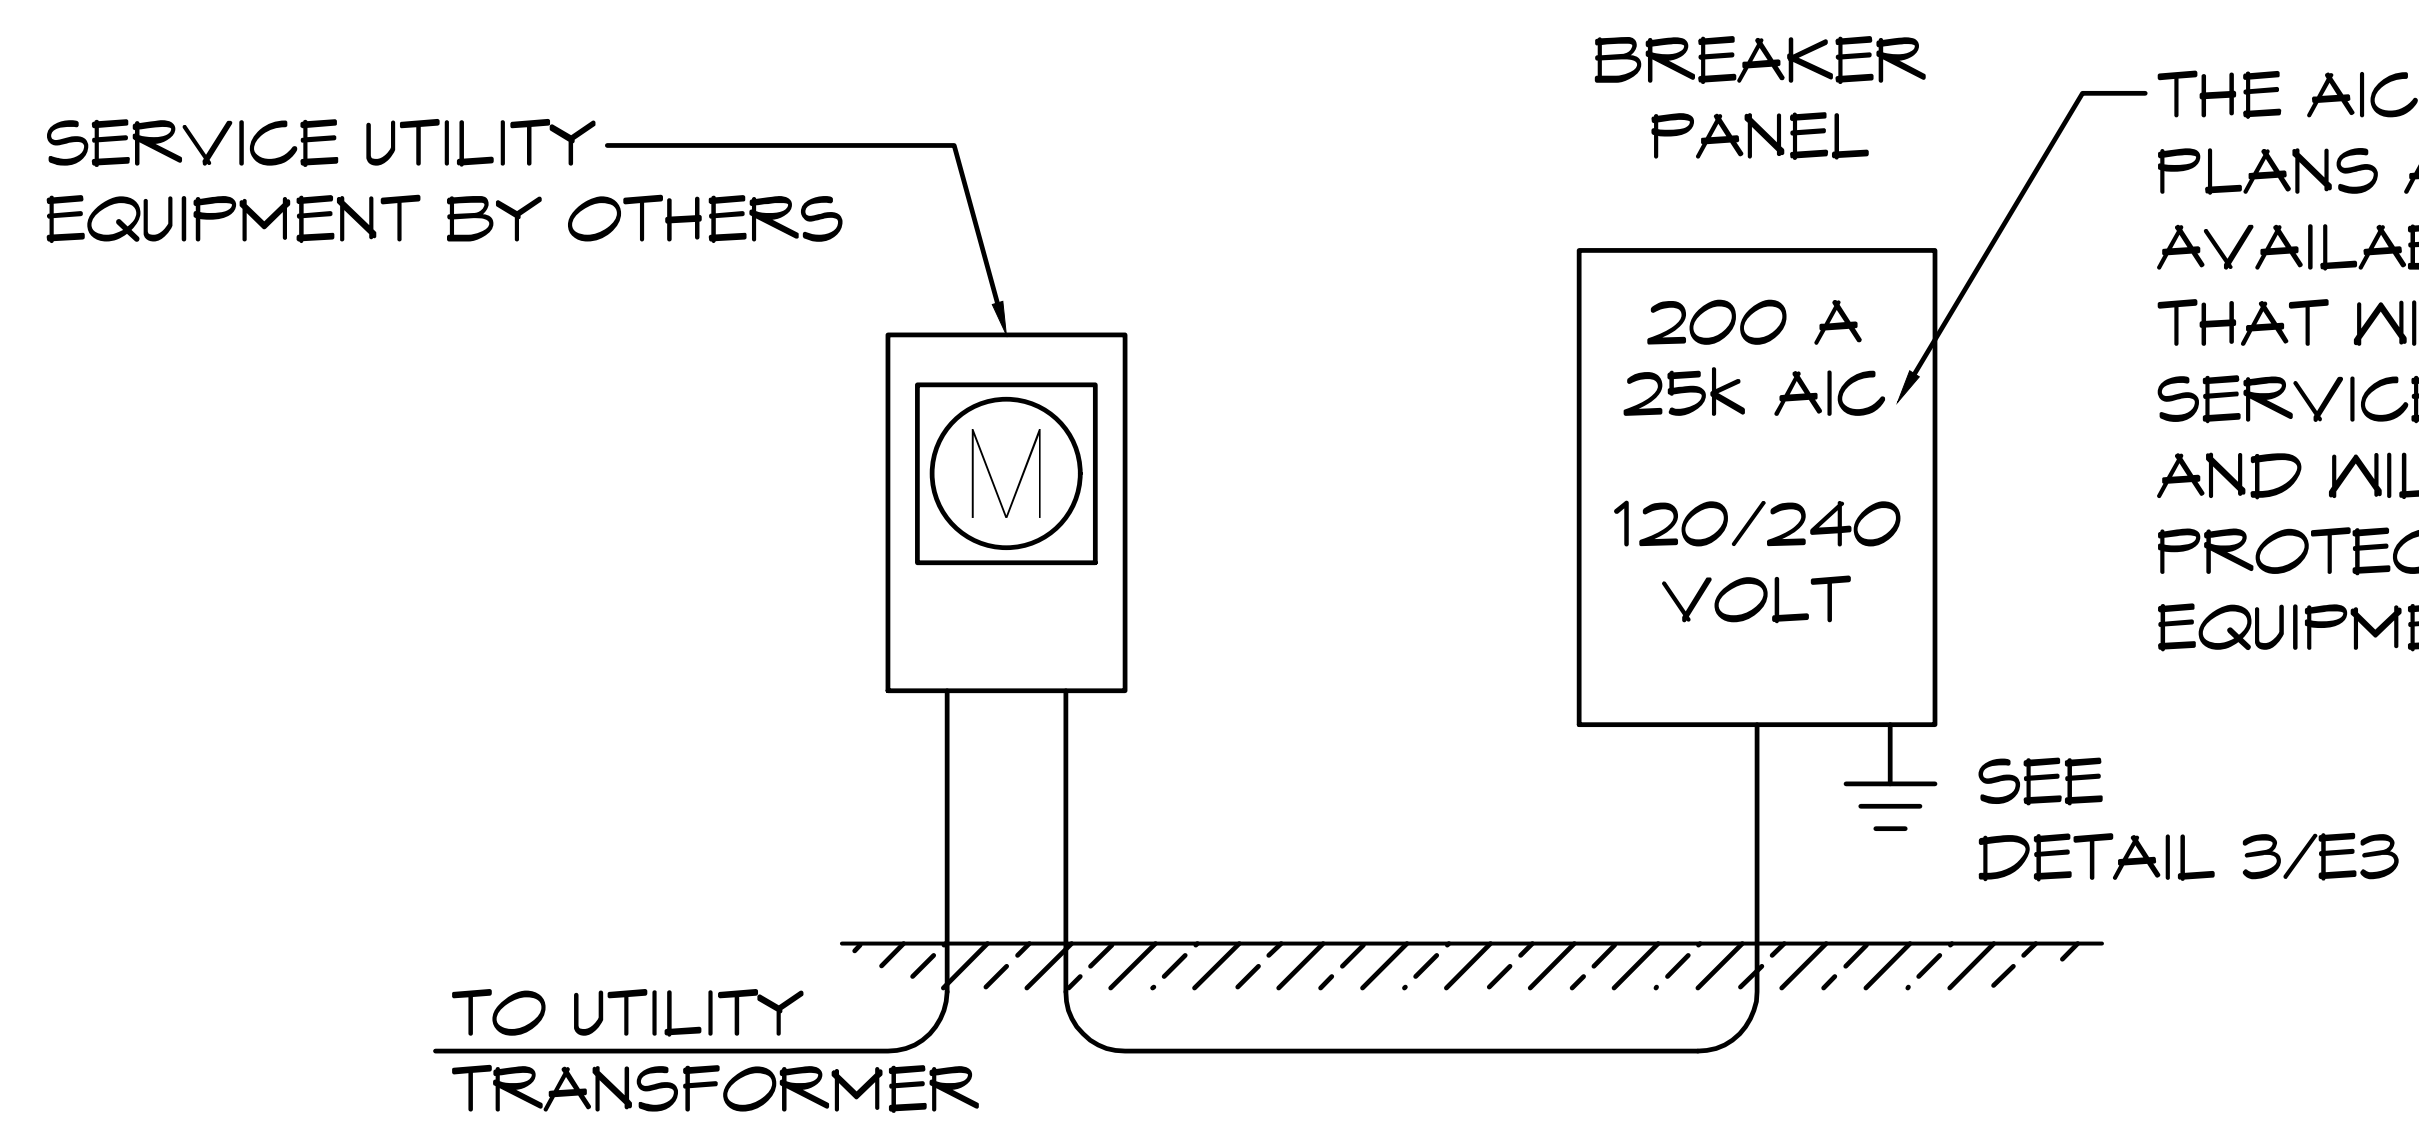
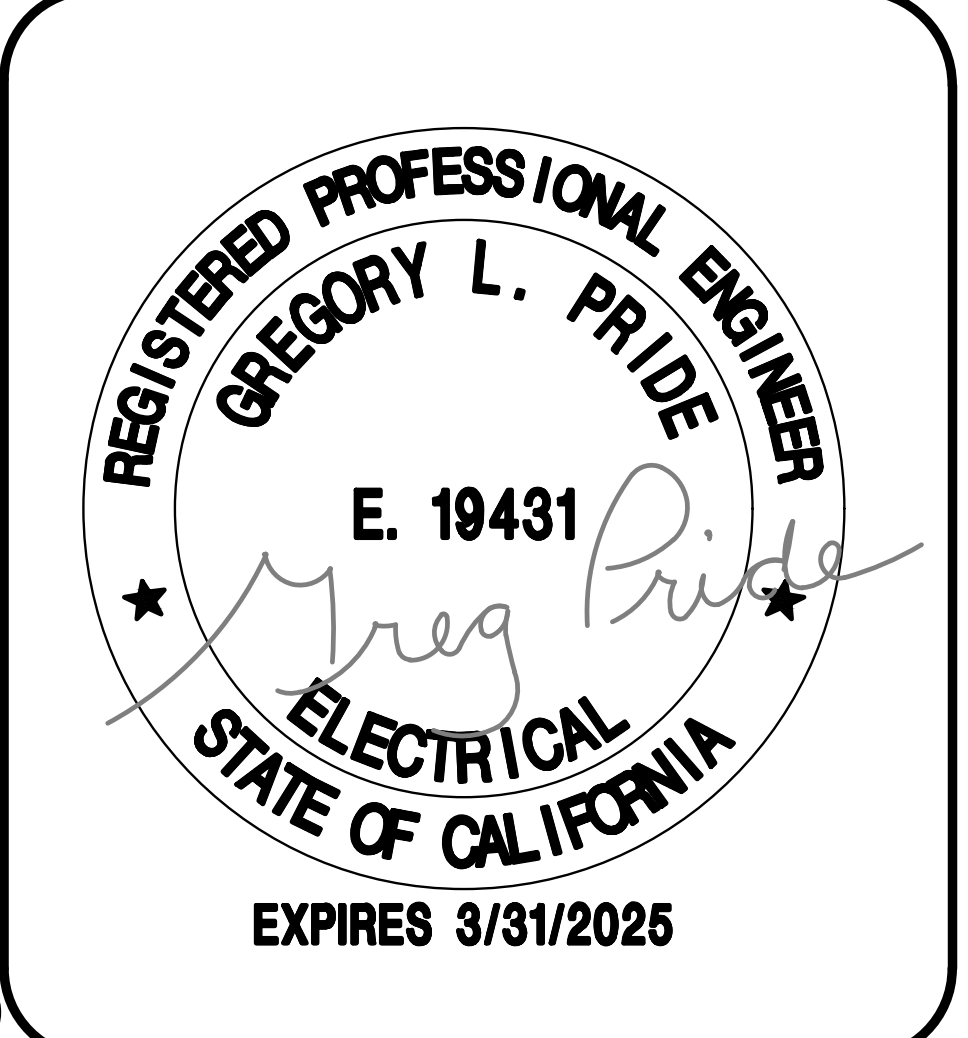
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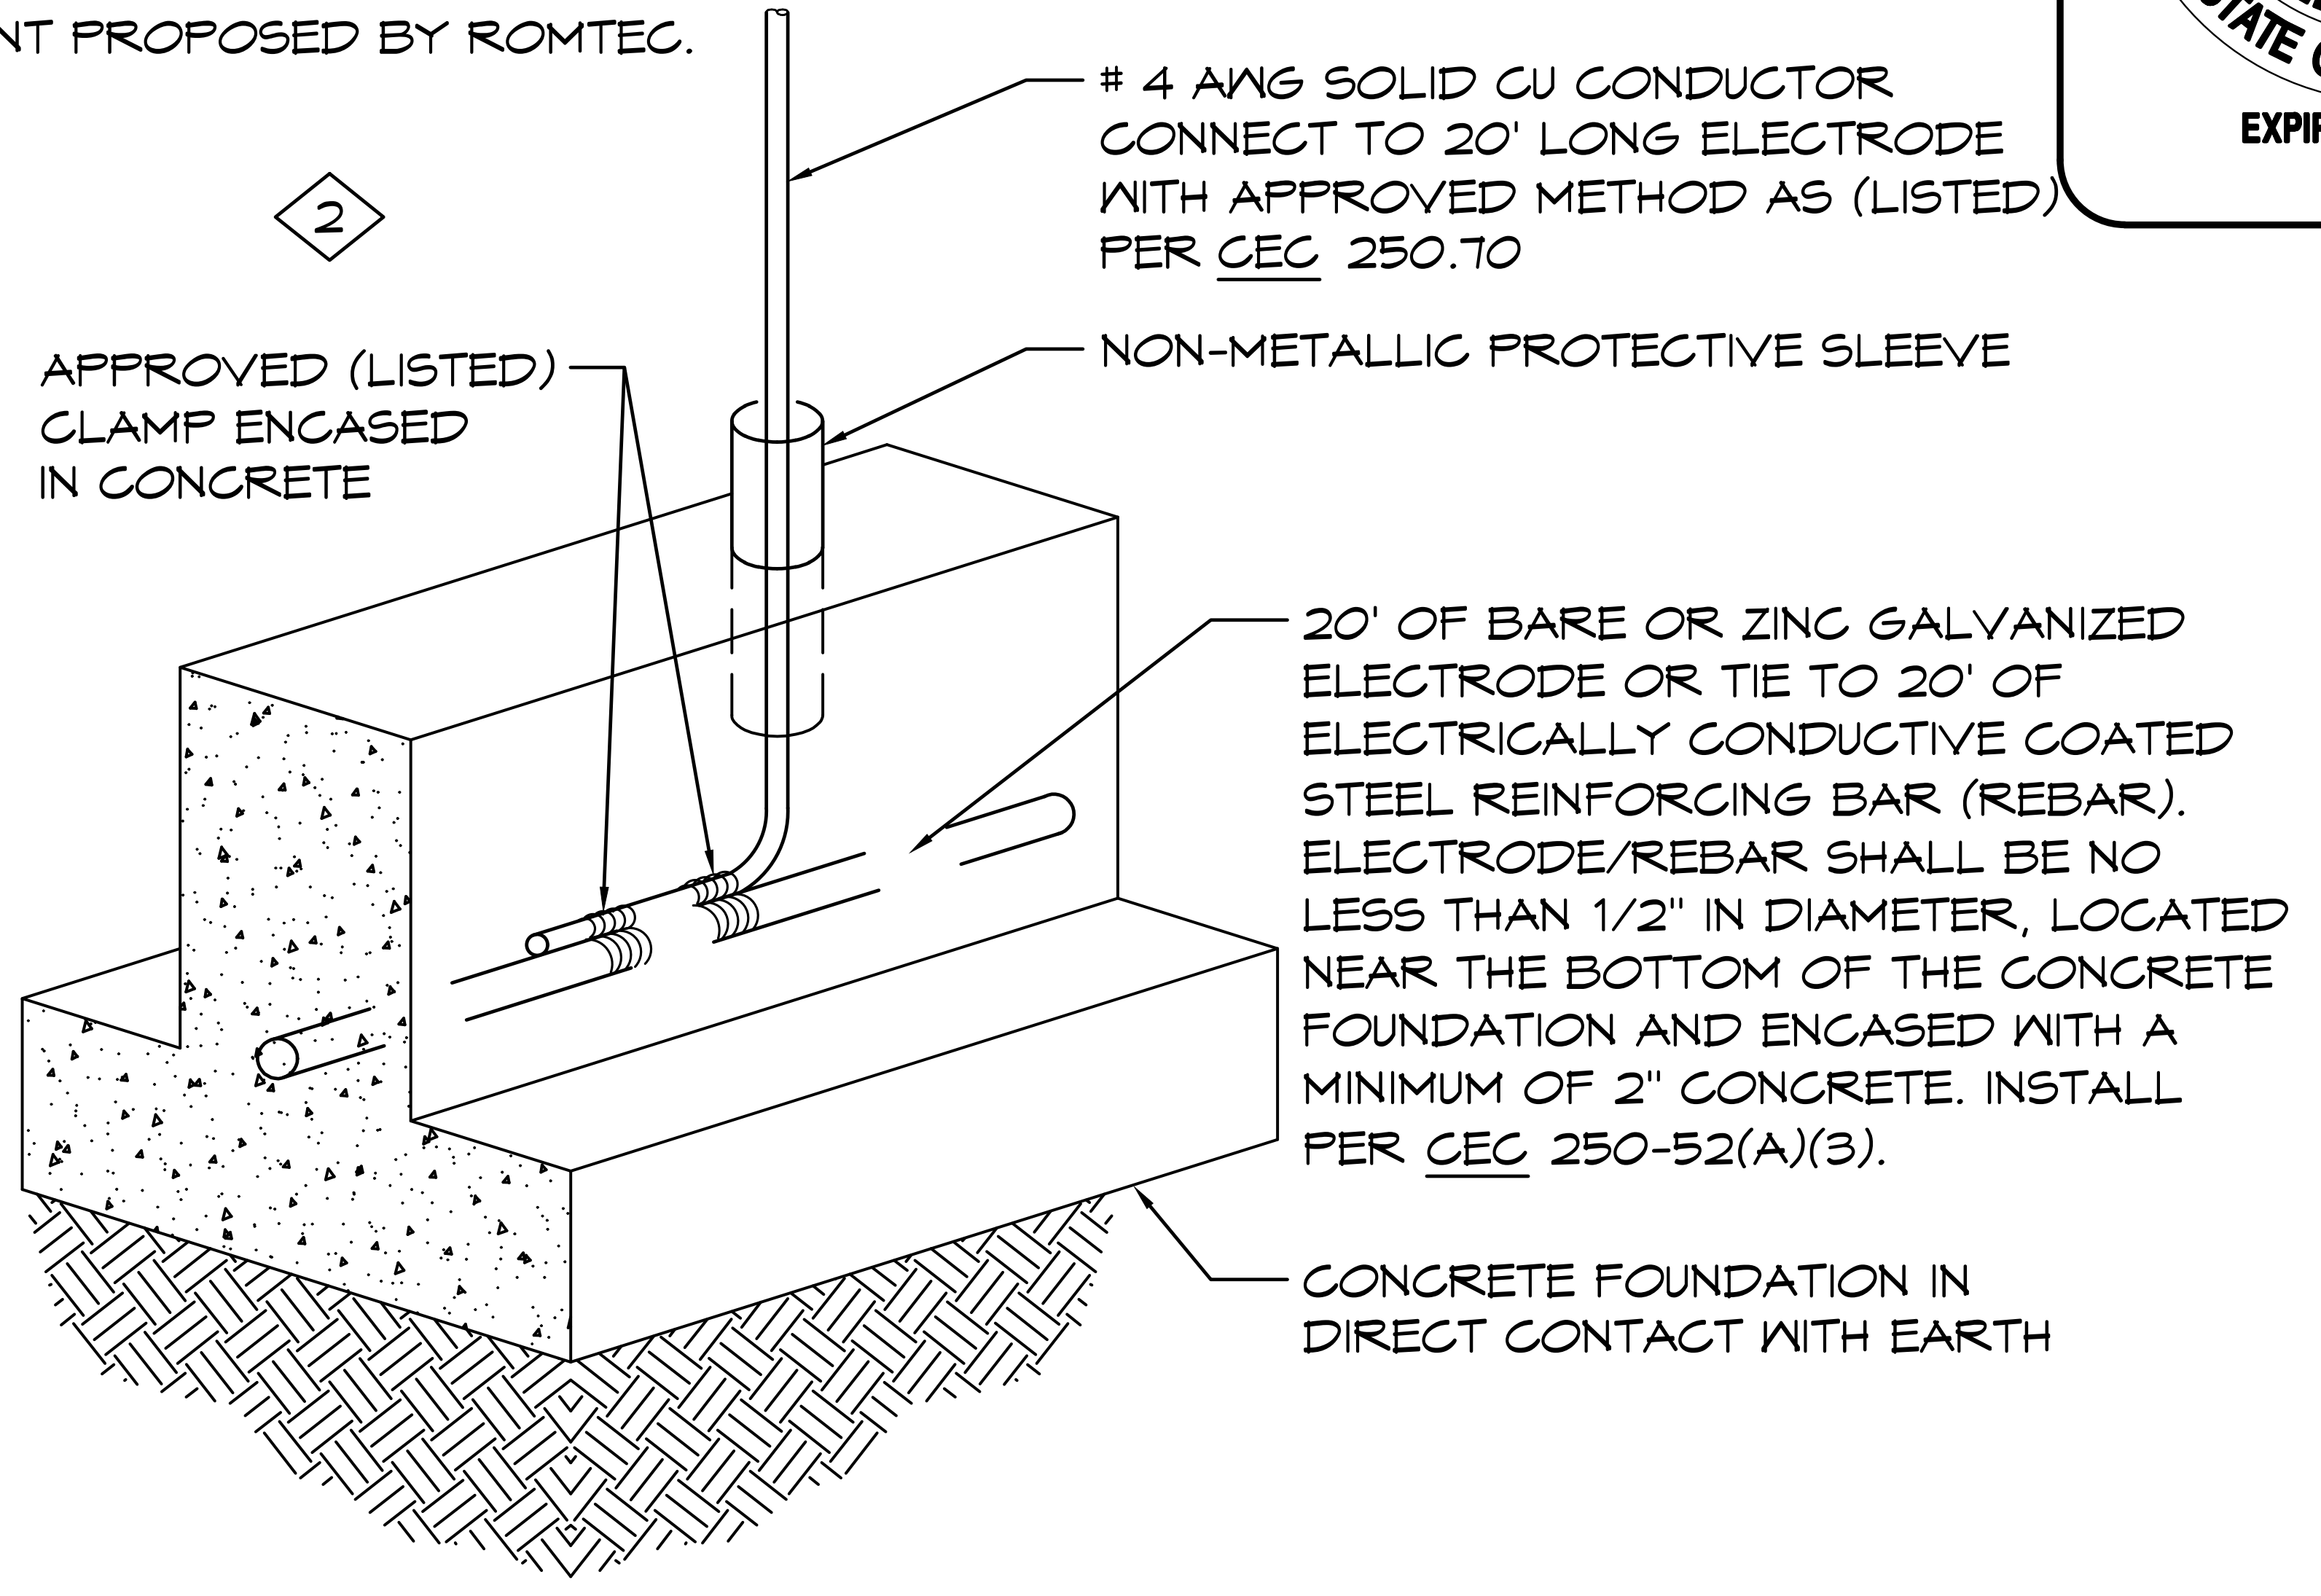
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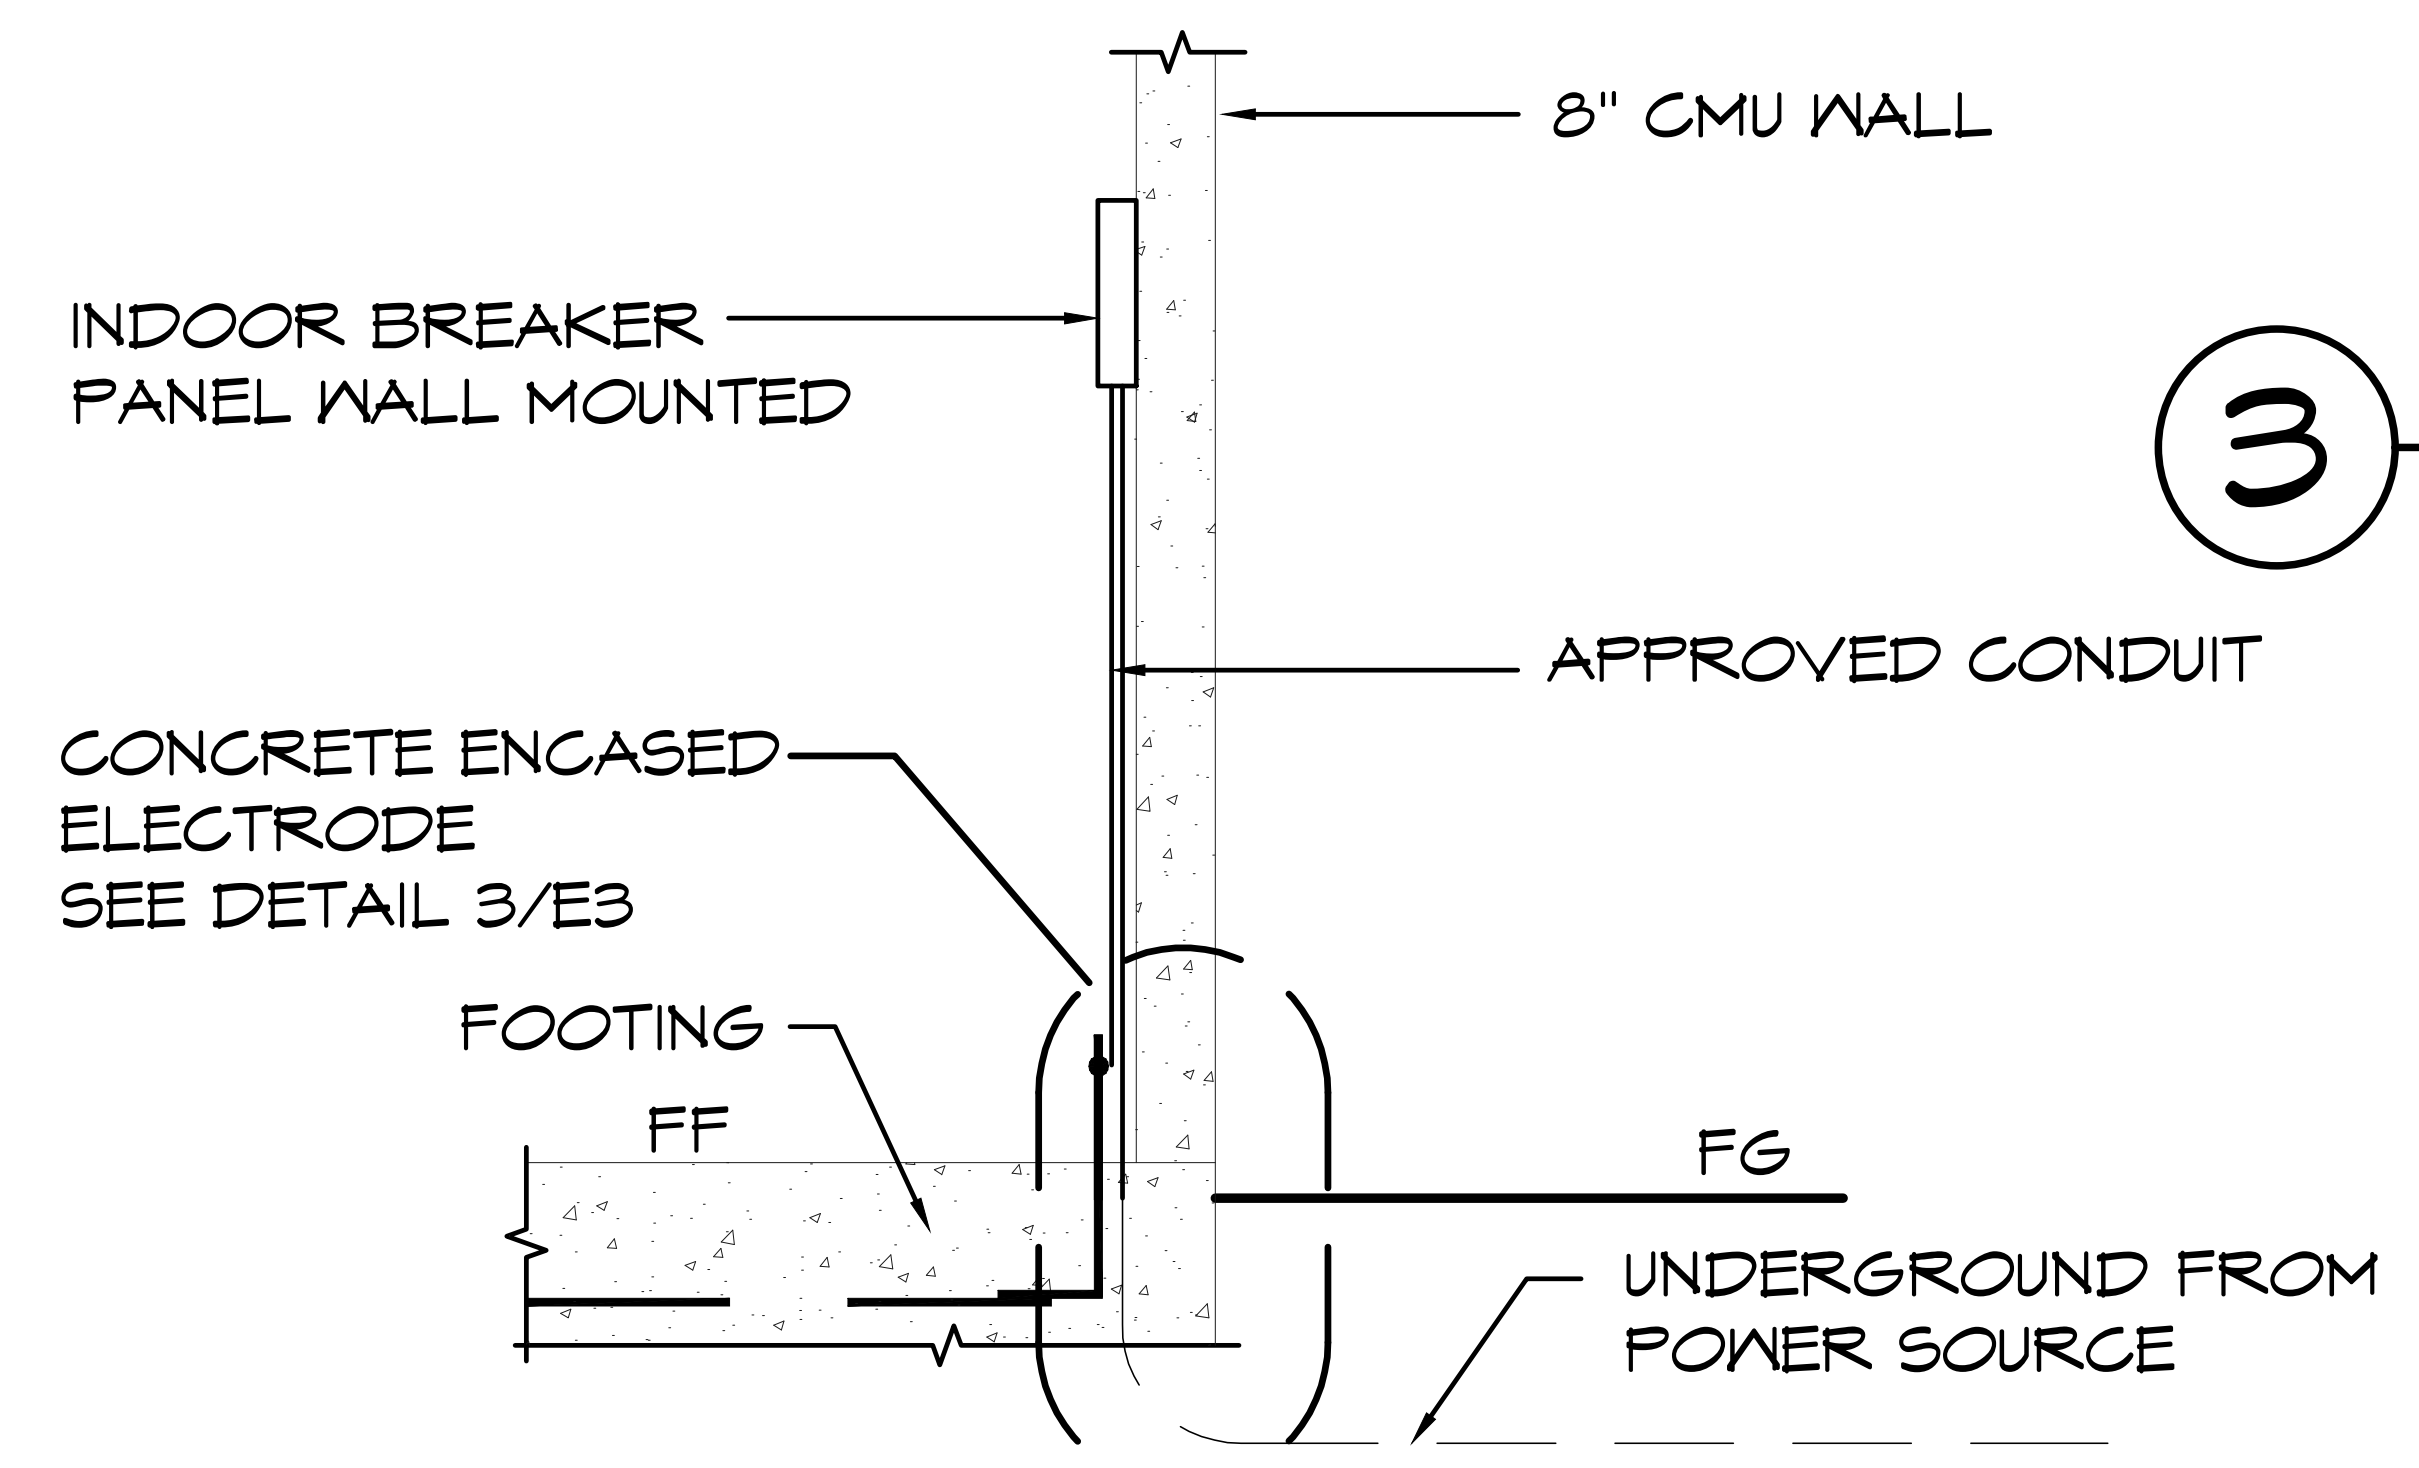


THE AIC VALUES SHOWN ON THESE ROMTEC PLANS ARE TO BE MADE CLEARLY AVAILABLE TO THE ELECTRICAL ENGINEER THAT WILL DESIGN THE ELECTRICAL SERVICE. THIS INFORMATION IS IMPORTANT AND WILL HELP TO ENSURE THE NECESSARY PROTECTION OF THE ELECTRICAL EQUIPMENT PROPOSED BY ROMTEC.

1 ONE-LINE DIAGRAM
 SCALE: NONE




3 CONCRETE ENCASED SERVICE GROUND
 SCALE: NONE



2 RISER DIAGRAM
 SCALE: NONE

"CEC ARTICLE 250 OR LOCAL CODES MAY REQUIRE OR ALLOW ADDITIONAL GROUNDING"

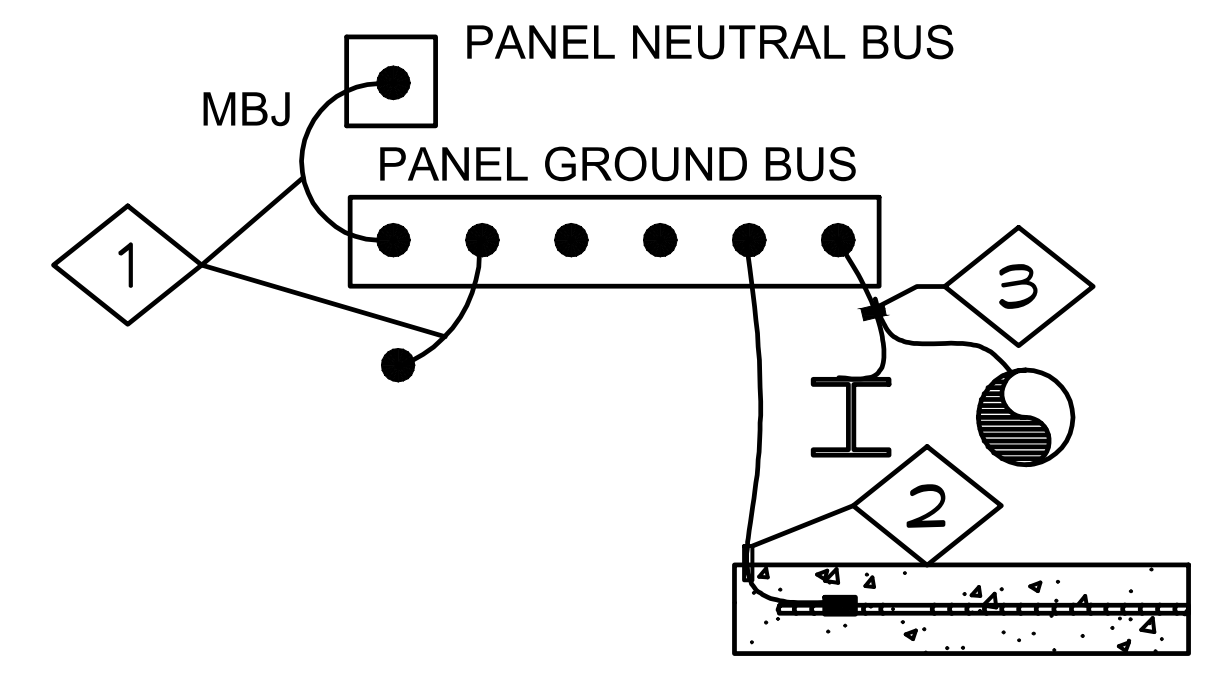

4 GROUNDING/BONDING DETAIL
 SCALE: NONE

KEYED NOTES


- 1 #4 CU MAIN BONDING JUMPER AND EQUIPMENT BONDING JUMPER PER CEC 250.28(D), 250.102(C) AND TABLE 250.66. DO NOT BOND THE NEUTRAL TO THE GROUND BUS IF THIS IS NOT A SERVICE ENTRANCE
- 2 #4 CU TO CONCRETE ENCASED ELECTRODE PER CEC 250.52(A)(3), 250.66(B) AND 250.70
- 3 WHERE REQUIRED, BOND PIPING SYSTEMS AND EXPOSED STRUCTURAL STEEL PER CEC 250.104

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BREAKER PANEL																	25k AIC RATING			
200 AMP		MAIN BREAKER		120 / 240 VOLTS											1-PHASE, 3-WIRE					
FEEDER SIZE:		ALUM: 3 #250 PH, #4 GRD, 2" C											SURFACE MOUNTED							
ELECTRICAL WIRING:		GROUNDED & BOND PER - CEC											USE XHHW-2 CU CONDUCTORS							
LOAD DISTRIBUTION		LTG	REC	MOTOR	DATA	HEAT	MISC	PH-A	PH-B	= TOTAL	AMPS	WITH SPARE		25%						
CONNECTED VA		4978	195	0	0	11330	0	6996	9506	= 16503	79	20628		99						
DIVERSITY FACTOR		125%	100%	100%	100%	100%	100%	=												
DIVERSIFIED VA		6222	195	0	0	11330	0	7326	10422	= 17747	87	22184		108						
PL	T	LOAD	VA	HP	PHW	GND	CON	BKR		PH		BKR	CON	GND	PHW	HP	VA	LOAD	T	PL
1	H	WATER HEATER	4750		8	10	3/4	50	2	A	1	20	1/2	12	12		36	LTS: EXTERIOR	L	2
3	H		4750							B	1	20	1/2	12	12		61	LTS: MECH	L	4
5	H	HAND DRYER	915		12	12	1/2	20	1	A	1	20	1/2	12	12		80	LTS: RESTROOMS	L	6
7	H	HAND DRYER	915		12	12	1/2	20	1	B	1	20	1/2	12	12		1200	SECURITY LIGHTS	L	8
9	R	DRINKING FOUNTAIN	15		12	12	1/2	20	1	A	1	20	1/2	12	12		1200	SECURITY LIGHTS	L	10
11	R	RECEPTACLE	180		12	12	1/2	20	1	B	1	30	1/2	10	10		2400	SECURITY LIGHTS	L	12
13										A										14
15										B										16
17										A										18
19										B										20
21										A										22
23										B										24
25										A										26
27										B										28
29										A										30

PLEASE NOTE THAT THE VALUES FOR THE SECURITY LIGHTS ARE AN ESTIMATE. SEE PROJECT ELECTRICAL ENGINEERING PLANS FOR FINAL LOADS.

1 ELECTRICAL PANEL SCHEDULE
 SCALE: NONE

ROMTEC HAS DESIGNED THIS ELECTRICAL SYSTEM TO MEET THE NEEDS OF THIS SPECIFIC FACILITY. SITE DESIGN AND ENGINEERING BY OTHERS. OWNER IS RESPONSIBLE TO PROVIDE ALL SERVICE AND/OR UTILITY ENTRANCE DESIGN. FIELD VERIFY THAT SERVICE CONDUCTOR SIZE IS ADEQUATE FOR VOLTAGE DROP. ANY ADDITIONAL POWER OR LIGHTING LOADS NOT SHOWN ON THESE PLANS SHALL BE ENGINEERED BY OTHERS.
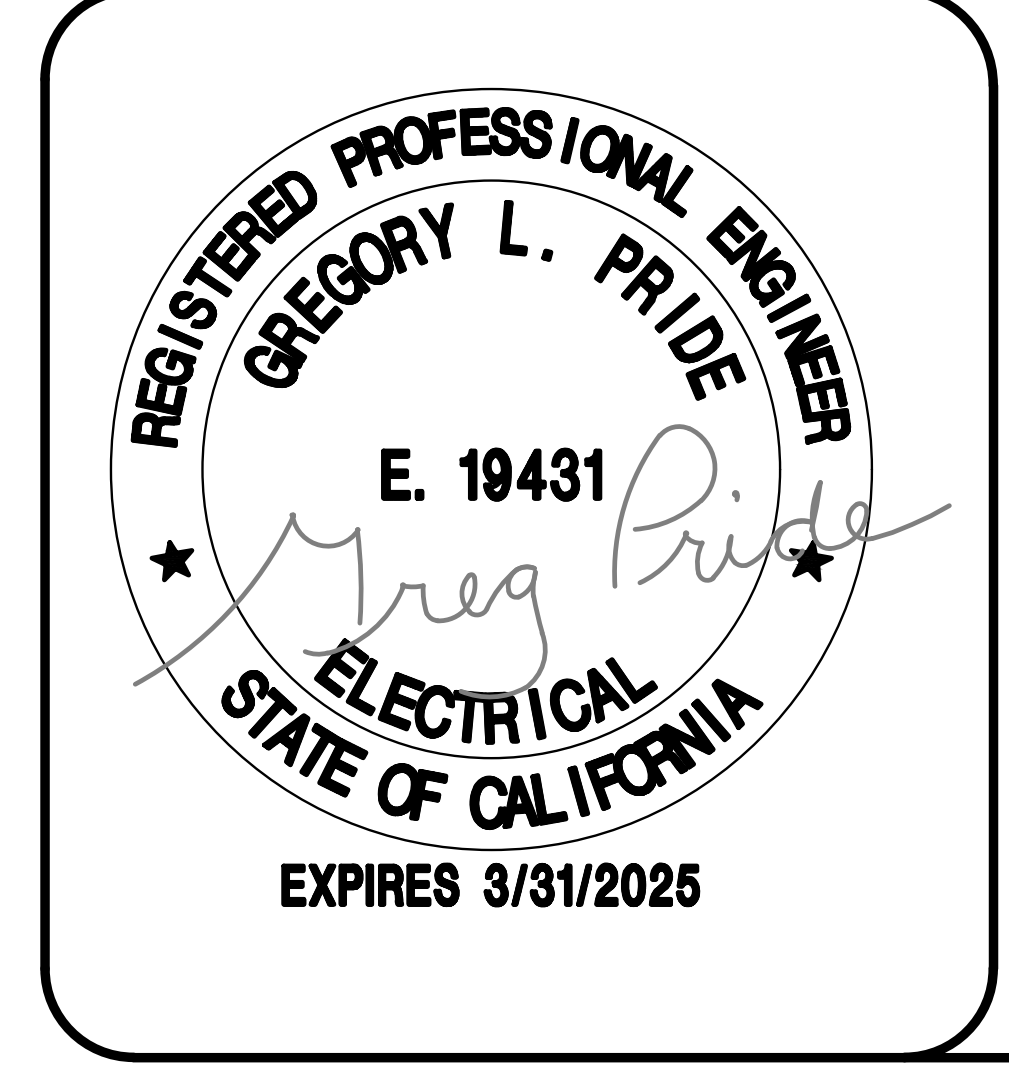
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DOUBLE 'E' ENGINEERING, LLC
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 (541) 496-3541 FAX (541) 496-0803

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JOHN F. KENNEDY RR FACILITY
 SACRAMENTO, CALIFORNIA

SHEET TITLE: ELECTRICAL PANEL SCHEDULE

PLAN SET# JFK01
 DATE: 10/16/2023

REV.	DATE:	BY
1	10-23-2023	CR
2	01-18-2024	CR
3	02-23-2024	CR
4	03-04-2024	HS

DRAWN BY: CR

SHEET NO. **E4**



BUILDING ENERGY ANALYSIS REPORT

PROJECT:

2310-020 John F. Kennedy Restroom
 6715 Gloria Dr.
 Sacramento, CA 95831

Project Designer:

Double 'E' Engineering, LLC
 315 Ash Street
 Myrtle Point, OR 97458
 541-294-0587

Report Prepared by:

Matthew Weldon
 Regerfour LLC dba 5 Star Energy
 940 Merchant St.
 Redding, Ca 96002
 530-275-3350

Job Number:

2310-020

Date:

1/24/2024

The EnergyPro computer program has been used to perform the calculations summarized in this compliance report. This program has approval and is authorized by the California Energy Commission for use with both the Residential and Nonresidential 2022 Building Energy Efficiency Standards.

This program developed by EnergySoft, LLC - www.energysoft.com.

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Form NRCC-LTI-E Indoor Lighting	3
Form NRCC-LTO-E Outdoor Lighting	10

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PROJECT: 2022 SIERRA II COMPACT 16'-8" W/ MECH RM
 JOHN F. KENNEDY RR FACILITY
 SACRAMENTO, CALIFORNIA
 SHEET TITLE: TITLE 24 DOCUMENTS

DOUBLE 'E' ENGINEERING, LLC
 Myrtle Point, Oregon
 www.eeengineering.com

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 (541) 466-3341 FAX (541) 466-0803

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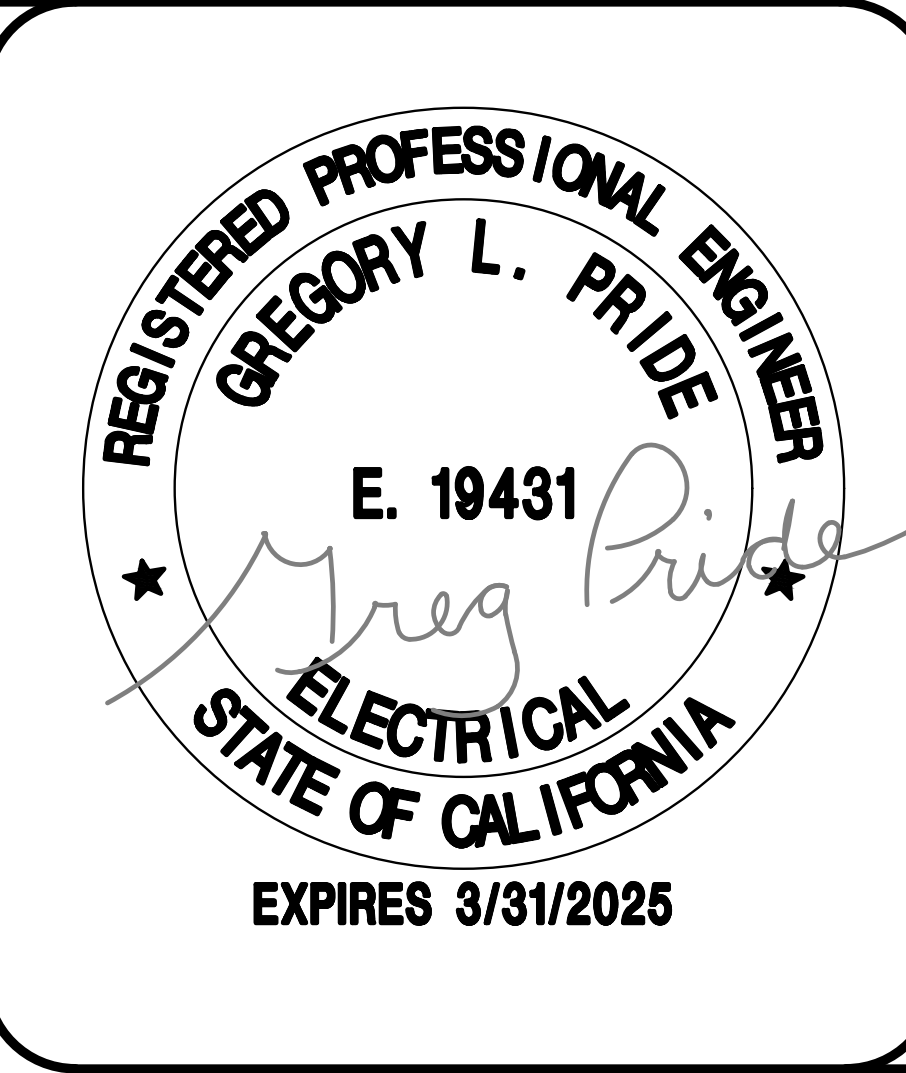
PLAN SET# LFK01
 DATE: 10/16/2023

REV.	DATE	BY
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SHEET NO.

E5



STATE OF CALIFORNIA
Indoor Lighting CALIFORNIA ENERGY COMMISSION

CERTIFICATE OF COMPLIANCE NRCC-LTI-E
 This document is used to demonstrate compliance with requirements in 110.9, 110.12(c), 130.0, 130.1, 140.6 and 141.0(b)2 for indoor lighting scopes using the prescriptive path for nonresidential and hotel/motel occupancies. It is also used to document compliance with requirements in 160.5, 170.2(e) and 180.2(b)4 for indoor lighting scopes using the prescriptive path for multifamily occupancies. Multifamily includes dormitory and senior living facilities.
 Project Name: 2310-020 John F. Kennedy Restroom Report Page: (Page 1 of 7)
 Project Address: 6715 Gloria Dr. Date Prepared: 1/24/2024

A. GENERAL INFORMATION

01 Project Location (city)	Sacramento	04 Total Conditioned Floor Area (ft ²)	0
02 Climate Zone	12	05 Total Unconditioned Floor Area (ft ²)	222
03 Occupancy Types Within Project (select all that apply):		06 # of Stories (Habitable Above Grade)	1

• Support Areas

B. PROJECT SCOPE
 This table includes any lighting systems that are within the scope of the permit application and are demonstrating compliance using the prescriptive path outlined in 140.6 / 170.2(e) or 141.0(b)2 / 180.2(b)4 for alterations.

Scope of Work	Conditioned Spaces		Unconditioned Spaces	
01	02	03	04	05
My Project Consists of (check all that apply):	Calculation Method	Area (ft ²)	Calculation Method	Area (ft ²)
<input checked="" type="checkbox"/> New Lighting System	Area Category Method	0	Area Category Method	222
<input type="checkbox"/> New Lighting System - Parking Garage				
Total Area of Work (ft²)		0		222

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STATE OF CALIFORNIA
Indoor Lighting CALIFORNIA ENERGY COMMISSION

CERTIFICATE OF COMPLIANCE NRCC-LTI-E
 Project Name: 2310-020 John F. Kennedy Restroom Report Page: (Page 2 of 7)
 Date Prepared: 1/24/2024

C. COMPLIANCE RESULTS
 If any cell on this table says "DOES NOT COMPLY" or "COMPLIES with Exceptional Conditions" refer to Table D. for guidance.

Lighting in conditioned and unconditioned spaces must not be combined for compliance per 140.6(b)1 / 170.2(e)	Allowed Lighting Power per 140.6(b) / 170.2(e) (Watts)					Total Allowed (Watts)	Adjusted Lighting Power per 140.6(a) / 170.2(e) (Watts)			Compliance Results
	01	02	03	04	05		06	07	08	
	Complete Building 140.6(c)1	Area Category 140.6(c)2 / 170.2(e)4	Area Category Additional 140.6(c)2G / 170.2(e)4Av (+)	Tailored 140.6(c)3 / 170.2(e)4B (+)			Total Designed (Watts)	Adjustments PAF Lighting Control Credits 140.6(a)2 / 170.2(e)1B (-)	Total Adjusted (Watts) *Includes Adjustments	
	(See Table I)	(See Table I)	(See Table J)	(See Table K)			(See Table F)	(See Table P)		05 must be >= 08 140.6 / 170.2(e)
Conditioned					=				=	
Unconditioned		144.3	0		=	144		0	=	63
Controls Compliance (See Table H for Details)										COMPLIES
Rated Power Reduction Compliance (See Table Q for Details)										COMPLIES

D. EXCEPTIONAL CONDITIONS
 This table is auto-filled with uneditable comments because of selections made or data entered in tables throughout the form.

E. ADDITIONAL REMARKS
 This table includes remarks made by the permit applicant to the Authority Having Jurisdiction.

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PROJECT: 2022 SIERRA II COMPACT 16'-8" W MECH RM
 JOHN F. KENNEDY RR FACILITY
 SACRAMENTO, CALIFORNIA
 SHEET TITLE: TITLE 24 DOCUMENTS

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 www.eee-engineering.com

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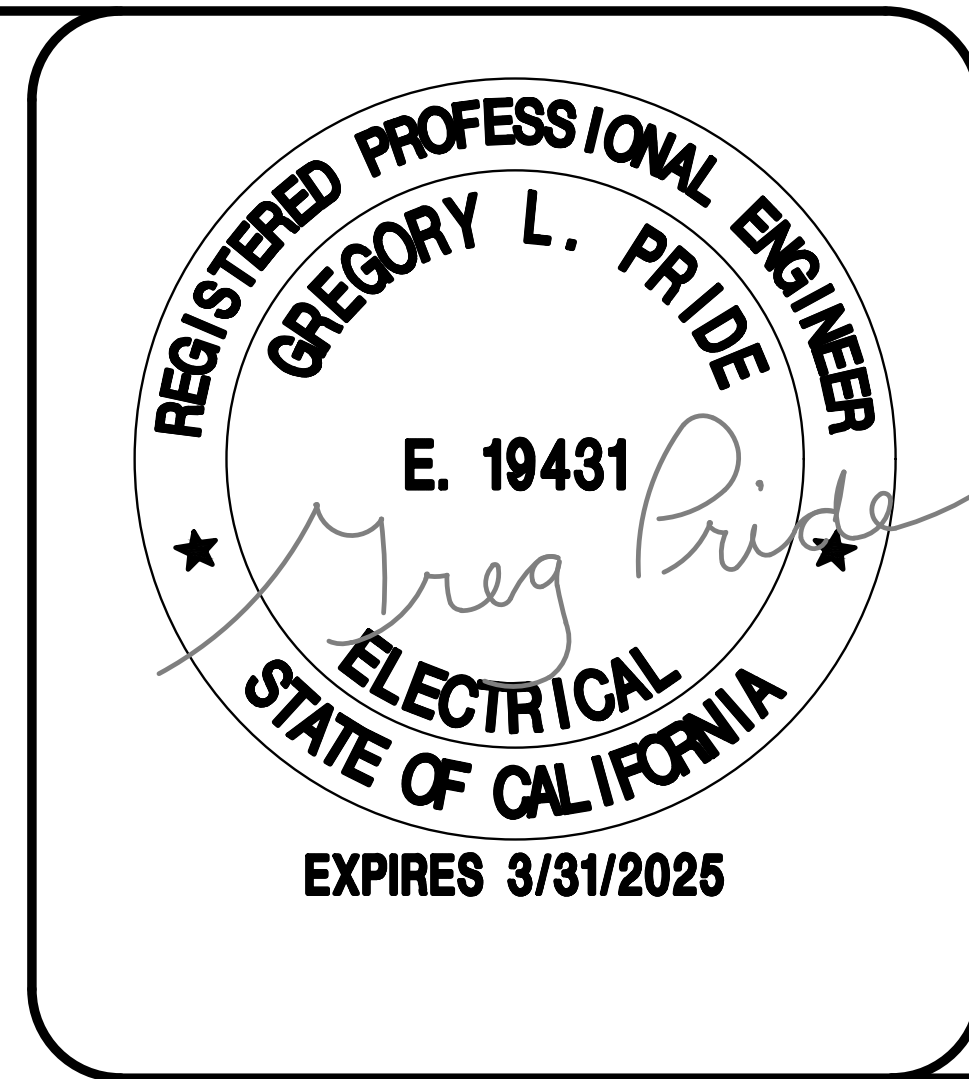
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STATE OF CALIFORNIA
Indoor Lighting CALIFORNIA ENERGY COMMISSION

CERTIFICATE OF COMPLIANCE		NRCC-LTI-E
Project Name: 2310-020 John F. Kennedy Restroom	Report Page:	(Page 3 of 7)
	Date Prepared:	1/24/2024

F. INDOOR LIGHTING FIXTURE SCHEDULE

This table includes all planned permanent and portable lighting other than dwelling unit/hotel/motel room lighting. Multifamily dwelling unit and hotel/motel room lighting is documented in Table T. If using Table T to document lighting in multifamily common use areas providing shared provisions for living, eating, cooking or sanitation, those luminaires are not included here.

Designed Wattage: Unconditioned Spaces										
01	02	03	04	05	06	07	08	09	10	
Name or Item Tag	Complete Luminaire Description	Modular (Track) Fixture	Small Aperture & Color Change ¹	Watts per luminaire ²	How is Wattage determined	Total Number of Luminaires	Excluded per 140.6(a)3 / 170.2(e)2C	Design Watts	Field Inspector	
									Pass	Fail
LF-2	Lithonia OLLWU Wall Mount14w (LF-2)	No	NA	14	Mfr. Spec	2	No	28	<input type="checkbox"/>	<input type="checkbox"/>
LF-3	Lithonia 48" Vapor Tight Wall Mount 35.3w LED	No	NA	35.3	Mfr. Spec	1	No	35.3	<input type="checkbox"/>	<input type="checkbox"/>
Total Designed Watts: UNCONDITIONED SPACES									63	

¹FOOTNOTE: Design Watts for small aperture and color changing luminaires which qualify per 140.6(a)4B / 170.2(e)2D is adjusted to be 75% /80% of their rated wattage. Table F automatically makes this adjustment, the permit applicant should enter full rated wattage in column 05.
²Authority Having Jurisdiction may ask for luminaire cut sheets to confirm wattage used for compliance per 130.0(c) / 160.5(b). Wattage used must be the maximum rated for the luminaire, not the lamp.

G. MODULAR LIGHTING SYSTEMS

This section does not apply to this project.

H. INDOOR LIGHTING CONTROLS (Not including PAFs)

This table includes lighting controls for conditioned and unconditioned spaces.

Building Level Controls			
01	02	03	
		Field Inspector	
		Pass	Fail
Mandatory Demand Response 110.12(c)	Shut-off controls 130.1(c) / 160.5(b)4C	<input type="checkbox"/>	<input type="checkbox"/>
NA < 4,000W subject to multilevel	See Area/Space Level Controls		

STATE OF CALIFORNIA
Indoor Lighting CALIFORNIA ENERGY COMMISSION

CERTIFICATE OF COMPLIANCE		NRCC-LTI-E
Project Name: 2310-020 John F. Kennedy Restroom	Report Page:	(Page 4 of 7)
	Date Prepared:	1/24/2024

H. INDOOR LIGHTING CONTROLS (Not including PAFs)

Area Level Controls									
04	05	06	07	08	09	10	11	12	
Area Description	Complete Building or Area Category Primary Function Area	Manual Area Controls 130.1(a) / 160.5(b)4A	Multi-Level Controls 130.1(b) / 160.5(b)4B	Shut-Off Controls 130.1(c) // 160.5(b)4C	Primary/Sky lit Daylighting 130.1(d) / 160.5(b)4D	Secondary Daylighting 130.1(d) / 160.5(b)4D	Interlocked Systems 140.6(a)1/ 170.2(e)2A	Field Inspector	
		Readily Accessible	Dimmer	See Building Level	Included	Included	No	Pass	Fail
Whole Building	All Other Space Types							<input type="checkbox"/>	<input type="checkbox"/>
13									
Plan Sheet Showing Daylit Zones:									

I. LIGHTING POWER ALLOWANCE: COMPLETE BUILDING OR AREA CATEGORY METHODS

Each area complying using the Complete Building or Area Category Methods per 140.6(b) are included in this table. Column 06 indicates if additional lighting power allowances per 140.6(c) or adjustments per 140.6(a) are being used.

Unconditioned Spaces					
01	02	03	04	05	06
Area Description	Complete Building or Area Category Primary Function Area	Allowed Density (W/ft ²)	Area (ft ²)	Allowed Wattage (Watts)	Additional Allowance / Adjustment
					Area Category PAF
Restrooms/Mech Storage	Restroom	0.65	222	144.3	No No
TOTALS:				222	144.3
See Tables J, or P for detail					

J. ADDITIONAL ALLOWANCE: AREA CATEGORY METHOD QUALIFYING LIGHTING SYSTEM

This section does not apply to this project.

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PROJECT: 2022 SIERRA TOWER COMPACT 16'-8" W/ MECH RM
 JOHN F. KENNEDY RR FACILITY
 SACRAMENTO, CALIFORNIA
 SHEET TITLE: TITLE 24 DOCUMENTS

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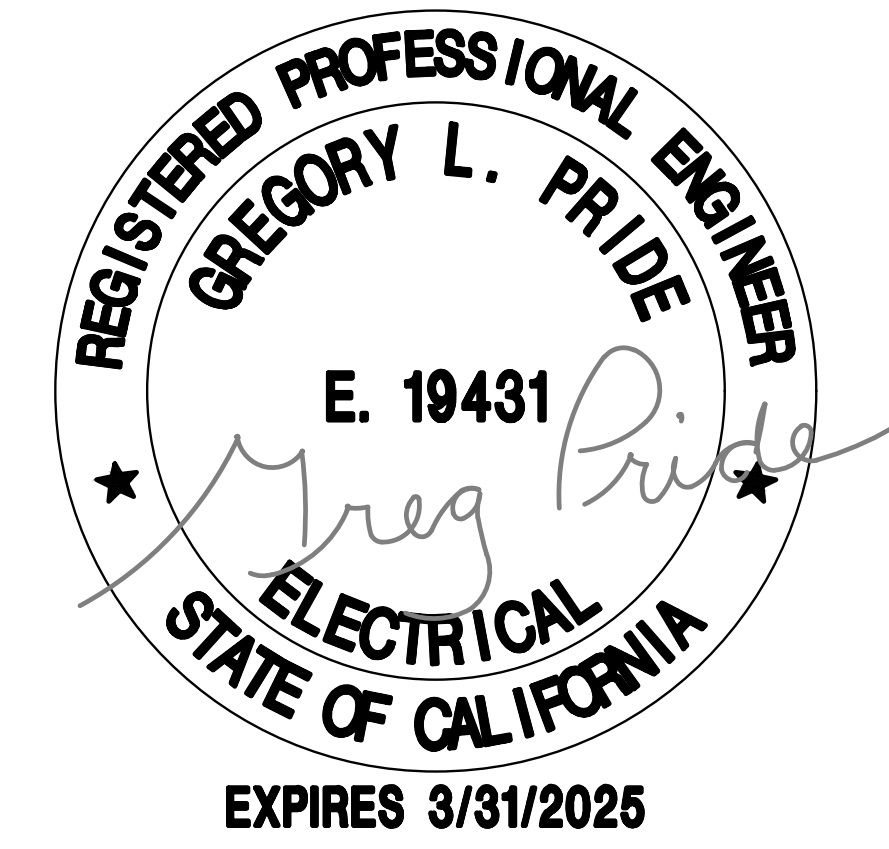
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STATE OF CALIFORNIA
Indoor Lighting CALIFORNIA ENERGY COMMISSION

CERTIFICATE OF COMPLIANCE		NRCC-LTI-E	
Project Name: 2310-020 John F. Kennedy Restroom	Report Page:	(Page 5 of 7)	
	Date Prepared:	1/24/2024	

K. TAILORED METHOD GENERAL LIGHTING POWER ALLOWANCE
This section does not apply to this project.

L. ADDITIONAL LIGHTING ALLOWANCE: TAILORED WALL DISPLAY
This section does not apply to this project.

M. ADDITIONAL LIGHTING ALLOWANCE: TAILORED FLOOR AND TASK LIGHTING
This section does not apply to this project.

N. ADDITIONAL LIGHTING ALLOWANCE: TAILORED DECORATIVE /SPECIAL EFFECTS
This section does not apply to this project.

O. ADDITIONAL LIGHTING ALLOWANCE: TAILORED VERY VALUABLE MERCHANDISE
This section does not apply to this project.

P. POWER ADJUSTMENT: LIGHTING CONTROL CREDIT (POWER ADJUSTMENT FACTOR (PAF))
This section does not apply to this project.

Q. RATED POWER REDUCTION COMPLIANCE FOR ONE-FOR-ONE ALTERATIONS
This section does not apply to this project.

R. 80% LIGHTING POWER FOR ALL ALTERATIONS - CONTROLS EXCEPTIONS
This section does not apply to this project.

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STATE OF CALIFORNIA
Indoor Lighting CALIFORNIA ENERGY COMMISSION

CERTIFICATE OF COMPLIANCE		NRCC-LTI-E	
Project Name: 2310-020 John F. Kennedy Restroom	Report Page:	(Page 6 of 7)	
	Date Prepared:	1/24/2024	

S. DAYLIGHT DESIGN POWER ADJUSTMENT FACTOR (PAF)
This section does not apply to this project.

T. DWELLING UNIT LIGHTING
This section does not apply to this project.

U. DECLARATION OF REQUIRED CERTIFICATES OF INSTALLATION
Selections have been made based on information provided in this document. If any selections have been changed by permit applicant, an explanation should be included in Table E. Additional Remarks. These documents must be provided to the building inspector during construction and can be found online

Form/Title
NRCI-LTI-E - Must be submitted for all buildings

V. DECLARATION OF REQUIRED CERTIFICATES OF ACCEPTANCE
Selections have been made based on information provided in this document. If any selections have been changed by the permit applicant, an explanation should be included in Table E. Additional Remarks. These documents must be provided to the building inspector during construction and any with "-A" in the form name must be completed through an Acceptance Test Technician Certification Provider (ATTCP). For more information visit: <http://www.energy.ca.gov/title24/attcp/providers.html>

Form/Title	Systems/Spaces To Be Field Verified
NRCA-LTI-03-A - Must be submitted for automatic daylight controls.	Whole Building;

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PROJECT: 2022 SIERRA II COMPACT 16'-8" W MECH RY
 JOHN F. KENNEDY RR FACILITY
 SACRAMENTO, CALIFORNIA
 SHEET TITLE: TITLE 24 DOCUMENTS

PLAN SET#	JFK01	
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SHEET NO. **E8**



STATE OF CALIFORNIA
Indoor Lighting CALIFORNIA ENERGY COMMISSION
CERTIFICATE OF COMPLIANCE NRCC-LTI-E
Project Name: 2310-020 John F. Kennedy Restroom **Report Page:** (Page 7 of 7)
Project Address: 6715 Gloria Dr. **Date Prepared:** 1/24/2024

DOCUMENTATION AUTHOR'S DECLARATION STATEMENT
 I certify that this Certificate of Compliance documentation is accurate and complete.

Documentation Author Name: Matthew Weldon	Documentation Author Signature: <i>Matthew Weldon</i>
Company: Regerfour LLC dba 5 Star Energy	Signature Date: 01/24/2024
Address: 940 Merchant St.	CEA/ HERS Certification Identification (if applicable):
City/State/Zip: Redding Ca 96002	Phone: 530-275-3350

RESPONSIBLE PERSON'S DECLARATION STATEMENT
 I certify the following under penalty of perjury, under the laws of the State of California:

- The information provided on this Certificate of Compliance is true and correct.
- I am eligible under Division 3 of the Business and Professions Code to accept responsibility for the building design or system design identified on this Certificate of Compliance (responsible designer)
- The energy features and performance specifications, materials, components, and manufactured devices for the building design or system design identified on this Certificate of Compliance conform to the requirements of Title 24, Part 1 and Part 6 of the California Code of Regulations.
- The building design features or system design features identified on this Certificate of Compliance are consistent with the information provided on other applicable compliance documents, worksheets, calculations, plans and specifications submitted to the enforcement agency for approval with this building permit application.
- I will ensure that a completed signed copy of this Certificate of Compliance shall be made available with the building permit(s) issued for the building, and made available to the enforcement agency for all applicable inspections. I understand that a completed signed copy of this Certificate of Compliance is required to be included with the documentation the builder provides to the building owner at occupancy.

Responsible Designer Name: Greg Pride	Responsible Designer Signature: <i>Greg Pride</i>
Company: Double 'E' Engineering, LLC	Date Signed: 2024-01-24
Address: 315 Ash Street	License: E19431
City/State/Zip: Myrtle Point Oregon 97458	Phone: 541-2940-0587

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STATE OF CALIFORNIA
Outdoor Lighting CALIFORNIA ENERGY COMMISSION
CERTIFICATE OF COMPLIANCE NRCC-LTO-E
Project Name: 2310-020 John F. Kennedy Restroom **Report Page:** (Page 1 of 7)
Project Address: 6715 Gloria Dr. **Date Prepared:** 1/24/2024

A. GENERAL INFORMATION

01 Project Location (city)	Sacramento	04 Total Illuminated Hardscape Area (ft ²)	193
02 Climate Zone	12	03 Outdoor Lighting Zone per Title 24 Part 1 10.114 or as designated by Authority Having Jurisdiction (AHJ):	
<input type="checkbox"/> LZ-0: Very Low - Undeveloped Parkland		<input type="checkbox"/> LZ-2: Moderate - Urban Clusters	
<input type="checkbox"/> LZ-1: Low - Rural Areas		<input type="checkbox"/> LZ-3: Moderately High - Urban Areas	
<input checked="" type="checkbox"/> LZ-4: High - Must be reviewed by CA Energy Commission for Approval			
05 Occupancy Types within Project			
• Support Areas			

B. PROJECT SCOPE
 This table includes outdoor lighting systems that are within the scope of the permit application and are demonstrating compliance using the prescriptive path outlined in 140.7 / 170.2(e)6 or 141.0(b)2L / 180.2(b)4Bv for alterations.

My Project Consists of:

01	02	03	04	05
<input checked="" type="checkbox"/> New Lighting System	Must Comply with Allowances from 140.7 / 170.2(e)6	Is your alteration increasing the connected lighting load (Watts)?		
<input type="checkbox"/> Altered Lighting System		Yes <input type="radio"/> No <input type="radio"/>		
% of Existing Luminaires Being Altered ¹		Sum Total of Luminaires Being Added or Altered		Calculation Method
<input type="checkbox"/> < 10% <input type="checkbox"/> >= 10% and < 50% <input type="checkbox"/> >= 50%				

Please proceed to Table F. Outdoor Lighting Fixture Schedule to define the project's luminaires.
¹ FOOTNOTES: % of Existing Luminaires Being Altered = (Sum Total of Luminaires Being Added or Altered / Existing Luminaires within the Scope of the Permit Application) x 100.

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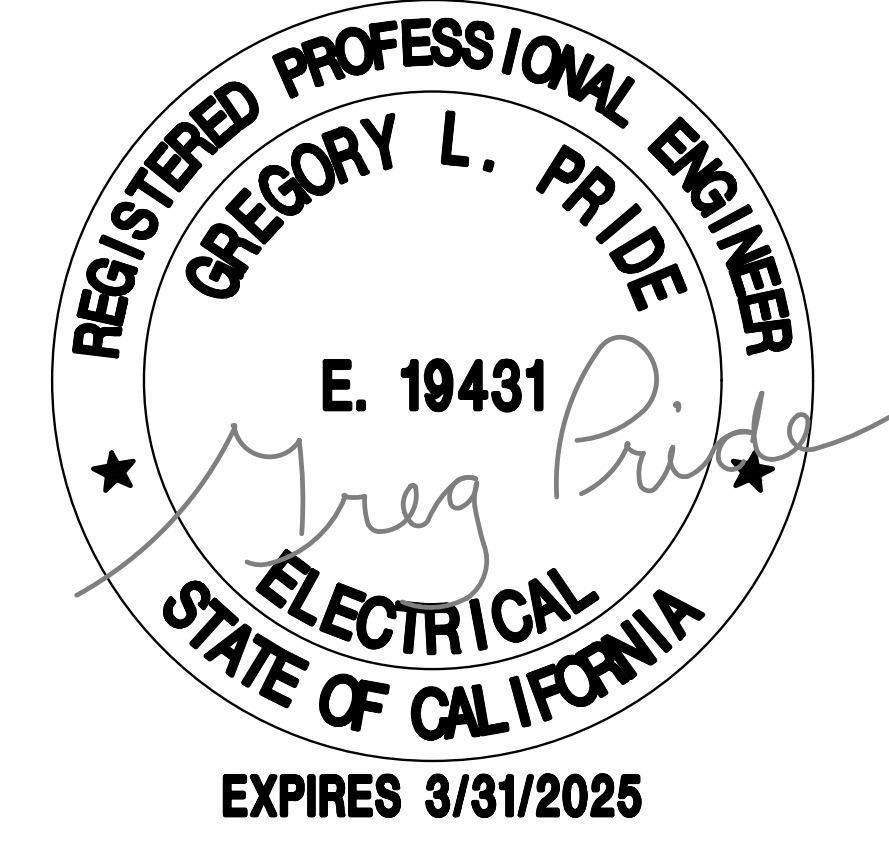
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 SHEET TITLE: TITLE 24 DOCUMENTS

PLAN SET#
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STATE OF CALIFORNIA
Outdoor Lighting CALIFORNIA ENERGY COMMISSION

CERTIFICATE OF COMPLIANCE		NRCC-LTO-E	
Project Name: 2310-020 John F. Kennedy Restroom	Report Page: (Page 2 of 7)	Date Prepared: 1/24/2024	

C. COMPLIANCE RESULTS

Results in this table are automatically calculated from data input and calculations in Tables F through N. Note: If any cell on this table says "COMPLIES with Exceptional Conditions" refer to Table D. Exceptional Conditions for guidance or see applicable Table referenced below.

Calculations of Total Allowed Lighting Power (Watts) 140.7 / 170.2(e)6 or 141.0(b)2L / 180.2(b)4Bv										Compliance Results					
01	02	03	04	05	06	07	08	09							
General Hardscape Allowance 140.7(d)1 / 170.2(e)6 (See Table I)	+	Per Application 140.7(d)2 / 170.2(e)6 (See Table J)	+	Sales Frontage 140.7(d)2 (See Table K)	+	Ornamental 140.7(d)2 / 170.2(e)6 (See Table L)	+	Per Specific Area 140.7(d)2 / 170.2(e)6 (See Table M)	OR	Existing Power Allowance 141.0(b)2L / 180.2(b)4Bv (See Table N)	=	Total Allowed (Watts)	≥	Total Actual (Watts)	07 must be ≥ 08
266	+	---	+	---	+	---	+	---	OR	---	=	266	≥	36	COMPLIES
Shielding Compliance (See Table G for Details)												N/A			
Controls Compliance (See Table H for Details)												Not applicable			

D. EXCEPTIONAL CONDITIONS

This table is auto-filled with uneditable comments because of selections made or data entered in tables throughout the form.

E. ADDITIONAL REMARKS

This table includes remarks made by the permit applicant to the Authority Having Jurisdiction.

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STATE OF CALIFORNIA
Outdoor Lighting CALIFORNIA ENERGY COMMISSION

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F. OUTDOOR LIGHTING FIXTURE SCHEDULE

For new or altered lighting systems demonstrating compliance with 140.7 / 170.2(e)6 all new luminaires being installed and any existing luminaires remaining or being moved within the spaces covered by the permit application are included in the Table below. For altered lighting systems using the Existing Power method per 141.0(b)2L only new luminaires being installed and replacement luminaires being installed as part of the project scope are included (ie, existing luminaires remaining or existing luminaires being moved are not included). Outdoor lighting attached to multifamily buildings and controlled from the inside of a dwelling unit are included in Table H, and are not included here. All other multifamily outdoor lighting is included here.

Designed Wattage:									
01	02	03	04	05	06	07	08	09	10
Name or Item Tag	Complete Luminaire Description	Watts per luminaire ^{1,2}	How is Wattage determined	Total Number Luminaires ²	Luminaire Status ³	Excluded per 140.7(a) / 170.2(e)6A	Design Watts	Cutoff Req. > 6,200 initial lumen output 130.2(b) / 160.5(c)1 ⁴	Field Inspector
LF-1	Lithonia OLLWD Wall Mount LED Lighting 9w (LF-1) <input type="checkbox"/> Linear	9	Mfr. Spec	4	New	<input type="checkbox"/>	36	NA: < 6200 lumens	Pass <input type="checkbox"/> Fail <input type="checkbox"/>
Total Design Watts:							36		

* NOTES: Selections with a * require a note in the space below explaining how compliance is achieved.
 EX: Luminaire is lighting a statue; EXCEPTION 2 to 130.2(b)

¹ FOOTNOTES: Authority Having Jurisdiction may ask for Luminaire cut sheets to confirm wattage used for compliance per 130.0(c) / 160.5(b)
² For linear luminaires, wattage should be indicated as W/lf instead of Watts/luminaire. Total linear feet should be indicated in column 05 instead of number of luminaires.
³ Select "New" for new luminaires in a new outdoor lighting project, or for added luminaires in an alteration. Select "Altered" for replacement luminaires in an alteration. Select "Existing to Remain" for existing luminaires within the project scope that are not being altered and are remaining. Select "Existing Reinstalled" for existing luminaires which are being removed and reinstalled as part of the project scope.
⁴ Compliance with mandatory shielding requirements is required for luminaires with initial lumen output ≥ 6,200 unless exempted by 130.2(b) / 160.5(c)

G. SHIELDING REQUIREMENTS (BUG)

This section does not apply to this project.


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DOUBLE 'E'
 ENGINEERING, LLC
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 www.ee-engineering.com

PROJECT: 2022 SIERRA II COMPACT 16'-8" W/ MECH RM
 JOHN F. KENNEDY RR FACILITY
 SACRAMENTO, CALIFORNIA
 SHEET TITLE: TITLE 24 DOCUMENTS

PLAN SET#	JFK01	
DATE:	10/16/2023	
REVISIONS		
REV.	DATE	BY
4	03-04-2024	HS
DRAWN BY: CR		



STATE OF CALIFORNIA
Outdoor Lighting CALIFORNIA ENERGY COMMISSION
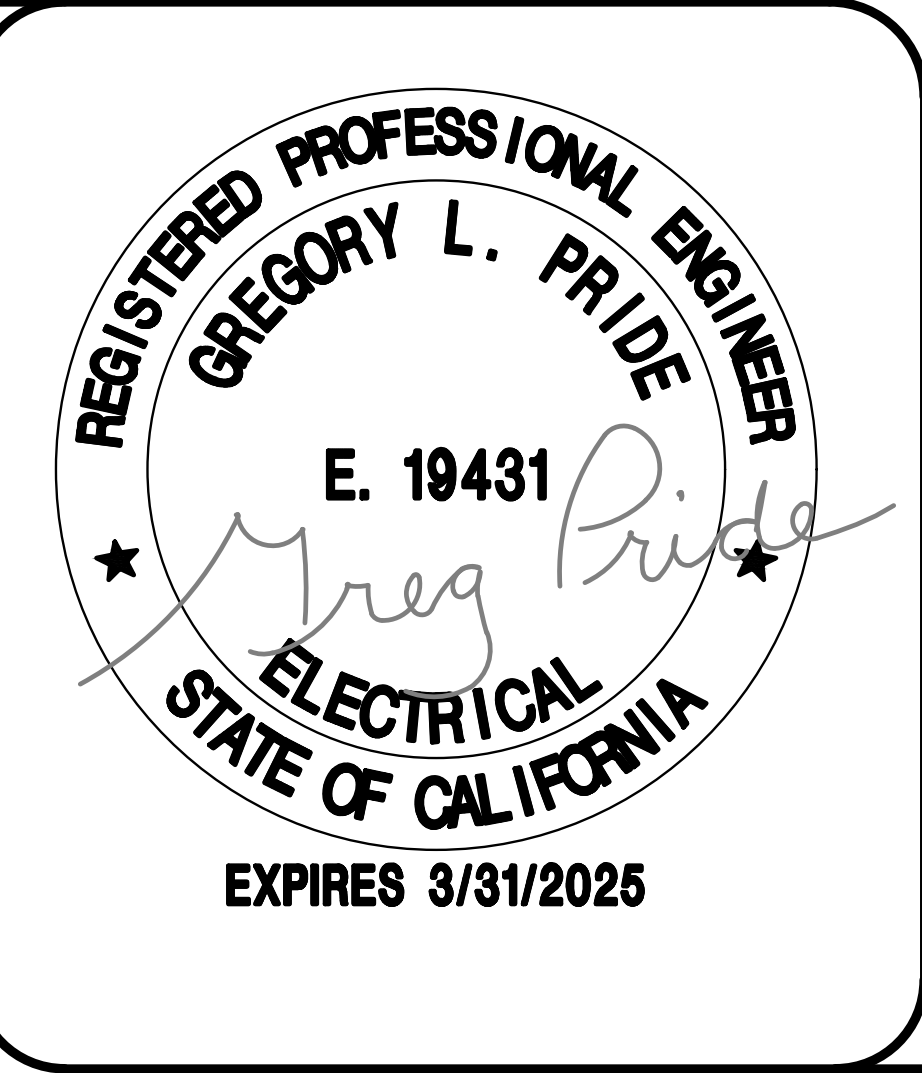
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H. OUTDOOR LIGHTING CONTROLS

This table demonstrates compliance with controls requirements for all new or altered luminaires installed as part of the permit application. For alteration projects, luminaires which are existing to remain (ie untouched) and luminaires which are removed and reinstalled (wiring only) do not need to be included in this table even if they are within the spaces covered by the permit application.
 Outdoor lighting for nonresidential buildings, parking garages and common service areas in multifamily buildings must be documented separately from outdoor lighting attached to multifamily buildings and controlled from the inside of a dwelling unit

Mandatory Controls for Nonresidential Occupancies, Parking Garages & Common Areas in Multifamily Buildings				
01	02	03	04	05
Area Description	Shut-Off 130.2(c)1 / 160.5(c)	Auto-Schedule 130.2(c)2 / 160.5(c)	Motion Sensor 130.2(c)3 / 160.5(c)	Field Inspector
				Pass
				Fail

¹FOOTNOTE: Text has been abbreviated, please refer to Table 160.5-A to confirm compliance with the specific light source technologies listed.
²Authority having jurisdiction may ask for cutsheets or other documentation to confirm compliance of light source.
³Recessed luminaires marked for use in fire-rated installations, and recessed luminaires installed in non-insulated ceilings are excepted from ii and iii.

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I. LIGHTING POWER ALLOWANCE (per 140.7 / 170.2(e))

This table includes areas using allowance calculations per 140.7 / 170.2(e). General Hardscape Allowance is per Table 140.7-A/Table 170.2-R while "Use it or lose it" Allowances are per Table 140.7-B /Table 170.2-S. Indicate which allowances are being used to expand sections for user input. Luminaires that qualify for one of the "Use it or lose it" allowances shall not qualify for another "Use it or lose it" allowance. Outdoor lighting attached to multifamily buildings and controlled from the inside of a dwelling unit are included in Table H. and are not included here. All other multifamily outdoor lighting is included here.

General Hardscape Allowance Table I (below) Per Application Table J Sales Frontage Table K Ornamental Table L Per Specific Area Table M

"Use it or lose it" Allowance (select all that apply) (select all that apply)

Calculated General Hardscape Lighting Power Allowance per Table 140.7-A for Nonresidential & Hotel/Motel											
02	03			04			05	06	07	08	09
	Area Wattage Allowance (AWA)			Linear Wattage Allowance (LWA)							
Area Description	Illuminated Area (ft ²)	Allowed Density (W/ft ²)	Area Allowance (Watts)	Perimeter Length (lf)	Allowed Density (W/lf)	Linear Allowance (Watts)					
Entrances Side Walk	193	0.021	4.1	60	0.2	12					16
Initial Wattage Allowance for Entire Site (Watts):											250
Instances of Initial Wattage Allowance (LZ 0 only)¹											
Total General Hardscape Allowance (Watts):											266

J. LIGHTING ALLOWANCE: PER APPLICATION
 This section does not apply to this project.

K. LIGHTING ALLOWANCE: SALES FRONTAGE
 This section does not apply to this project.

L. LIGHTING ALLOWANCE: ORNAMENTAL
 This section does not apply to this project.


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M. LIGHTING ALLOWANCE: PER SPECIFIC AREA
This section does not apply to this project.

N. EXISTING CONDITIONS POWER ALLOWANCE (alterations only)
This section does not apply to this project.

O. DECLARATION OF REQUIRED CERTIFICATES OF INSTALLATION
Selections have been made based on information provided in this document. If any selection has been changed by permit applicant, an explanation should be included in Table E. Additional Remarks. These documents must be provided to the building inspector during construction and can be found online

Form/Title
NRCI-LTO-E - Must be submitted for all buildings

P. DECLARATION OF REQUIRED CERTIFICATES OF ACCEPTANCE
There are no NRCA forms required for this project.

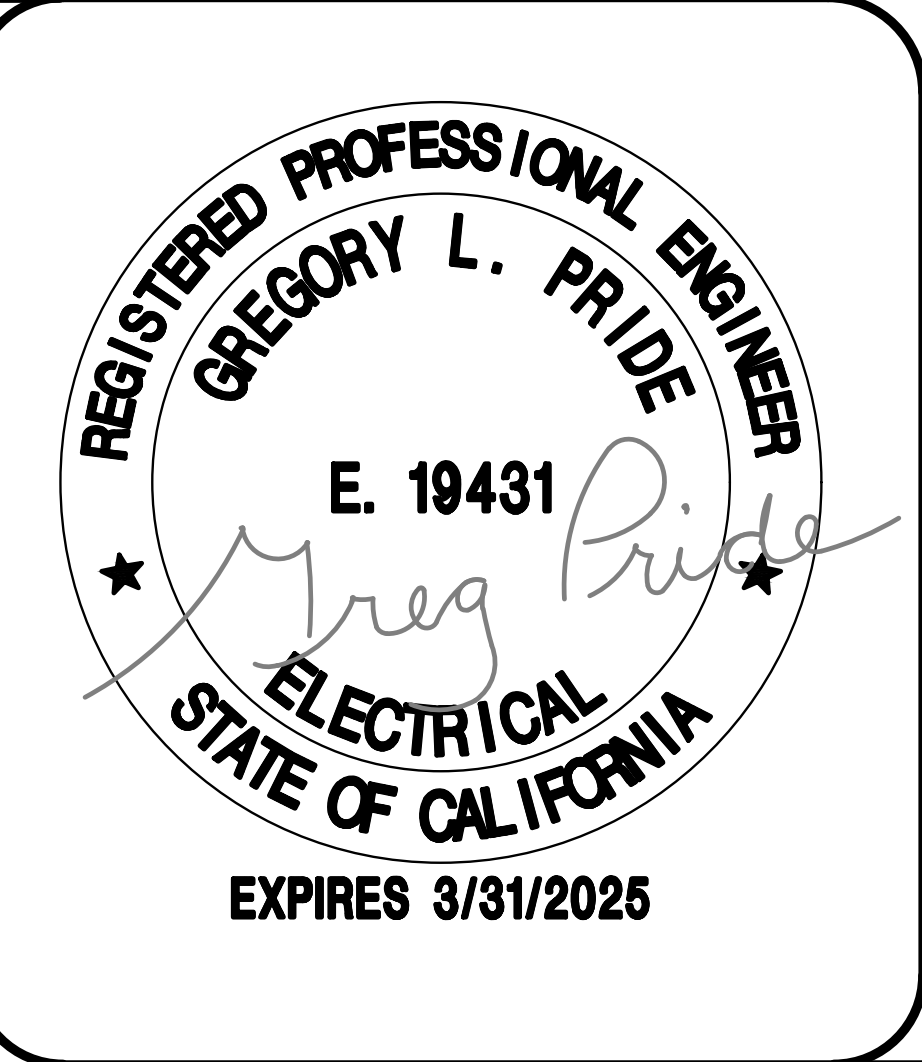STATE OF CALIFORNIA
Outdoor Lighting CALIFORNIA ENERGY COMMISSION
CERTIFICATE OF COMPLIANCE NRCC-LTO-E
 Project Name: 2310-020 John F. Kennedy Restroom Report Page: (Page 7 of 7)
 Project Address: 6715 Gloria Dr Date Prepared: 1/24/2024

DOCUMENTATION AUTHOR'S DECLARATION STATEMENT
I certify that this Certificate of Compliance documentation is accurate and complete.

Documentation Author Name: Matthew Weldon	Documentation Author Signature: <i>Matthew Weldon</i>
Company: Regerfour LLC dba 5 Star Energy	Signature Date: 01/24/2024
Address: 940 Merchant St.	CEA/ HERS Certification Identification (if applicable):
City/State/Zip: Redding Ca 96002	Phone: 530-275-3350

RESPONSIBLE PERSON'S DECLARATION STATEMENT
 I certify the following under penalty of perjury, under the laws of the State of California:

- The information provided on this Certificate of Compliance is true and correct.
- I am eligible under Division 3 of the Business and Professions Code to accept responsibility for the building design or system design identified on this Certificate of Compliance (responsible designer)
- The energy features and performance specifications, materials, components, and manufactured devices for the building design or system design identified on this Certificate of Compliance conform to the requirements of Title 24, Part 1 and Part 6 of the California Code of Regulations.
- The building design features or system design features identified on this Certificate of Compliance are consistent with the information provided on other applicable compliance documents, worksheets, calculations, plans and specifications submitted to the enforcement agency for approval with this building permit application.
- I will ensure that a completed signed copy of this Certificate of Compliance shall be made available with the building permit(s) issued for the building, and made available to the enforcement agency for all applicable inspections. I understand that a completed signed copy of this Certificate of Compliance is required to be included with the documentation the builder provides to the building owner at occupancy.

Responsible Designer Name: Greg Pride	Responsible Designer Signature: <i>Greg Pride</i>
Company: Double 'E' Engineering, LLC	Date Signed: 2024-01-24
Address: 315 Ash Street	License: E19431
City/State/Zip: Myrtle Point Oregon 97458	Phone: 541-2940-0587

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